# WESTBANK PLAZA -EXTERIOR FACADE RENOVATION


3600 MAC ARTHUR BLVD., NEW ORLEANS LA





**EXISTING** 

**PROPOSED** 

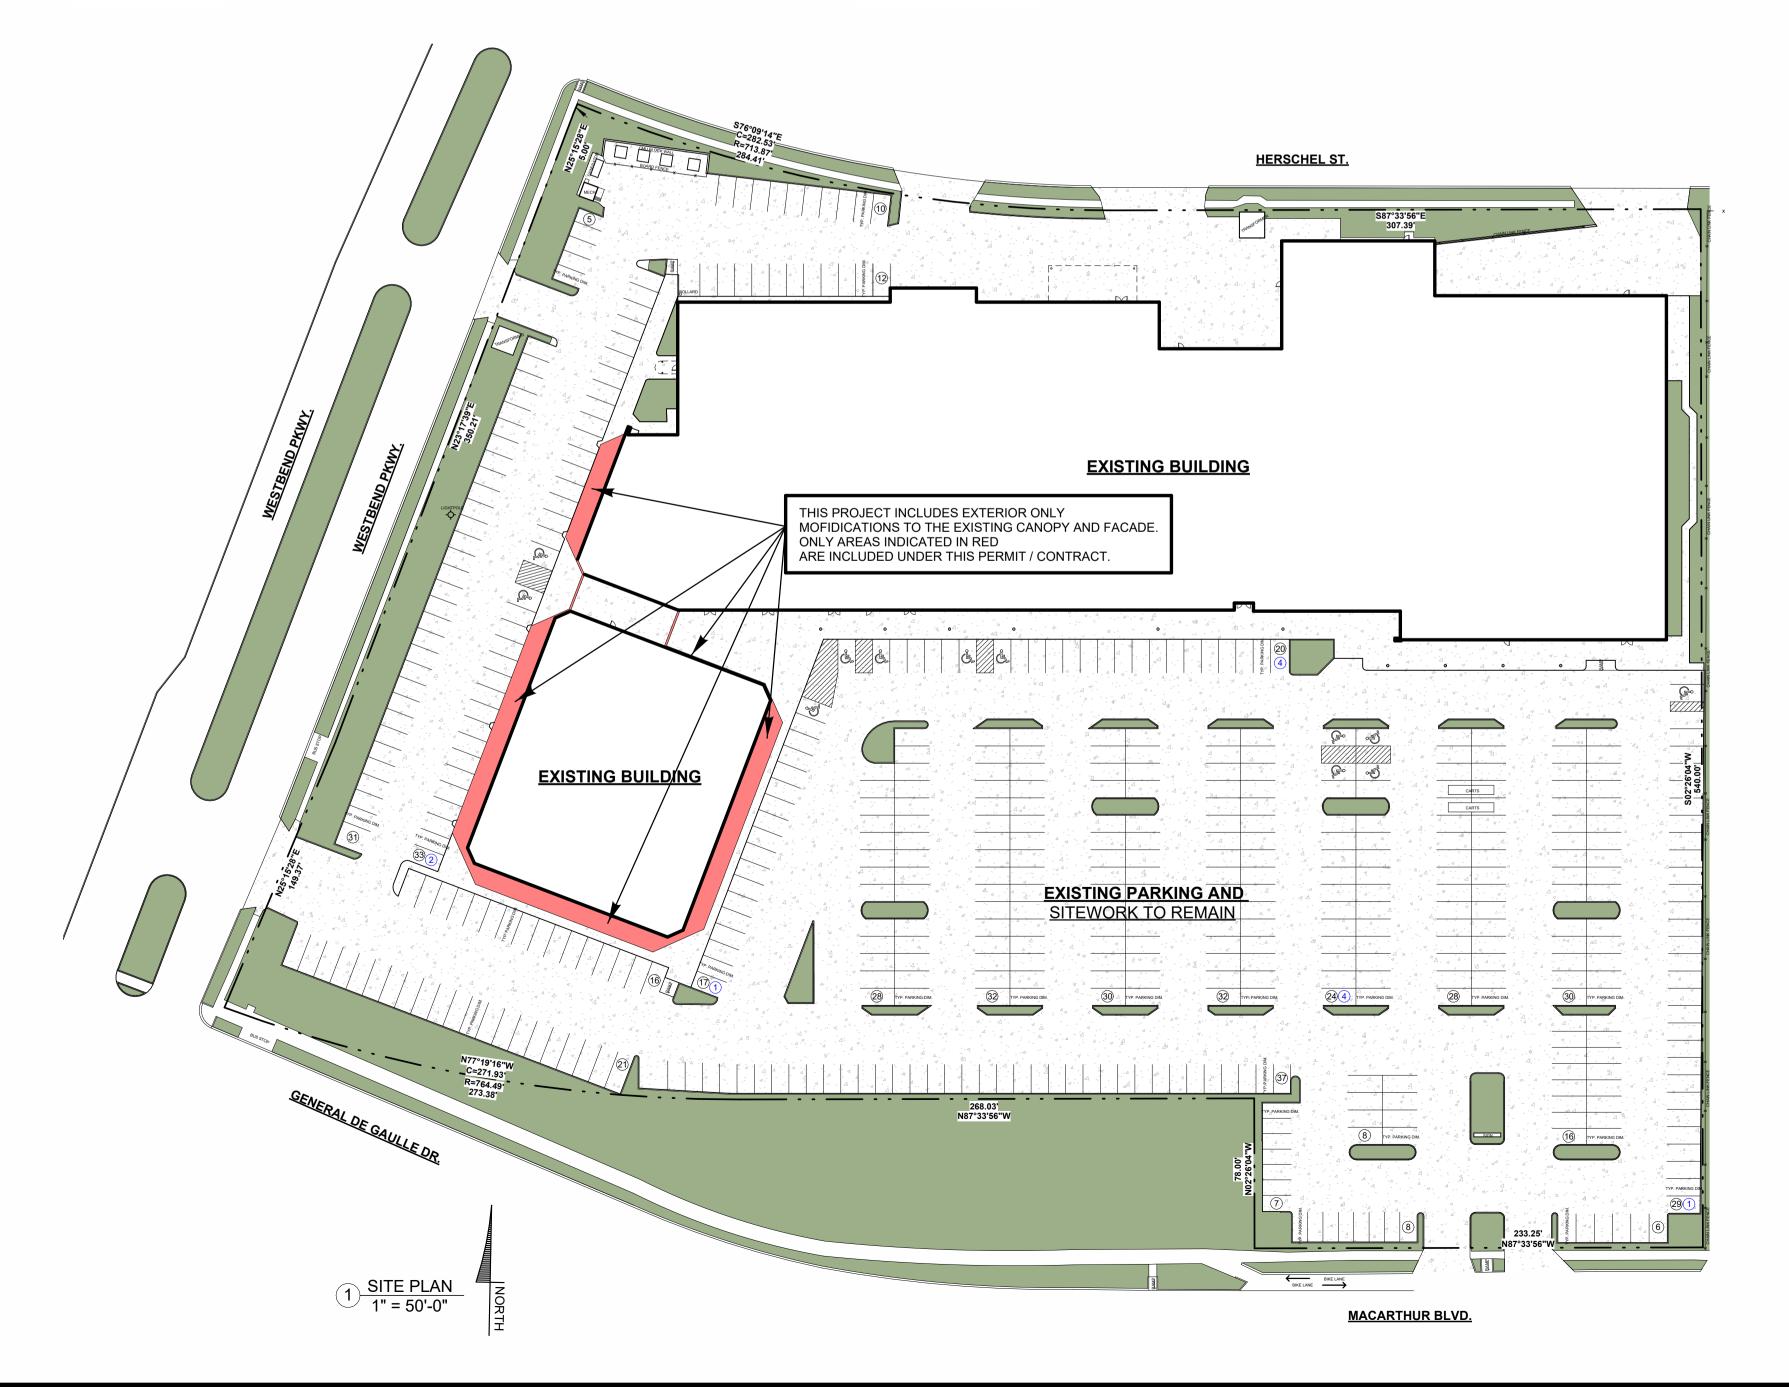

### **DESIGN SUMMARY:**

THIS PROJECT INCLUDES EXTERIOR ONLY MODIFICATIONS TO THE EXISTING CANOPY AND FACADE AT WESTBANK PLAZA SHOPPING CENTER. SCOPE OF WORK IS LIMITED TO THE SMALL BUILDING ONLY AS INDICATED. NO DOORS. OR EXITS ARE TO BE MODIFIED

|                            | CITATION         | ALLOWED / REQUIRED | PROVIDED                | COMMENTS                                       |
|----------------------------|------------------|--------------------|-------------------------|--|
| OCCUPANCY                  | IBC: CHAPTER 3   | GROUP B, M         |                         | EXISTING RETAIL STRIP<br>CENTER - MULTI TENANT |
|                            |                  |                    |                         |  |
| CONSTRUCTION<br>TYPE       | IBC: 601         | TYPE IIB           |                         |  |
|                            |                  |                    |                         |  |
| AREA AND HEIGHT            |                  |                    |                         | EXISTING RETAIL STRIP                          |
|                            |                  |                    |                         | CENTER - MULTI TENANT                          |
|                            |                  |                    |                         |  |
| SEPARATION                 | IBC: TABLE 508.4 | N/A                |                         |  |
|                            |                  |                    |                         |  |
| DESIGN LOADS               |                  |                    |                         |  |
| DESIGN LIVE LOADS          | FIRST FLOOR      | IBC: 1607.1.34     | RETAIL: 100PSF          | EXISTING                                       |
|                            | ROOF             | IBC: 1607.1.27     | ORDINARY PITCHED: 20PSF |  |
| WIND LOAD                  |                  | FIG. 1609A         | 3 SECOND GUST           | DESIGN WIND SPEED:                             |
|                            |                  | IBC: 1609.4.3      | EXPOSURE CATEGORY B     | 130mph (V-ult) and 108mpg (V-asd)              |
| OCCUPANCY RISK<br>CATEGORY |                  | IBC: 1604.5        | CATEGORY II             |  |

## **PROJECT NOTES:**

#### **GENERAL NOTES**

1. DO NOT SCALE DRAWINGS. USE WRITTEN DIMENSIONS ONLY. SUBMIT TO ARCHITECT ANY

2. ALL WORK SHALL BE IN COMPLIANCE WITH THE IBC RECOGNIZED INDUSTRY STANDARDS,

WITH THESE PLANS AND SPECIFICATIONS UNLESS WRITTEN NOTIFICATION FROM THE OWNER OR

THE ARCHITECT DOES NOT GUARANTEE THE PERFORMANCE OF THE PROJECT IN ANY RESPECT OTHER THAN THAT OUR ARCHITECTURAL WORK AND JUDGMENT RENDERED MEET THE STANDARDS OF CARE OF OUR PROFESSION.

APPROXIMATE. IT SHALL BE THE RESPONSIBILITY OF THE CONTRACTOR TO VERIFY THE EXISTENCE AND ACTUAL LOCATION OF SUCH, WHETHER SHOW HEREON OR NOT, PRIOR TO ANY EXCAVATION. ANY DAMAGES SHALL BE REPAIRED AT THE EXPENSE OF THE CONTRACTOR

. THE CONTRACTOR SHALL PROVIDE ADEQUATE BRACING AND SHORING FOR ALL WORK DURING

FIRE BARRIER TO A FIRE BARRIER, OR A COMBINATION THEREOF: INCLUDING CONTINUITY THROUGH ALL CONCEALED SPACES SUCH AS THOSE FOUND ABOVE A CEILING, INCILIDING

PASSAGES OF PIPES, CONDUITS, BUS DUCTS, CABLES, WIRES, AIRDUCTS, PNEUMATIC DUCTS, AND SIMILAR BUILDING SERVICES EQUIPMENT THROUGH FIRE BARRIERS SHALL BE PROTECTED AS FOLLOWS:

--THE SPACE BETWEEN PENETRATING ITEM AND FIRE BARRIER SHALL BE FILLED WITH A MATERIAL CAPABLE OF MAINTAINING THE FIRE RESISTANCE RATING OF THE FIRE BARRIER PRODUCT. PRODUCT USED MUST MEET TEST METHODS ASTM E814 OR UL 1479 FOR FIRE RATING.

--FIRE BARRIERS SHALL BE EFFECTIVELY AND PERMANENTLY IDENTIFIED WITH 1" STENCILING (AT 10' 0N CENTER) ABOVE ANY DECORATIVE CEILING AND CONCEALED SPACES WITH THE FOLLOWING:

#### FIRE / SMOKE BARRIER PROTECT ALL OPENINGS

9. WHEN A BEAM OR COLUMN BECOMES PART OF A FIRE RATED WALL OR CEILING IT MUST BE PROTECTED AND BE FIRE RATED AS IS THE WALL OR CEILING.

10. SIGNS, LOCATION, NUMBER, AND SIZE ARE NOT APPROVED UNDER THIS BUILDING PERMIT. A SEPARATE PERMIT IS REQUIRED FOR EACH SIGN. SEE DEVELOPMENT REVIEW FOR SIGNAGE

11. ALL METAL STUD GAUGE DESIGN SHALL BE AS REQUIRED BY PERFORMANCE AND AS INDICATED IN THE DRAWINGS.

12. PRIME AND PAINT ALL STEEL EXPOSED TO VIEW, INCLUDING BUT NOT LIMITED TO: EXTERIOR RAILINGS, PIPE BOLLARDS, STAIRS, CANOPY STEEL AND TRUSSES, ETC.

13.PROVIDE SEPARATION BETWEEN ALL DISSIMILAR METALS INCLUDING SCREWS, NAILS AND OTHER FASTENING DEVICES.

14. WHERE MATERIAL FASTENERS ARE NOT INDICATED, PROVIDE AS SPECIFIED BY THE MATERIAL MANUFACTURER'S RECOMMENDATIONS AND PROCEDURES.

15. ALL WOOD BLOCKING AT COPING SHALL BE PRESSURE TREATED.

## JOINTS AND SEALANT NOTES

1. PROVIDE CONTINUOUS WATERPROOFING SILICONE BASED SEALANT AND BACKER ROD AT ALL STOREFRONT AND MASONRY JUNCTIONS AND TERMINATIONS, SEALANT SHALL MATCH

2 PROVIDE CONTINUOUS SEALANT AND BACKER ROD AT ALL JUNCTIONS. BETWEEN DISSIMILAR MATERIALS. I.E. BRICK TO E.I.F.S., STOREFRONT TO BRICK, ETC...DOW /CORNING #790.

3. FASTEN ALL PREFINISHED METAL COPING W/ CONT. CLEAT AT FRONT AND NEOPRENE GROMMETED FASTENERS AT 24" O.C. AT REAR. ALL JOINTS IN COPING SHALL BE STANDING SEAM PER "SMACNA" STANDARDS, (PLATE 76)

4. PROVIDE STANDING SEAM JOINTS AT ALL COPING SPLICES FOR THERMAL EXPANSION. ALL SEAMS SHALL BE SEALED WITH DOW/CORNING #795, TYPICAL 5. PROVIDE CLOSURE END CAPS AND 90 DEGREE TRANSITIONS AT ALL EXPANSION JOINT AND END

WALL CAPS ETC., TYPICAL. 6. PROVIDE VERTICAL METAL FLASHING AT ALL INSIDE AND OUTSIDE CORNERS OF PARAPET, TO

PROVIDE WEATHER TIGHT SEAL. EXTEND VERTICAL FLASHING UP UNDER COPING AND TERMINATE WITHIN 1" OF CANT STRIP OR WITHIN 6" OF ROOF MEMBRANE. SEAL HEMMED EDGE OF VERTICAL FLASHING WITH DOW/CORNING #795.

7. ANCHOR ALL PRESSURE TREATED WOOD BLOCKING AT TOP OF WALLS UNDER COPING WITH 3/8" DIA. ANCHORS AT 36" O.C. TYP.

THESE PLANS AND SPECIFICATIONS HAVE BEEN PREPARED BY ME OR UNDER MY CLOSE PERSONAL SUPERVISION AND TO THE BEST OF MY KNOWLEDGE AND BELIEF, THEY COMPLY WITH ALL CITY AND STATE REGULATIONS AND REQUIREMENTS. I AM NOT ADMINISTERING THE CONTRACT.



LA LICENSE # 5038

# **PROJECT DIRECTORY:**

PROJECT LOCATION: 3600 MAC ARTHUR BLVD **NEW ORLEANS. LA** 

EDDIE HAMDEN 2439 MANHATTAN BLVD SUITE 302 HARVEY LA 70058 PH: 504.366.2413 eddie@brothersfoodmart.com

**GARRITY + ACCARDO ARCHITECTS** 2401 WHITNEY AVENUE GRETNA, LA 70056 PH: 504.366.4475 EMAIL: bgarrity@garrityaccardo.com CONTACT: BRADY GARRITY

**DRAWING INDEX:** 

INDEX OF DRAWINGS

T-100 TITLE SHEET A-100 NEW ELEVATIONS- SMALL **BUILDING FRONT & ALCOVE** A-101 NEW ELEVATIONS- SMALL

BUILDING BACK & LEFT A-300 WALL SECTIONS AND DETAILS

#### **ALL CONSTRUCTION SHALL BE IN ACCORDANCE WITH:**

INTERNATIONAL BUILDING CODE 2021 EDITION LIFE SAFETY CODE (NFPA 101) 2015 EDITION AMERICANS WITH DISABILITIES ACT (ADA) 2010

ROJECT NUMBER

REVISIONS

HEET NUMBER

05.30.2024


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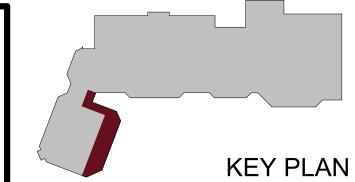
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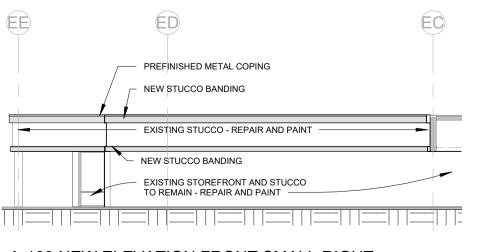


REVISIONS

05.30.2024


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SHEET NUMBER

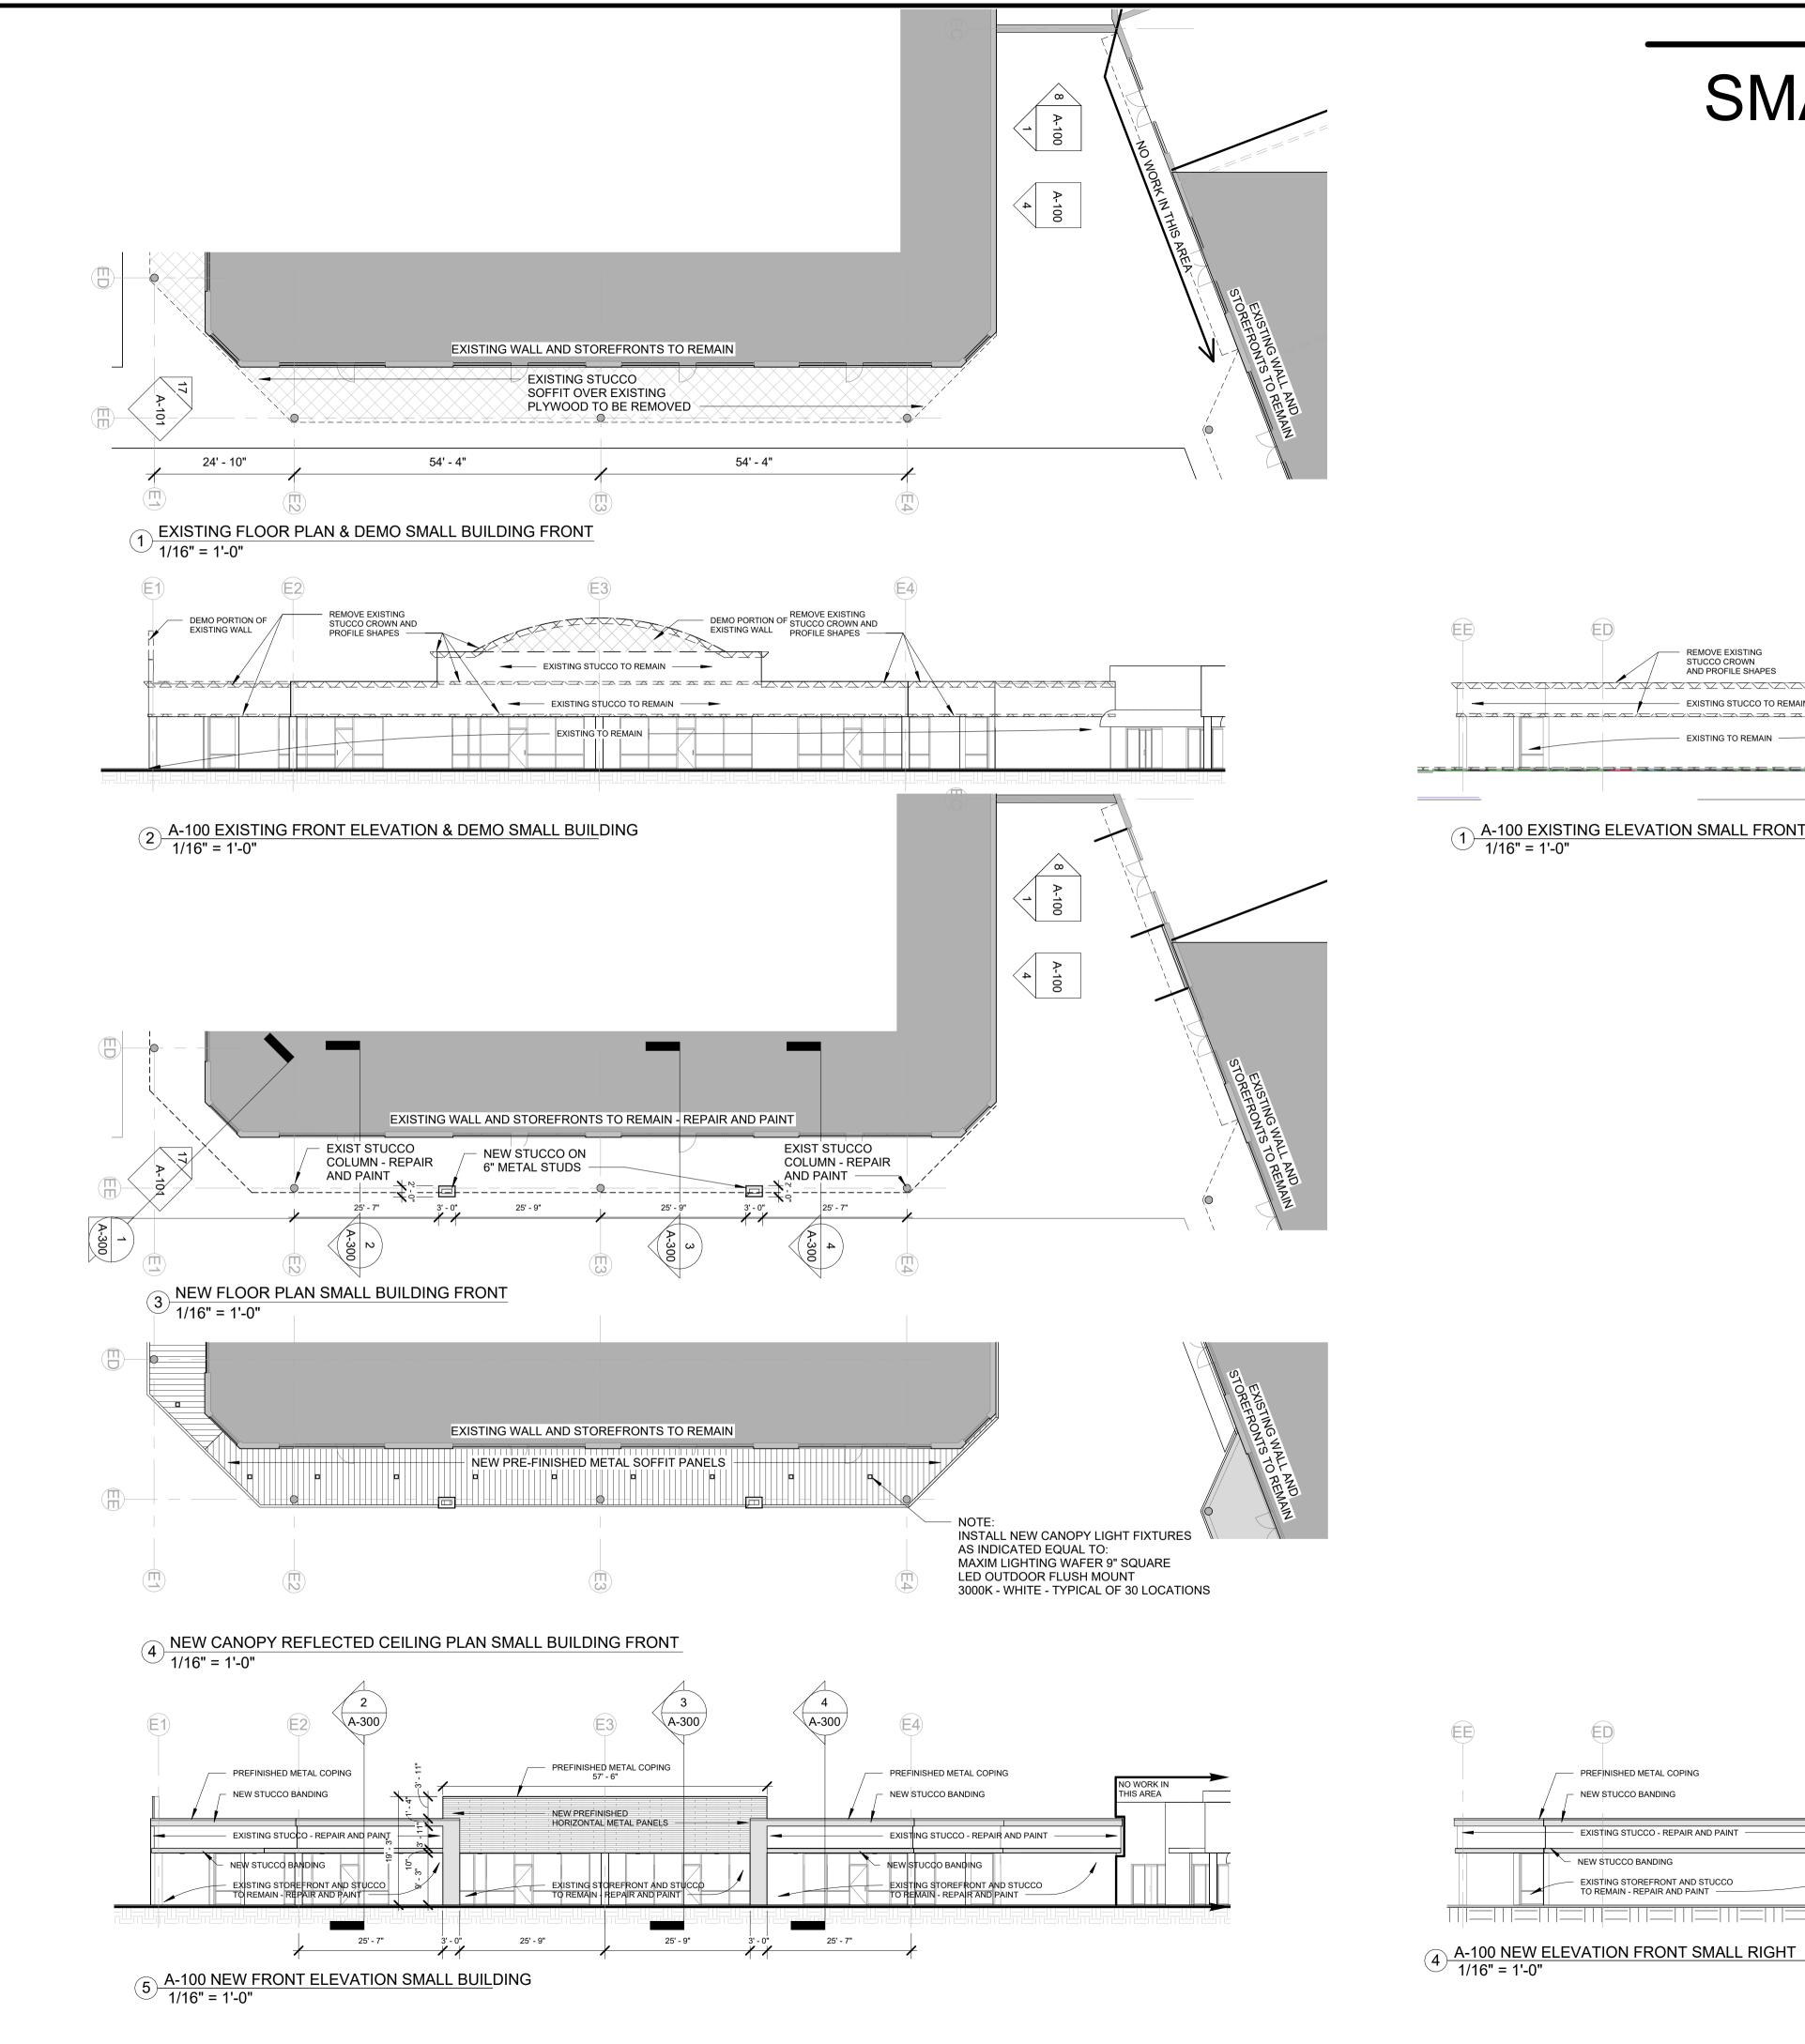

REMOVE EXISTING

—— EXISTING STUCCO TO REMAIN ———

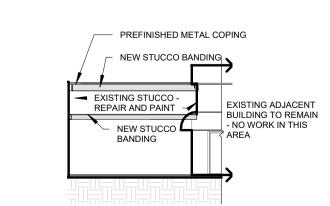

REMOVE EXISTING STUCCO CROWN AND PROFILE SHAPES

3 A-100 EXISTING ELEVATION BETWEEN BLDGS. LEFT 1/16" = 1'-0"

EXISTING ADJACENT BUILDING TO REMAIN - NO WORK IN THIS

EXISTING TO REMAIN


8 A-100 NEW ELEVATION BETWEEN BLDGS. LEFT

1/16" = 1'-0"

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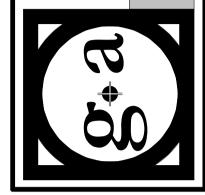


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1 t c h i t e c t s

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Phone: 504-366-4475

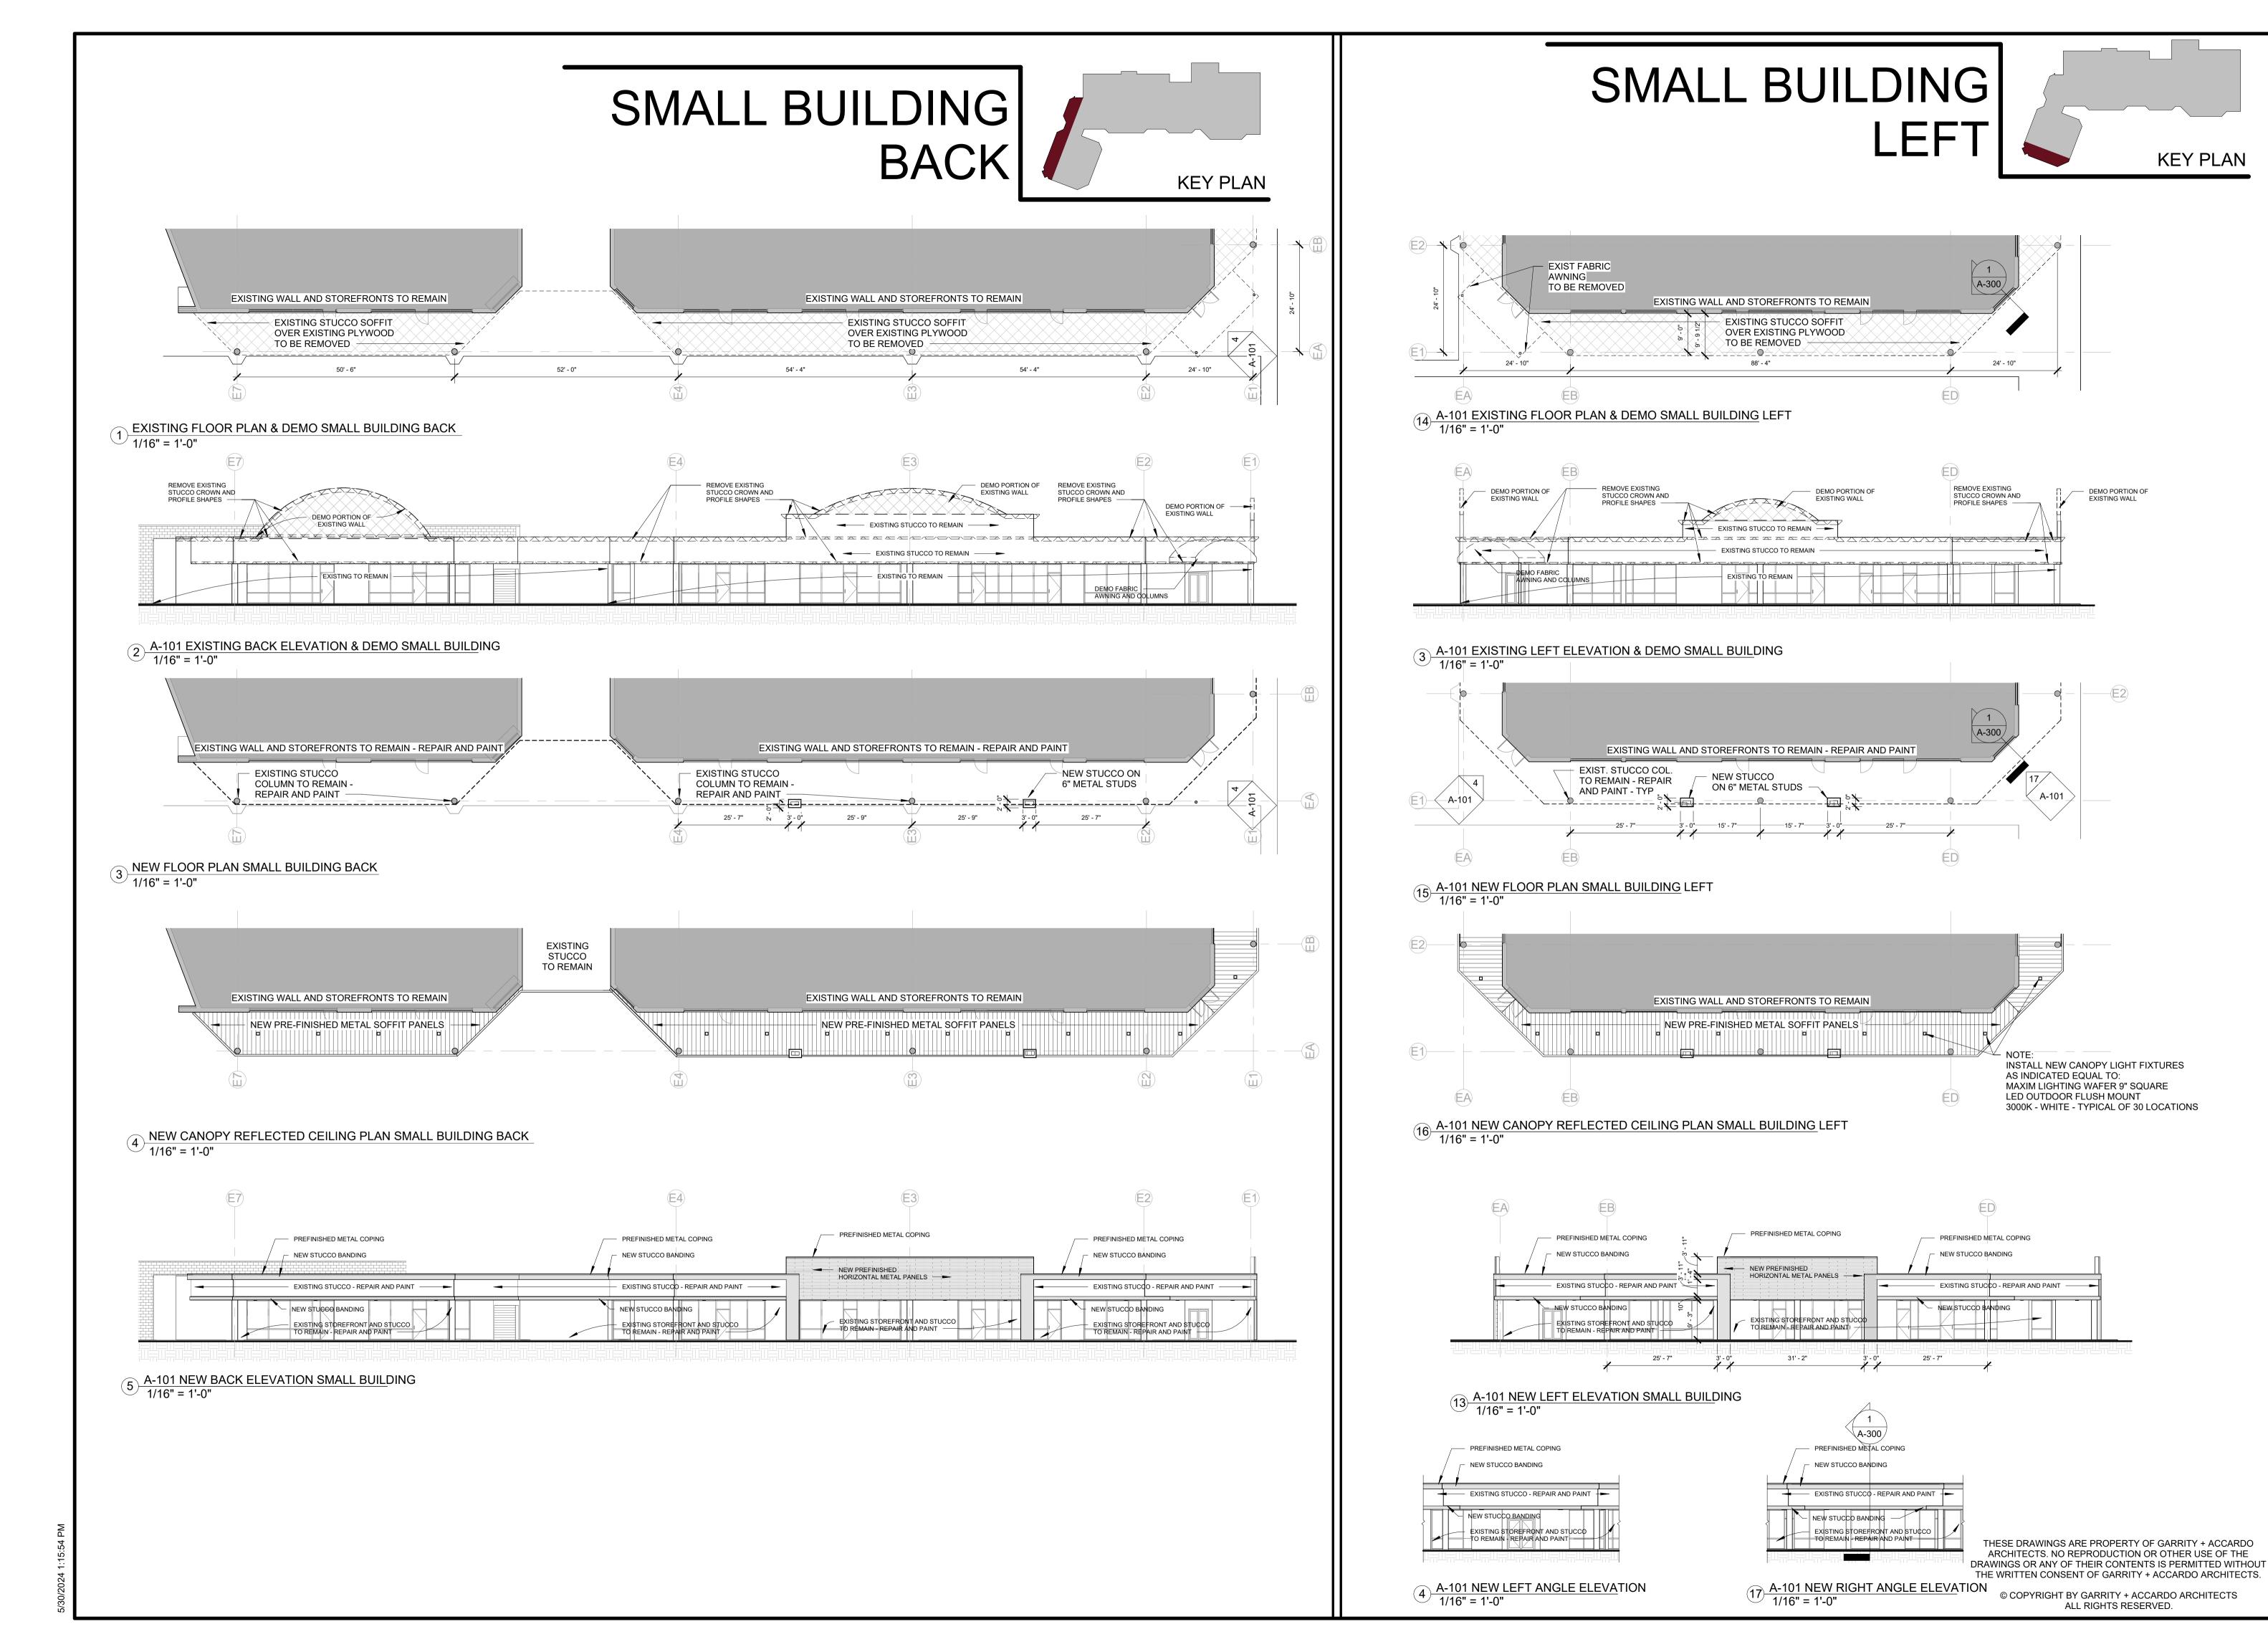



OJECT

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EET TITLE


NEW ELEVATIONS-SMALL BUILDING BACK & LEFT

REVISIONS

DATE 05.30.2024

PROJECT NUMBER 2410

SHEET NUMBER
A-101

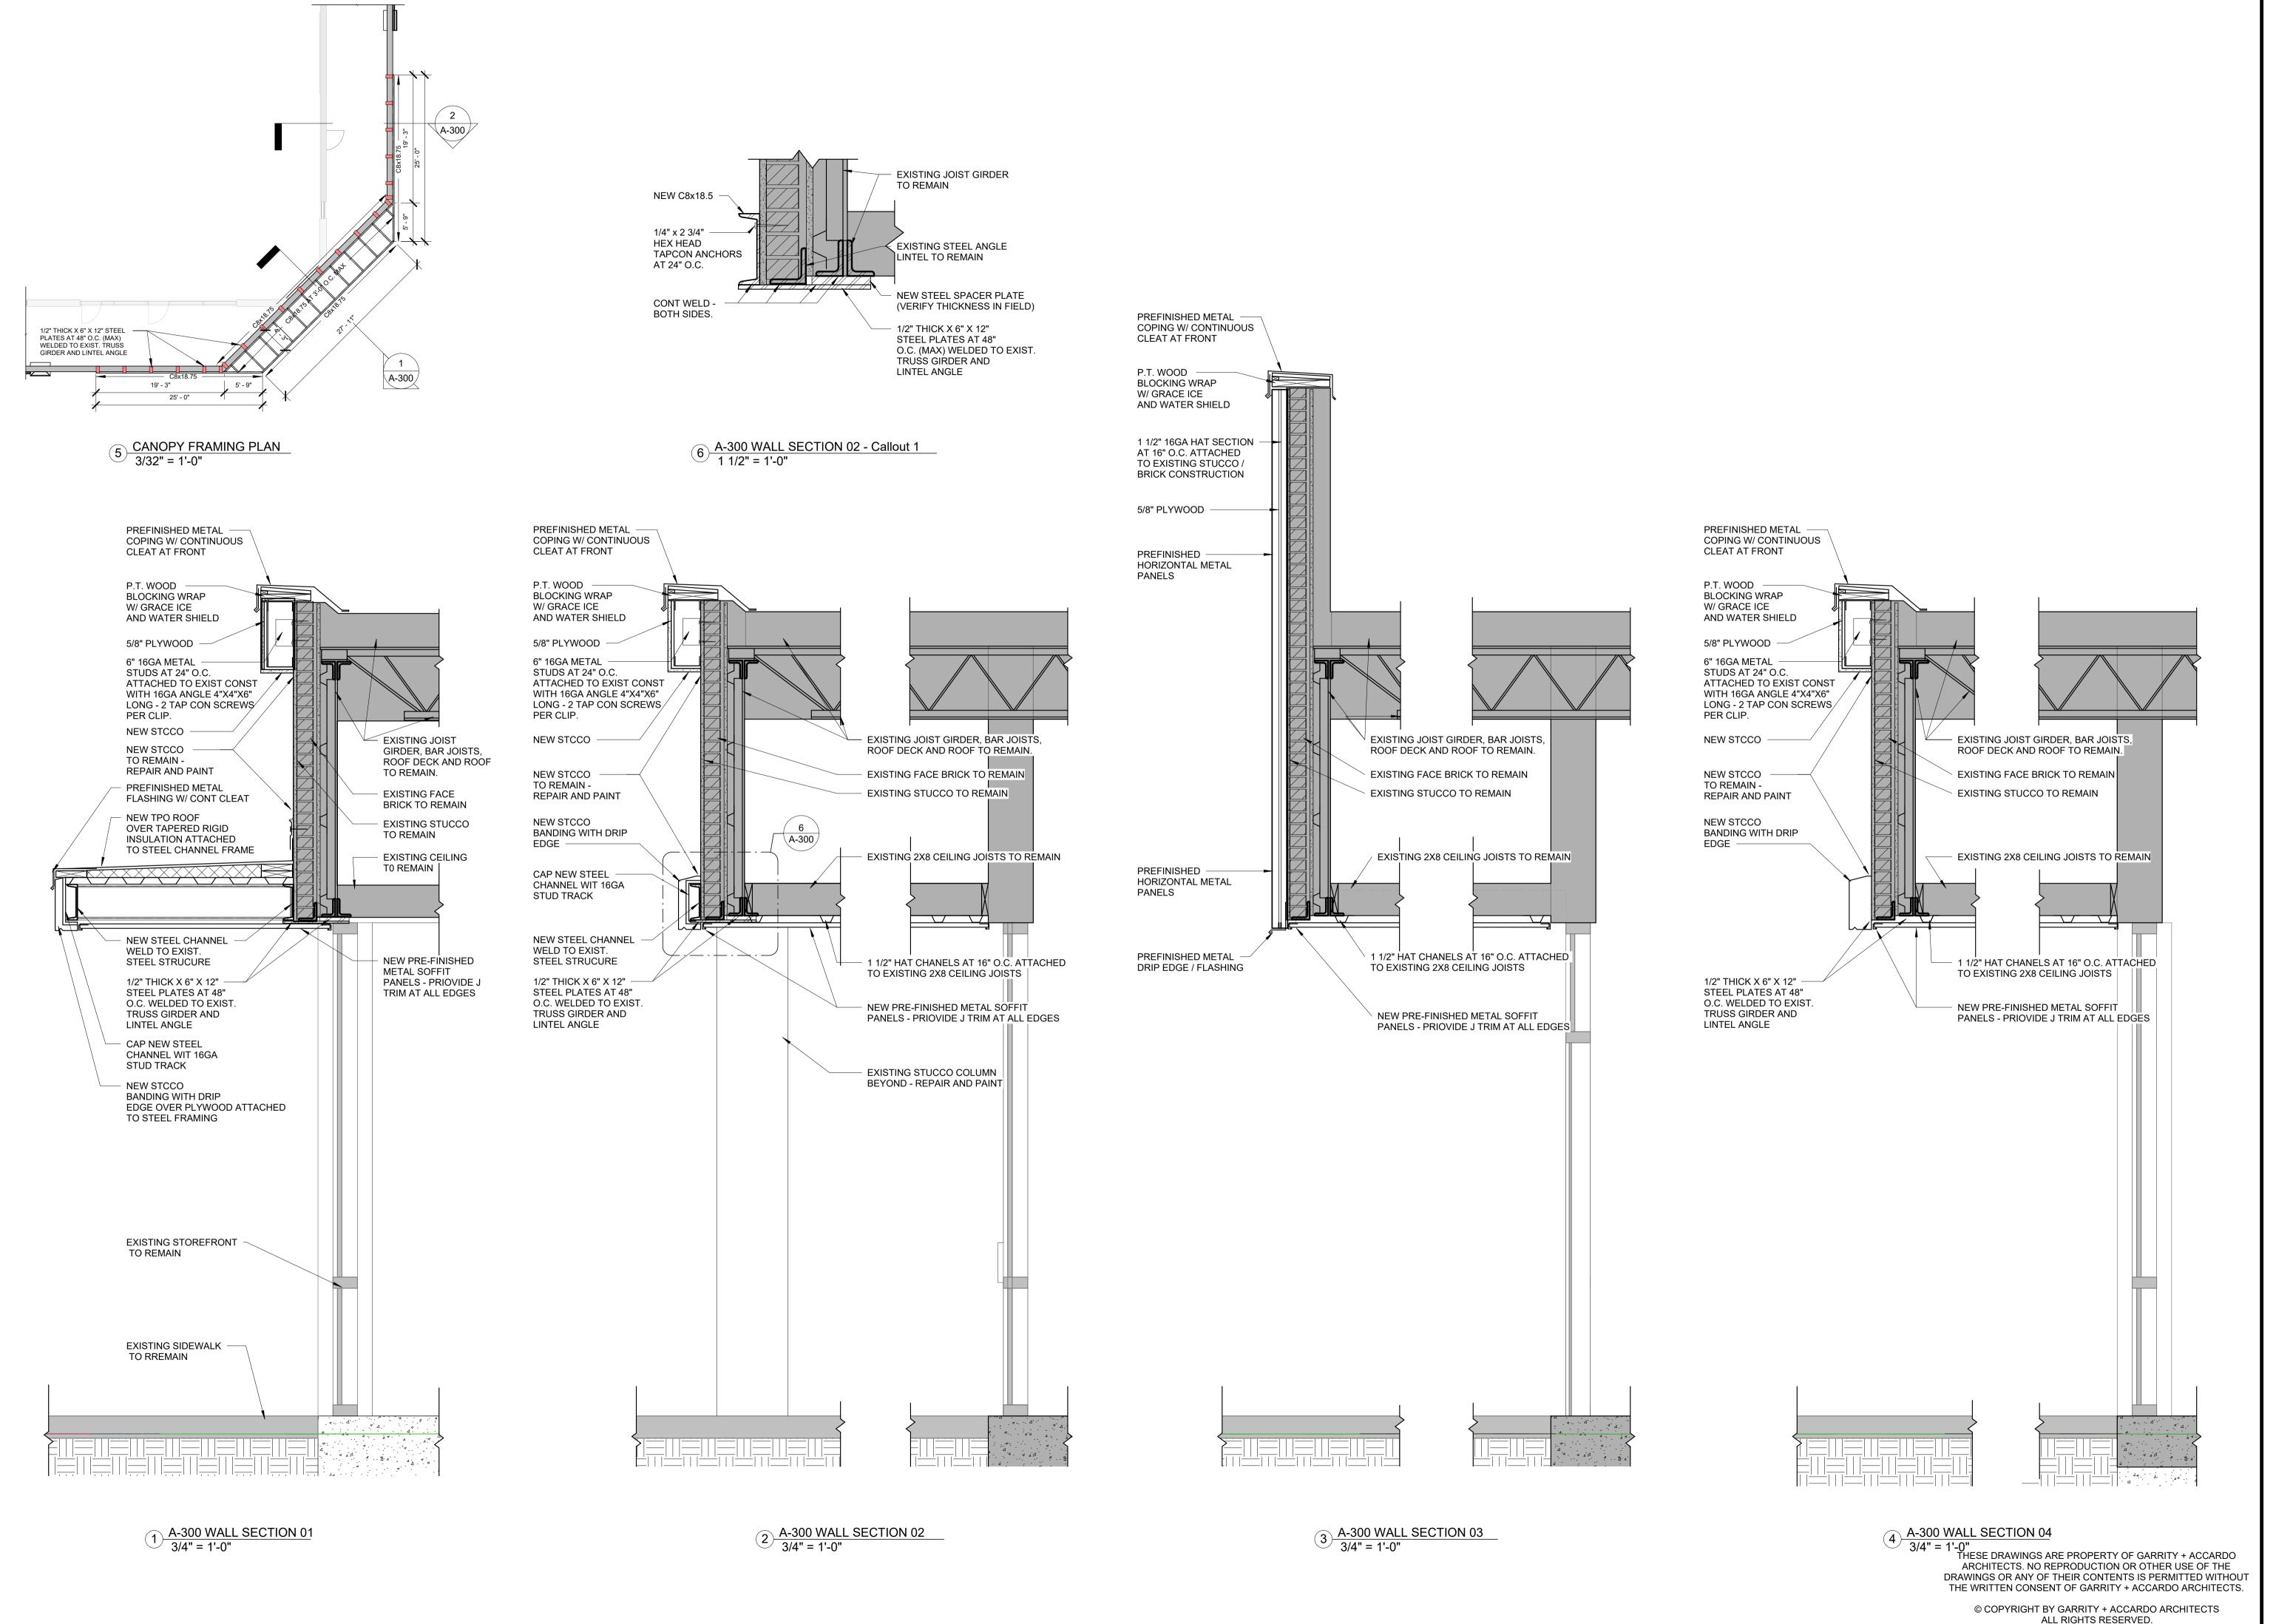

garrity + accardo
a r c h i t e c t s
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2401 Whitney Avenue Grenta, Louisiana 70056





REGISTERED ARCHITECT MINIMUM M

STBANK PLAZA FERIOR FACADE VOVATION

WESTBA EXTERIC RENOVA

ECTIONS AND S

REVISIONS

ATE 05.30.2024

PROJECT NUMBER
24105

A-300

