ISSUE FOR CONSTRUCTION

AUDUBON NATURE INSTITUTE RIVERVIEW PARK IMPROVEMENTS - PHASE 1

AUDUBON RIVERVIEW PARK NEW ORLEANS, LA



DRAWING ISSUE

ATE ISSUED FOR

3.19.24 DESIGN DEVELOPMENT

5.20.24 90% CD

6.28.24 FOR CONSTRUCTION

REVISIONS



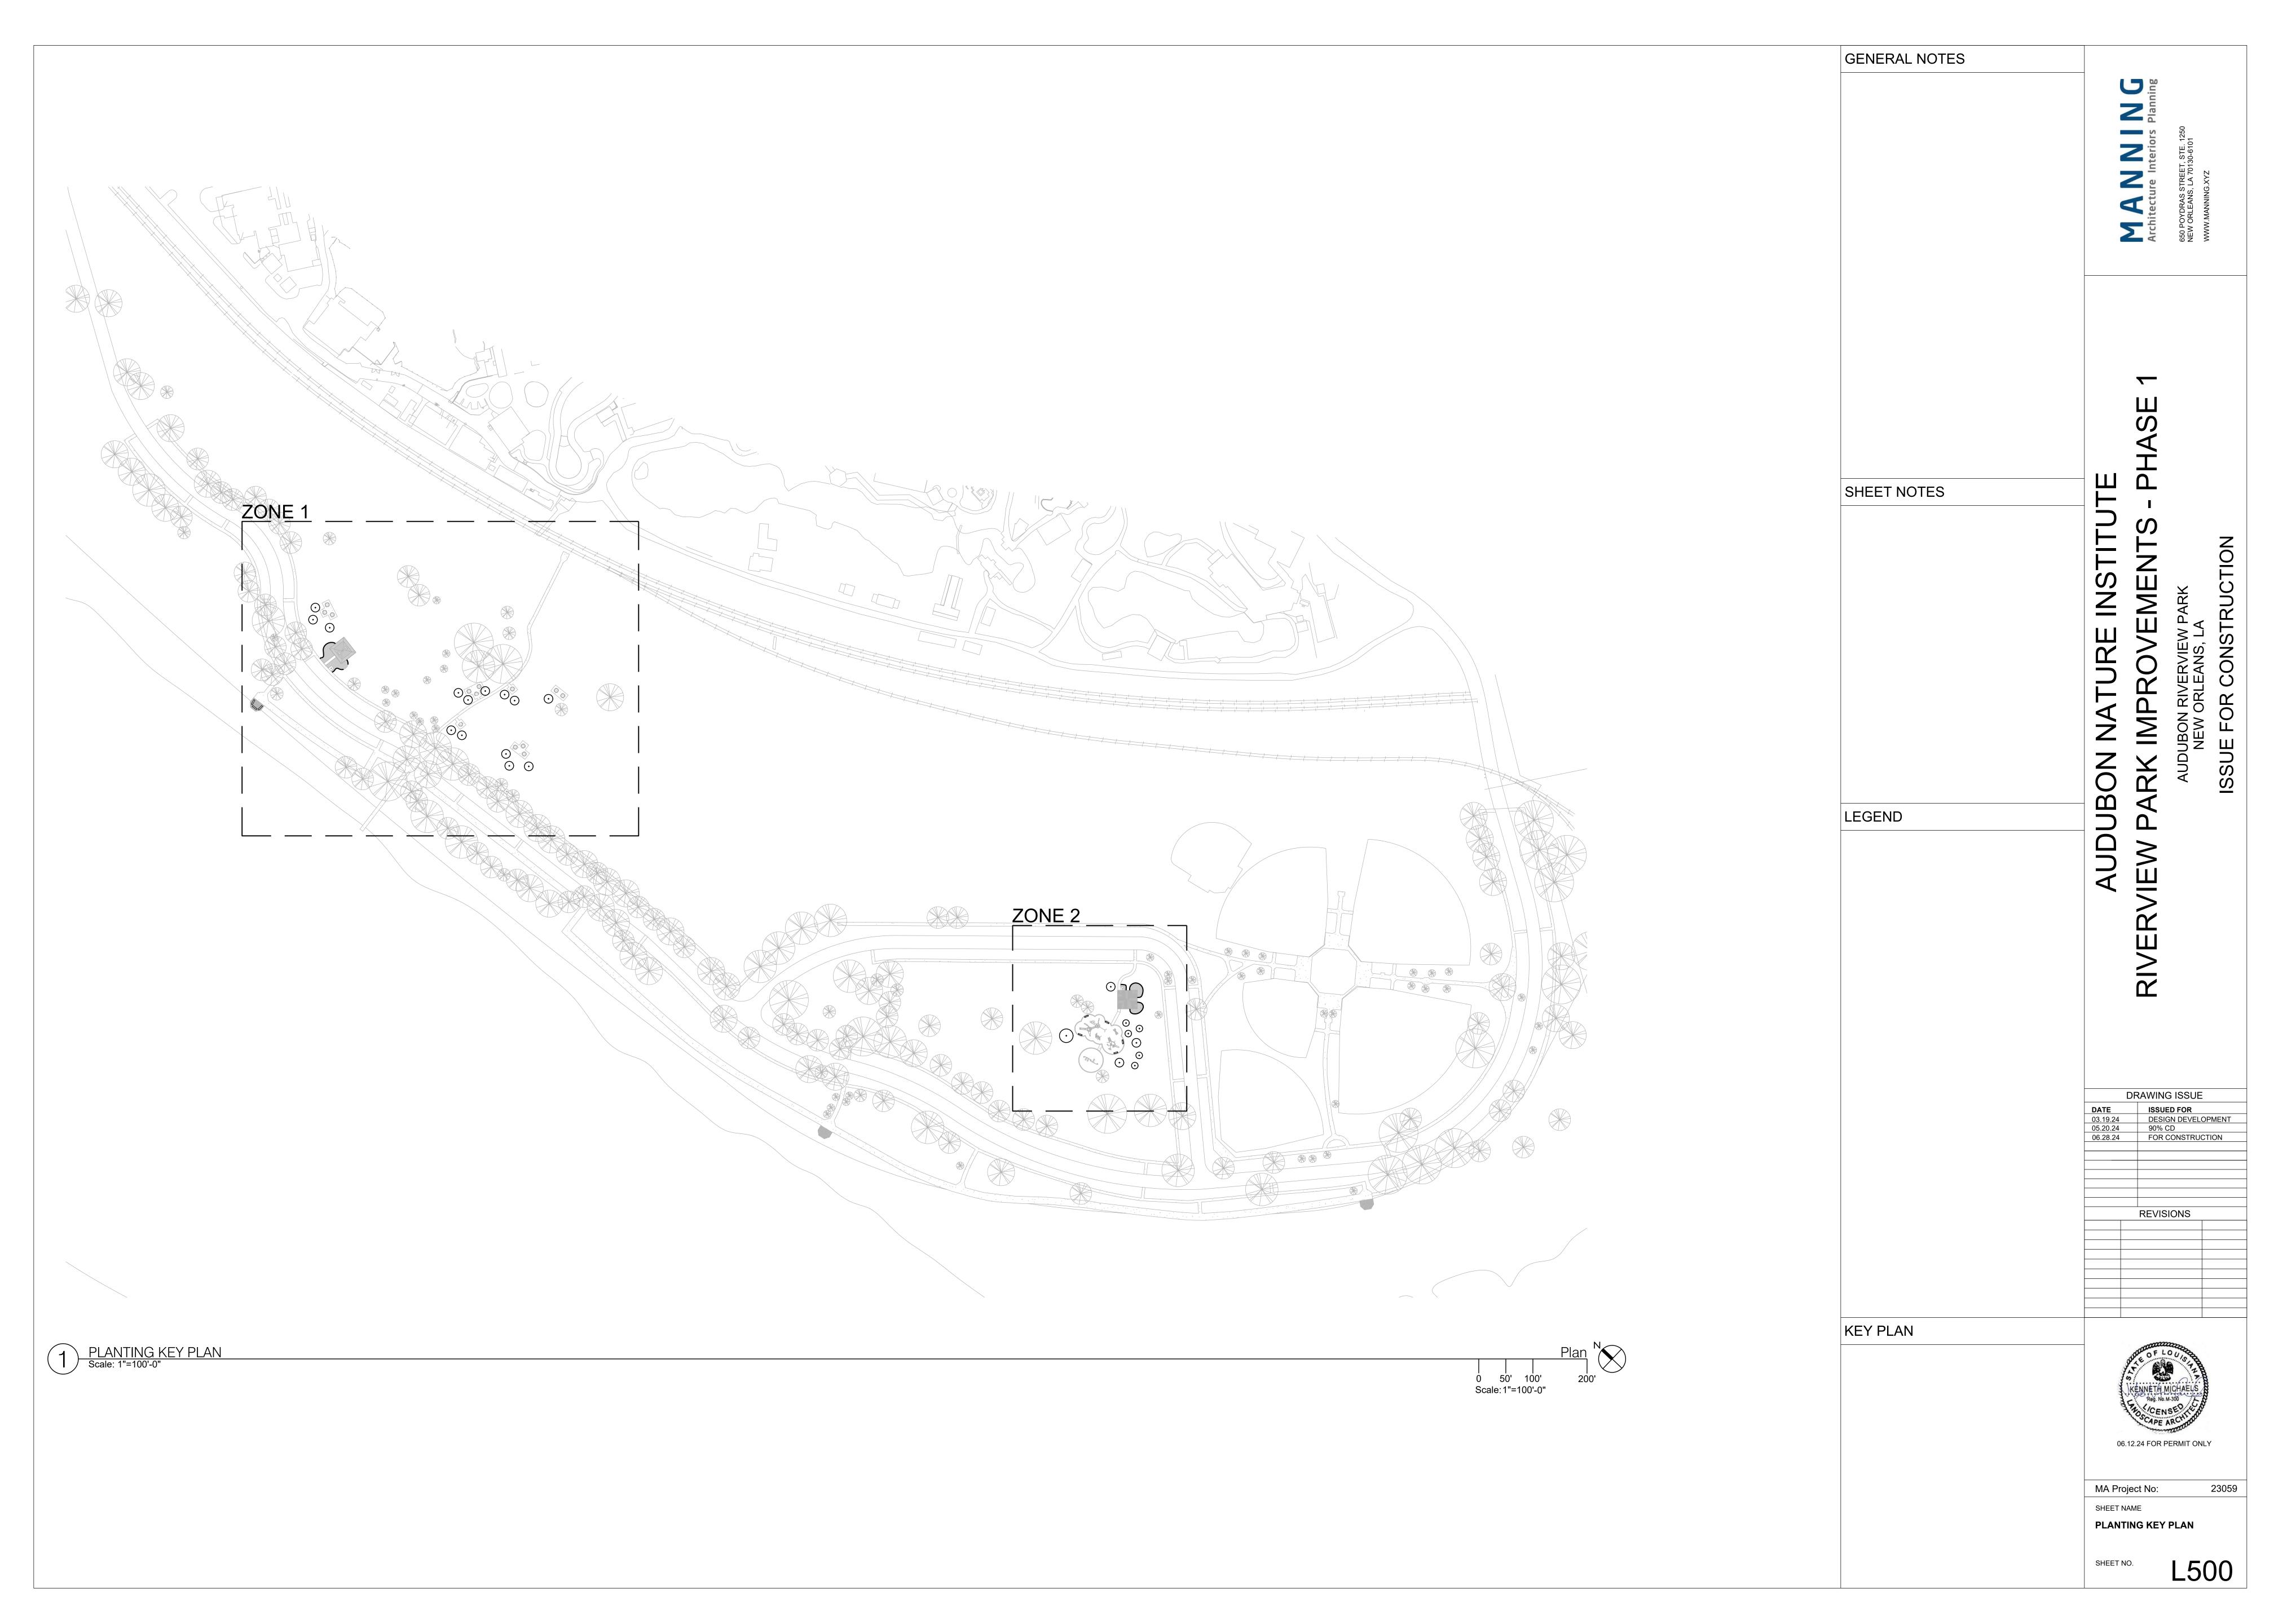
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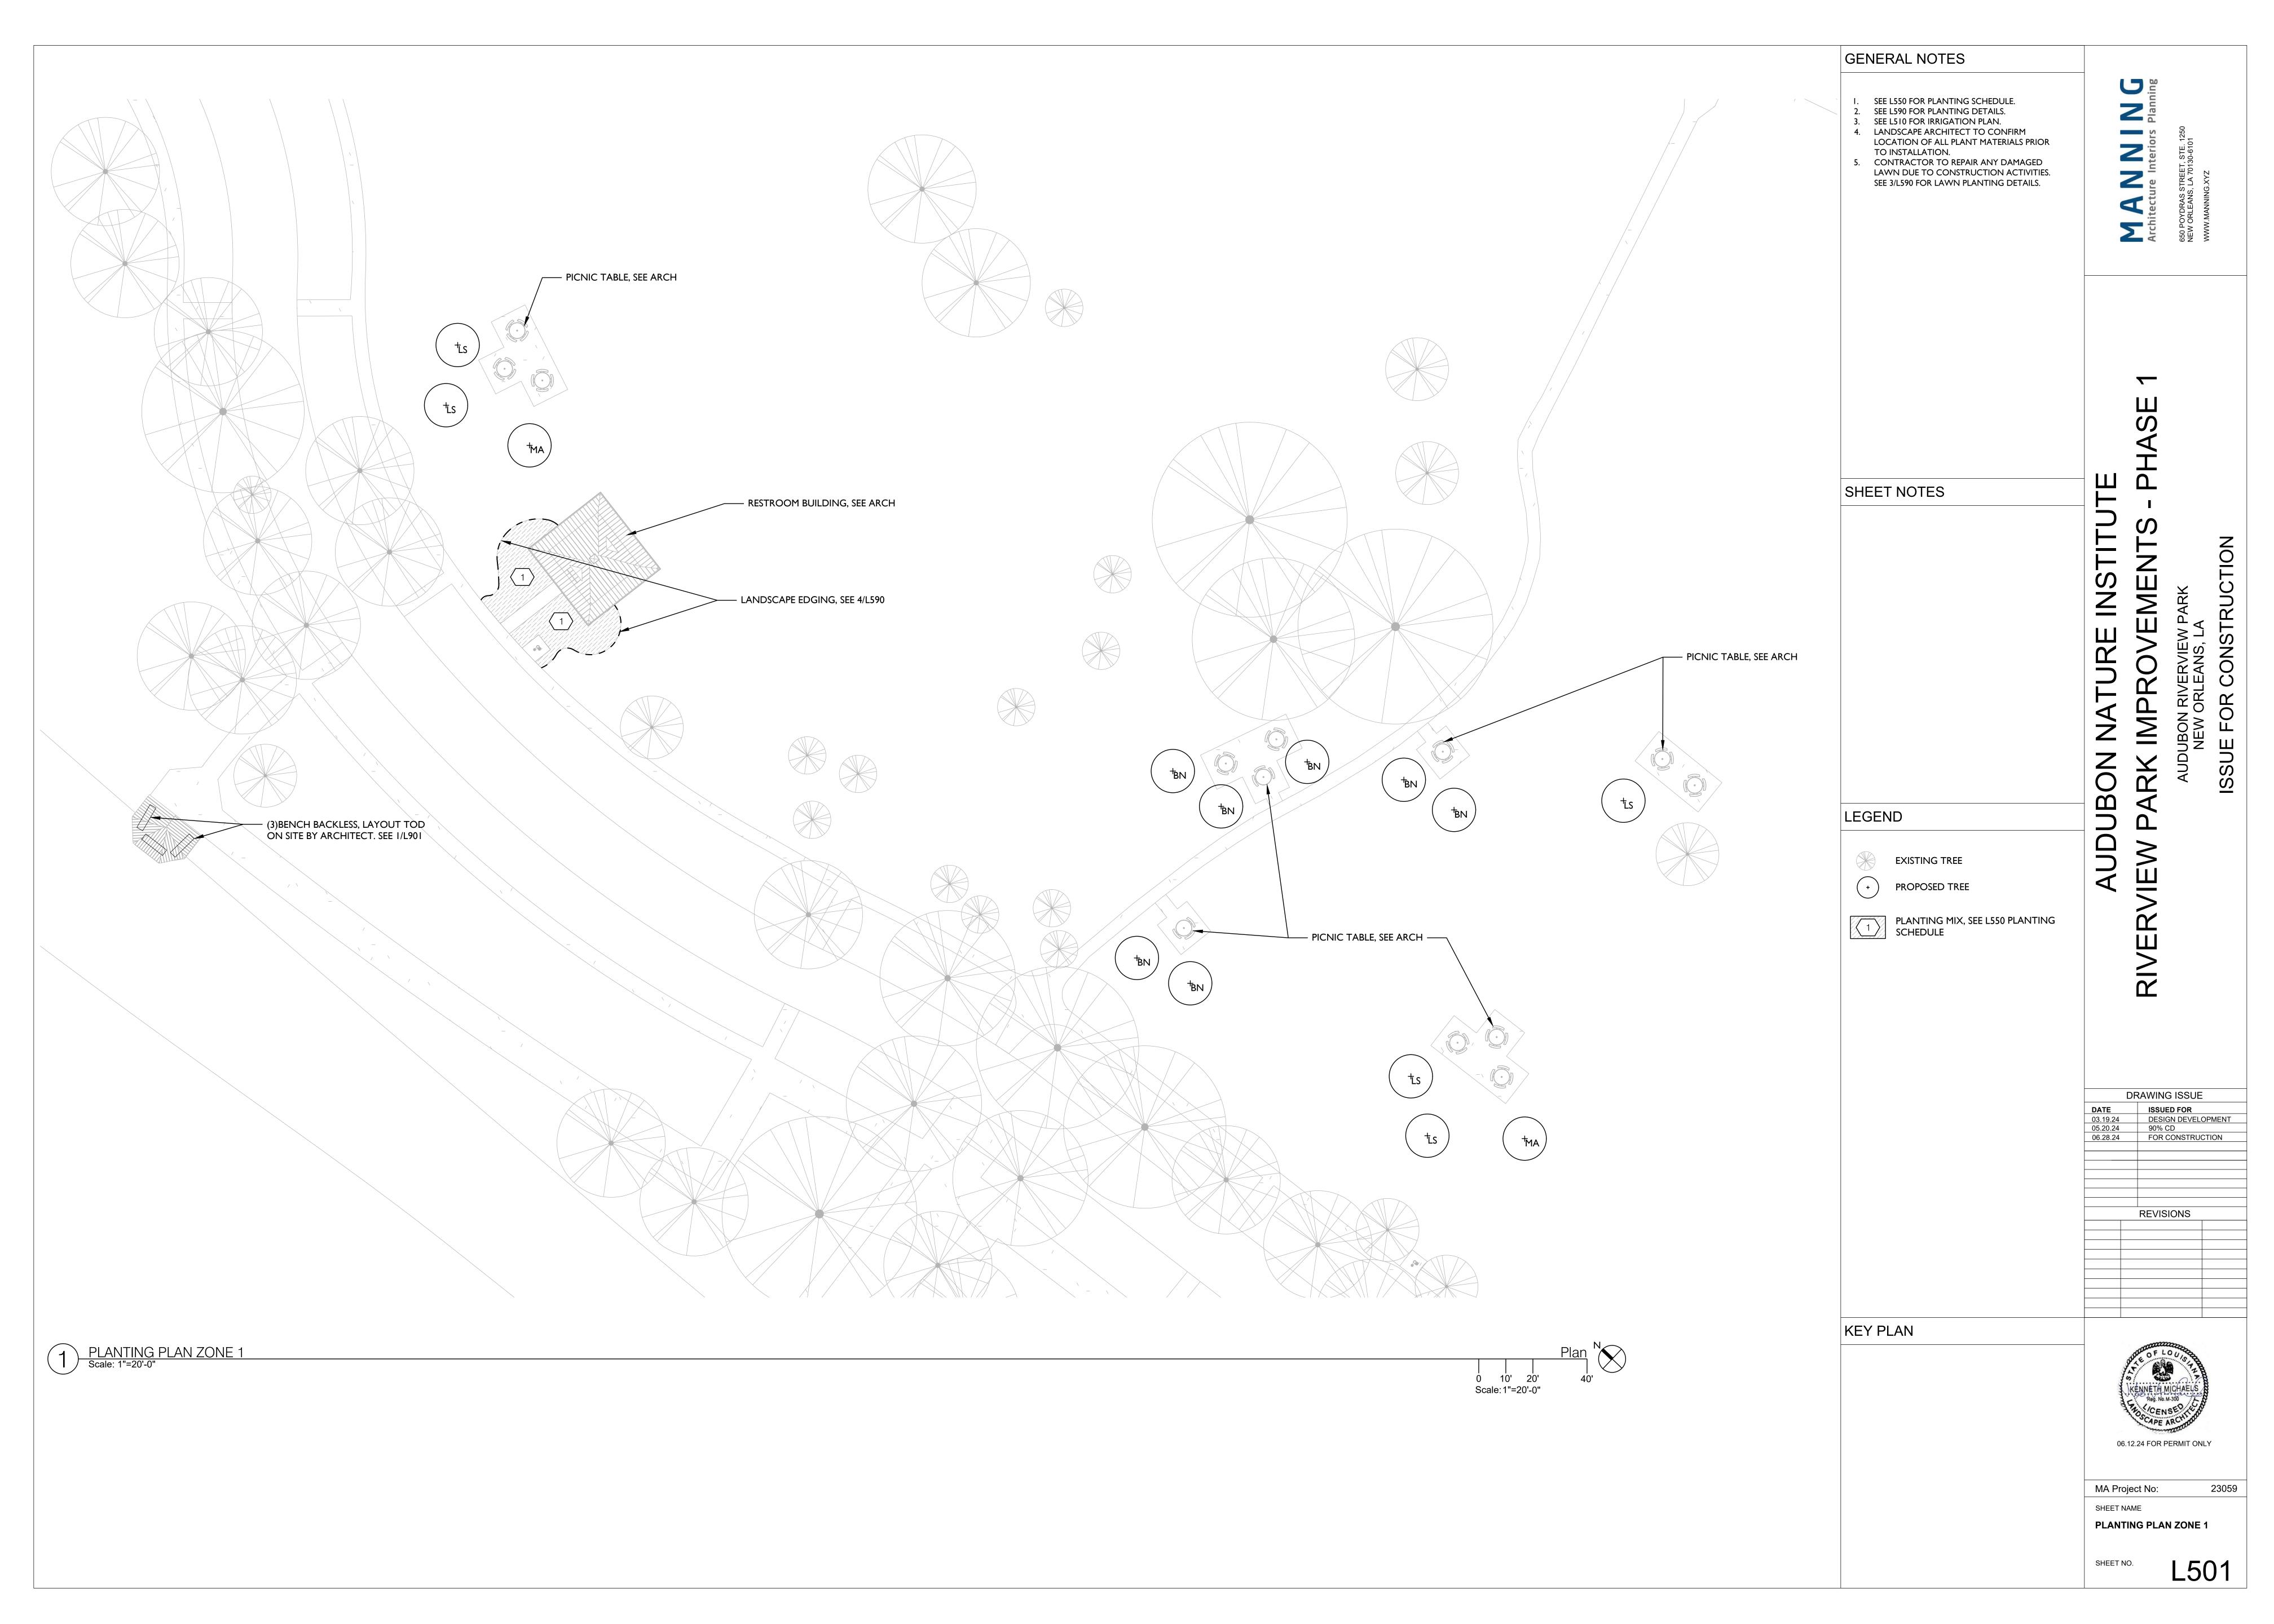
SHEET NAME

COVER SHEET

NO. **C**C

2000







				PLAN ⁻	Γ SCHEDULE (32 s	93 00)	
					TREES		
SYMBOL	COMMON NAME	BOTANICAL NAME	QTY	SIZE	ROOT BALL	SPACING	NOTES
+ MV	SWEETBAY MAGNOLIA	Magnolia virginiana	5	45 GAL	B&B	REF PLAN	MIN. I I'-0" OVER ALL HEIGHT. MULTI-TRUNK, 2TO 3 TRUNKS
t LS	SWEETGUM	Liquidambar styraciflua	6	3" CAL	B&B	REF PLAN	MUST HAVE STRONG CENTRAL LEADER MIN. CROTCH HEIGHT 6'-0"
+ BN	RIVER BIRCH	Betula nigra	7	45 GAL	B&B	REF PLAN	MIN. 11'-0" OVER ALL HEIGHT. MULTI-TRUNK, 2TO 3 TRUNKS
+ MA	SOUTHERN MAGNOLIA	Magnolia grandiflora	3	3" CAL	B&B	REF PLAN	MUST HAVE STRONG CENTRAL LEADER MIN. CROTCH HEIGHT 6'-0"
t CV	FRINGE TREE	Chionanthus virginicus	I	3" CAL	B&B	REF PLAN	MUST HAVE STRONG CENTRAL LEADER MIN. CROTCH HEIGHT 6'-0"
+ BS	BIG SHADE TREE	SEE NOTES	I	8" CAL	B&B	REF PLAN	TO BE SELECTED BY OWNER. OPTIONS ARE: LIVE OAK NUTTAL OAK SOUTHERN MAGNOLIA SWEET GUM MUST HAVE STRONG CENTRAL LEADER MIN. HEIGHT 25'-0"

PERENNIALS/ORNAMENTAL GRASS & GROUNDCOVER									
SYMBOL	COMMON NAME	BOTANICAL NAME	QTY	SIZE	SPACING	NOTES			
1	PLANTING MIX	SEE NOTES	1,834 SF	SEE NOTES	SEE NOTES	15% Morella cerifera 'Don's Dwarf', 3 GAL, 36" O.C. 30% Ilex glabra, 7 GAL, 36'O.C. 25% Juncus inflexus 'Blue Arrows', 7 GAL, 18" O.C. 30% Crinum americanum, IGAL, 36" O.C.			
	PINE STRAW MULCH		2,650 SF	3" LAYER		ALL PLANT BEDS AND 4' RADIUS AROUND ALL TREES			

- I. UNLESS OTHERWISE NOTED ON THE DRAWINGS, CONTRACTOR SHALL ALWAYS USE THE STRICTER REQUIREMENT WHEN PLACING DIFFERENT SPECIES NEXT TO EACH OTHER.

 2. UNLESS OTHERWISE NOTED ON DRAWINGS, ANY PLANT THAT IS LESS THAN 3 GAL SHALL BE PLACED NO FURTHER THAN 6 INCH AWAY FROM THE EDGE OF THE PLANTER/PLANTING BED ON ALL SIDES. ANY PLANT THAT IS EQUAL OR LARGER THAN 3 GAL SHALL BE PLACED NO FURTHER THAN 12 INCH AWAY FROM THE EDGE OF THE
- PLANTER/PLANTING BED ON ALL SIDES. 3. PLANTS SHALL BE PACED EVENLY PER PLANTING SCHEDULE. ANY INCORRECT SPACING WILL NOT BE ACCEPTED.
- 4. UNLESS OTHERWISE NOTED ON THE DRAWINGS, PLANTING SOIL FINISH GRADE SHALL BE 3" BELOW THE SURROUNDING PLANTING BED/PLANTER EDGE. MULCH FINISH GRADE SHALL BE FLUSH WITH THE SURROUNDING PLANTING BED/PLANTER EDGE.
- 5. CONTRACTOR SHALL ARRANGE POTTED PLANTS PER PLANTING PLAN AND NOTIFY LANDSCAPE ARCHITECT 72 HOURS AHEAD TO APPROVE PLANTING LAYOUT ON SITE PRIOR TO PLANTS INSTALLATION.



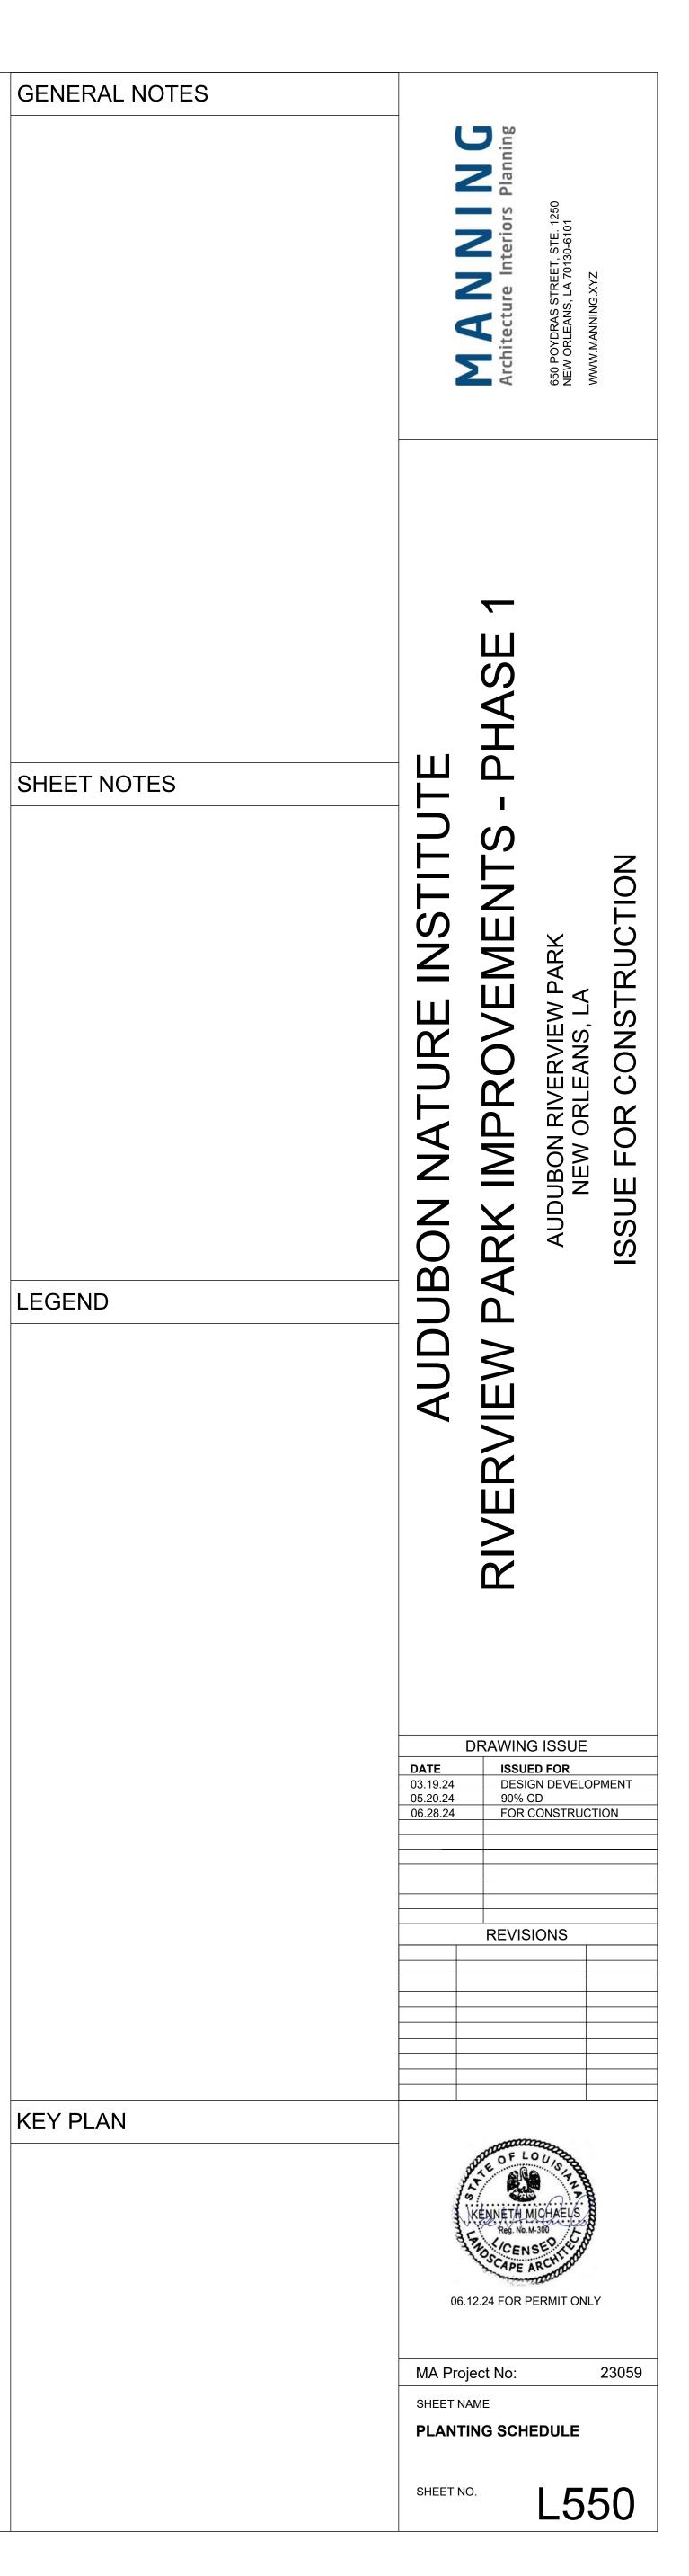


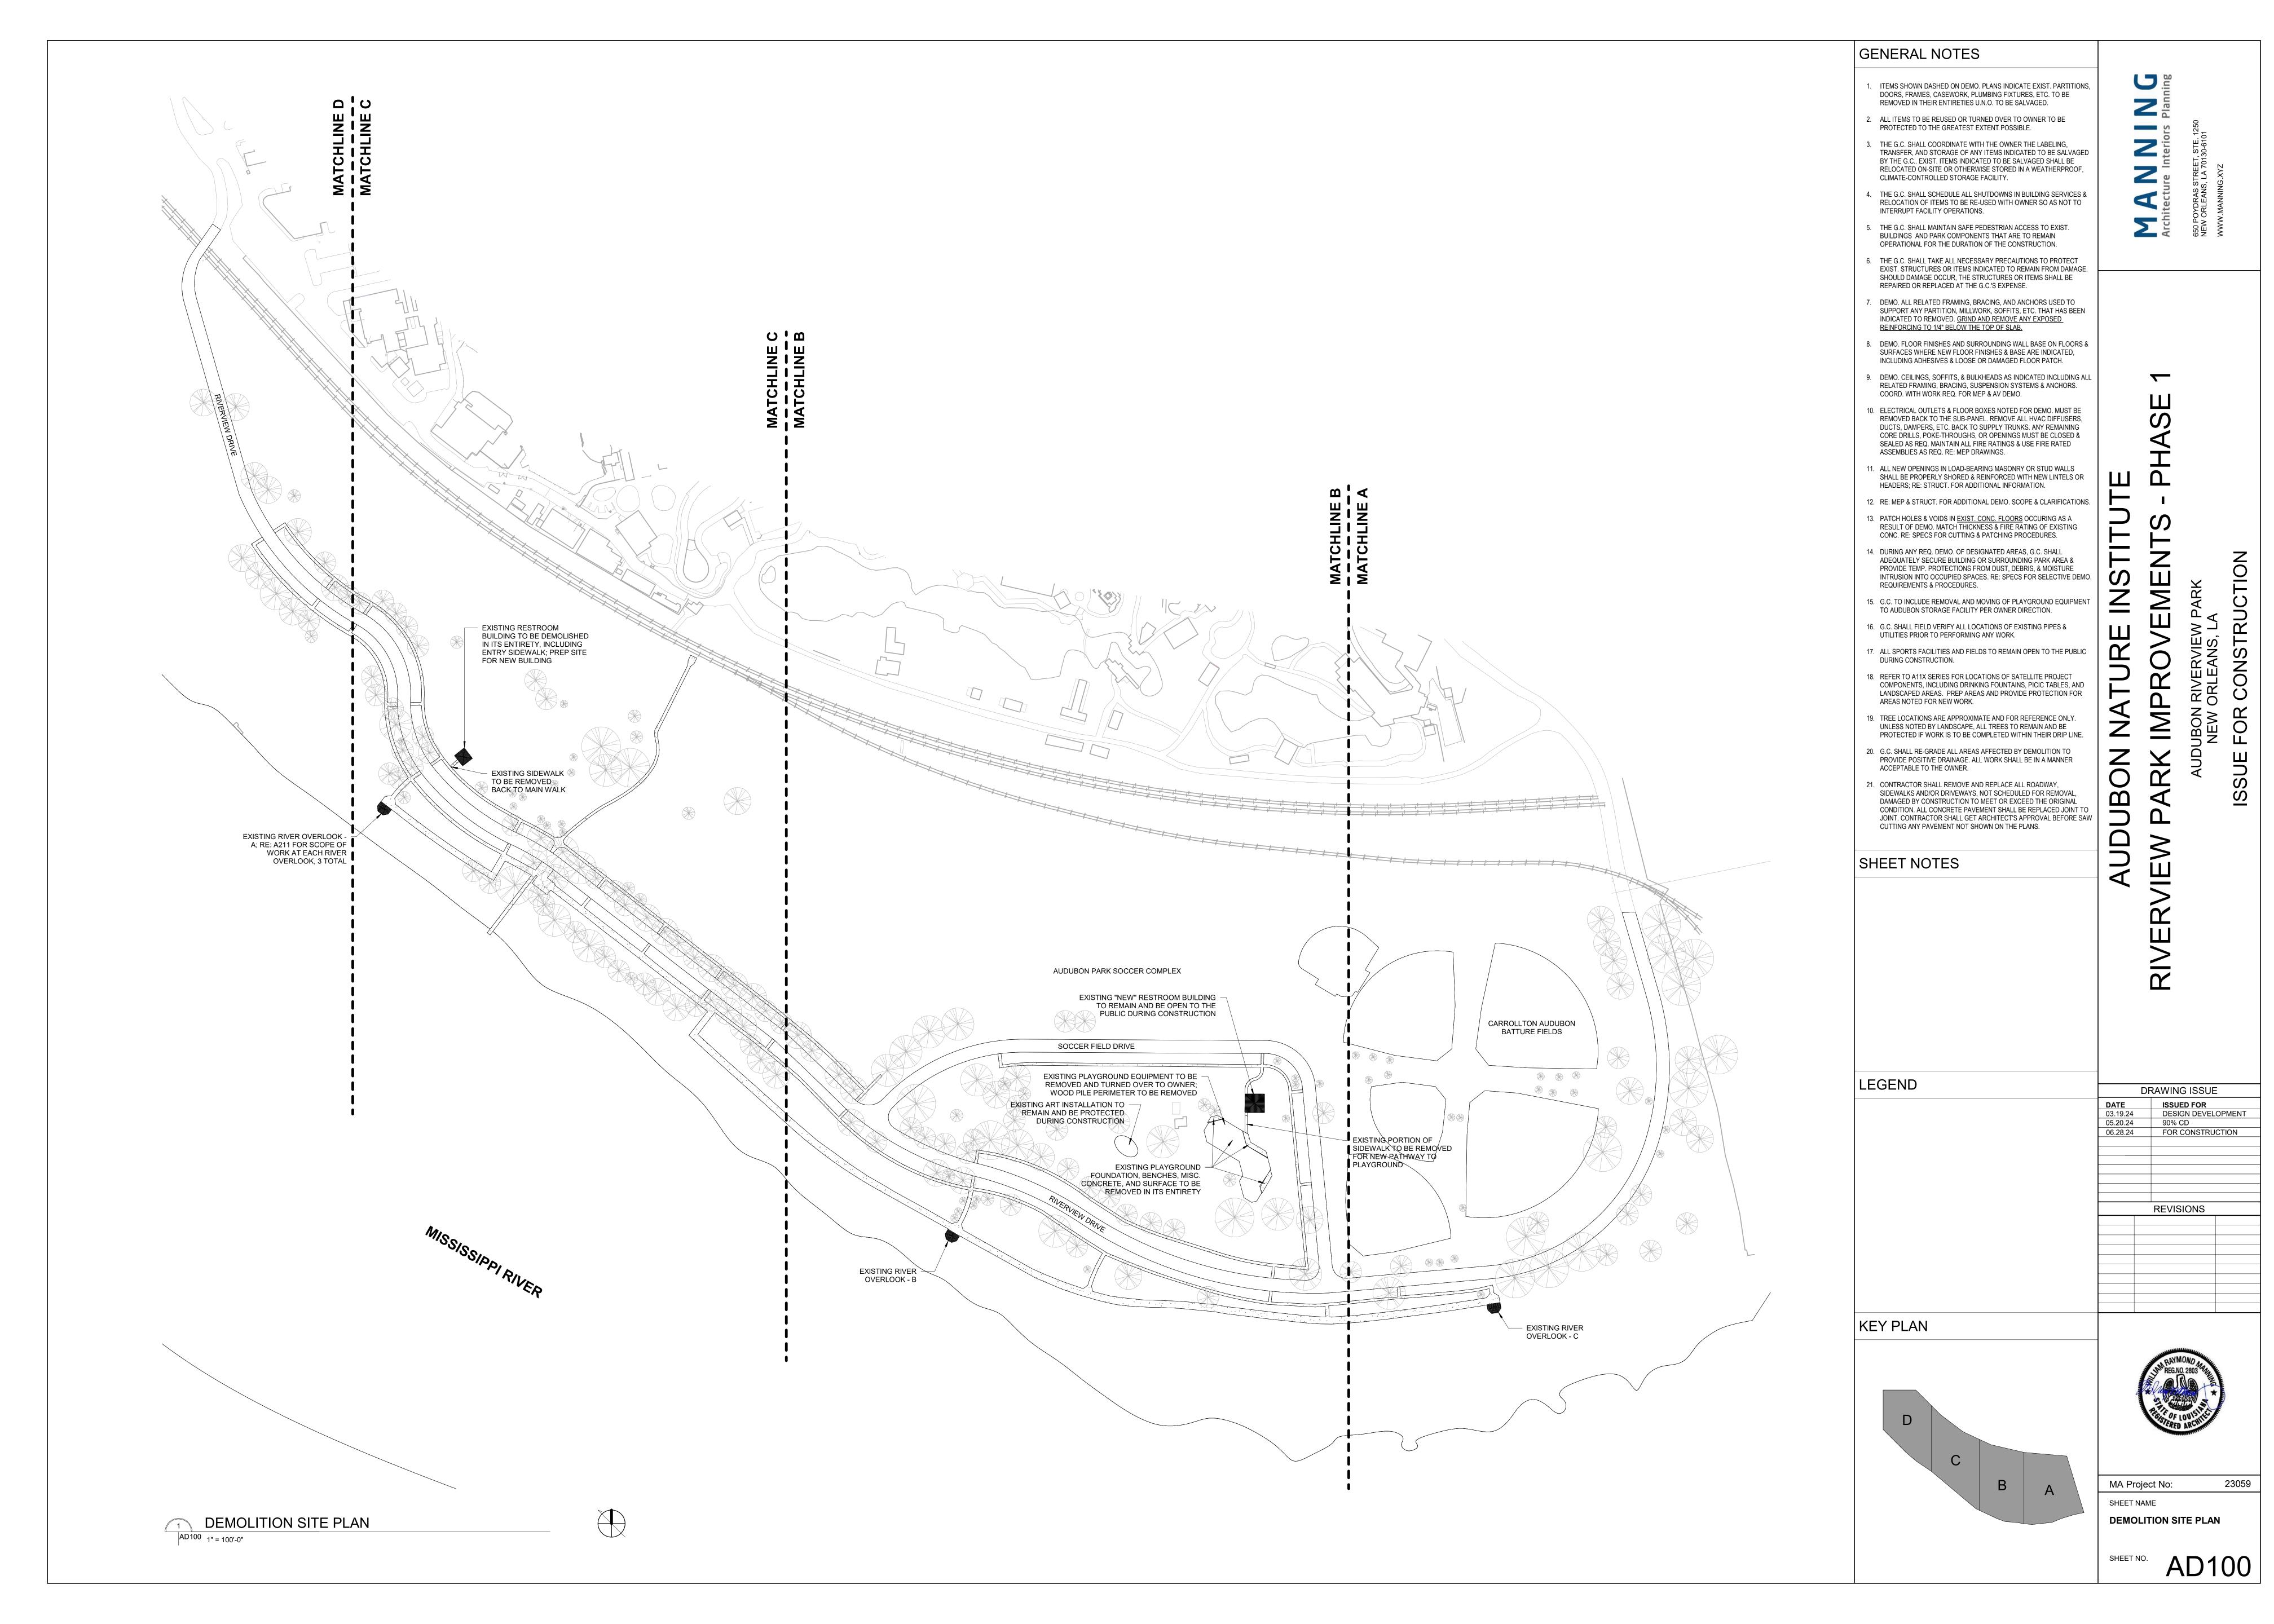


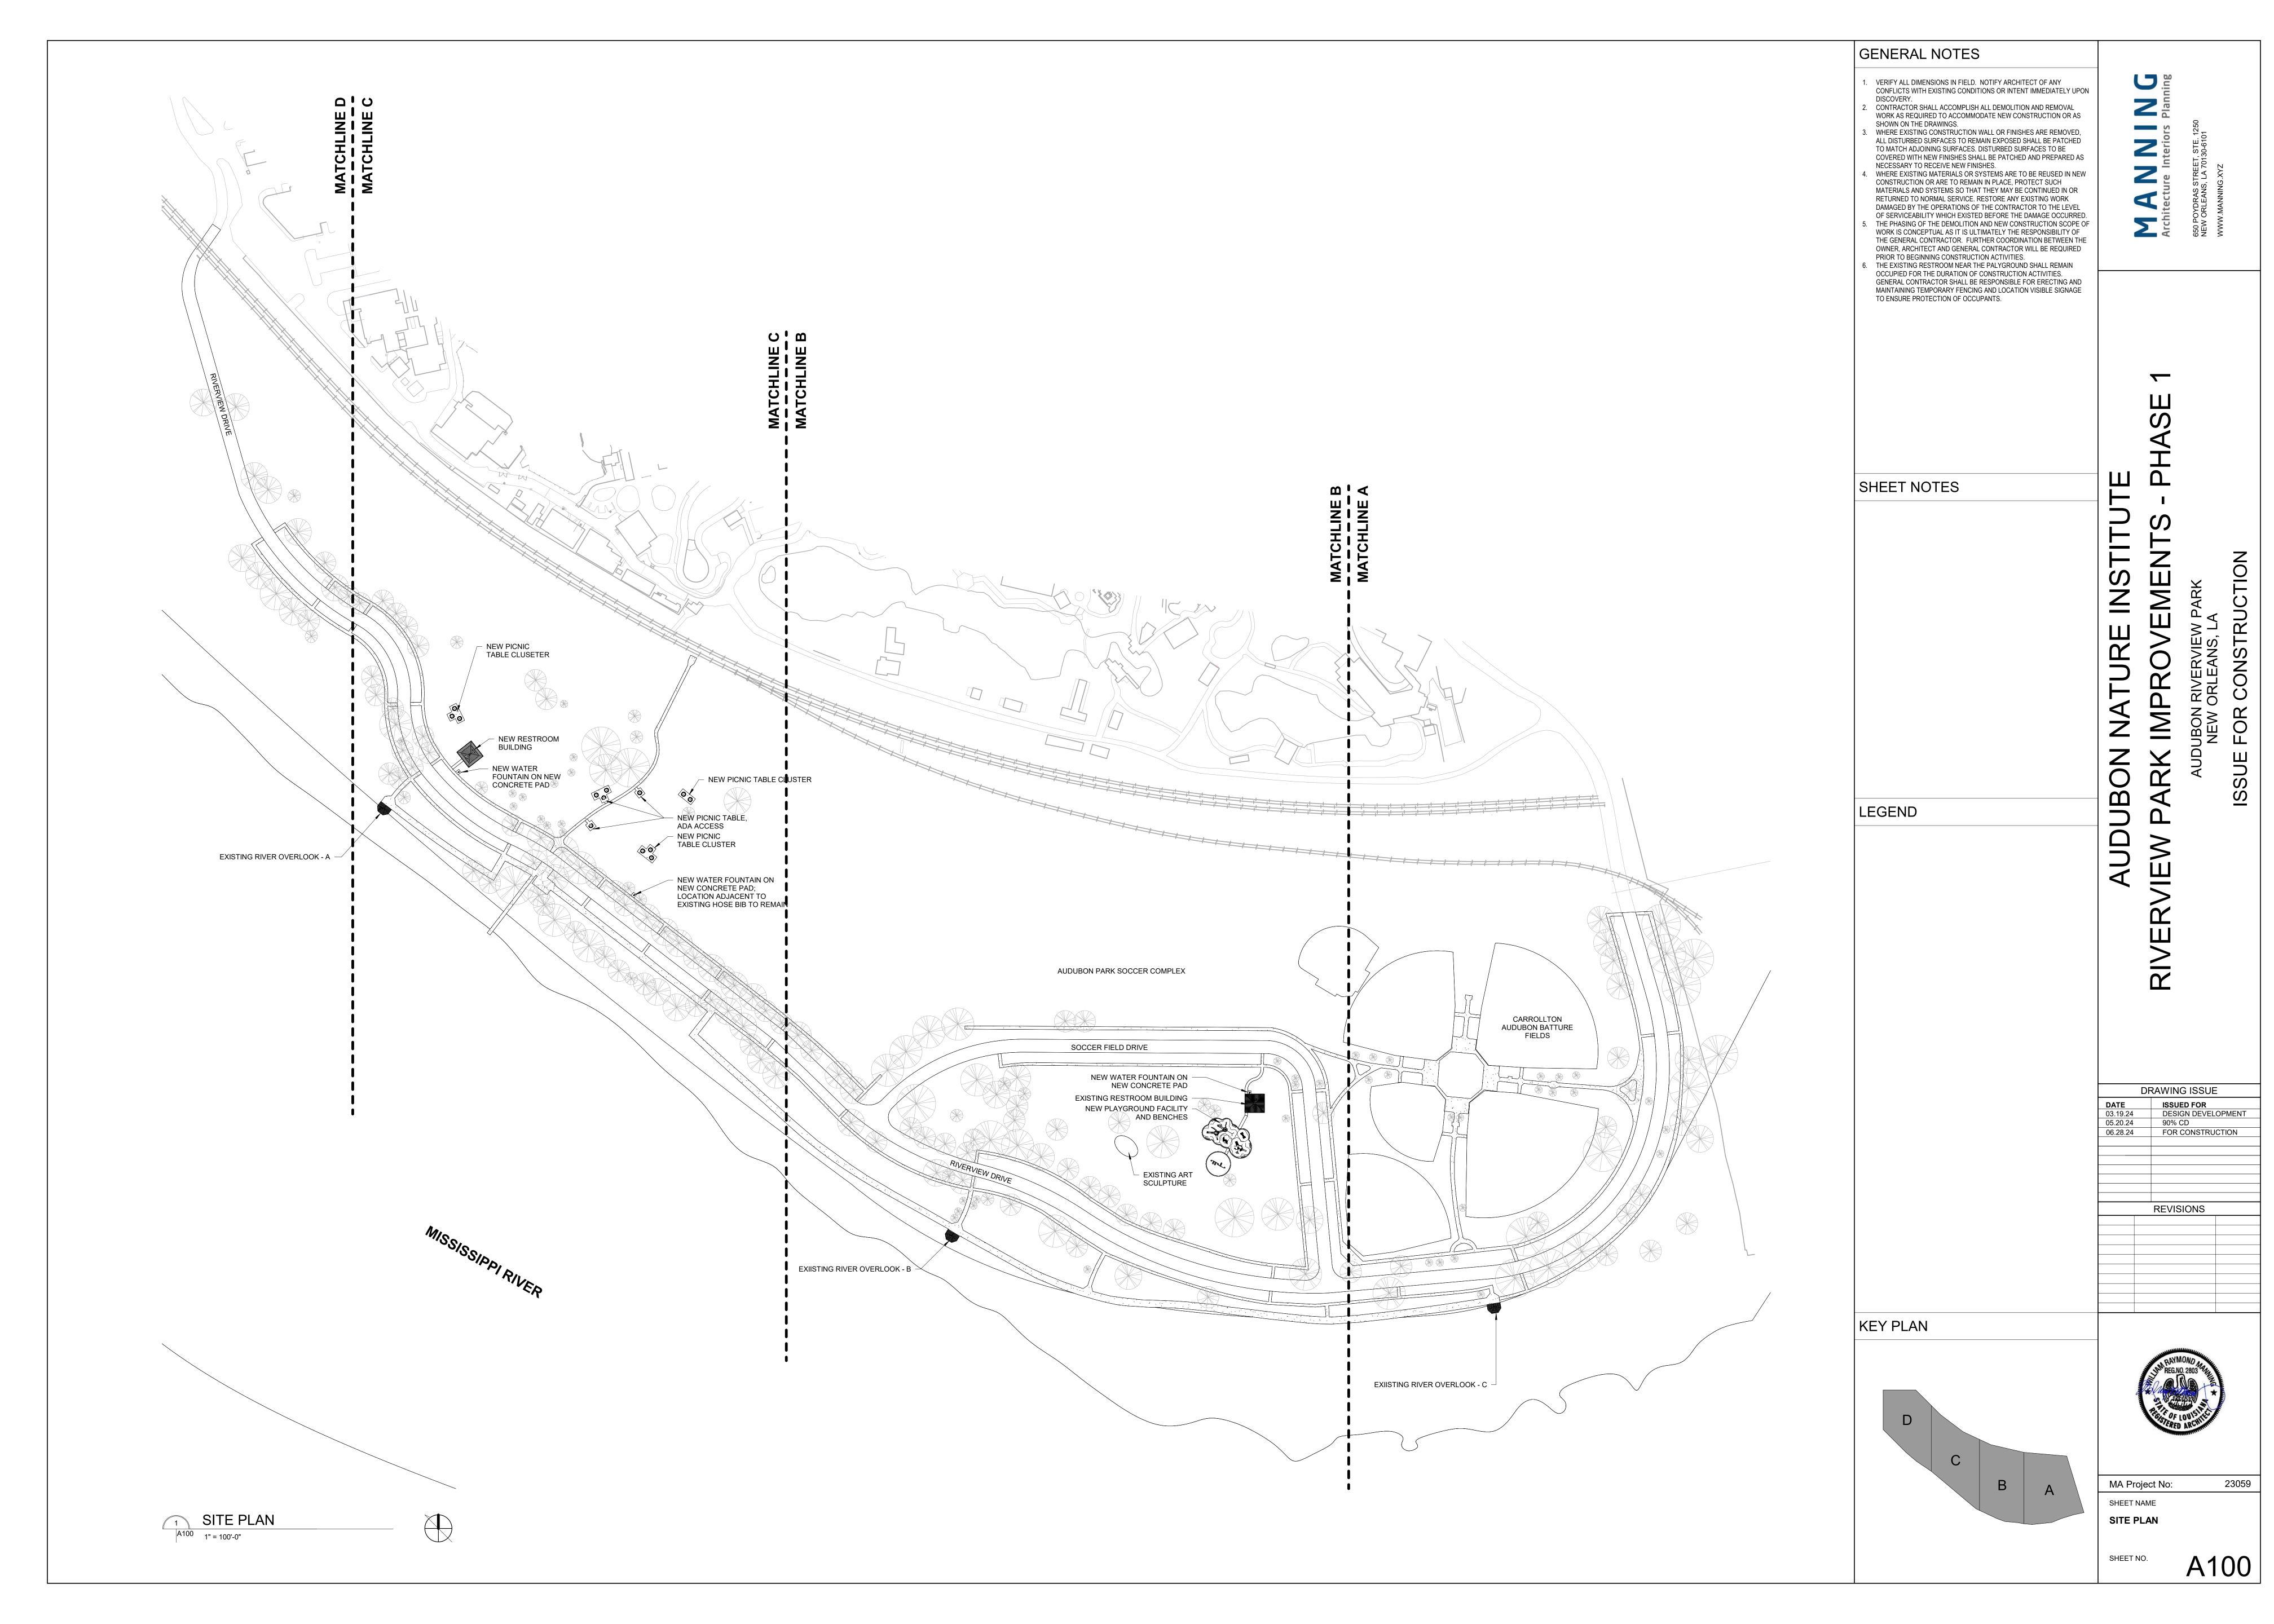


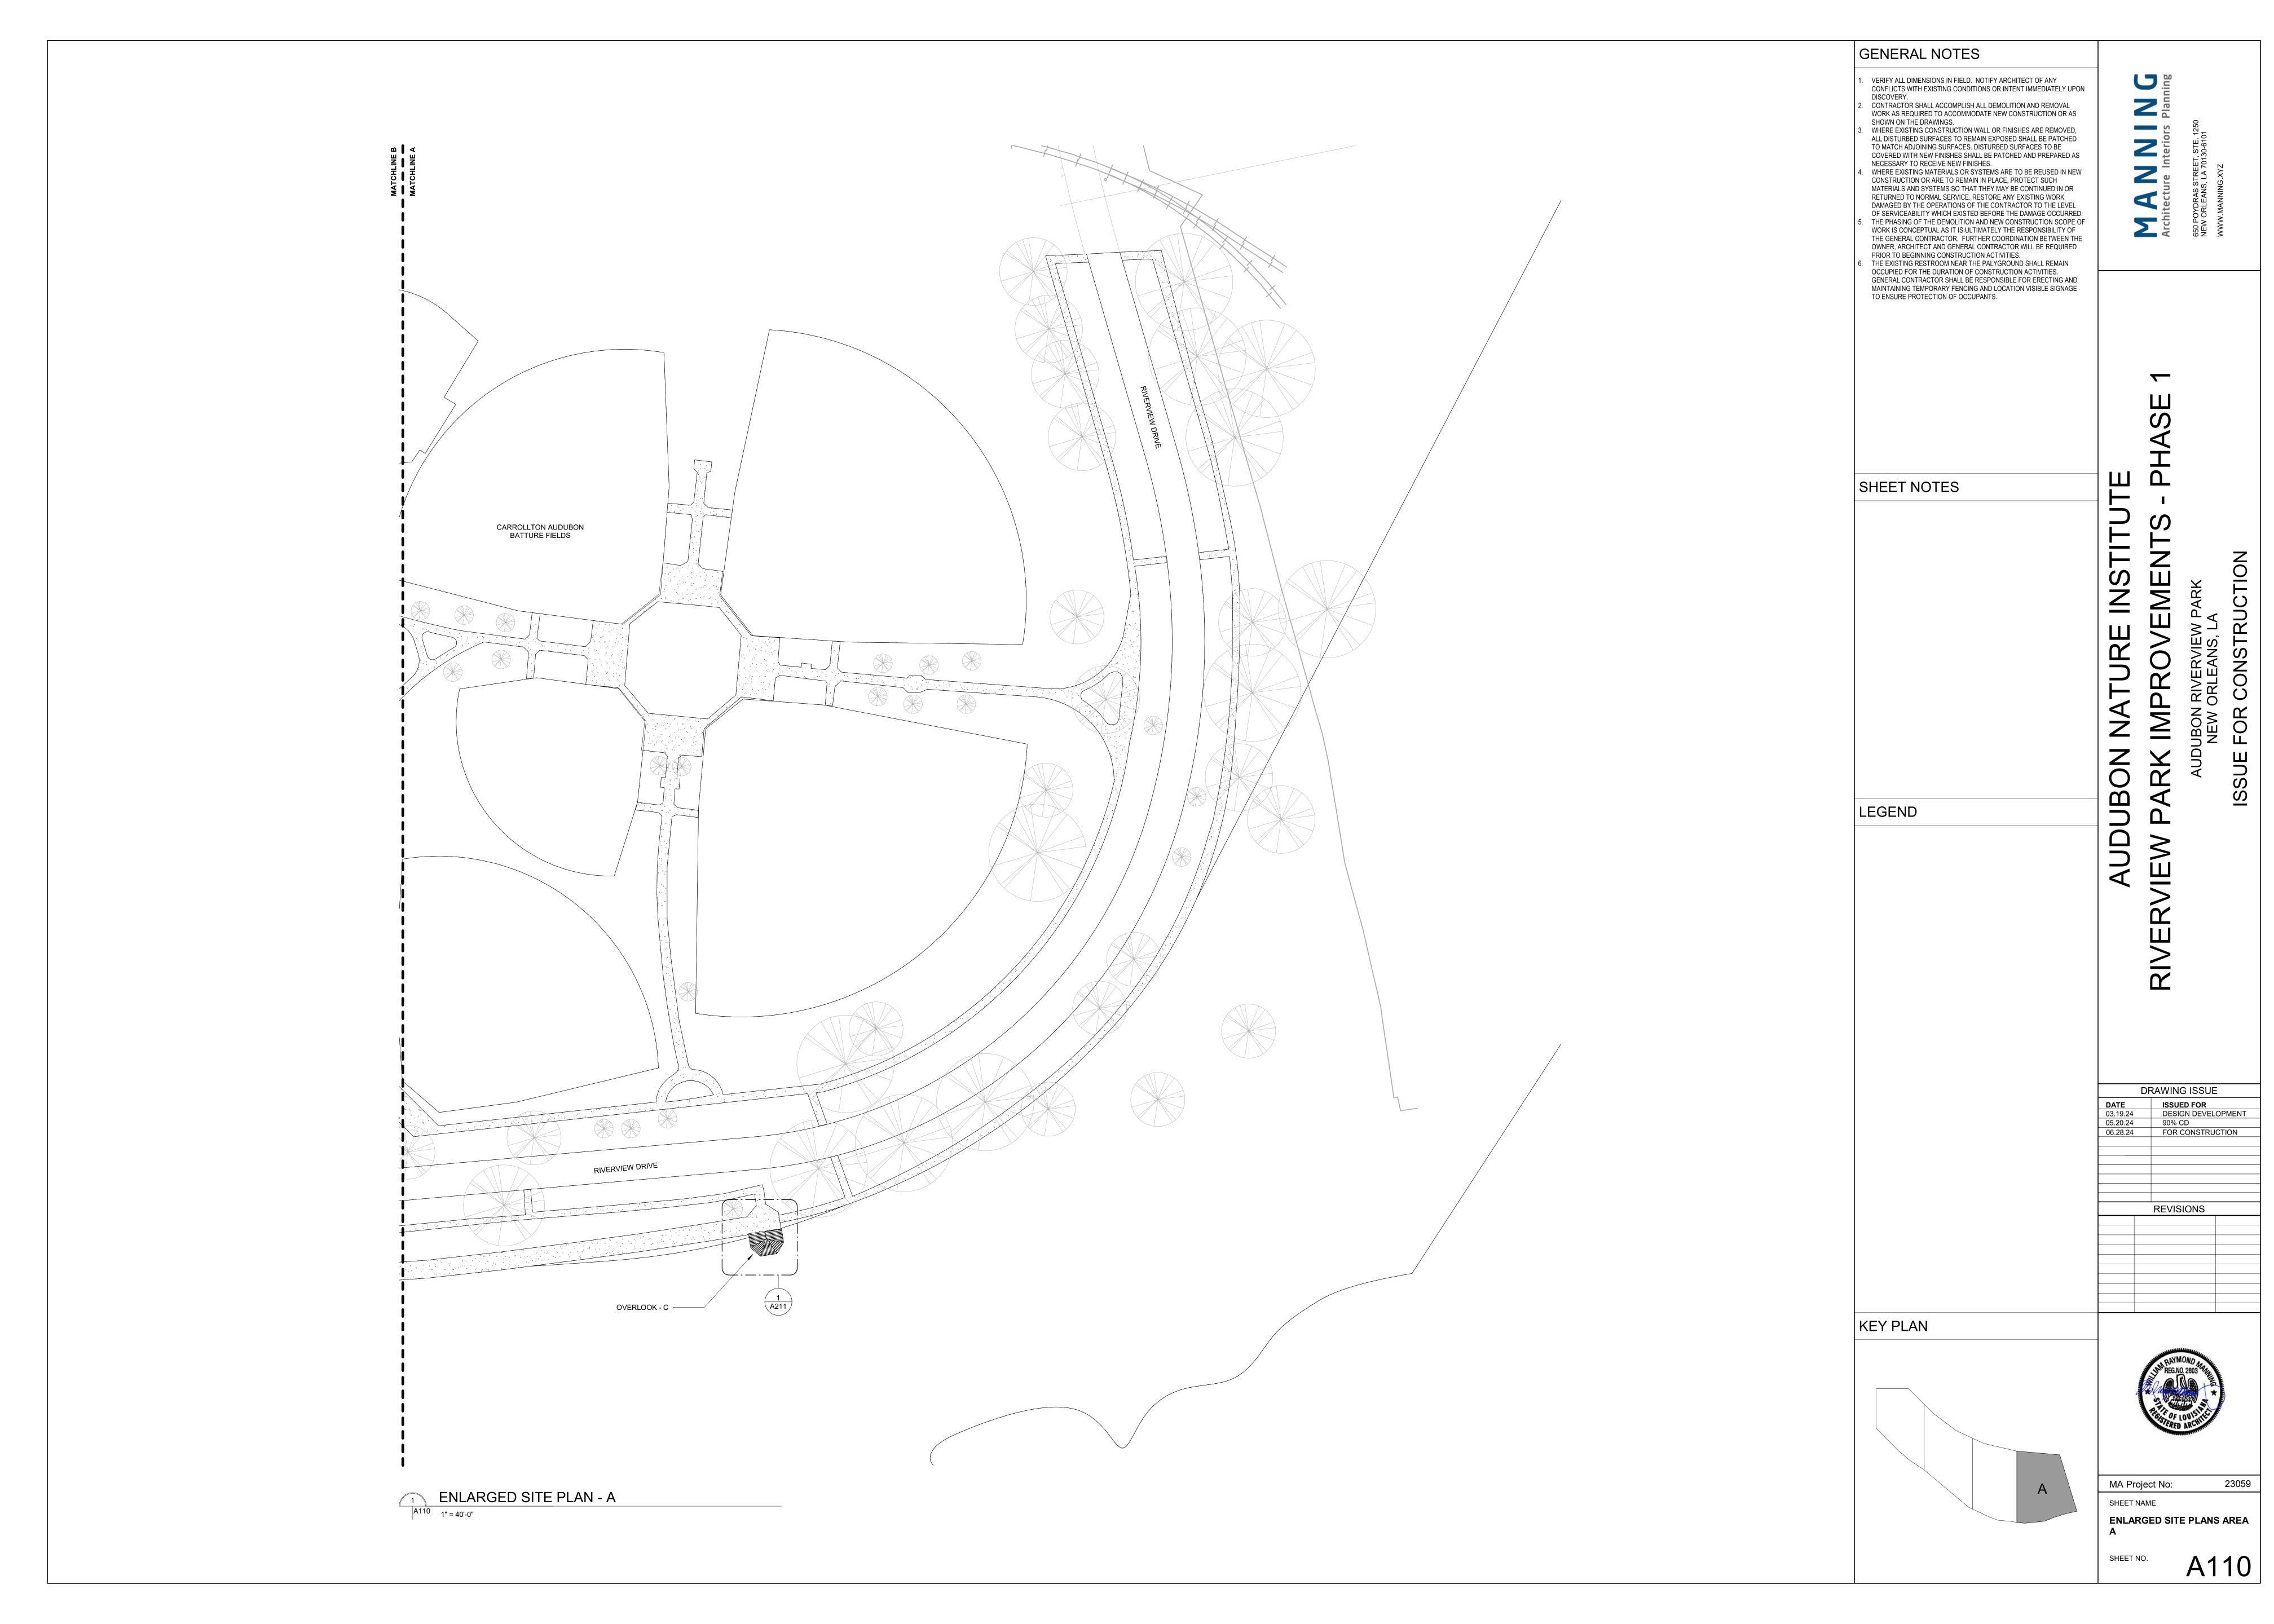
BLUE ARROW JUNCUS - Juncus inflexus 'Blue Arrows' DWARF WAX MYRTLE - Morella cerifera 'Don's Dwarf'

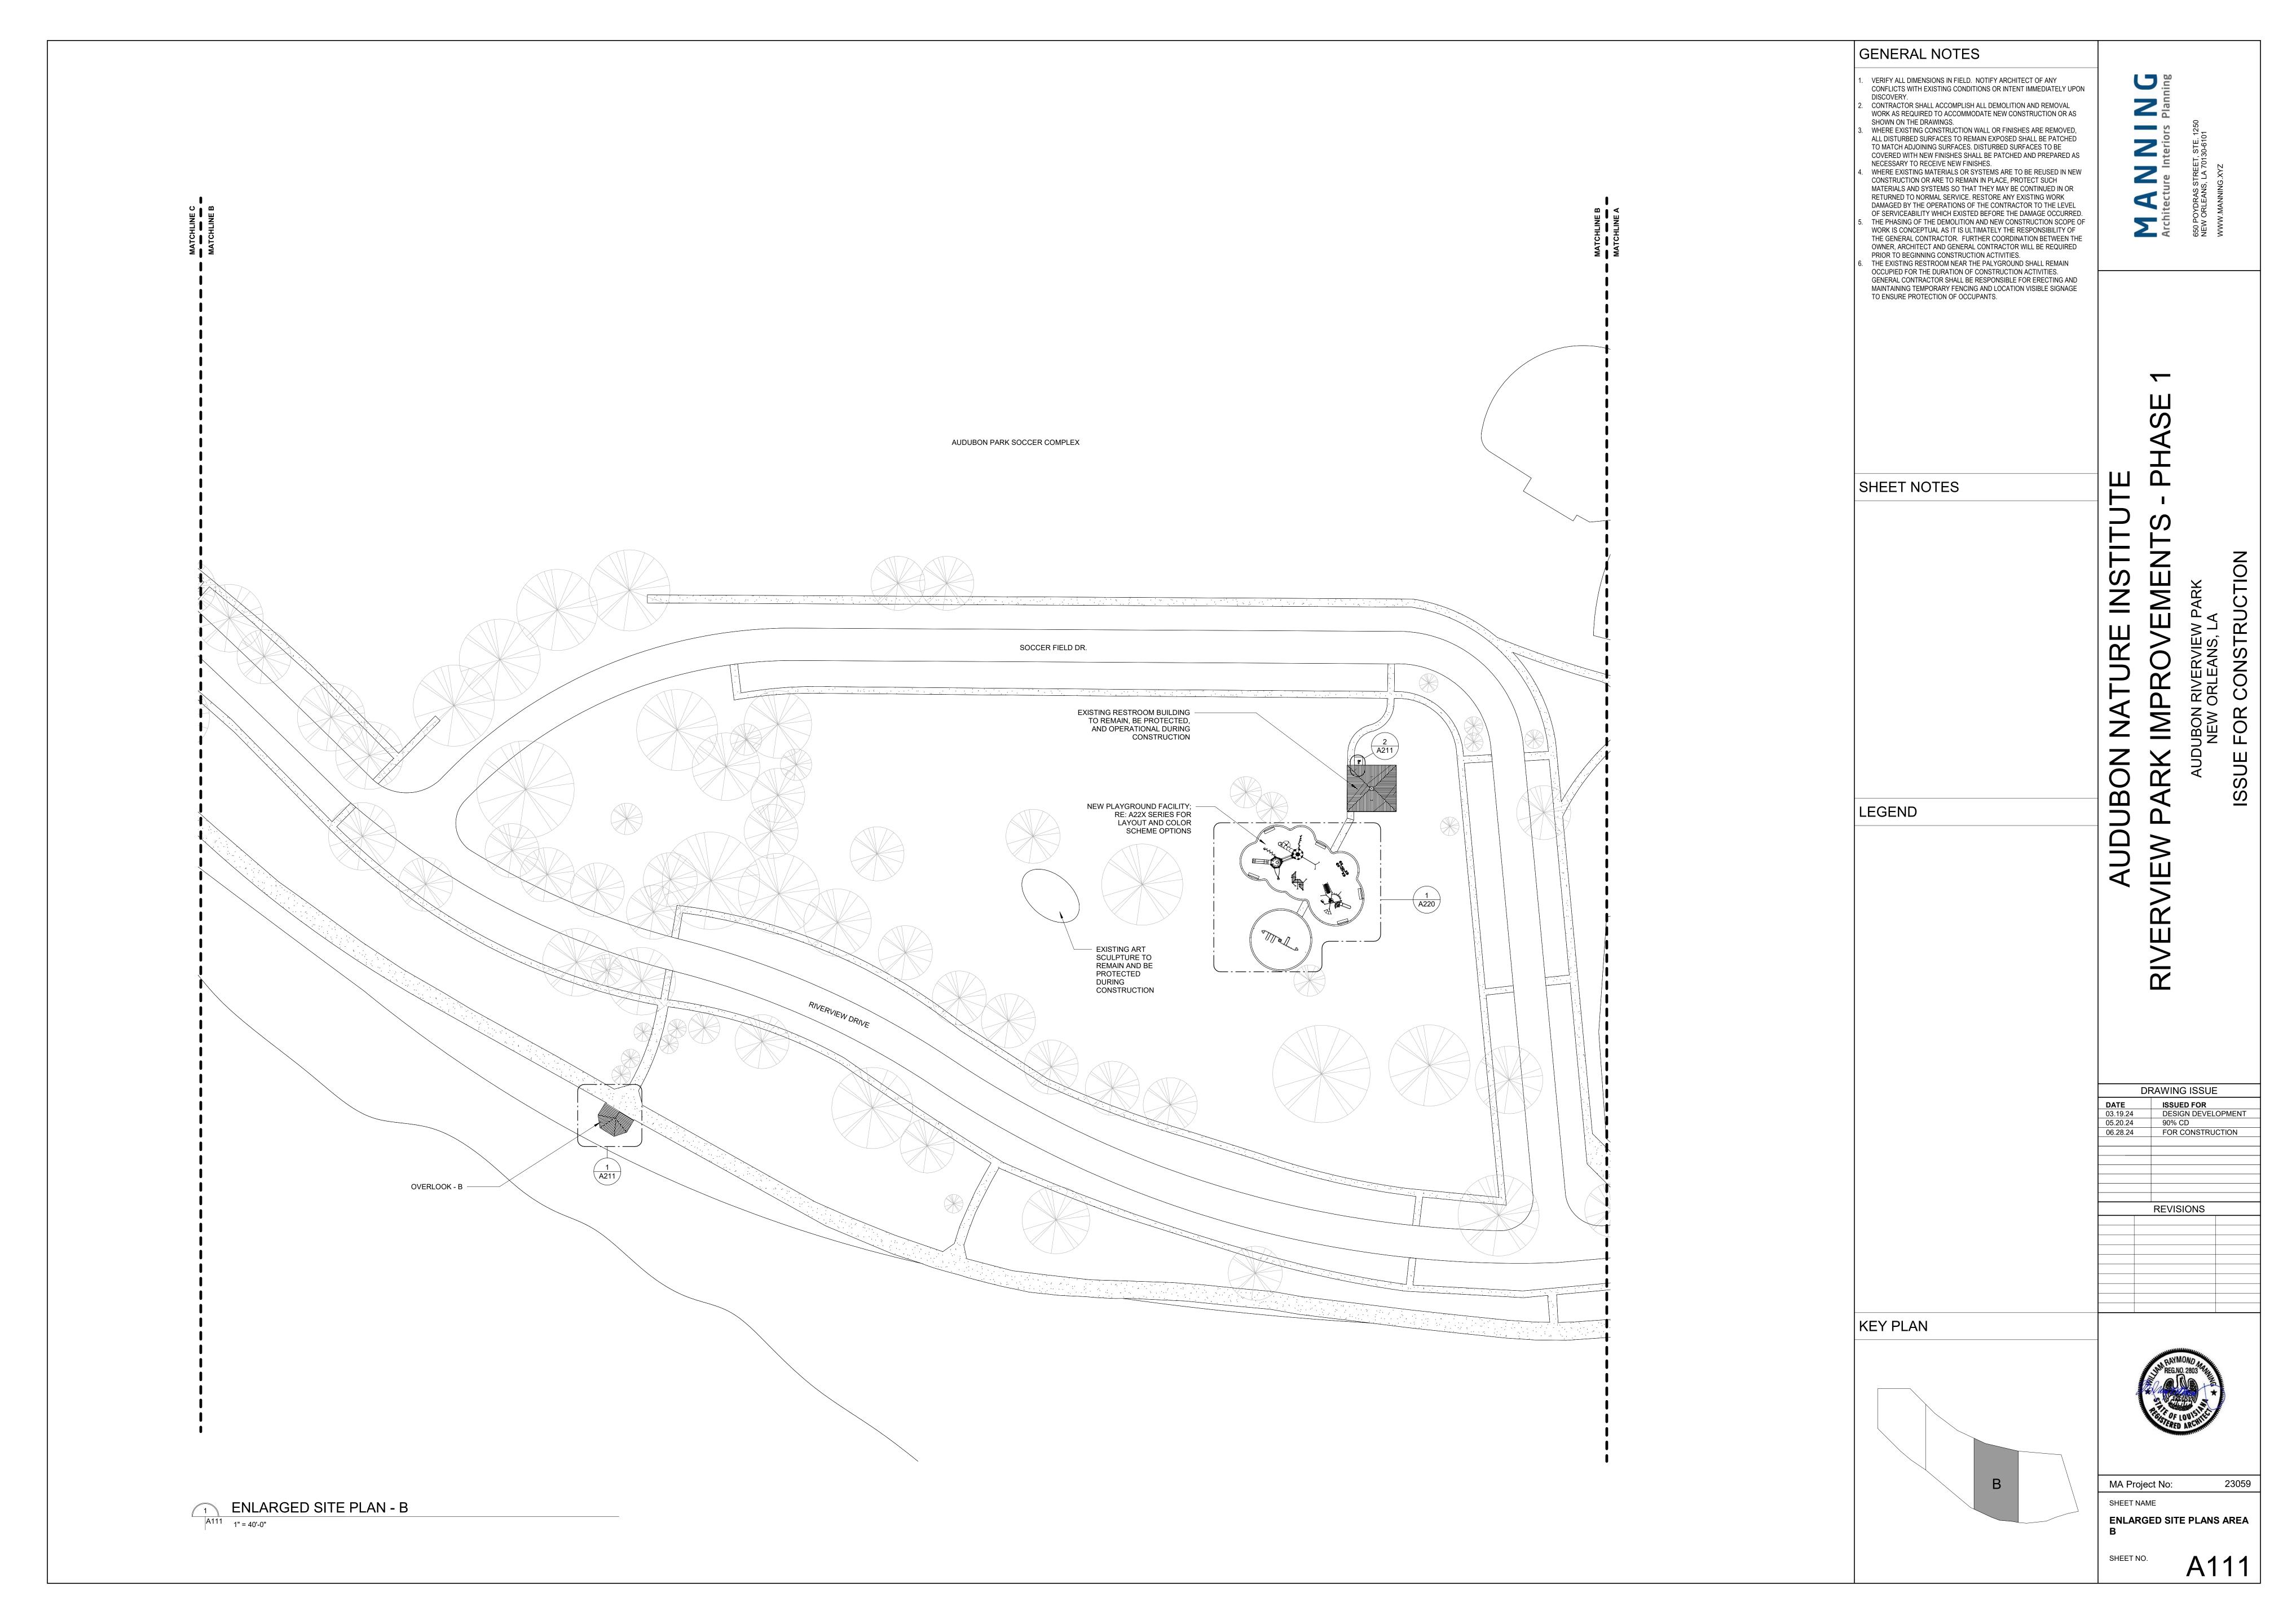
CRINUM LILY - Crinum americanum

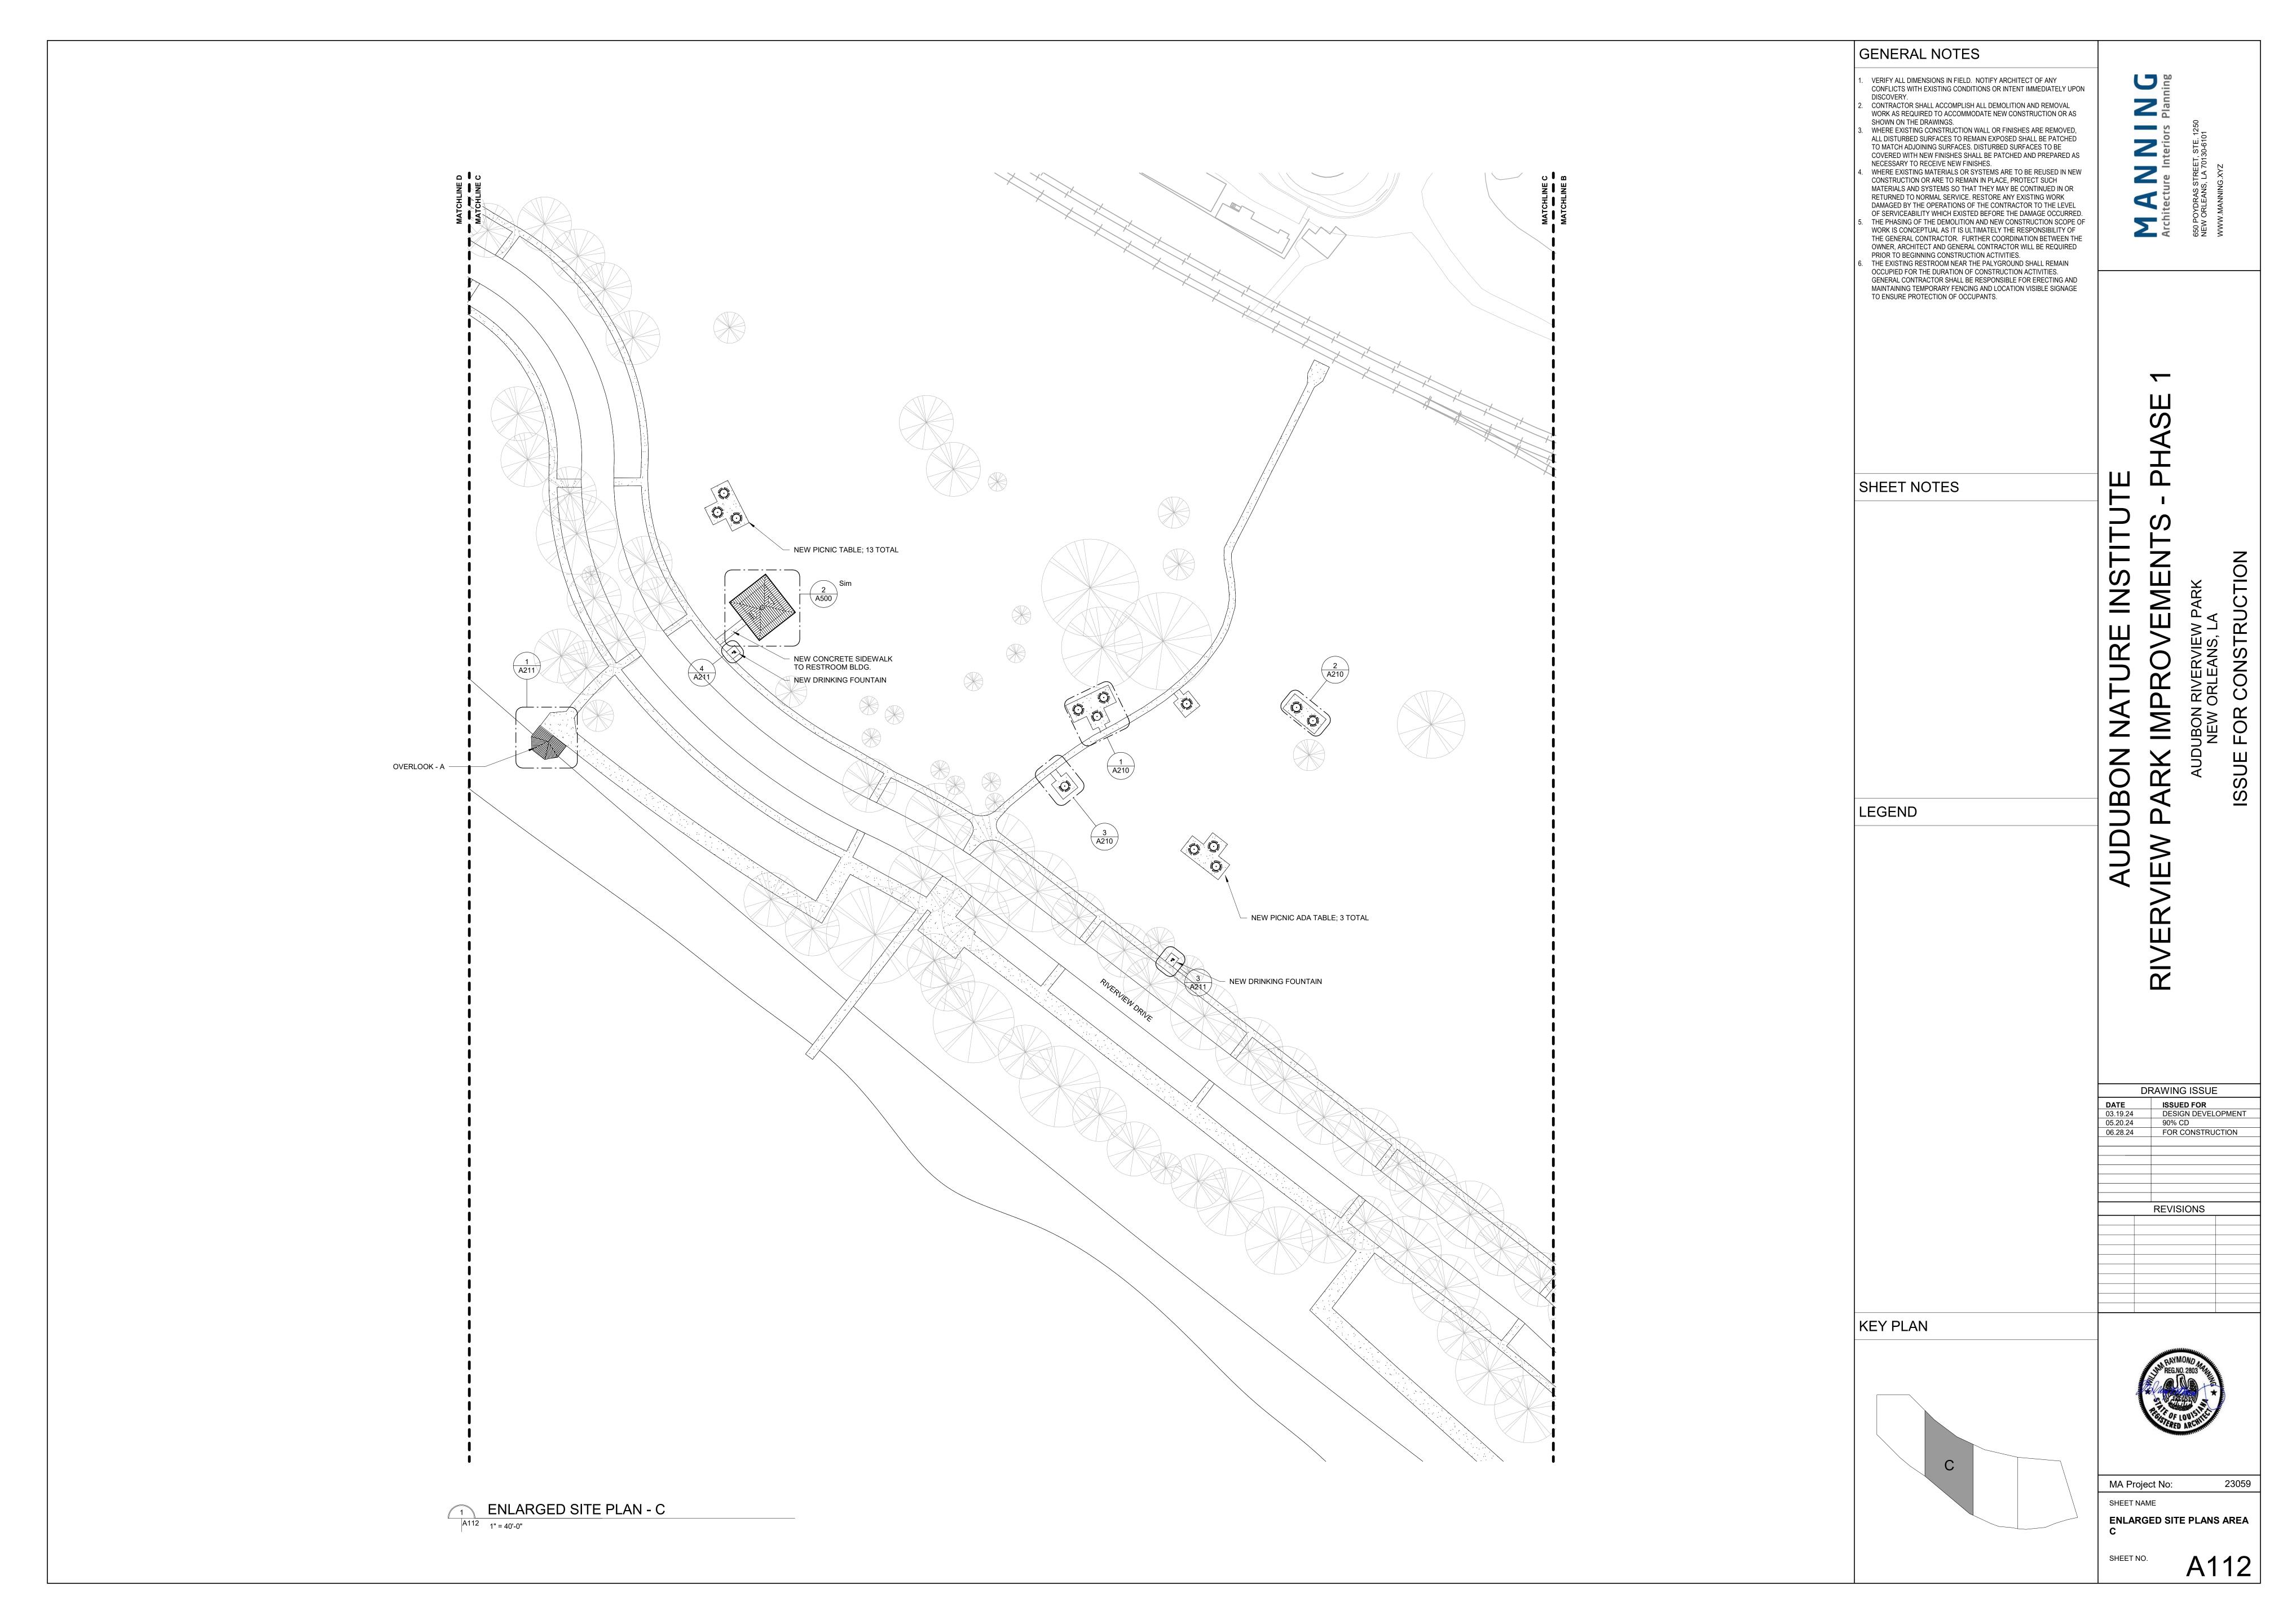


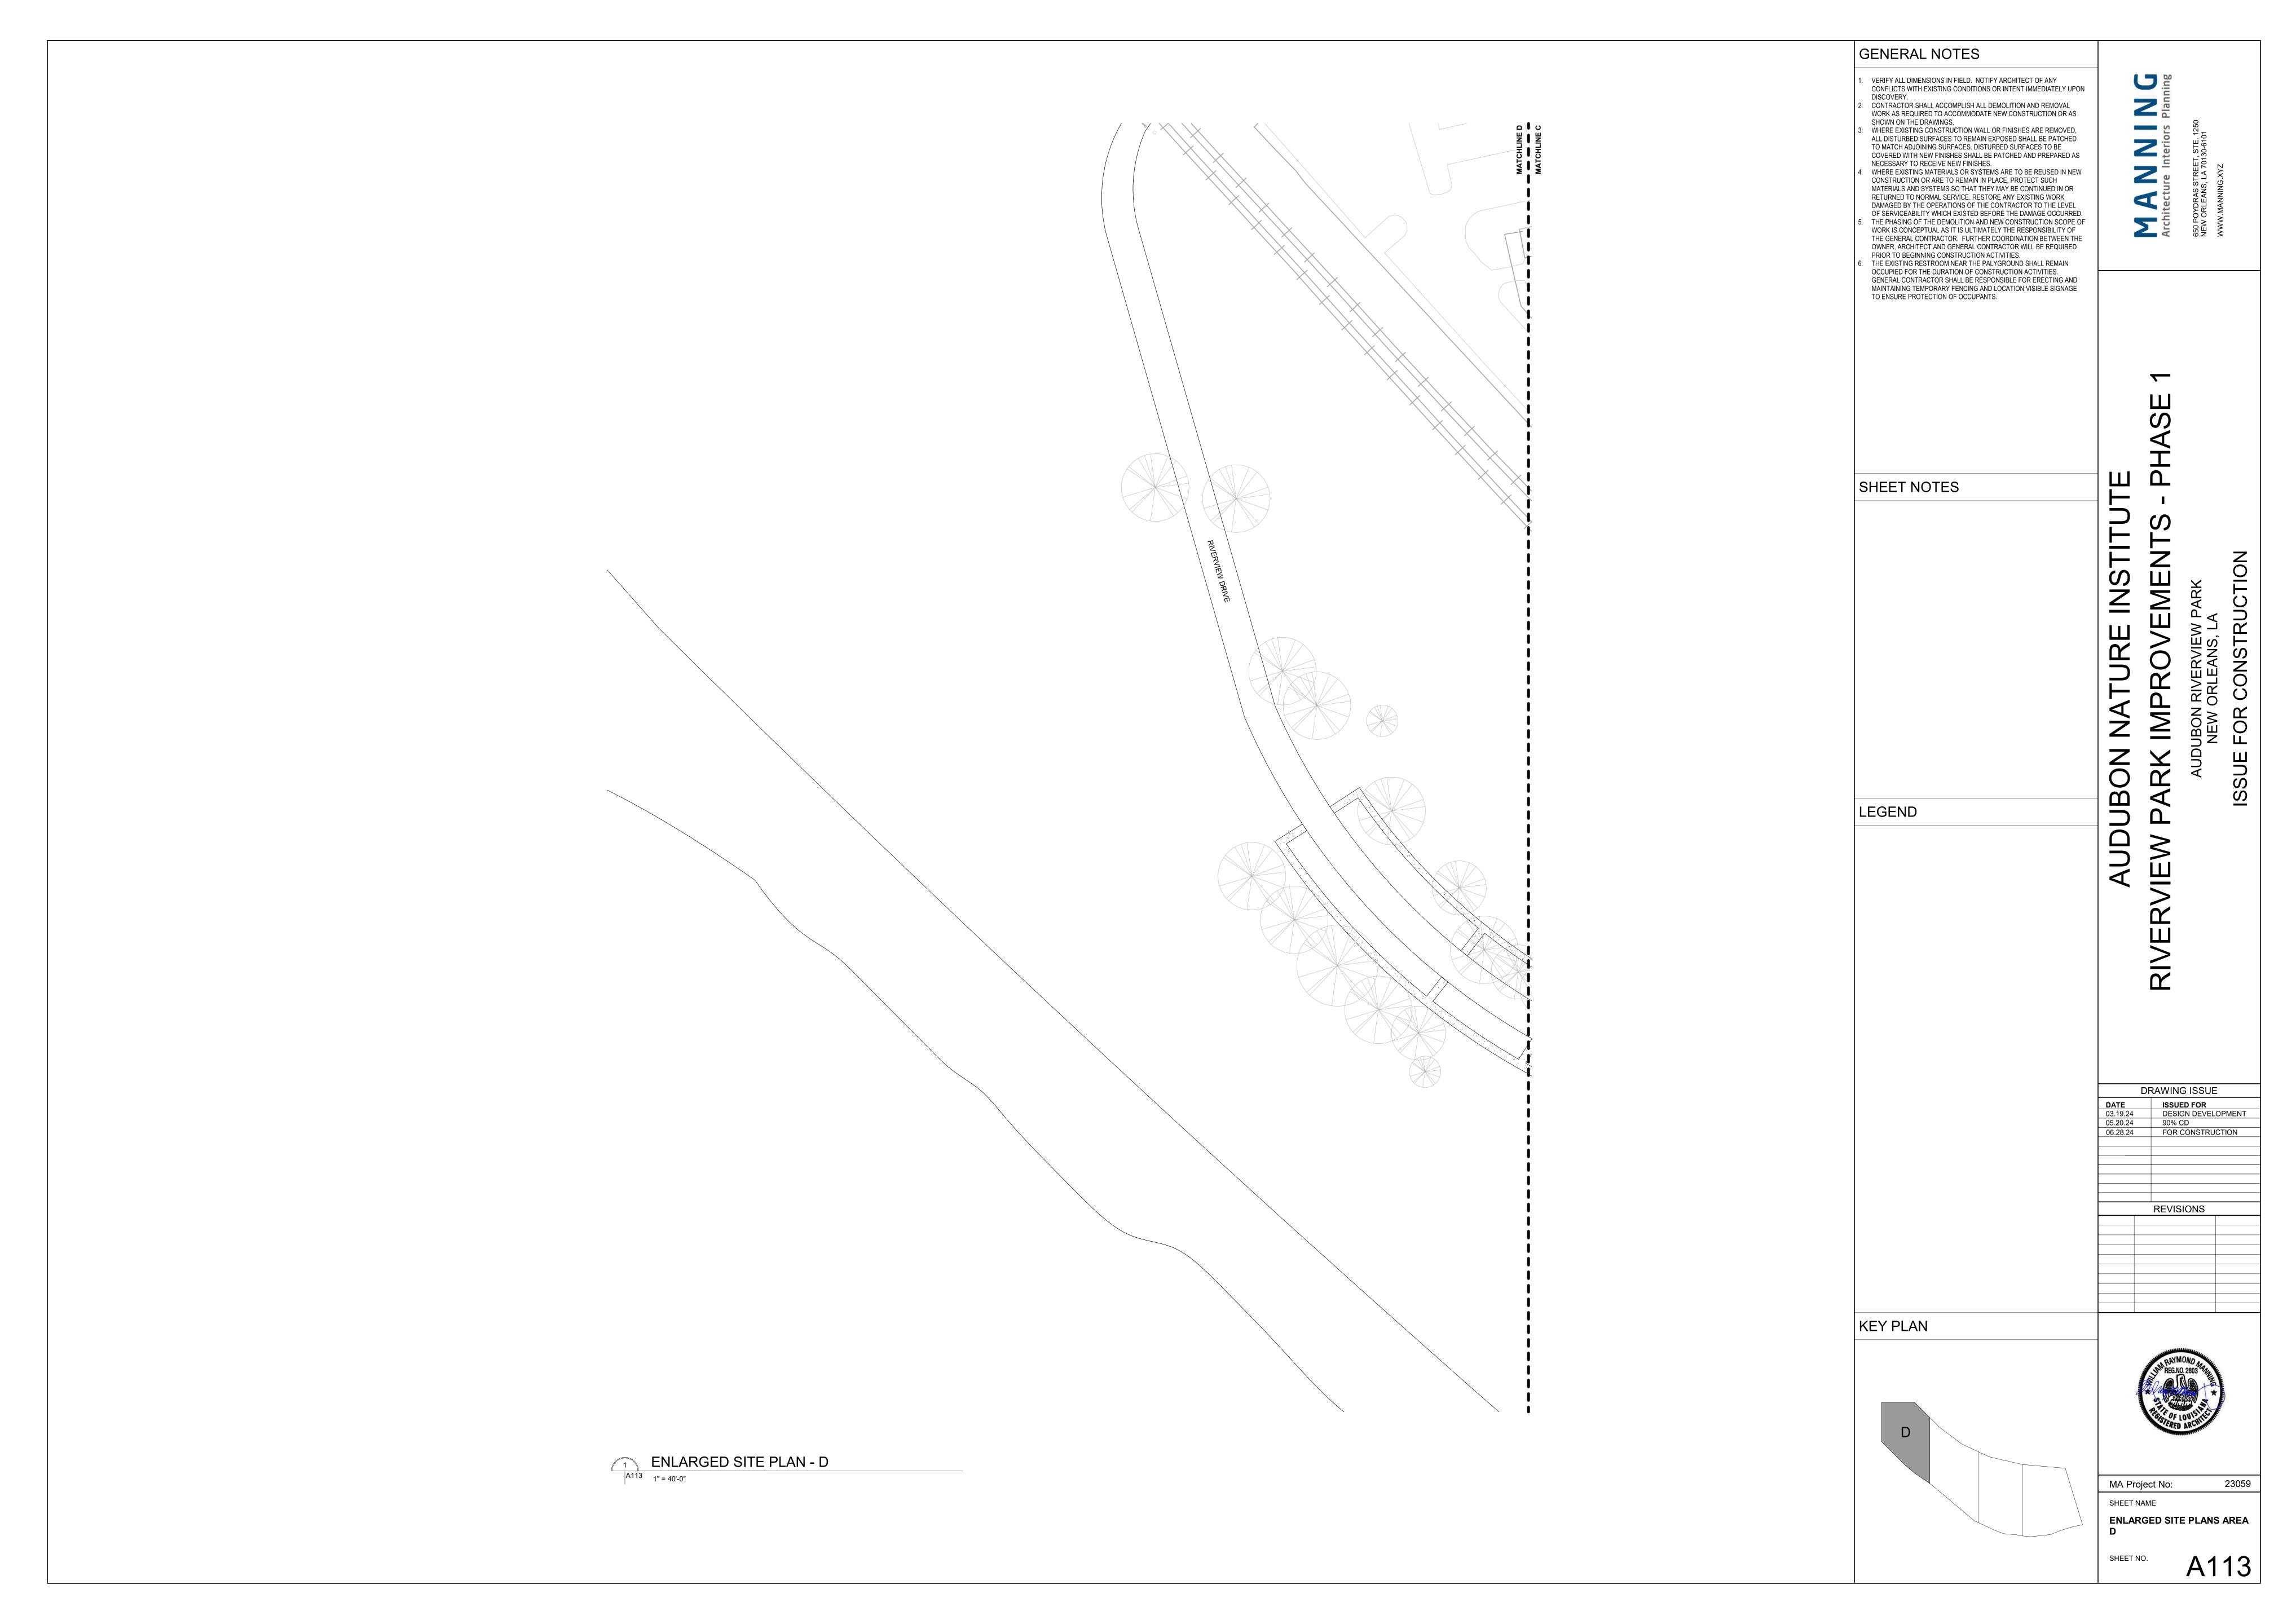


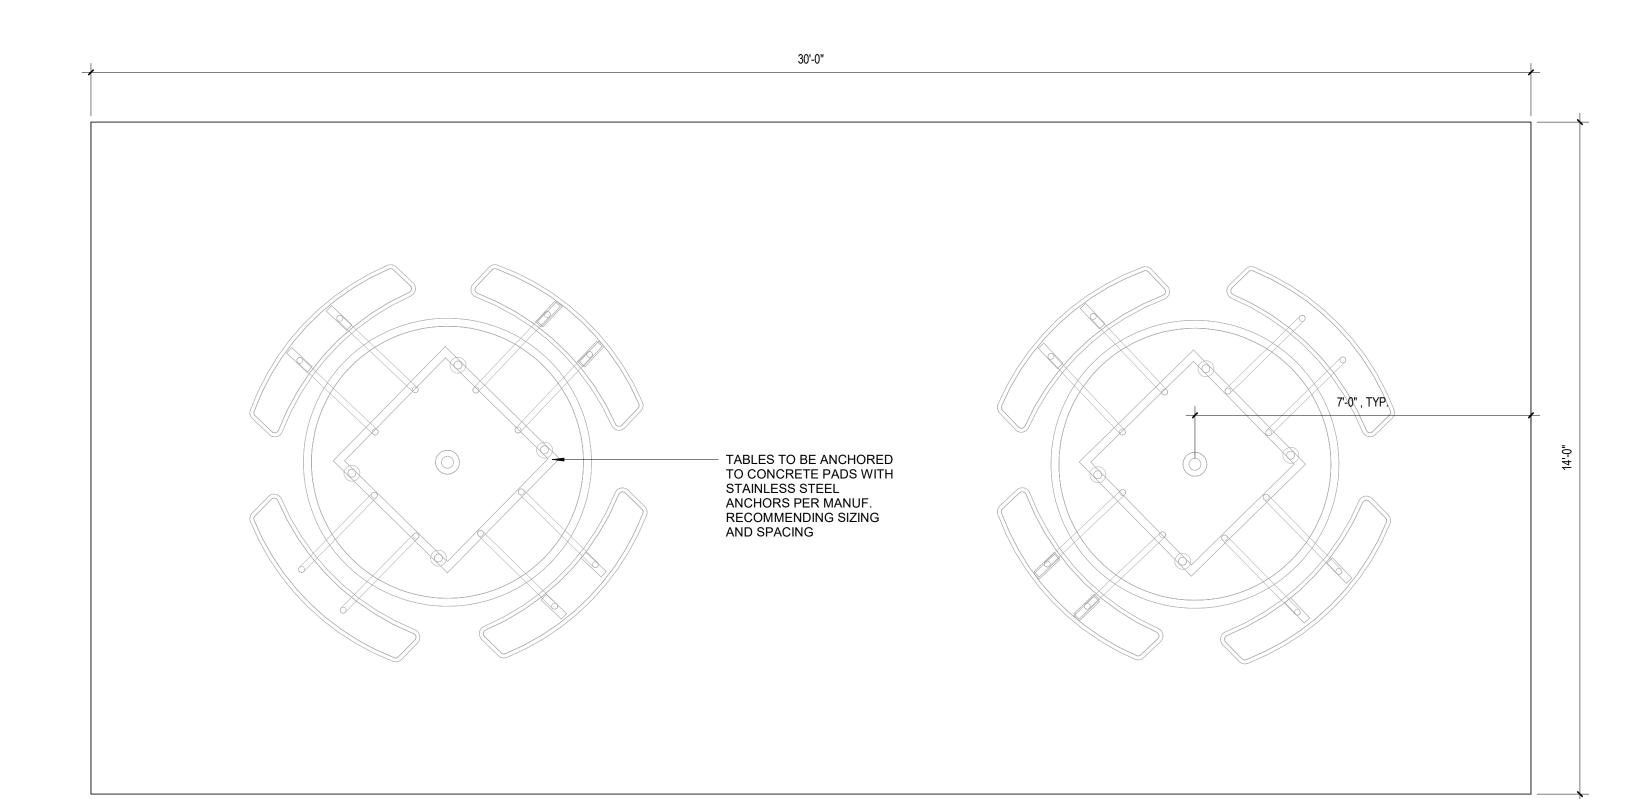


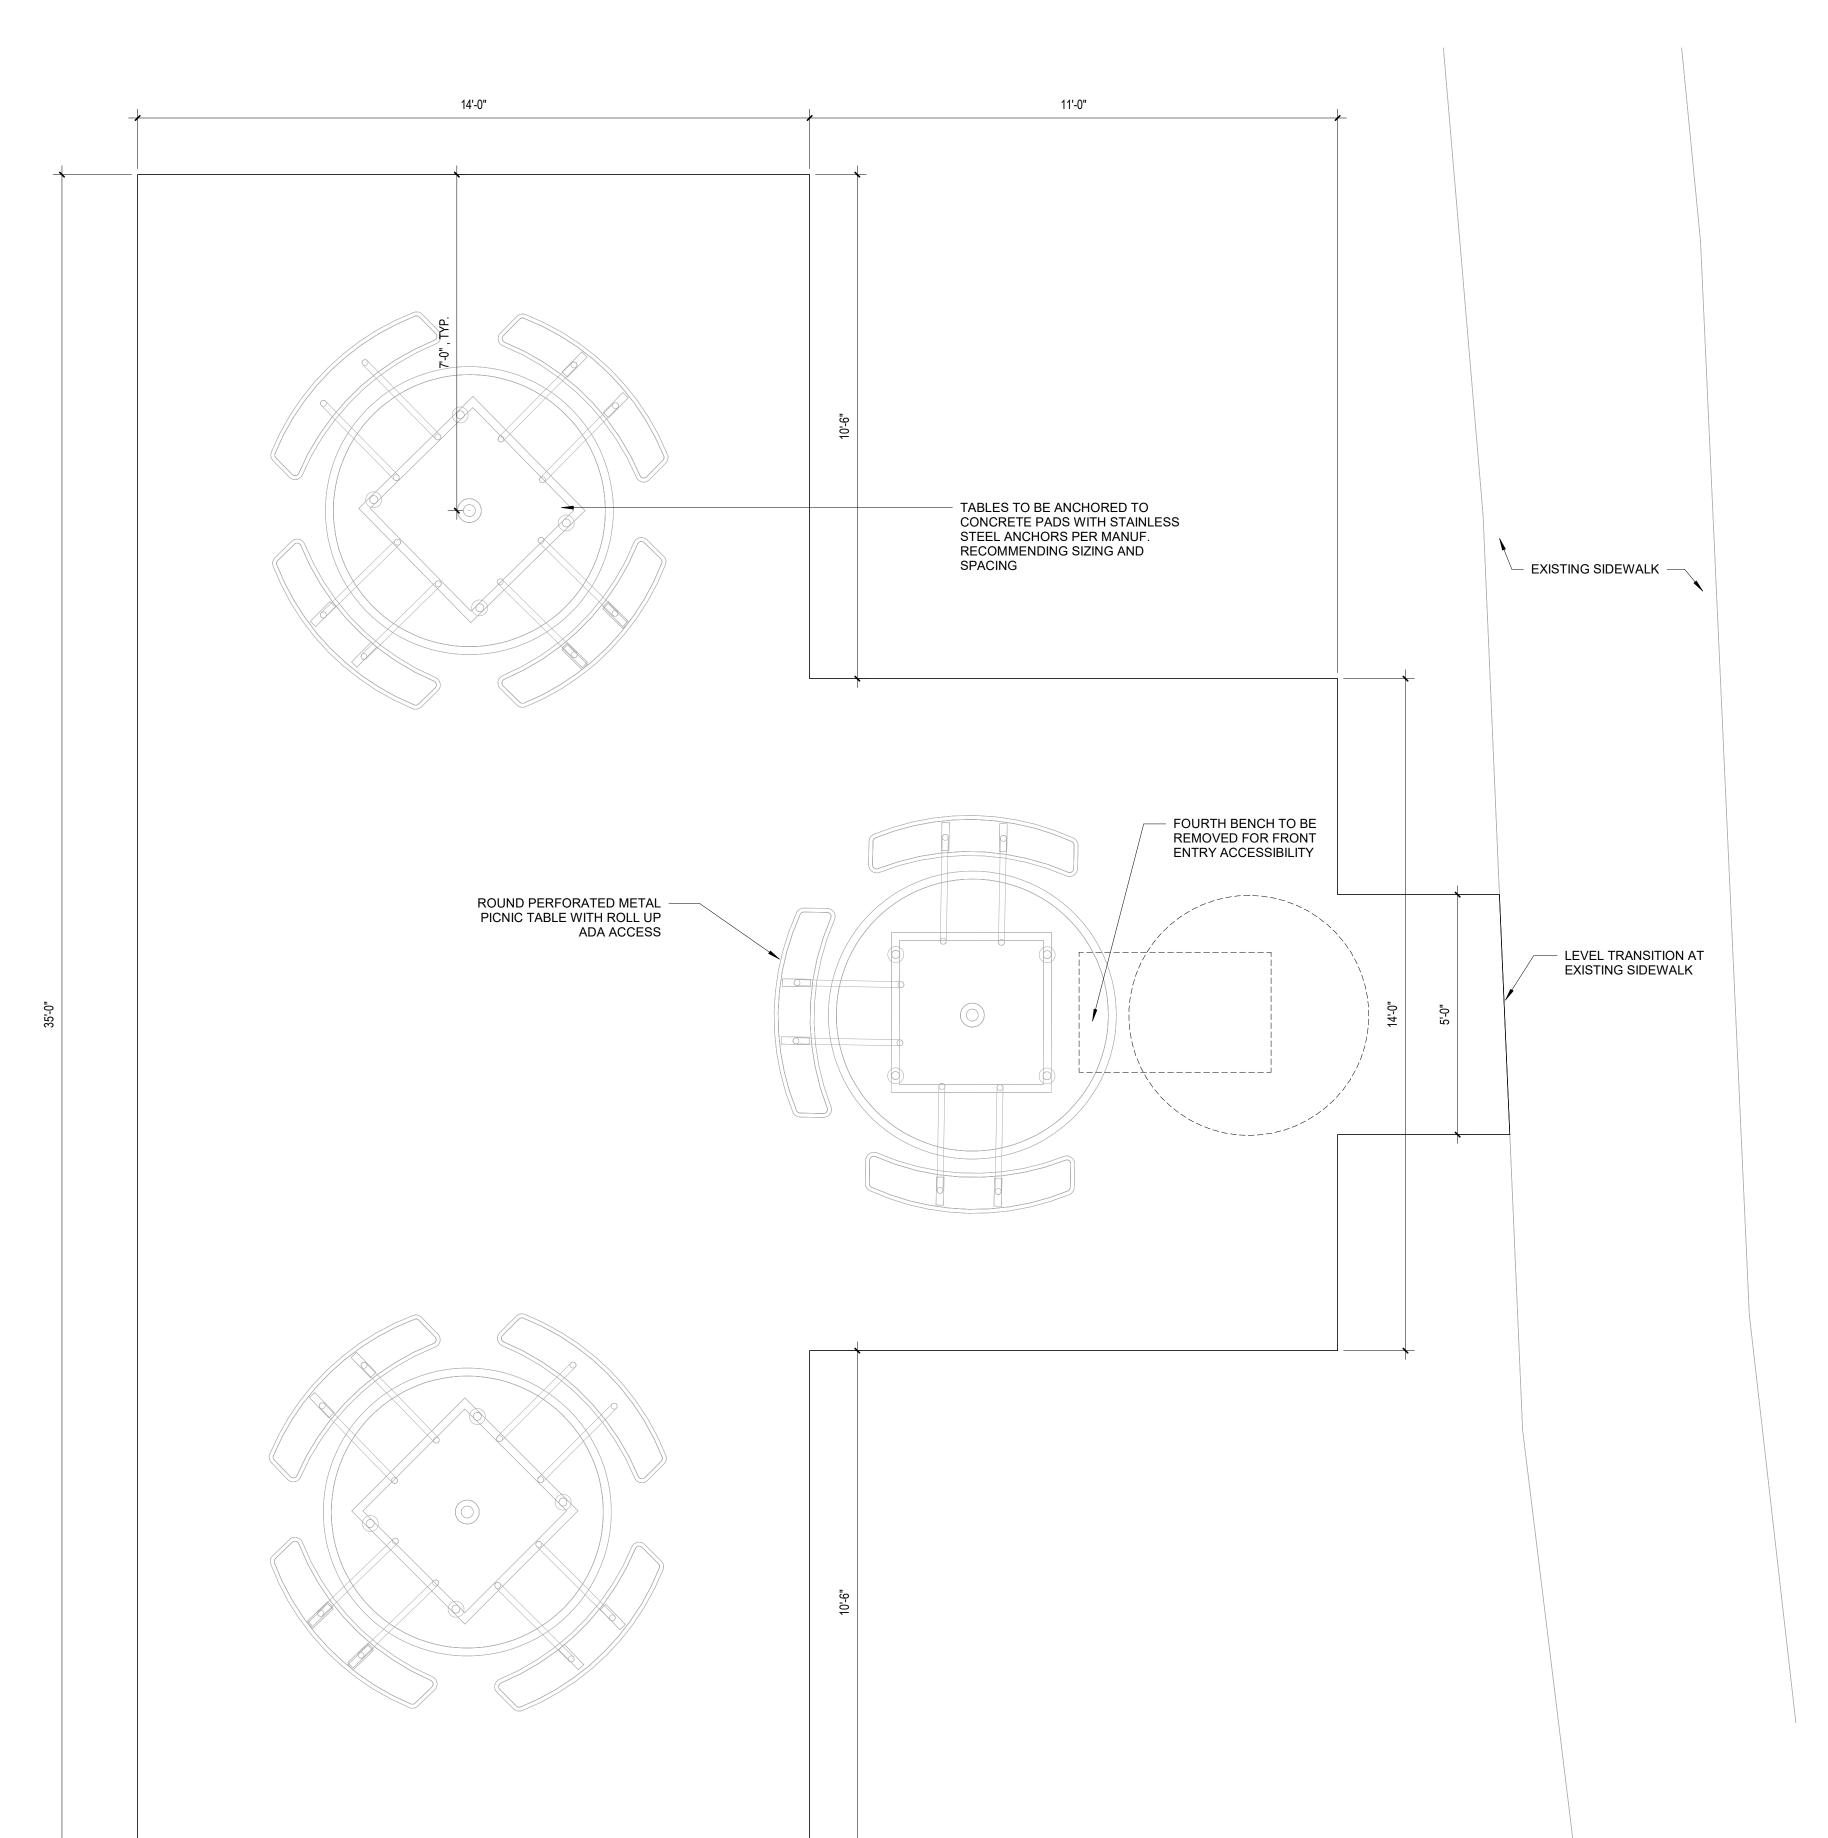














NOTE: IMAGE FOR REFERENCE ONLY

AUDUBON DRAWING ISSUE
 DATE
 ISSUED FOR

 05.20.24
 90% CD
 06.28.24 FOR CONSTRUCTION

INSTITUTE

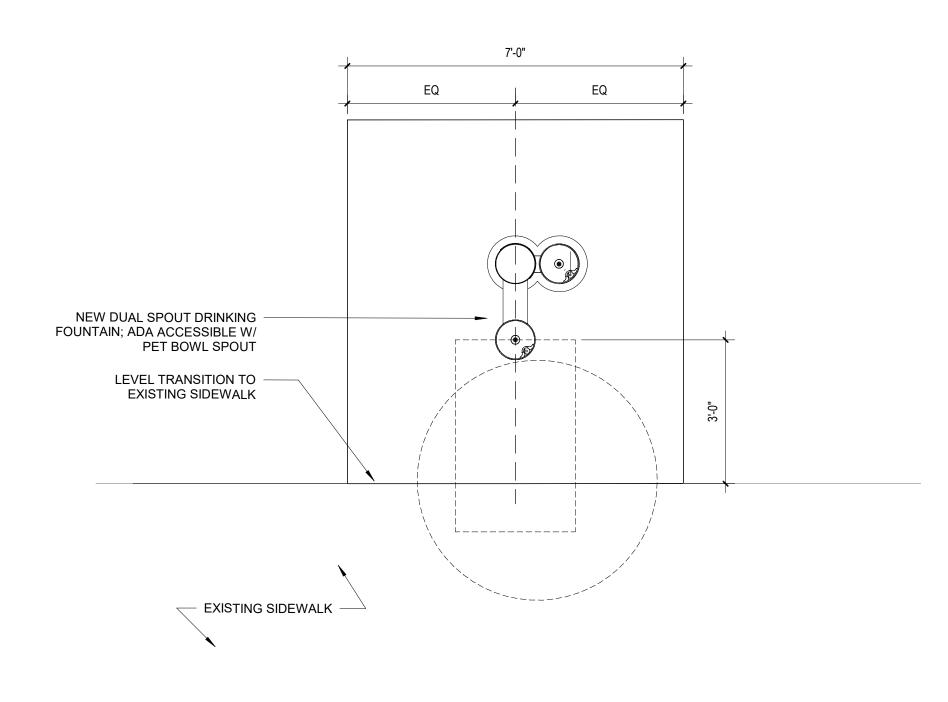
REVISIONS

MA Project No: 23059 SHEET NAME

SITE COMPONENT - PICNIC

DRINKING FOUNTAIN - NEW RESTROOM FACILITY

NOTE: LOCATION TO BE V.I.F. TO ENSURE NO DAMAGE TO EXISTING TREES AND ASSOCIATED DRIPLINES

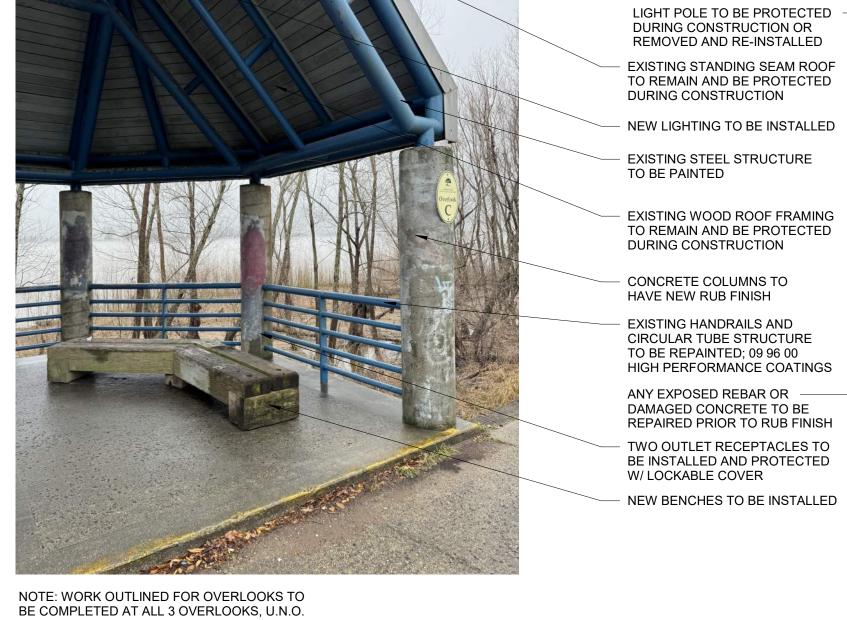








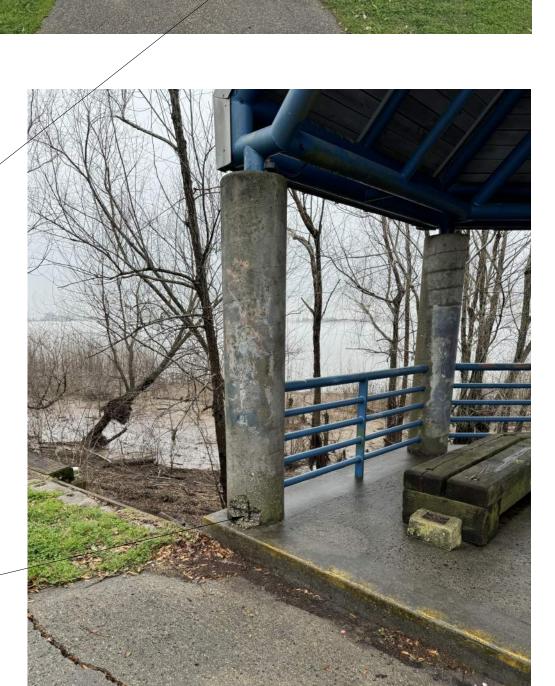


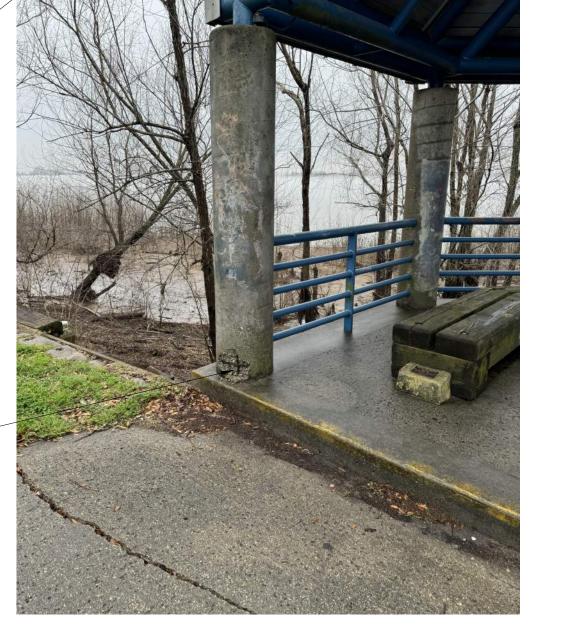


OVERLOOK A (ONLY): NEW
CONCRETE LANDING FLUSH WITH
OVERLOOK; RAMP UP FROM
EXISTING SIDEWALK FOR ADA

SINGLE HAND RAIL AT RIVER EDGE

ACCESS; ROLL OFF CURB AND

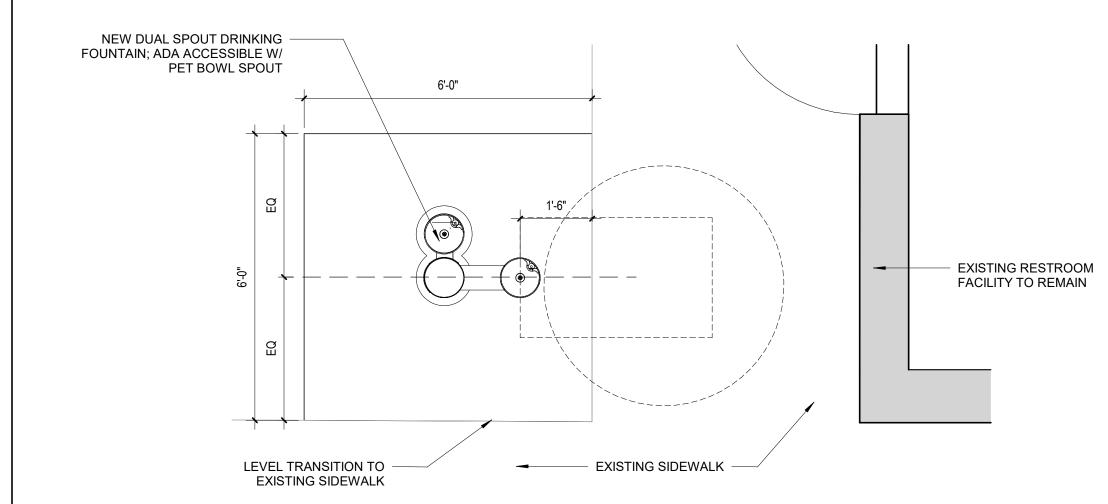




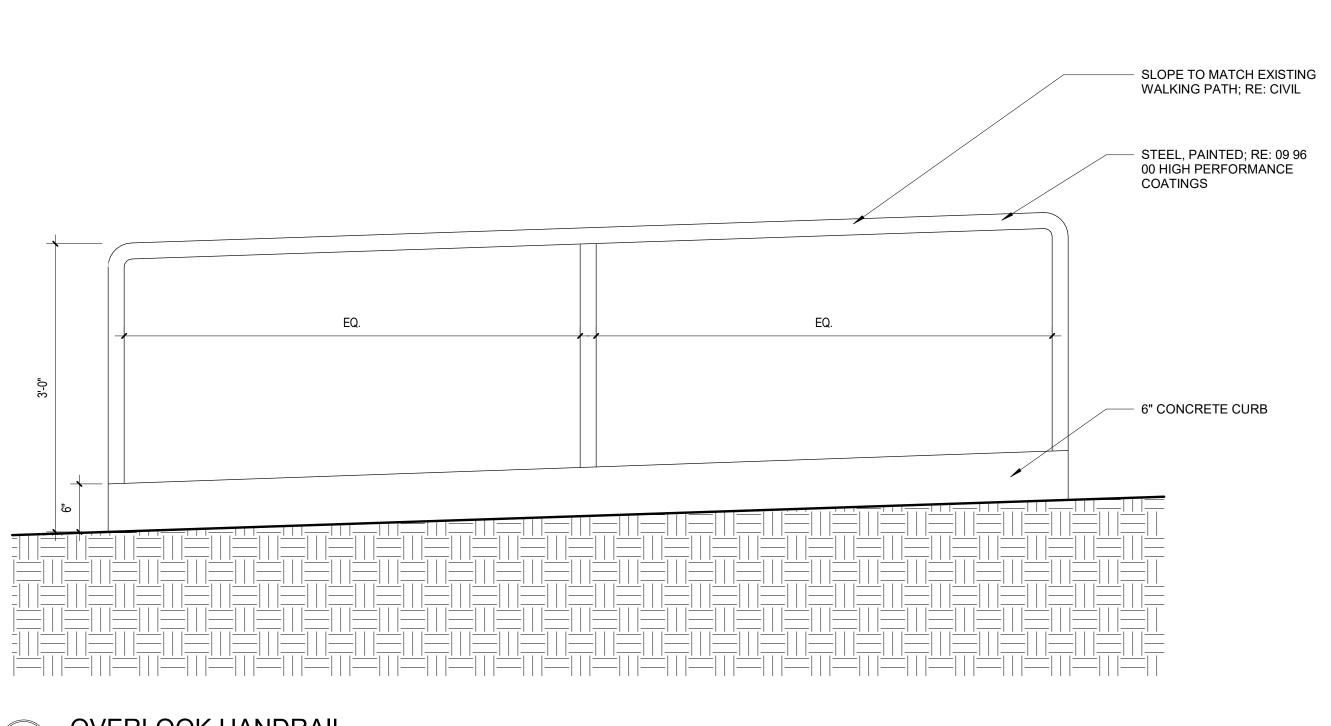
RIVER OVERLOOK A110 A211 12" = 1'-0"

DRINKING FOUNTAIN - MIDDLE PARK A112 A211 1/2" = 1'-0"

A112 A211 1/2" = 1'-0"



DRINKING FOUNTAIN - PLAYGROUND AREA



OVERLOOK HANDRAIL

A211 1" = 1'-0"

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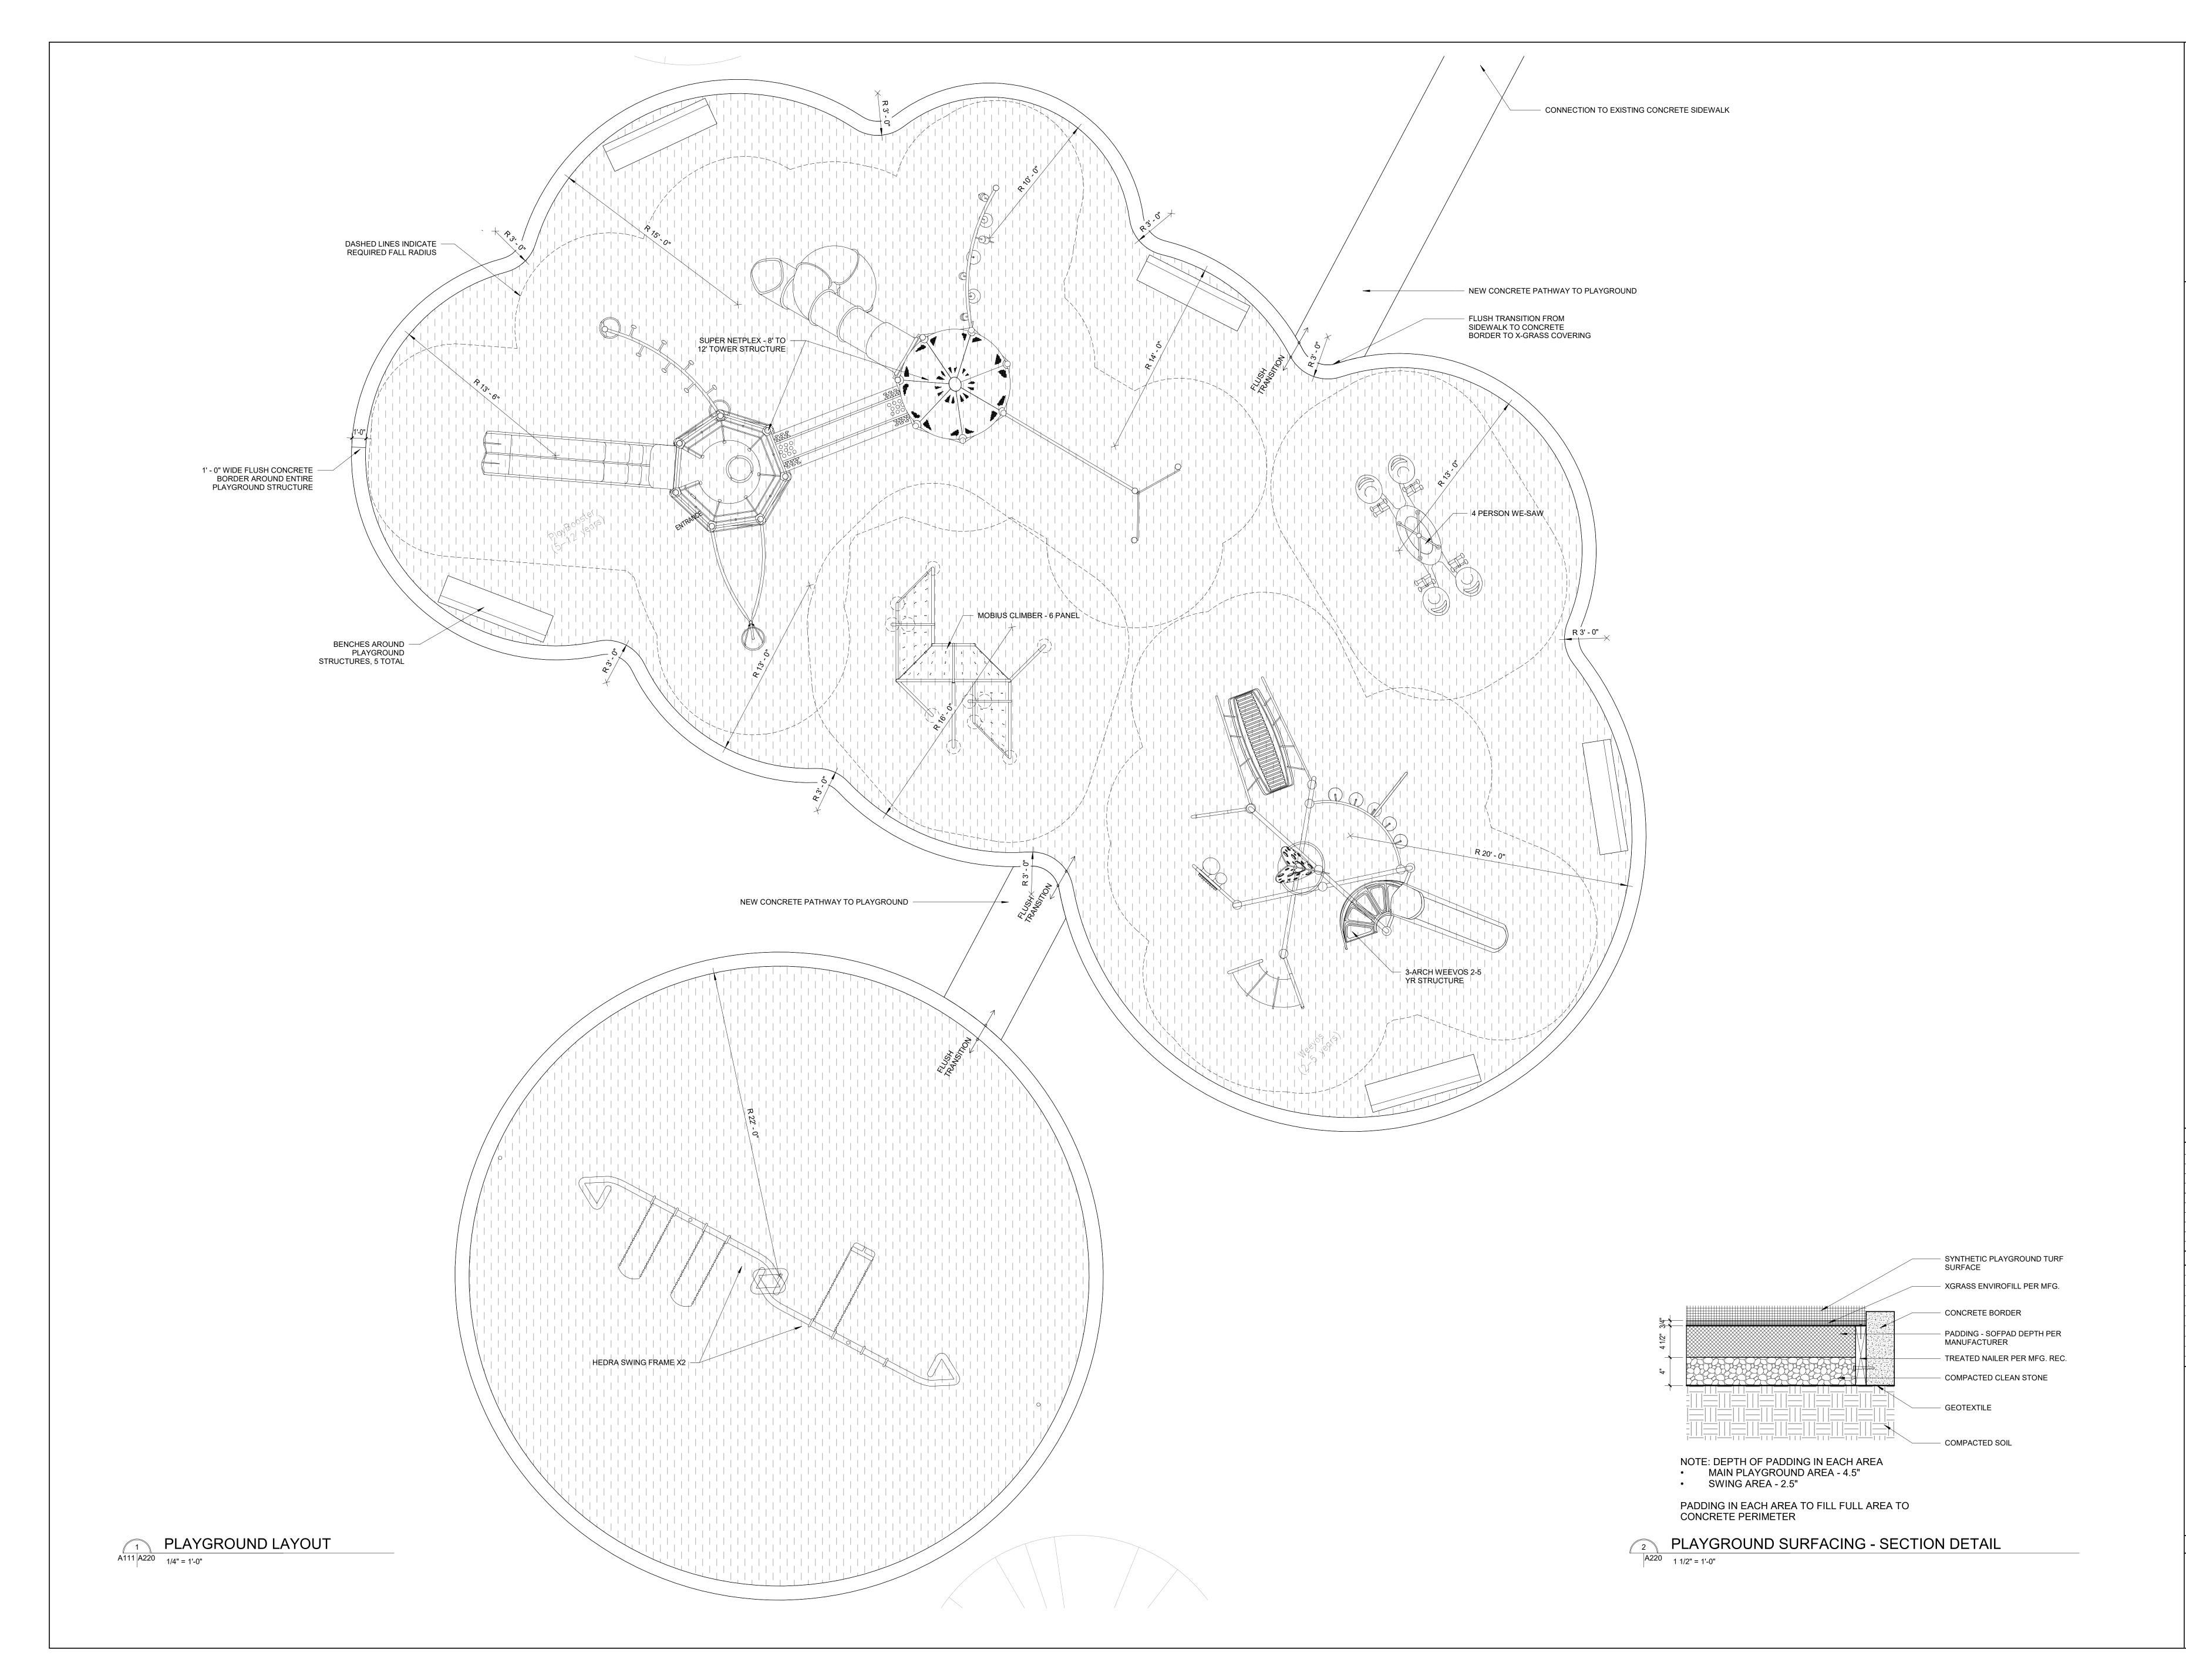
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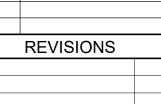
23059 MA Project No: SHEET NAME SITE COMPONENT - DRINKING FOUNTAINS & OVERLOOKS

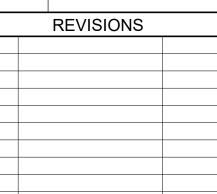




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3.19.24	DESIGN DEVELOPMENT	
5.20.24	90% CD	_
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23059

MA Project No:

SHEET NAME PLAYGROUND PERIMETER AND SURFACING LAYOUT

A220



AUDUBON NATURE INSTITUTE RIVERVIEW PARK IMPROVEMENTS - PHASE

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MA Project No:

PLAYGROUND EQUIPMENT

ATOUT

A22



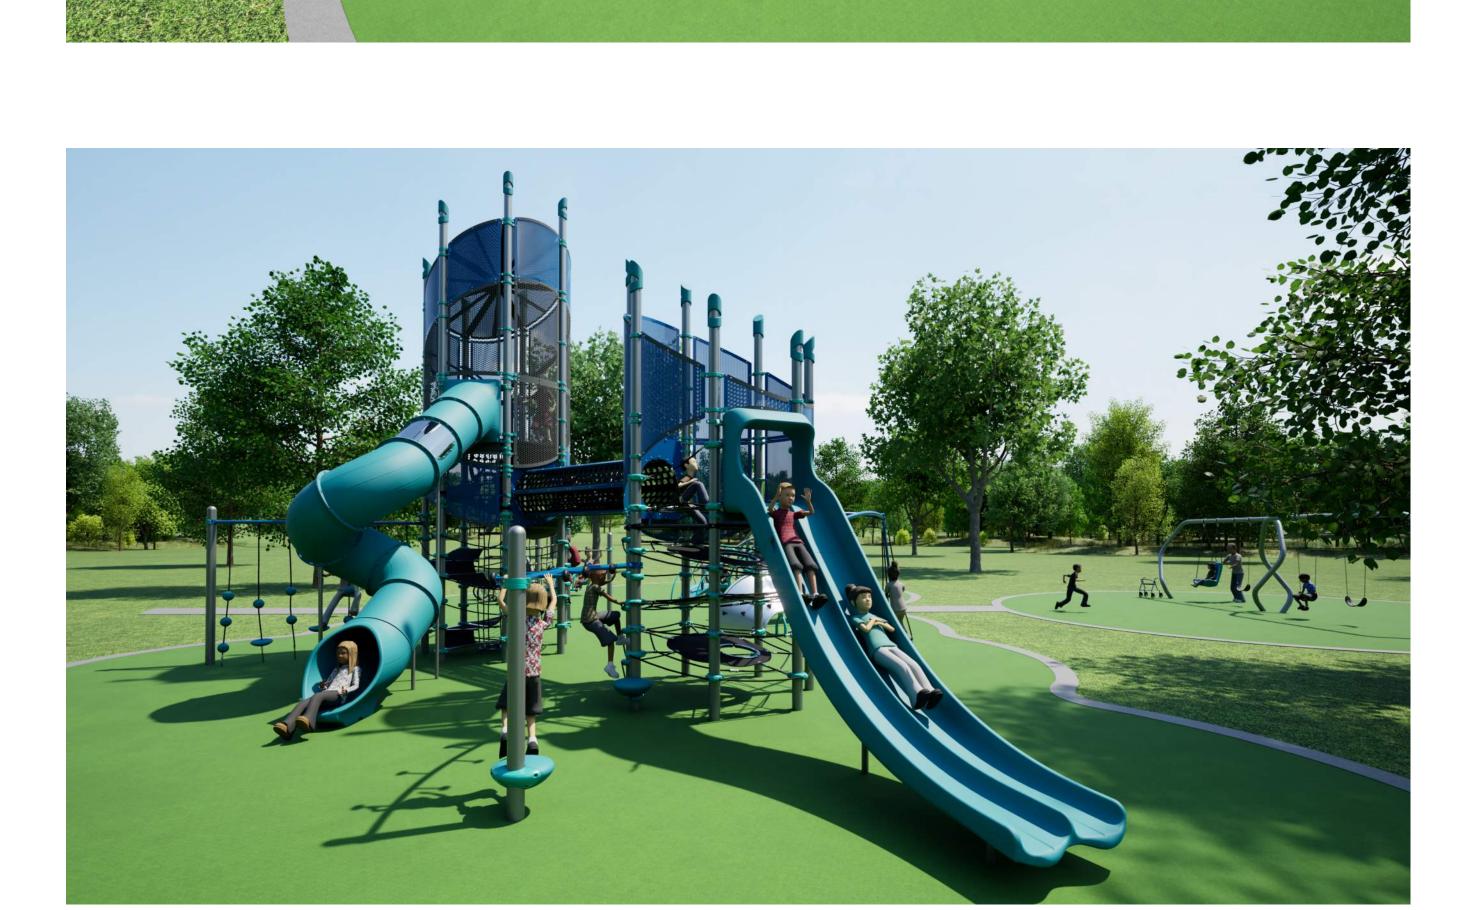




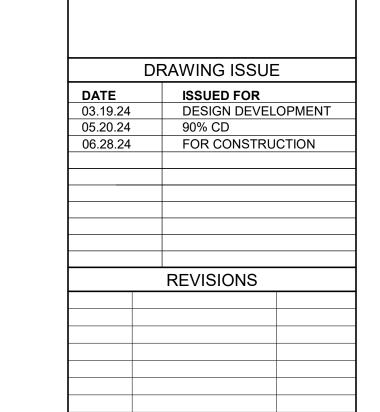








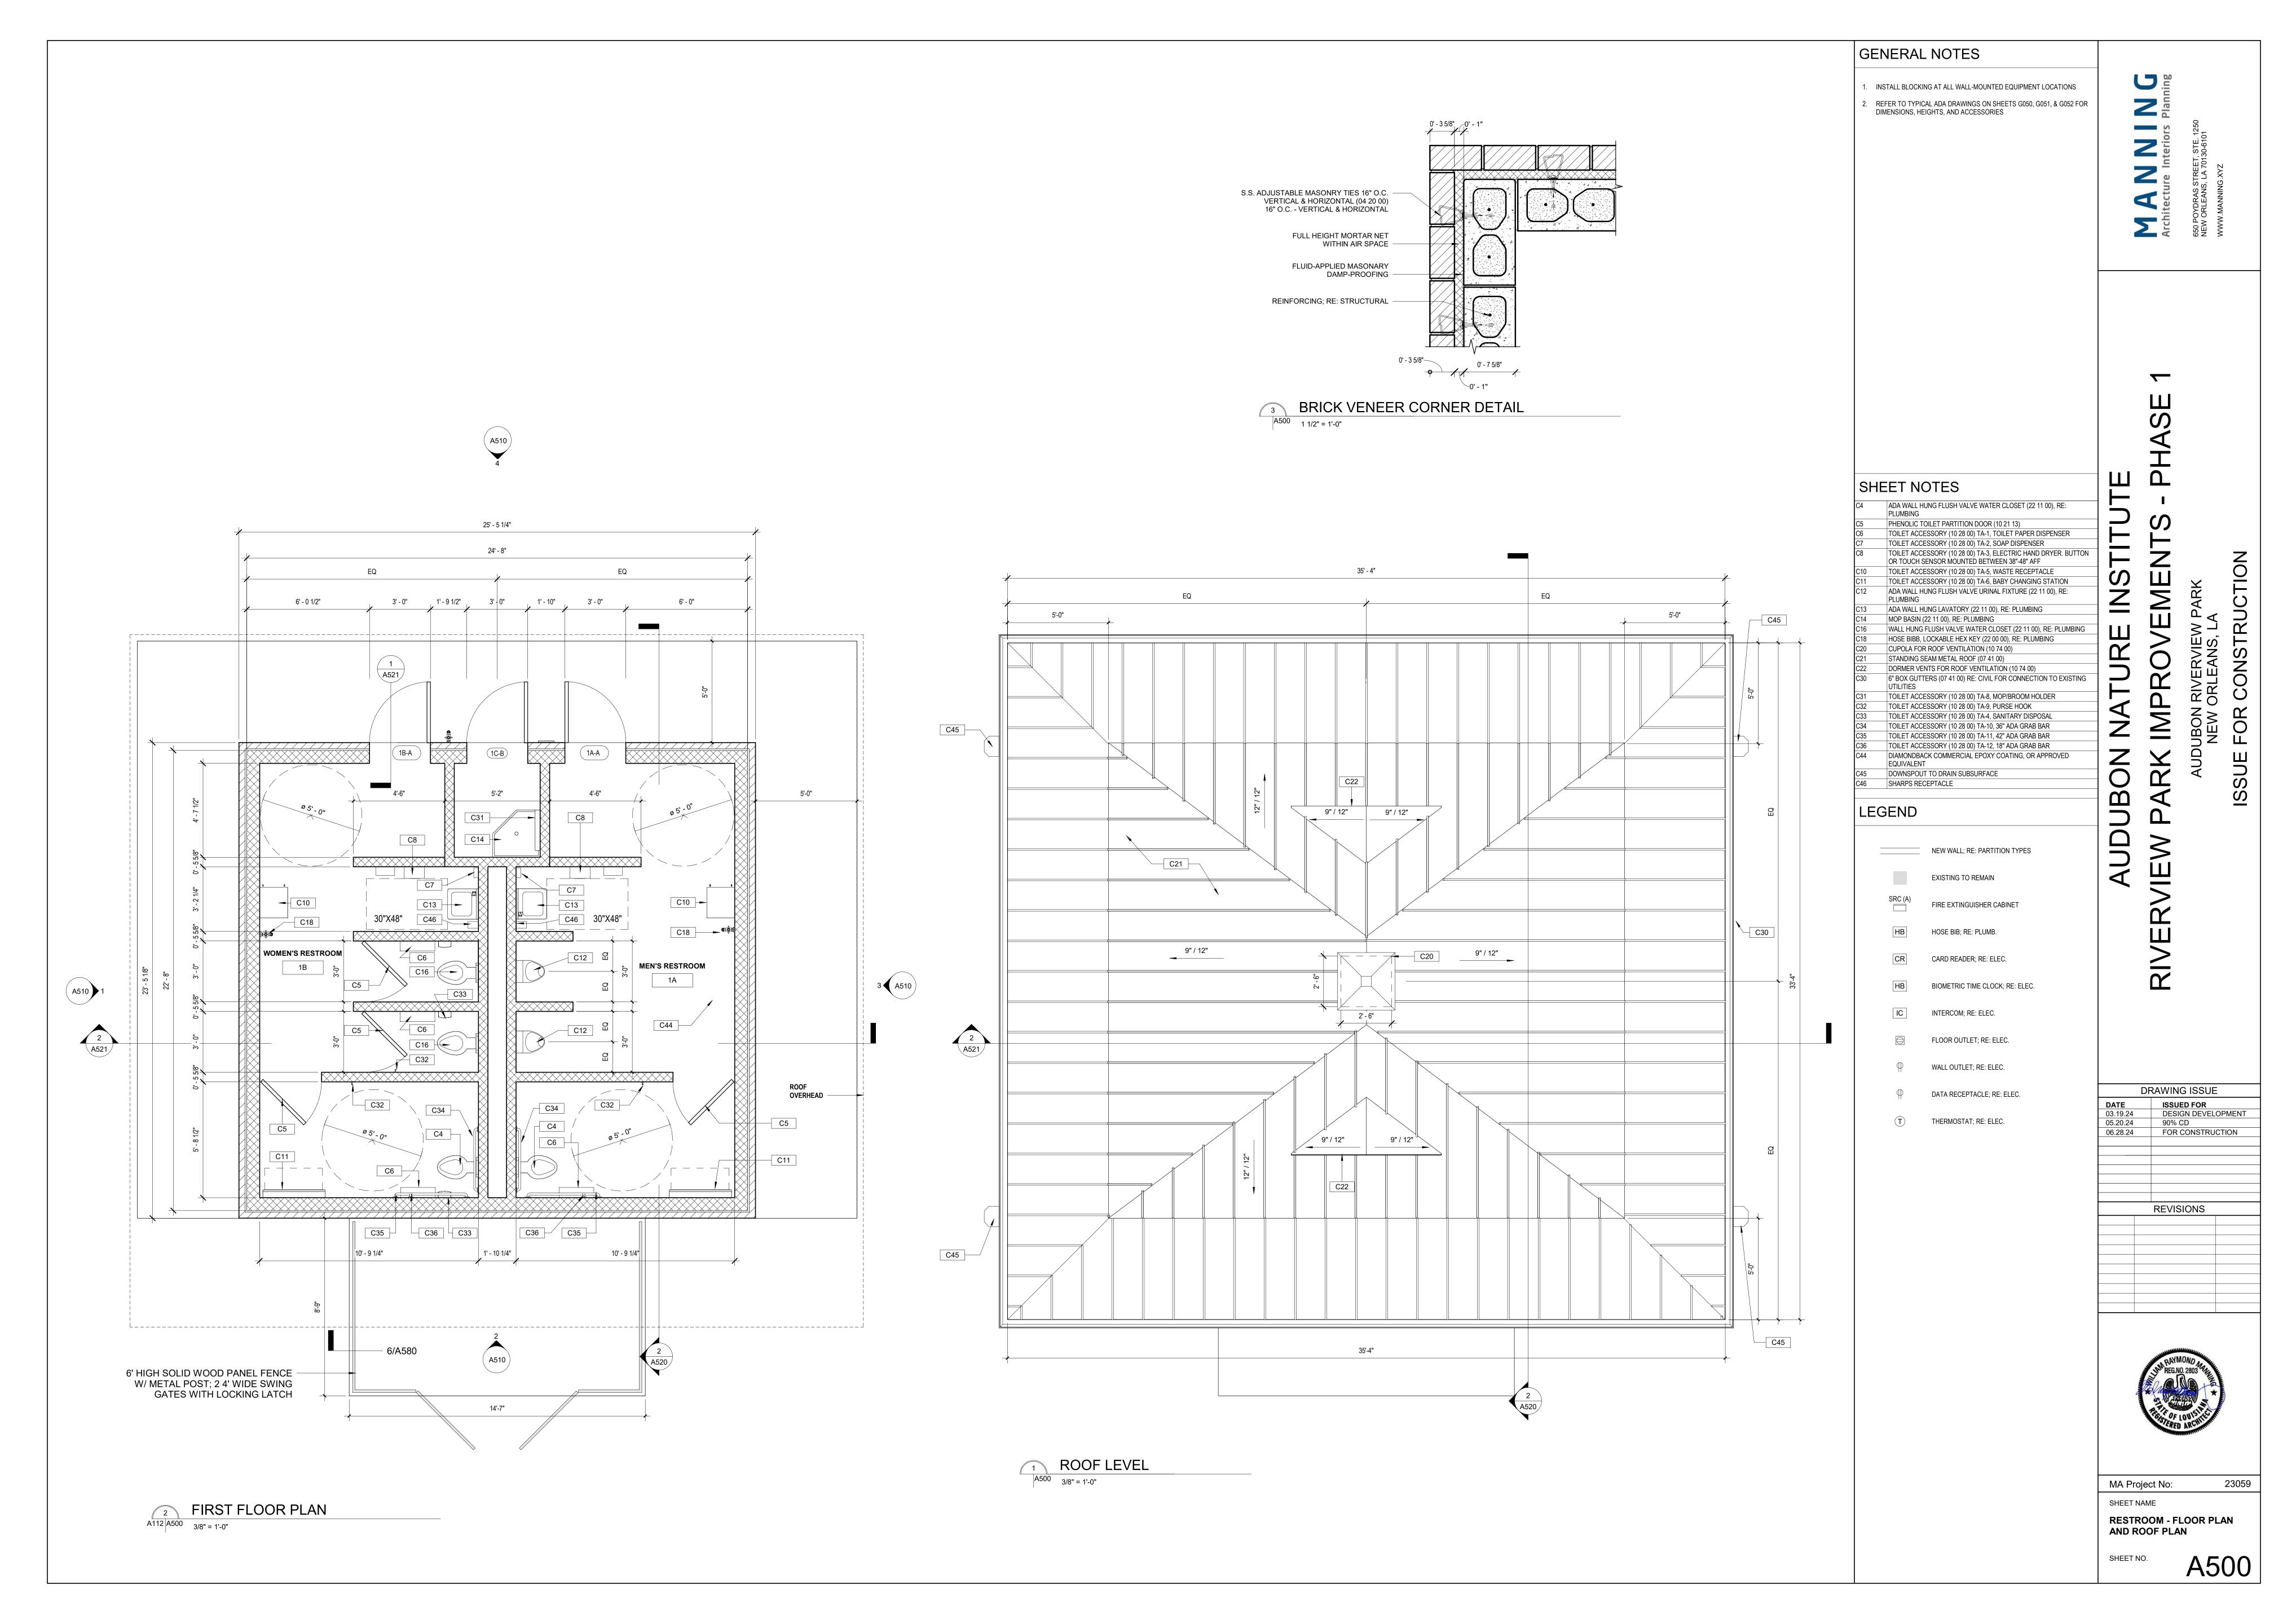






MA Project No: SHEET NAME PLAYGROUND COLOR

23059





B.O. ROOF 11' - 4"

C47

MECH. YARD PERIMTER
 FENCE DASHED FOR CLARITY

C30

C29

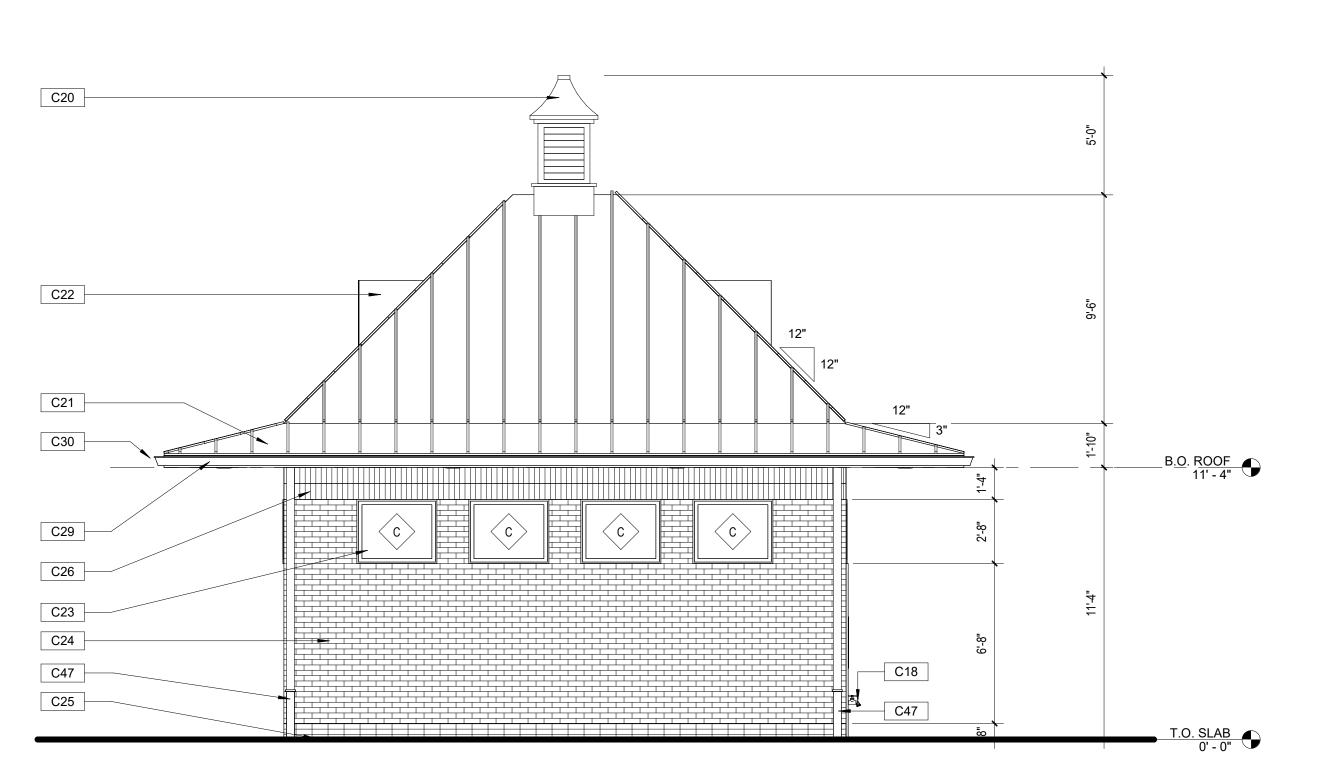
C27

C24 C47

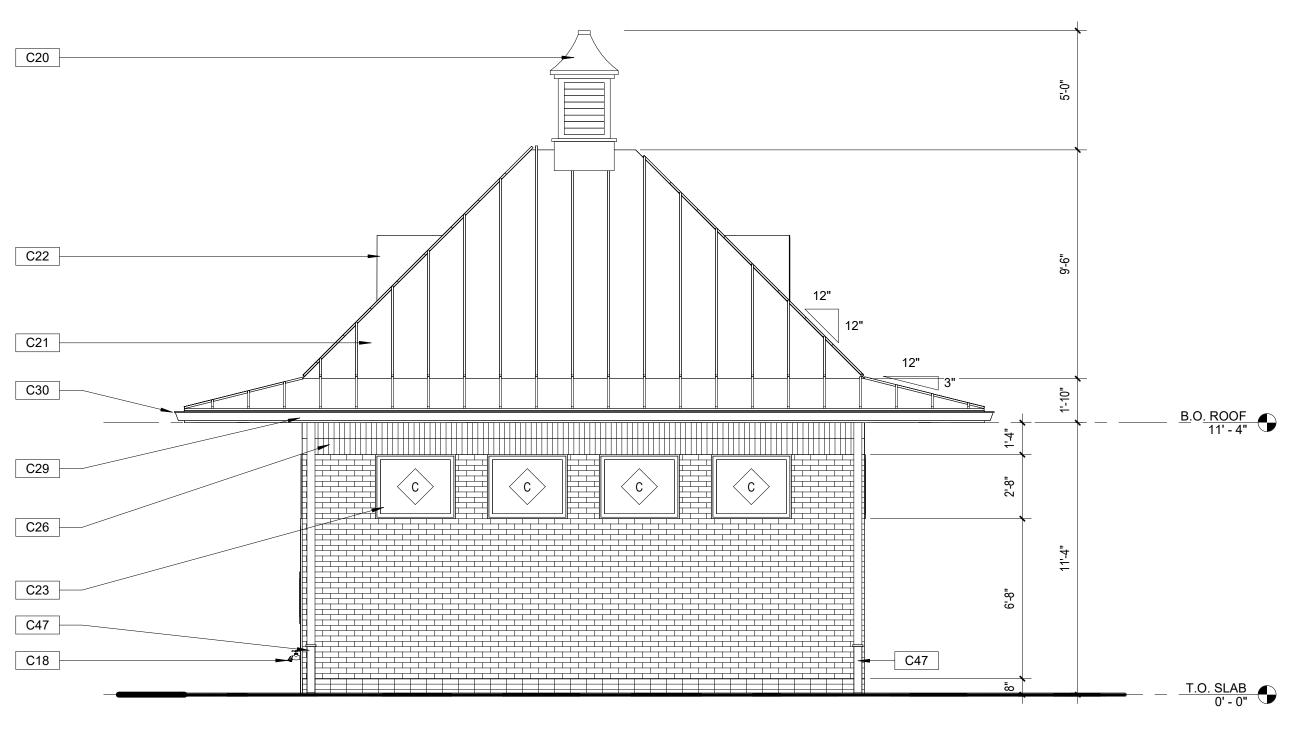
C25

EAST BUILDING ELEVATION

A500 A510 1/4" = 1'-0"



NORTH BUILDING ELEVATION



SOUTH BUILDING ELEVATION A114 A510 1/4" = 1'-0"

SHEET NOTES HOSE BIBB, LOCKABLE HEX KEY (22 00 00), RE: PLUMBING CUPOLA FOR ROOF VENTILATION (10 74 00) STANDING SEAM METAL ROOF (07 41 00) DORMER VENTS FOR ROOF VENTILATION (10 74 00) TRANSLUSCENT POLYCARBONATE GLAZING (08 51 13) FACE BRICK (04 20 00) TO MATCH ADJACENT STRUCTURES TRIPLE STACK BOND BRICK DOUBLE SOLDIER COURSE BRICK HURRICANE-RATED LOUVERS FOR CROSS VENTILATION (08 90 00) FIBER CEMENT SOFFIT BOARD, PT- (09 29 00) 6" BOX GUTTERS (07 41 00) RE: CIVIL FOR CONNECTION TO EXISTING RECESSED FIRE EXTINGUISHER CABINET (10 44 00) RECTANGULAR CAST IRON DOWNSPOUT GUTTER, COLORED TO MATCH DOWNSPOUTS AND GUTTERS EMERGENCY LIGHT TO BE REMOVED AND REINSTALLED ON NEW BUILDING; POWER AND CONDUIT TO BE RUN ON INTERNAL FACE OF EMERGENCY CALL BOX TO BE REMOVED AND REINSTALLED ON NEW BUILDING; POWER AND CONDUIT TO BE RUN ON INTERNAL FACE OF AUDUBON

GENERAL NOTES

LEGEND

DRAWING ISSUE
 DATE
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 03.19.24
 DESIGN DEVELOPMENT

 05.20.24
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 FOR CONSTRUCTION
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MA Project No: 23059 SHEET NAME **RESTROOM - EXTERIOR**

ELEVATIONS

SHEET NO.

A510

Z

₹ Z

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ELECTRICAL SYMBOLS NOT ALL SYMBOLS ARE USED **DESCRIPTION** CEILING WALL O D LIGHT FIXTURE EMERGENCY LIGHT FIXTURE EXIT LIGHT. SHADING DENOTES SIDE WITH FACE LIGHT FIXTURE - POLE MOUNTED LIGHT FIXTURE - WALL WASHER $\vdash \hookrightarrow$ LIGHT FIXTURE STRIP LIGHT FIXTURE - BATTERY UNIT LOW VOLTAGE MOMENTARY CONTACT SWITCH LOW VOLTAGE MOMENTARY CONTACT SWITCH WITH DIMMER WALL ASTRONOMICAL TIMER SWITCH DIGITAL SCENE CONTROL DIMMING SWITCH. "x" DENOTES NUMBER OF SCENES DIGITAL ZONE CONTROL STATION WITH MANUAL DIMMING. "x" DENOTES NUMBER OF ZONES DIGITAL ZONE CONTROL WITHOUT MANUAL DIMMING. "x" DENOTES NUMBER OF ZONES LINE VOLTAGE SWITCH THREE WAY LINE VOLTAGE SWITCH (SUBSCRIPT DENOTES FIXTURE CONTROLLED) FOUR WAY LINE VOLTAGE SWITCH (SUBSCRIPT DENOTES FIXTURE CONTROLLED) LINE VOLTAGE DIMMER (SUBSCRIPT DENOTES FIXTURE CONTROLLED) LINE VOLTAGE TOGGLE SWITCH WITH PILOT LOT LINE VOLTAGE SINGLE POLE SWITCH KEY OPERATED MANUAL STARTER WITH THERMAL OVERLOAD ELEMENT TWO BUTTON WIRELESS DIMMER SWITCH (SUBSCRIPT DENOTES FIXTURE CONTROLLED) TWO BUTTON WIRELESS SWITCH (SUBSCRIPT DENOTES FIXTURE CONTROLLED) THREE BUTTON WIRELESS DIMMER SWITCH (SUBSCRIPT DENOTES FIXTURE CONTROLLED) THREE BUTTON WIRELESS SWITCH (SUBSCRIPT DENOTES FIXTURE CONTROLLED) 0-10V DIMMER WALL SWITCH SENSOR (DUAL TECHNOLOGY) WALL SWITCH SENSOR (DUAL TECHNOLOGY) DUAL RELAY WALL SWITCH SENSOR (DUAL TECHNOLOGY) PIR OCCUPANCY SENSOR \odot ULTRASONIC OCCUPANCY SENSOR **(**1) DUAL TECHNOLOGY OCCUPANCY SENSOR WIRELESS POWER PACK DIMMING MODULE (MOUNTED IN ACCESSIBLE CEILING SPACE, UNLESS NOTED OTHERWISE) WIRELESS POWER PACK RELAY MODULE (MOUNTED IN ACCESSIBLE CEILING SPACE, UNLESS NOTED OTHERWISE) POWER PACK RELAY, DUAL VOLTAGE (MOUNTED IN ACCESSIBLE CEILING SPACE, UNLESS NOTED OTHERWISE) LIGHTING CONTROL REMOTE RELAY (NON-DIM OR DIMMING PER PLANS) (MOUNTED IN ACCESSIBLE CEILING SPACE, UNLESS NOTED OTHERWISÉ) EMERGENCY LIGHTING CONTROL UNIT (MOUNTED IN ACCESSIBLE CEILING SPACE, UNLESS NOTED OTHERWISE) ROOM LIGHTING CONTROLLER (MOUNTED IN ACCESSIBLE CEILING SPACE, UNLESS NOTED OTHERWISE) LIGHTING CONTACTOR TIME CLOCK PHOTOCELL WIRELESS AREA CONTROLLER \Rightarrow DUPLEX RECEPTACLE 20 AMP, 2 POLE, 3W, 120V, GROUNDING TYPE SAME AS ABOVE, MOUNTED ABOVE COUNTER DUPLEX RECEPTACLE, 20 AMP, 2 POLE, 3W GFI TYPE GFI ←

(GROUND FAULT INTERRUPTER)

DUPLEX RECEPTACLE, 20 AMP, 2 POLE, 3W ISOLATED GROUND TYPE

SINGLE RECEPTACLE 20 AMP, 2 POLE, 3W, 120V GROUNDING TYPE

		ELECTRICAL SYMBOLS NOT ALL SYMBOLS ARE USED							
SYN	MBOL	<u>DESCRIPTION</u>							
	<u> </u>	QUADRAPLEX RECEPTACLE QUADRAPLEX RECEPTACLE MOUNTED ABOVE COUNTER SINGLE RECEPTACLE, 20AMP, 250V, OR 120/250V GROUNDING TYPE (20AMP UNLESS NOTED OTHERWISE) SPECIAL RECEPTACLE AS NOTED TRANSFORMER FLOOR BOX WITH 20A DUPLEX RECEPTACLE MULTI-SERVICE FLOOR BOX							
<u>_</u>	<u>r</u>								
<u> </u>	<u>r</u> D=								
	<u> </u>								
	<u> </u>								
	<u>-</u>)								
	 <u> </u>								
<u></u>	2)	MOTOR (NUMERAL INDICATES H.P.)							
		COMBINATION MAGNETIC STARTER & DISCONNECT SWITCH							
×		MAGNETIC STARTER (FURNISHED BY MECHANICAL, INSTALLED BY ELECTIRCAL)							
VF	D	VARIABLE FREQUENCY DRIVE (FURNISHED BY MECHANICAL, INSTALLED BY ELECTIRCAL)							
В	 3]	ENCLOSED CIRCUIT BREAKER							
		DISCONNECT SWITCH - SIZE/POLES/FUSE/NEMA TYPE							
•]	PUSH BUTTON STATION							
Р]	PULL BOX							
M	1	METER							
CH	1	DOORBELL CHIME							
		MULTI-OUTLET ASSEMBLY (PLUG STRIP OR SURFACE METAL RACEWAY AS NOTED)							
		CROSSHATCHING INDICATES EQUIP. DISCONNECTION AND REMOVAL							
		CIRCUIT WIRING IN CONDUIT (CONCEALED). TICK MARKS DENOTE QUANTITY OF PHASE AND NEUTRAL CONDUCTORS. CONDUIT IS TO INCLUDE AN EQUIPMENT GROUND WIRE SIZED PER NEC (NOT SHOWN). UNLESS NOTED OTHERWISE, NO MARKS INDICATE 2#12, 1#12 GROUND IN CONDUIT							
+	 	CONDUIT IN OR UNDER FLOOR SLAB, OR UNDERGROUND CONDUIT EXPOSED EXISTING CONDUIT TO REMAIN							
_ 	<u> </u>								
——Е	EX								
<u>FLUSH</u>	SURFACE								
_	_	PANELBOARD							
		EQUIPMENT CABINET AS NOTED							
CEILING	WALL	<u>TELECOMMUNICATIONS</u>							
		TELEPHONE BACKBOARD							
•	⋖ ×D ×T	COMMINICATION OUTLET, "xD" DENOTES x NUMBER OF DATA DROPS, "xT" DENOTES x NUMBER OF TELEPHONE DROPS IN ONE DEVICE BOX. TWO GANG BOX WITH SINGLE GANG TRIM RING AND FACEPLATE FOR QUANTITY OF DROPS IN BOX							
<	\triangleleft	EMPTY COMMUNICATION OUTLET. TWO GANG BOX WITH SINGLE GANG TRIM RING AND BLANK FACEPLATE							
•	■WAP	WIRELESS ACCESS POINT. ONE DATA DROP IN BOX							
(FLOOR BOX WITH DATA/PHONE OUTLET							
_	\triangleleft	T.V. OUTLET. SINGLE GANG BOX WITH F CONNECTOR AND FACEPLATE							
<	P	INTERCOM PAGING HORN							
•	4	INTERCOM ADMIN TELEPHONE							
	Ι	INTERCOM CALL SWITCH. PROVIDE VOLUME CONTROL STATION ADJACENT TO CALL SWITCH							
Н	©1,2	CLOCK. "1" DENOTES SINGLE FACE, "2" DENOTES DOUBLE FACE							
<u>s</u>	HS	INTERCOM SPEAKER							
M	⊢⊚	MICROPHONE OUTLET							
	AR	AREA OF RESCUE CALL STATION							
	I 😽	FIRE ALARM							
s	S	SPEAKER ONLY							
s 15	s ₁₅	STROBE ONLY (SUBSCRIPT DENOTES CANDELA OF STROBE)							

		ELECTRICAL SYMBOLS NOT ALL SYMBOLS ARE USED
SYM	MBOL	NOT ALL STIMBOLS AND USED
CEILING	WALL	<u>DESCRIPTION</u>
HS 15	HS 15	HORN/STROBE (SUBSCRIPT DENOTES CANDELA OF STROBE)
SS ₁₅	V SS ₁₅	SPEAKER/STROBE (SUBSCRIPT DENOTES CANDELA OF STROBE)
<u> </u>	H2	SMOKE DETECTOR
<u>(S)</u>	HS>	SMOKE DETECTOR WITH LOW FREQUENCY SOUNDER BASE
	F	MANUAL PULL STATION
	 D	DUCT MOUNTED SMOKE DETECTOR.
	<u></u> T	"S" DENOTES SUPPLY DUCT, "R" RETURN DUCT THERMAL DETECTOR
	D _{co}	COMBINATION SMOKE/CARBON MONOXIDE DETECTOR COMBINATION SMOKE/CARBON MONOXIDE DETECTOR WITH LOW
	s) _{co}	FREQUENCY SOUNDER BASE
	ЭН	MAGNETIC DOOR HOLDER
F	-s	FLOW SWITCH
Ī	rs	TAMPER SWITCH
С	СМ	CONTROL MODULE
M	1М	MONITOR MODULE
		<u>SECURITY</u>
С	CR	CARD READER
-[М	MOTION DETECTOR 180°
	<u>M</u> -	MOTION DETECTOR 360°
- I	<u>.</u> К	SECURITY KEYPAD
<u>_</u>	_ H© 4	SECURITY CAMERA
 		INTRUSION AUDIO DEVICE
		INTRUSION DETECTION SIREN
	<u>s</u>	ELECTRIC DOOR STRIKE
A		ABBREVIATIONS AMPS
AF		ABOVE FINISHED FLOOR
AF		ABOVE FINISHED GRADE
AL	_, ALUM	ALUMINUM
AT	ΓS	AUTOMATIC TRANSFER SWITCH
AV	WG	AMERICAN WIRE GUAGE
С		CONDUIT
	O.	CONDUIT ONLY
Cl		COPPER
C1	NC	CURRENT TRANSFORMER ELECTRIC WATER COOLER
Ε\		EXISTING TO REMAIN
	<u>` </u>	FULL LOAD AMPS
GI	FI	GROUND FAULT INTERRUPTER
GI	ND	GROUND
IG		ISOLATED GROUND
	VA	KILO VOLT AMPS
K\		MANUAL TRANSFER SWITCH
М Р	TS	MANUAL TRANSFER SWITCH POLE
	H.Ø	PHASE
	YP	TYPICAL
TF	₹	TAMPER RESISTANT
W	′P	WEATHERPROOF
W	'R	WEATHER RESISTANT
V	TAID	VOLTS
XF	MR	TRANSFORMER

GENERAL NOTES:

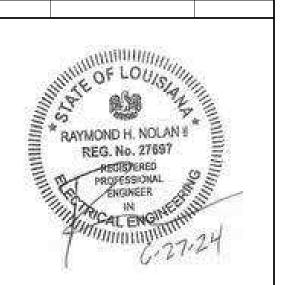
- 1. COORDINATE THE LOCATION OF ALL DEVICES AND LIGHT FIXTURES WITH THE ARCHITECT, AND OTHER TRADES, PRIOR TO ROUGH-IN. IN FINISHED SPACES LIGHT FIXTURE LOCATIONS SHOWN ON THE DRAWINGS SHALL BE MAINTAINED. WHERE A CONFLICT OCCURS NOTIFY THE ARCHITECT FOR RESOLUTION.
- 2. THE CONTRACTOR SHALL SEAL ALL CONDUITS, AT BOTH ENDS, ROUTED UNDERGROUND AFTER CONDUCTORS ARE INSTALLED.
- 3. THE CONTRACTOR SHALL COORDINATE AND ARRANGE FOR TEMPORARY POWER DURING CONSTRUCTION. THE CONTRACTOR SHALL INCLUDE ALL COSTS ASSOCIATED WITH TEMPORARY SERVICES IN HIS BID.
- 4. CONTRACTOR SHALL FIRE SEAL ALL CONDUIT PENETRATIONS AT FIRE RATED WALLS AND FLOORS.
- 5. ALL DEVICE WALL PLATES SHALL BE STAINLESS STEEL.
- 6. ALL EXTERIOR 15 AND 20 AMP NON-LOCKING RECEPTACLES SHALL BE LISTED WEATHER-RESISTANT TYPE.
- 7. THE CONTRACTOR SHALL PROVIDE A SEPARATE NEUTRAL CONDUCTOR, SIZED TO MATCH THE PHASE CONDUCTOR, FOR EACH BRANCH CIRCUIT. DO NOT SHARE A NEUTRAL BETWEEN TWO OR MORE BRANCH CIRCUITS.
- 8. MC CABLE SHALL BE PERMITTED FOR BRANCH CIRCUITS. CONDUIT HOMERUNS SHALL BE USED. MC CABLE SHALL BE INSTALLED PER NEC ARTICLE 330.
- 9. DO NOT ROUTE CONDUITS WITHIN SLAB. CONDUITS SHALL BE ROUTED BELOW SLAB.
- 10. PROVIDE PULL STRINGS IN ALL EMPTY CONDUITS.
- 11. CONTRACTOR SHALL PROVIDE IN GRADE HANDHOLE/PULL BOX AS NECESSARY FOR BRANCH CIRCUITS TO OVERLOOKS AND PLAYGROUND LIGHTS. BOXES SHALL BE USED FOR PULL POINTS ONLY; DO NOT SPLICE CIRCUITS IN BOX. BOXES SHALL BE MINIMUM 11" X 18" X 24" DEEP WITH BOLT DOWN. TIER 15 COVER AND STAINLESS STEEL HARDWARE. QUAZITE PG SERIES OR EQUAL. DO NOT LOCATE PULL BOX IN ROADWAYS, DRIVEWAYS, SIDEWALKS OR UNDER TREE CANOPIES.
- 12. ALL RECEPTACLES FOR THIS PROJECT SHALL BE TAMPER
- 13. ALL EXTERIOR WEATHERPROOF RECEPTACLES SHALL HAVE LOCKABLE WHILE IN USE COVER. TAYMAC MX4280S SINGLE GANG, TAYMAC MX7280S (QUAD) TWO GANG.

						LAMI	P	
ГҮРЕ	REMARKS	CATALOG NO.	MOUNTING	VOLTAGE	LAMP QTY	TYPE	TOTAL WATTS	NOTES
F1	4 FOOT VAPORTIGHT WITH T8 LED TUBES	BRILLIHOOD LED VAPOR PROOF 4 FT LIGHT FIXTURE WITH CLEAR COVER, IP65 (NOTE 1)	SURFACE	120V	2	T8 LED TUBE	36	6000K
F2	EMERGENCY LIGHT	EXITRONIX #LEM54-N4-WH	SURFACE	120V	-	LED	-	
F3	6" LENSED DOWNLIGHT	HALO #E71CAT-426-6150WH (NOTE 1)	RECESS	120V	1	60 WATT A19 LED	10	4000K
F4	EXTERIOR EMERGENCY LIGHT WITH PHOTOCELL AND PIR MOTION SENSOR	EXITRONIX #SLW-15-4K-EM (NOTE 2)	WALL	120V	1	LED	15	4000K
F5	AREA LIGHT WITH GOOSENECK BRACKET (LESS SCROLL) AND 12 FT POLE/BASE	ALUMILITE #VK2100/E26(MEDIUM BASE)/INC-UV-ICCA-CC/DP212FLCC-LESS SCROLL (NOTES 1 AND 3)	POLE	120V	1	ED17 LED BULB (NOTE 4)	45	4000K

NOTES:

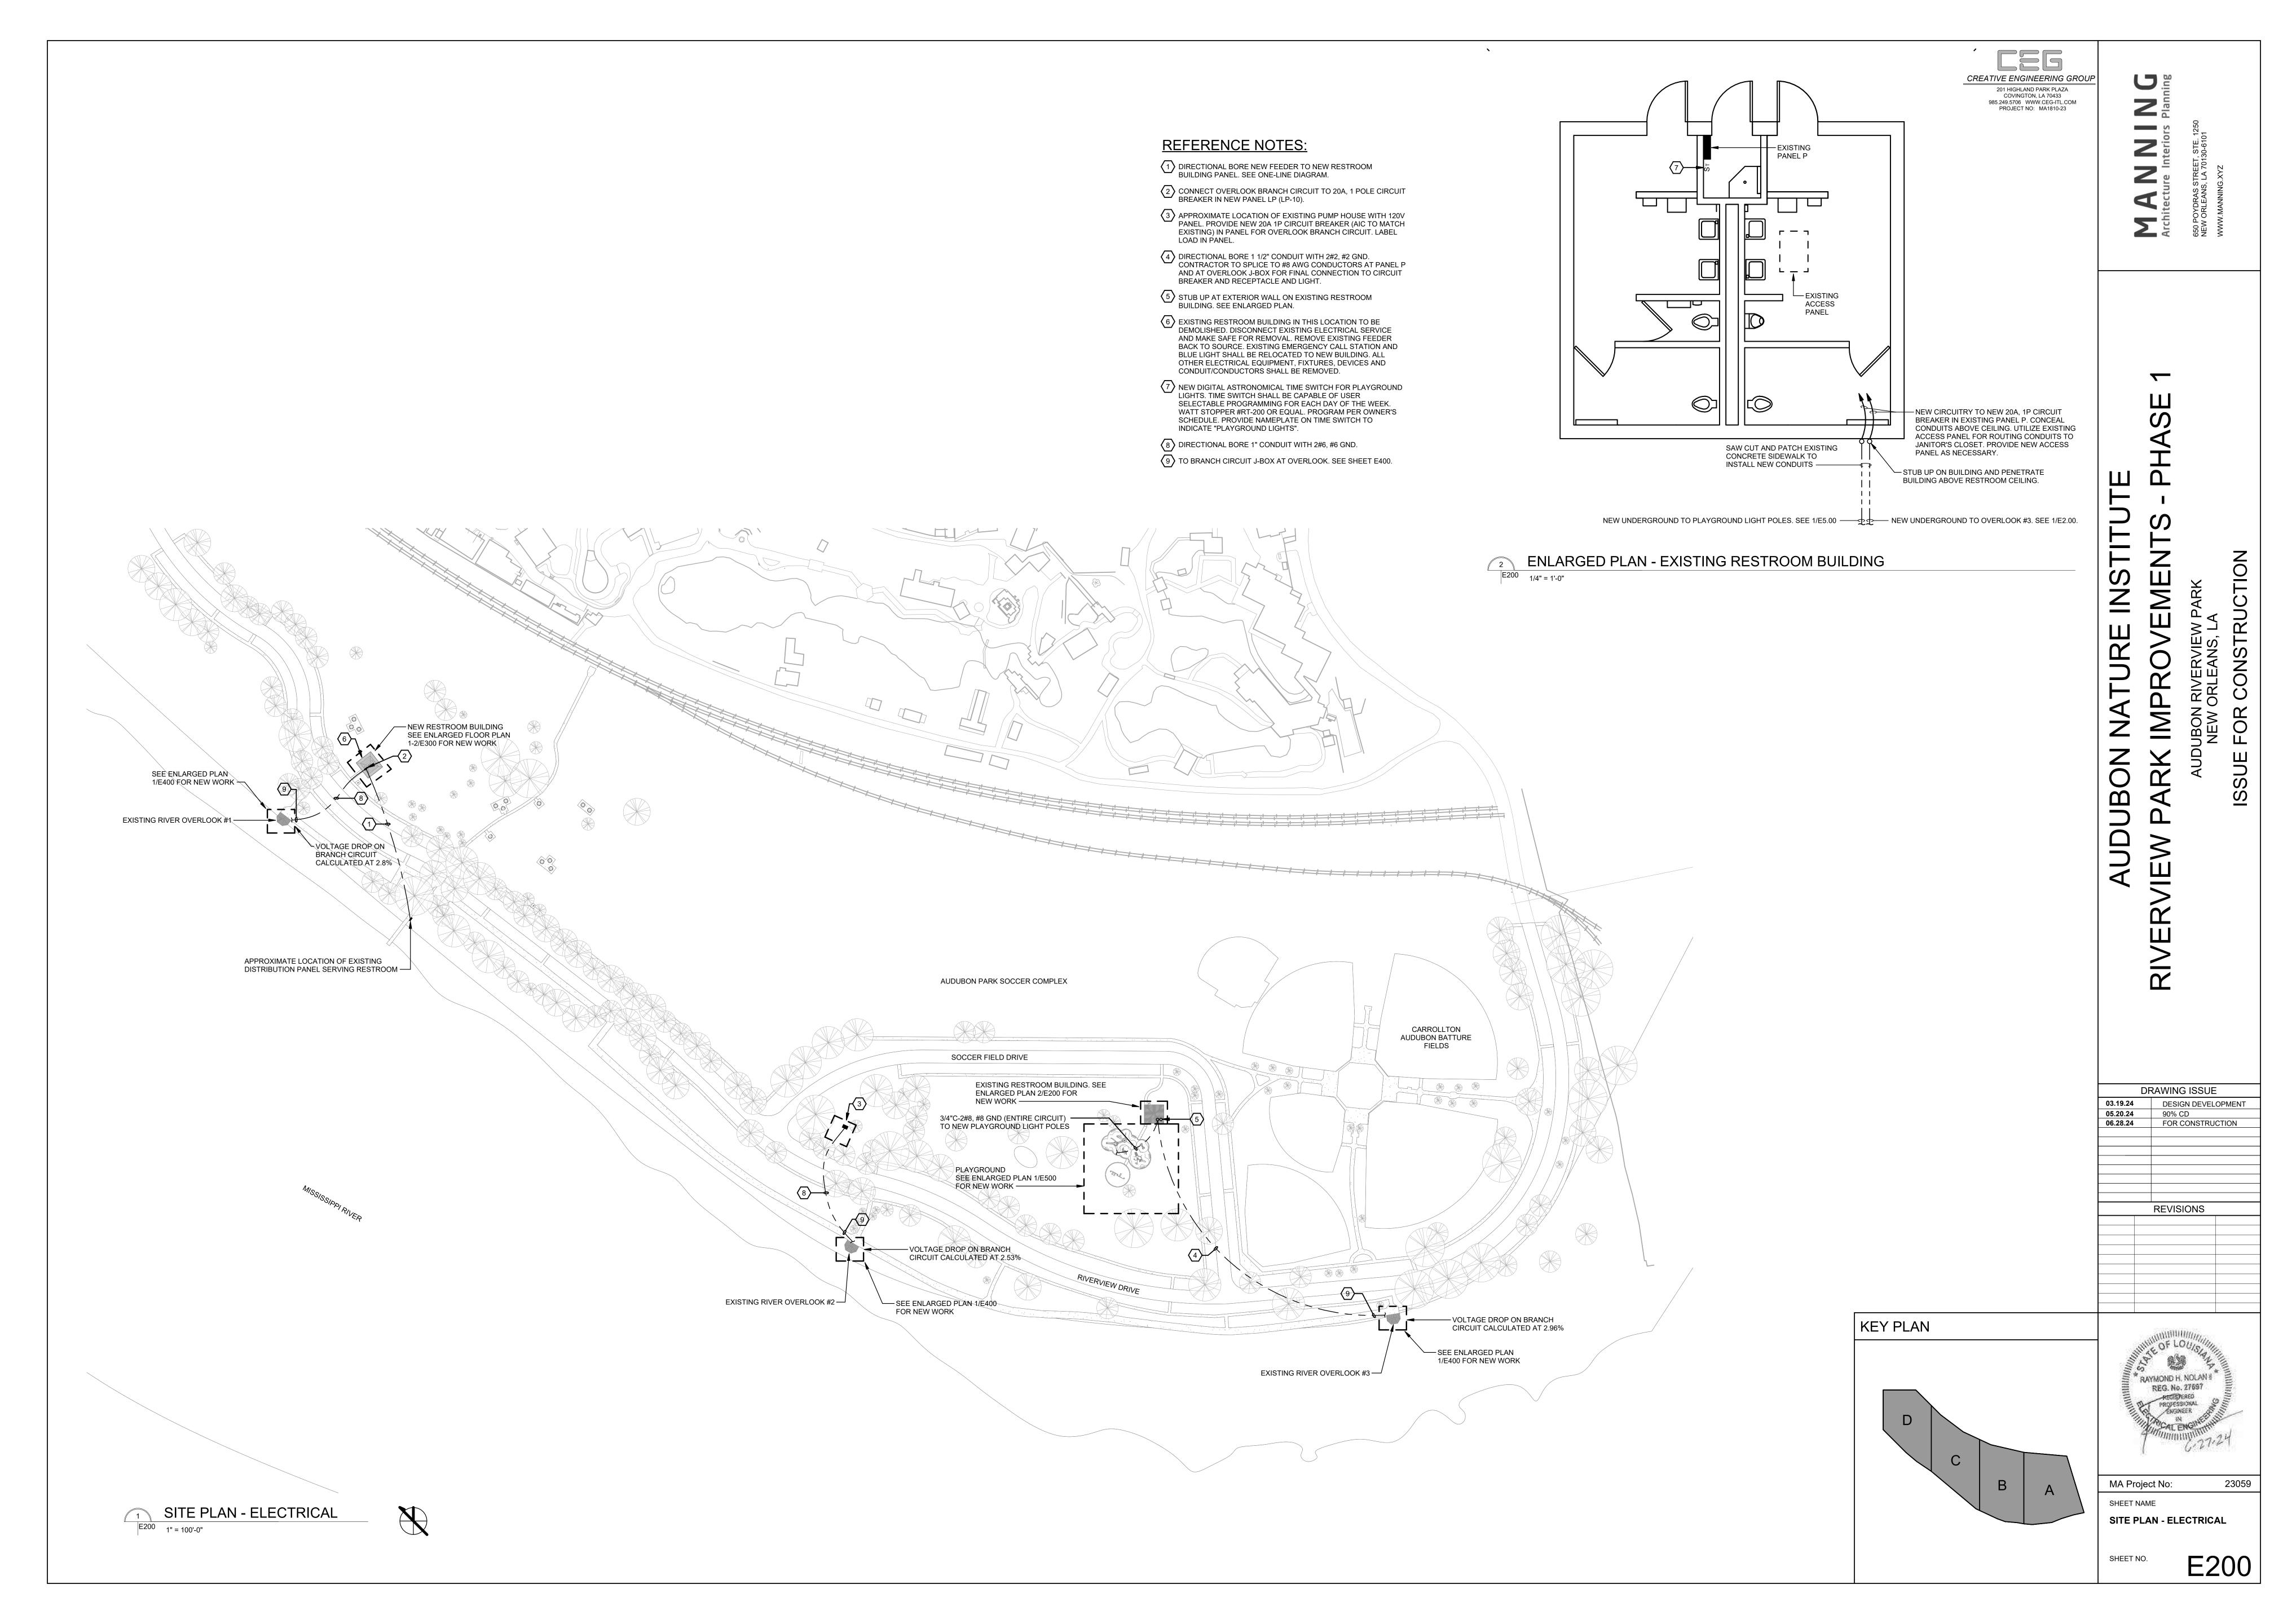
- 1. PROVIDE LED BULBS IN FIXTURE
- 2. LIGHT SHALL ACTIVATE IN AC MODE FROM DUSK TO DAWN WHEN MOTION IS DETECTED. IN EM MODE LIGHT IS ACTIVATED VIA BATTERY BACK UP FOR 90 MINUTES. 3. VERIFY COLOR WITH ARCHITECT
- 4. GE 93303384 OR EQUAL

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MA Project No:

SHEET NAME LIGHTING FIXTURE SCHEDULE, GENERAL NOTES, SYMBOL LIST



REFERENCE NOTES:

MANUFACTURE INSTRUCTIONS.

PRIMARY/SECONDARY FUSING.

PRIOR TO ROUGH-IN.

TO MATCH EXISTING INSTALLATION.

1 LINE VOLTAGE ULTRASONIC OCCUPANCY SENSOR.

2 EXTERIOR CIRCUIT CONTROLLED BY DIGITAL TIME SWITCH. EXTEND UNSWITCHED PHASE CONDUCTOR TO EXTERIOR EMERGENCY LIGHTS.

FOR HAND DRYER. COORDINATE EXACT LOCATION WITH ARCHITECT PRIOR TO ROUGH-IN.

6 60A,2P CIRCUIT BREAKER FOR RESTROOM BUILDING.

PROVIDE RECESSED BOX FOR AUTO FLUSH SENSORS PER MANUFACTURER AND 1/2" CONDUIT WITH LOW VOLTAGE WIRING

PROVIDE NAMEPLATE WITH 2 LINES OF TEXT FIRST LINE SHALL BE PANEL DESIGNATION AND SECOND LINE SHALL BE WHERE THE PANEL IS FED FROM.

SURFACE BOX FOR CONNECTION TO 120V AUTO FLUSH VALVE POWER SUPPLIES. PROVIDE RECEPTACLES AS REQUIRED FOR PLUG-IN UNITS. COORDINATE QUANTITY AND LOCATION OF POWER SUPPLIES WITH PLUMBER. POWER SUPPLIES SHALL BE FURNISHED BY PLUMBER, INSTALLED BY ELECTRICAL. PROVIDE

RELOCATED EMERGENCY CALL STATION. CONNECT TO 120V CIRCUIT AND PROVIDE NEW CONDUIT AND WIRING TO BLUE LIGHT

PRELOCATED EMERGENCY CALL BLUE LIGHT. MOUNT AT 8'-0" AFF, OR AS DIRECTED BY ARCHITECT.

LIGHTS. TIME SWITCH SHALL BE CAPABLE OF USER SELECTABLE PROGRAMMING FOR EACH DAY OF THE WEEK. WATT STOPPER

10) NEW DIGITAL ASTRONOMICAL TIME SWITCH FOR EXTERIOR

#RT-200 OR EQUAL. PROGRAM PER OWNER'S SCHEDULE. PROVIDE NAMEPLATE ON TIME SWITCH TO INDICATE "EXTERIOR

EXTERIOR EMERGENCY LIGHT WITH INTERNAL MOTION SENSOR. CONNECT TO UNSWITCHED CIRCUIT. LIGHT WILL ACTIVATE IN AC MODE FROM DUSK TO DAWN ONLY WHEN MOTION IS DETECTED.

PROVIDE 120V CONNECTION TO PUMP ENCLOSURE HEATER AND LIGHT. COORDINATE LOCATION WITH MECHANICAL CONTRACTOR

TO POWER SUPPLY. COORDINATE BOX QUANTITY AND EXACT LOCATION WITH MANUFACTURER PRIOR TO ROUGH-IN. WIRE PER

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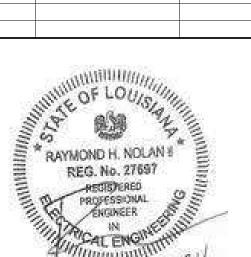
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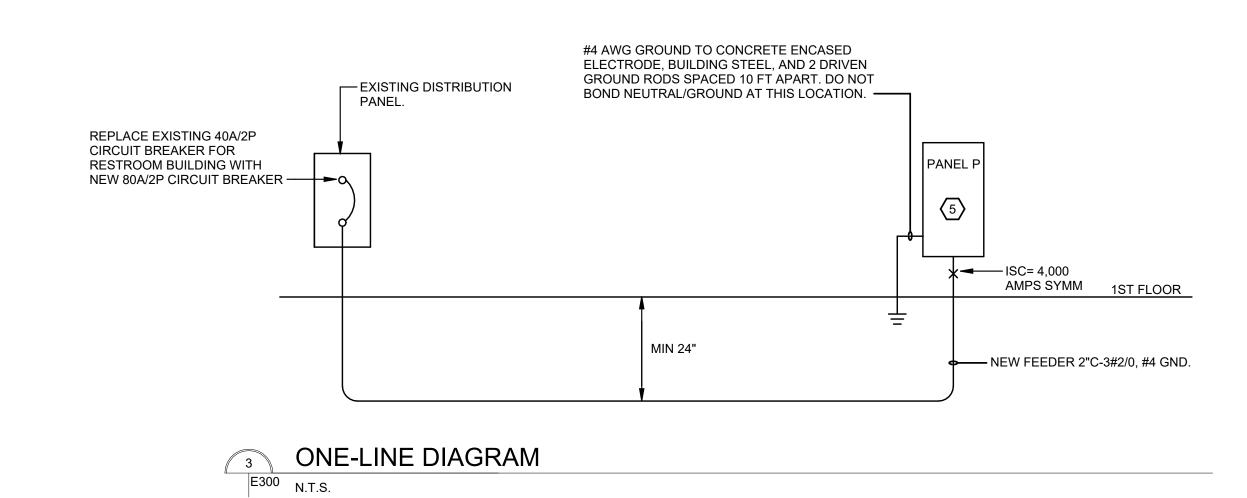


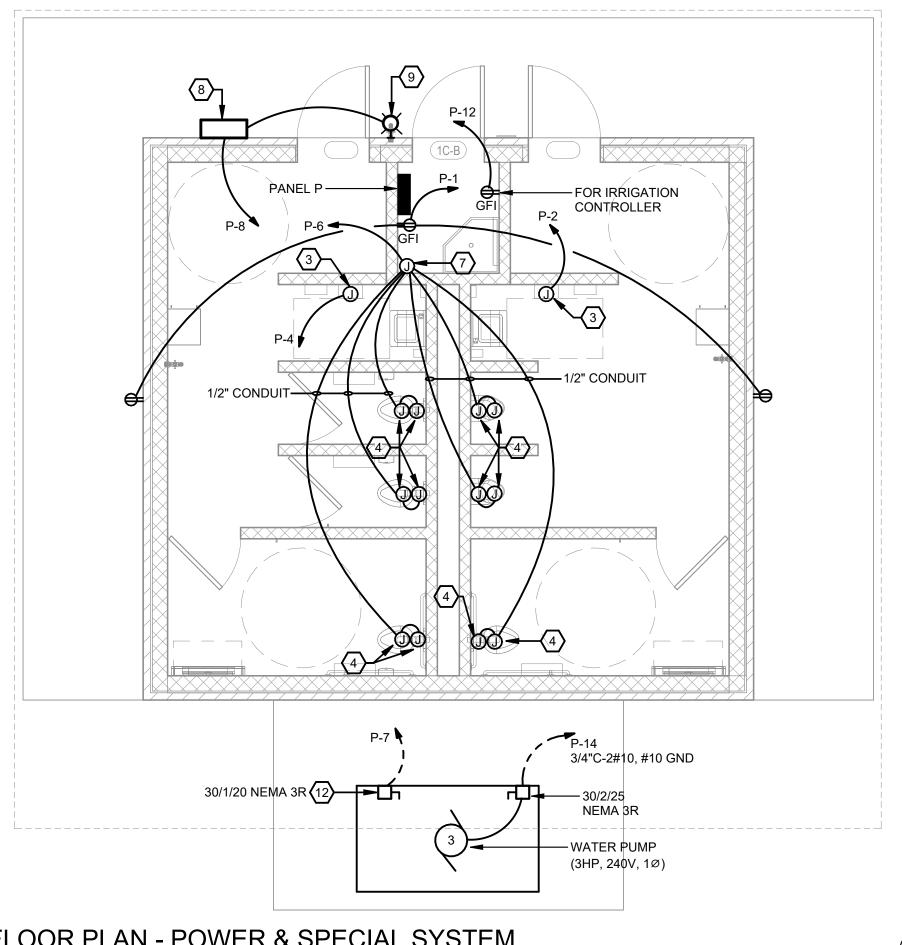
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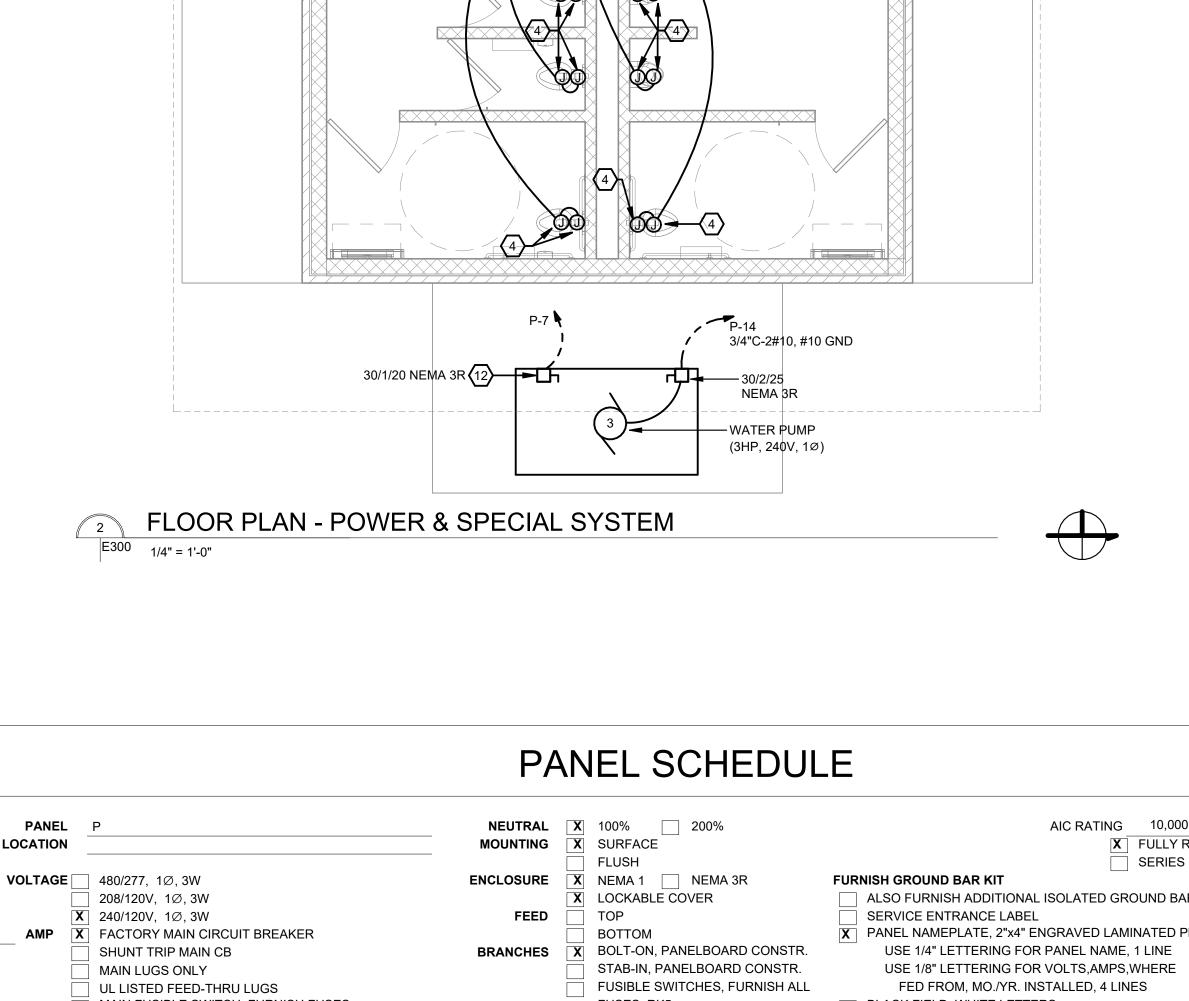
FLOOR PLAN - LIGHTING, POWER & SPECIAL SYSTEMS

E300









PANEL P					NEUTRAL	X 1	00%	20	0%		AIC RATING 10,000					
VOLTAGE 480/277, 1Ø, 3W 208/120V, 1Ø, 3W X 240/120V, 1Ø, 3W 80 AMP X FACTORY MAIN CIRCUIT BREAKER SHUNT TRIP MAIN CB MAIN LUGS ONLY UL LISTED FEED-THRU LUGS MAIN FUSIBLE SWITCH, FURNISH FUSES < 600A, CLASS RK5 > 600A, CLASS L		EN	X SURFACE FLUSH X NEMA 1 NEMA 3R LOCKABLE COVER TOP BOTTOM X BOLT-ON, PANELBOARD CONSTR. STAB-IN, PANELBOARD CONSTR. FUSIBLE SWITCHES, FURNISH ALL FUSES, RK5						SERIES RATUND BAR K ATED PLAS LINE HERE	ED PLASTIC						
CKT.	(T. # OF TRIP		VOLT	VOLT-AMPS		ND LO		VOLT	-AMPS	LOAD DESCRIPTION		# OF	СКТ			
NO.	POLES	AMPS	LOAD DESCRIPTION	А	В	CODE		CODE	Α	В	LOAD DESCRIPTION		POLES	NO		
1	1	20	RESTROOM BLDG RECEPTACLES	540		R		- M	1500		HAND DRYER	20	1	2		
3	1	20	RESTROOM BDLG INTERIOR LIGHTS	///////	300	L		- M		1500	HAND DRYER	20	1	4		
5	1	20	RESTROOM BDLG EXTERIOR LIGHTS	110		L	_	- M	100	<u> </u>	AUTO FLUSH POWER SUPPLY	20	1	6		
7	1	20*	PUMP ENCLOSURE		600	M	_	- M		500	EMERGENCY CALL	20	1	8		
9	1	20	SPARE				_	- M	800		OVERLOOK POWER	20	1	10		
11	1	20	SPARE					- M		500	IRRIGATION	20	1	12		
13	1	20	SPARE					- М	2040		WATER PUMP	30	2	14		
15	1	20	SPARE		1			- М		2040	-	-	-	16		
17	1	20	SPARE					-			SPACE			18		
19			SPACE		1			-		1	SPACE			20		
21			SPACE					-			SPACE			22		
23			SPACE					-		1	SPACE			24		
25			SPACE				7+++	-			SPACE			26		
27			SPACE				7+++	-			SPACE			28		
29			SPACE				7+++	-			SPACE			30		
31							7	-						32		
33							7+++	-						34		
35								-						36		
37							744	-						38		
39							744	-						40		
41					///////		744	-	//////	///////				42		
RIP AN	1PS = FUS	E SIZE	SUBTOTAL ODD SI	DE 650	900	SUBT	TAL E	VEN SIDE	4440	4540	LCL = 410	VA x 1.25 =	513	VA		
FUSII	BLE SWITC	CHES			<u> </u>		PHA	ASE LOAD	5090	5440	КІТС	HEN LOAD	0	VA		
EMAR	KS:	* PROVII	DE LOCKING DEVICE FOR CIRCUIT BREAKER				-	TOTAL VA	10	530	-	IISC. LOAD	9580	VA		
									-		RECEPT	ACLE LOAD	540	V		
											AC= 0 VA= ; HEAT= 0	VA =	0	V		
			A/C @ 125% & HEAT @ 100% LARGEST LOAI								AHU = 0	VA x 1.25	0	V		
												DTAL LOAD	10633	V		





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MA Project No: 23059 SHEET NAME

RIVER OVERLOOK DETAILS E400



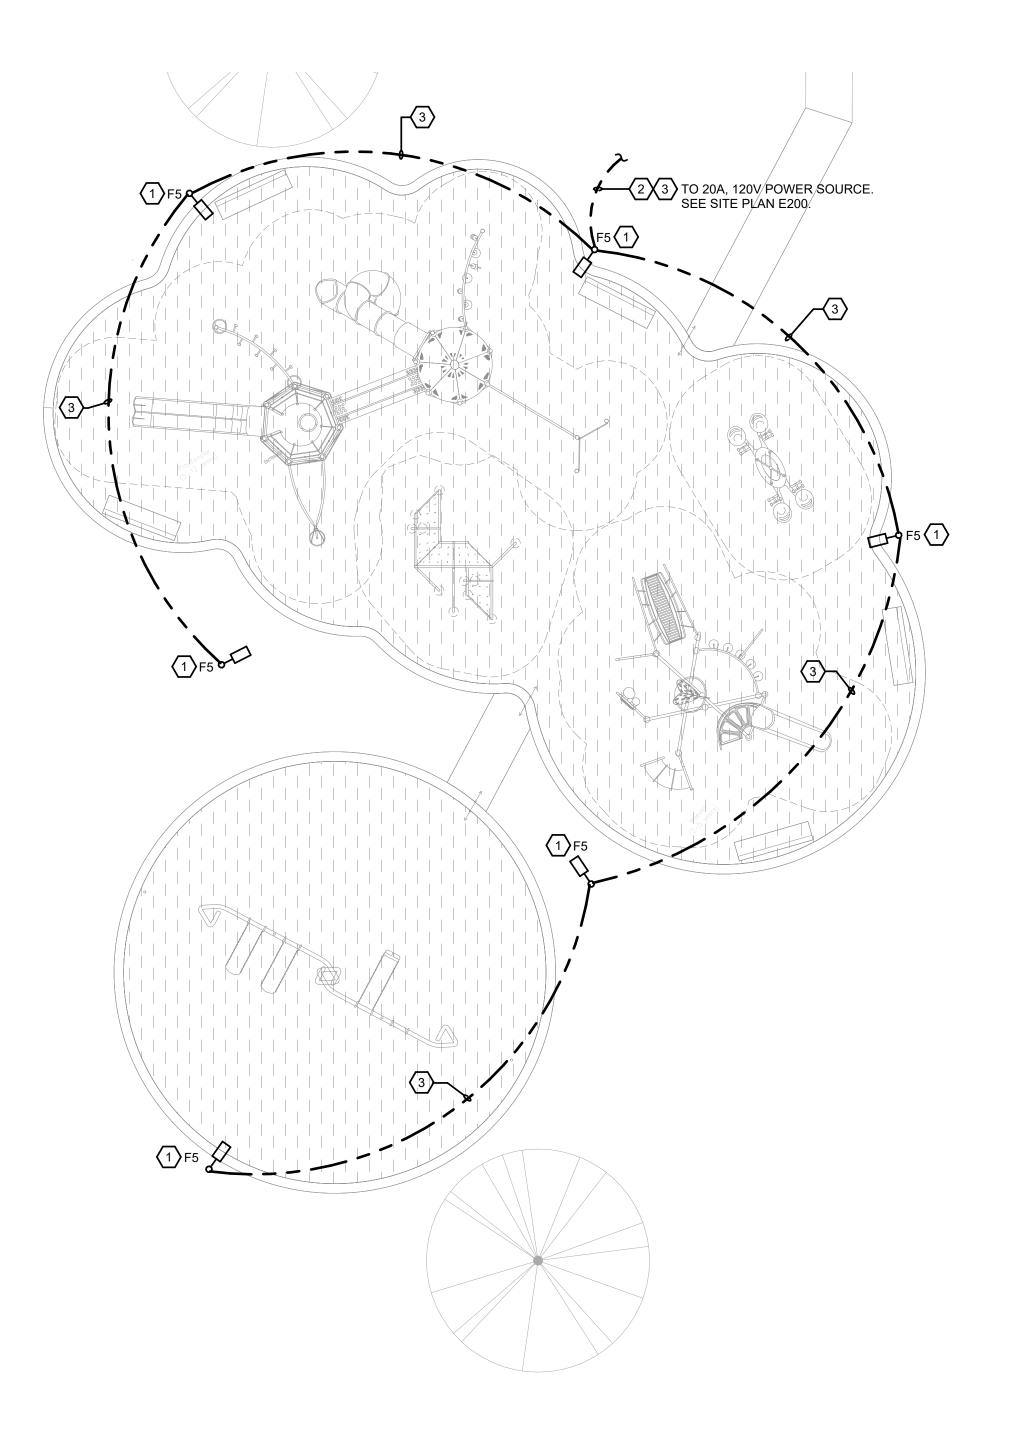


ENLARGED RIVER OVERLOOK #1
(SIMILAR FOR RIVER OVERLOOKS #2 AND #3)

E400 3/8" = 1'-0"

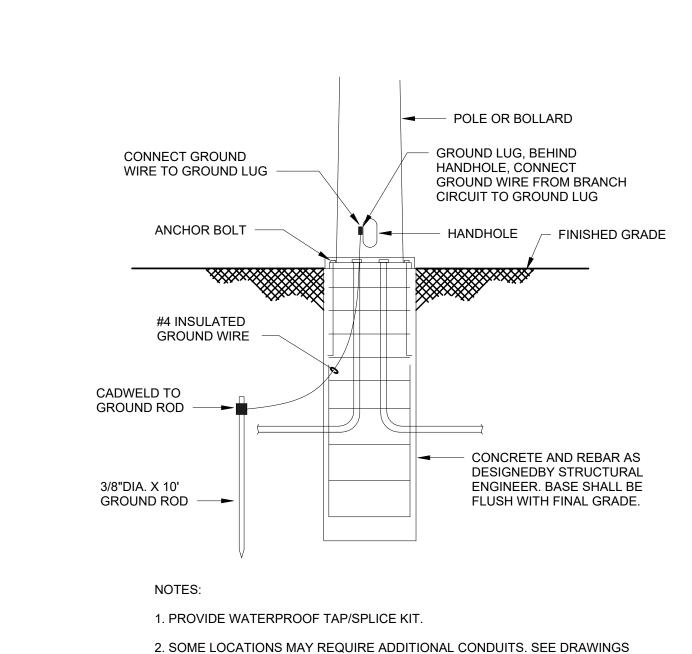






REFERENCE NOTES:

- COORDINATE EXACT LOCATION OF LIGHT POLES WITH ARCHITECT PRIOR TO INSTALLATION.
- PLAYGROUND LIGHTING CIRCUIT SHALL BE ROUTED THRU A NEW DIGITAL ASTRONOMICAL TIME SWITCH IN EXISTING RESTROOM BUILDING. SEE SHEET E200.
- 3) 3/4"C-2#8, #8 GND, CONTRACTOR MAY USE #12 AWG CONDUCTORS, SPLICED AT HANDHOLE, UP POLE TO FIXTURE.



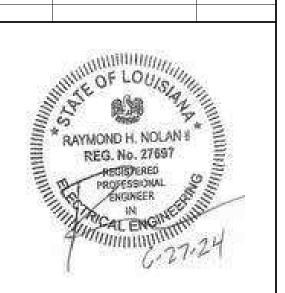
POLE BASE DETAIL (TYPE F5)

E500 N.T.S.

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MA Project No:

SHEET NAME **ENLARGED PLAYGROUND** -ELECTRICAL

E500