OPTION 1

Design Advisory Committee (February 19, 2025)

The applicant explains that a demolition of less than 50% of the building and would like to keep the existing frontage of the building. The HDLC representative states that the side addition to the property is problematic as it bumps out from the building and should be flush with the rest of existing structure.

The CPC representative asks HDLC what their thoughts are about the off-set heights of the building. HDLC responds that the applicant should try to maintain as much of the rhythm and pattern of what is existing.

The CPC representative states that that the concern that the proportion is off and needs to go all one direction to demo more than 50% or start the addition further back. Additionally, the offset of the windows from the front to the back of the structure compounds the design issue.

One constituent spoke in opposition to the item expressing concerns about the property not being used as affordable housing. The HDLC representative made a motion for DEFERRAL, seconded by the CPC representative, and unanimously adopted.

CPC DRAWINGS

SMFA 4PLEX - ADDITION / RENOVATION

7229 Zimpel St. New Orleans LA, 70118

OAK ST.

3' - 0"

SIDE YARD

NEW LOT A

5' - 0"

CORNER-SIDE YARD

43' - 0"

NEW LOT B



KEYNOTES - SHEET

REQ'D FOR IECC REQUIREMENTS. RE: MEP.

N-12 6" ALUMINUM BAKED HALF ROUND STYLE GUTTERS

EXTERIOR WD. STAIR TO MATCH WD. PORCH/DECK.

TREATED FRAMING, TYP. RE: DETAILS / STRUCT.

RIDGE VENT AT ROOF, TYP.


BOOT AS REQ'D.

N-08 NEW PERVIOUS PAVERS THIS LOCATION

FLASHING AS REQ'D. RE: DETAILS

NEW GRADING/SOD AS REQ'D.

	SHEET LIST			
Sheet Name	Sheet Issue Date	Current Revision	Current Revision Date	Current Revision Description
TITLE SHEET	01/16/25			
NERAL INFO				
SITE PLAN - EXIST & PROPOSED	01/16/25			
CTURE	•			
FLOOR PLANS - EXISTING/DEMO	01/16/25			
FLOOR PLANS - PROPOSED	01/16/25			
EXTERIOR ELEVATIONS - EXISTING/DEMO	01/16/25			
EXTERIOR ELEVATIONS - PROPOSED	01/16/25			
	TITLE SHEET NERAL INFO SITE PLAN - EXIST & PROPOSED CTURE FLOOR PLANS - EXISTING/DEMO FLOOR PLANS - PROPOSED EXTERIOR ELEVATIONS - EXISTING/DEMO	Sheet Name Sheet Issue Date TITLE SHEET NERAL INFO SITE PLAN - EXIST & PROPOSED CTURE FLOOR PLANS - EXISTING/DEMO FLOOR PLANS - PROPOSED 01/16/25 EXTERIOR ELEVATIONS - EXISTING/DEMO 01/16/25	Sheet Name Sheet Issue Current	Sheet Name Sheet Issue Date Current Revision Date TITLE SHEET NERAL INFO SITE PLAN - EXIST & PROPOSED CTURE FLOOR PLANS - EXISTING/DEMO FLOOR PLANS - PROPOSED EXTERIOR ELEVATIONS - EXISTING/DEMO 01/16/25 EXTERIOR ELEVATIONS - EXISTING/DEMO 01/16/25

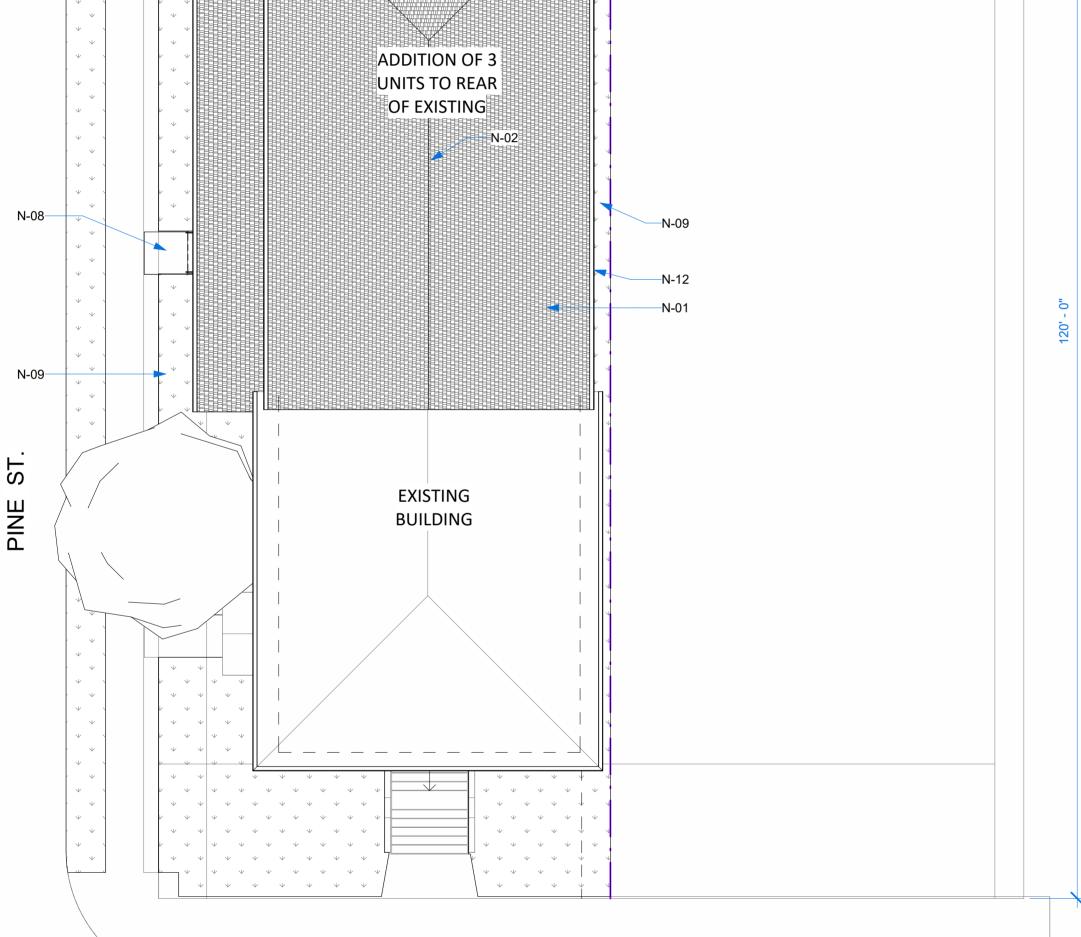

TOTAL LOT AREA: 4720 SF

ZIMPEL ST.

1600 SF. PERVIOUS / OPEN AT GRADE

SITE PLAN- PROPOSED - COVER 1" = 10'-0"

> **ZONING: HU-RD2 OVERLAY: LOWER NINTH WARD** REDEVELOPMENT INTERIUM ZONING DISTRICT

MIN. PERMIABLE AREA FRONT YARD SETBACK SIDE YARD SETBACK	REQ: 2,250 SF 30% AVG SURROUNDING (NONE) 3' 20% of lot depth or 15, whichever is less 1	COMPLIANCE: YES YES YES YES YES YES
--	---	---

Energy Code Compliance Summary IECC 2021 CLIMATE ZONE 2A FOR ORLEANS COMPLIANCE METHOD CHECK PRESCRIPTIVE N-01 EXISTING ROOF RECENTLY REPLACED. PROVIDE BATT INSULATION AT ATTIC CEILING AND CONDITION ATTIC AS (HTTP://WWW.ENERGYCODES.GOV/RESCHECK) COMCHECK (HTTP://WWW.ENERGYCODES.GOV/COMCHECK) **BUILDING AREA** VALUE CONNECTED TO ALUMINUM ENAMEL BAKED 4" CIRCULAR TOTAL AREA (SQ FT) OF CONDITIONED SPACE DOWNSPOUTS BELOW, TYP. FOR ALL INSTANCES. TYP. FOR ALL INSTANCES. PROVIDE SPLASH-BLOCK OR DOWNSPOUT ENTER R VALUE **INSULATION VALUES (R402)** CEILNG/ROOF AERITAS HERITAGE TONGUE AND GROOVE DECKING BASEMENT INSTALLED OVER DOUBLE SLEEPERS WHERE REQ'D (JOIST FLOOR DROPPED 3", RE: STRUCT.) SLOPE NEW DECKING TO DRAIN (1/4 OVER 1' MIN.) PROVIDÉ ICE AND WATER SHIELD AND CRAWLSPACE HEATING EQUIPMENT EFFICIENCY (BTU'S/RATING) TBD. SEE GENERAL NOTE 1 BELOW. TBD. SEE GENERAL NOTE 1 BELOW. COOLING EQUIPMENT EFFICIENCY (BTU/SEER)

TBD. SEE GENERAL NOTE 1 BELOW.

FENESTRATION U VALUE

FENESTRATION SHGC

.25 MAX.

SKYLIGHT U VALUE

GREATER THAN OF EQUAL TO 10 HSPF/16 SEER AIR SOURCE HEAT PUMP GREATER THAN OR EQUAL TO 3.5 COP GROUND SOURCE HEAT PUMP

U-VALUE

SHGC

U-VALUE

EXISTING MULTI FAMILY BUILDING

CONVERTED INTO SMFA AFFORDABLE 4-FRONT FACADE TO REMAIN. NEW MEP **THROUGHTOUT**

ADDITION / STRUCTURAL RENO

SFM, LEVEL OF ALTERATION

LEVEL 4

JAMES SPALT 7229 ZIMPLE ST **NEW ORLEANS LA 70118**

JS@NDVRPARTNERS.COM **ZACH SMITH CONSULTING & DESIGN**

1000 S NORMAN C FRANCIS PKWY NEW ORLEANS, LA 70125 504-383-3748 ZACH@ZACHSMITHCONSULTING.COM

MEP ENGINEER

STRUCTURAL/CIVIL ENGINEER AP DESIGN GROUP JOSHUA JUNEAU, PE

504-410-5322 JJUNEAU@AP-ENG.COM

• RESIDENTIAL STR IZD

UNIVERSITY AREA OFF-STREET PARKING OVERLAY DISTRICT

HDLC DISTRICT: NOHDLC UPTOWN PARTIAL

PROPOSED DEVELOPMENT: NEW LOT B DIMENSIONS: 47' X 120'

CONSTRUCTION TYPE: IBC/IFC: NFPA: COMMON TERMINOLOGY: TYPE V-A V (000) PROTECTED COMBUSTIBLE

OCCUPANCY TYPE:

IBC: RESIDENTIAL (R-2) NFPA: RESIDENTIAL, GROSS SF: 5863 (INCLUDING UNDER HOUSE STORAGE)

SPRINKLERED / FIRE ALARM: YES / YES

APPLICABLE CODES:

• 2021 IBC WITH NEW ORLEANS CODE ADOPTIONS

(BUILDINGS, STRUCTURES, APPURTENANCES AND PARTS THEREOF BE DESIGNED TO WITHSTAND A BASIC (NOMINAL) WIND SPEED OF 130 MPH, EXPOSURE B, IN ACCORDANCE WITH 2021 IBC, SECTION 1609)

• 2021 INTERNATIONAL MECHANICAL CODE

• 2021 LOUISIANA STATE PLUMBING CODE

• NFPA 70, 2020 NATIONAL ELECTRIC CODE 2021 INTERNATIONAL FUEL CODE

 2021 INTERNATIONAL ENERGY CONSERVATION CODE • 2021 INTERNATIONAL EXISTING BUILDING CODE

PROJECT INFORMATION

- THE GENERAL CONTRACTOR IS RESPONSIBLE TO SUPPLY ALL SUBCONTRACTORS WITH CONSTRUCTION DRAWINGS AND SPECIFICATIONS NECESSARY TO BID AND/OR CONSTRUCT THIS PROJECT.
- TO THE GENERAL CONTRACTOR AND ALL SUBCONTRACTORS: ALL CONTRACTORS ARE RESPONSIBLE TO NOTIFY THE ARCHITECT OF ANY ERRORS, OMISSIONS OR DISCREPANCIES PRIOR TO MAKING ANY CHANGES TO THE CONSTRUCTION DOCUMENTS.
- ALL DIMENSIONS ON THE FLOOR PLANS, UNLESS OTHERWISE NOTED, ARE TAKEN FROM INSIDE FACE OF STUDS OF EXTERIOR WALLS, CENTER OF STUDS OF NEW INTERIOR PARTITIONS, FACES OR CENTERLINE OF STRUCTURAL COLUMNS, AND FACES OF EXISTING WALLS.
- IN ACCORDANCE WITH GENERALLY ACCEPTED CONSTRUCTION PRACTICES, THE CONTRACTOR WILL BE SOLELY AND COMPLETELY RESPONSIBLE FOR CONDITIONS OF THE JOB SITE, INCLUDING SAFETY OF ALL PERSONS AND PROPERTY DURING PERFORMANCE OF WORK. THIS REQUIREMENT WILL APPLY CONTINUOUSLY AND NOT BE LIMITED TO NORMAL WORKING HOURS. THE CONTRACTOR SHALL TAKE ALL NECESSARY PRECAUTIONS TO INSURE THE SAFETY OF THE PUBLIC AND/OR WORK PERSONS ON THE JOB TO PREVENT ACCIDENTS OR INJURY TO ANY PERSON ON, ABOUT OR ADJACENT TO THE PREMISES. THE CONTRACTOR SHALL COMPLY WITH ALL LAWS, ORDINANCES, CODES, RULES AND
- REGULATIONS RELATIVE TO SAFETY AND THE PREVENTION OF ACCIDENTS. WHETHER OR NOT SPECIFICALLY INDICATED ON THE DRAWINGS, ALL CONTRACTORS SHALL BE RESPONSIBLE FOR REMOVING OR DEMOLISHING EXISTING CONSTRUCTION (INCLUDING UTILITIES) WHICH WILL INTERFERE WITH NEW
- PRIOR TO THE SHUT-DOWN OR TYING INTO ANY UTILITY, APPROVAL SHALL BE OBTAINED FROM THE OWNER'S
- REPRESENTATIVE. COORDINATE WITH OWNER'S REPRESENTATIVE THE LOCATION OF CONTRACTOR'S EQUIPMENT AND MATERIAL
- THE CONSTRUCTION DRAWINGS CONTAIN INFORMATION FOR MULTIPLE CONTRACTORS. OWNER PROVIDED AND INSTALLED ITEMS ARE SHOWN FOR INFORMATIVE PURPOSES. THE GENERAL CONTRACTOR SHALL VERIFY OWNER PROVIDED AND INSTALLED ITEMS AND COORDINATE INSTALLATION WITH OWNER'S REPRESENTATIVE TO AVOID CONFLICTS OR DISCREPANCIES.
- CONTRACTOR SHALL PROVIDE AND INSTALL ALL MATERIALS IN ACCORDANCE WITH ALL LOCAL, STATE, AND FEDERAL
- ALL PERMIT FEES SHALL BE PAID BY CONTRACTOR.
- CONTRACTOR SHALL BE RESPONSIBLE FOR AND PAY FOR ALL UTILITY DEPOSITS, IMPACT FEES AND CONNECTION

TITLE SHEET

Description

PROJECT STATUS

GENERAL NOTES - PROJECT

OAK ST.

3' - 0"

43' - 0"

NEW LOT B

47' - 0"

NEW LOT A

5' - 0"


DEMO AT SIDES AND REAR 300 SF (RIGHT) 550 (REAR) 600 (LEFT)

3192 SF TOTAL SF (SIDES AND REAR) 1450 TOTAL DEMO (45%) - NOT TO EXCEED 49%

OAK ST.

LESS THAN 50% DEMO AT ROOF

982 SF DEMOLISHED OF 2617 (37%)

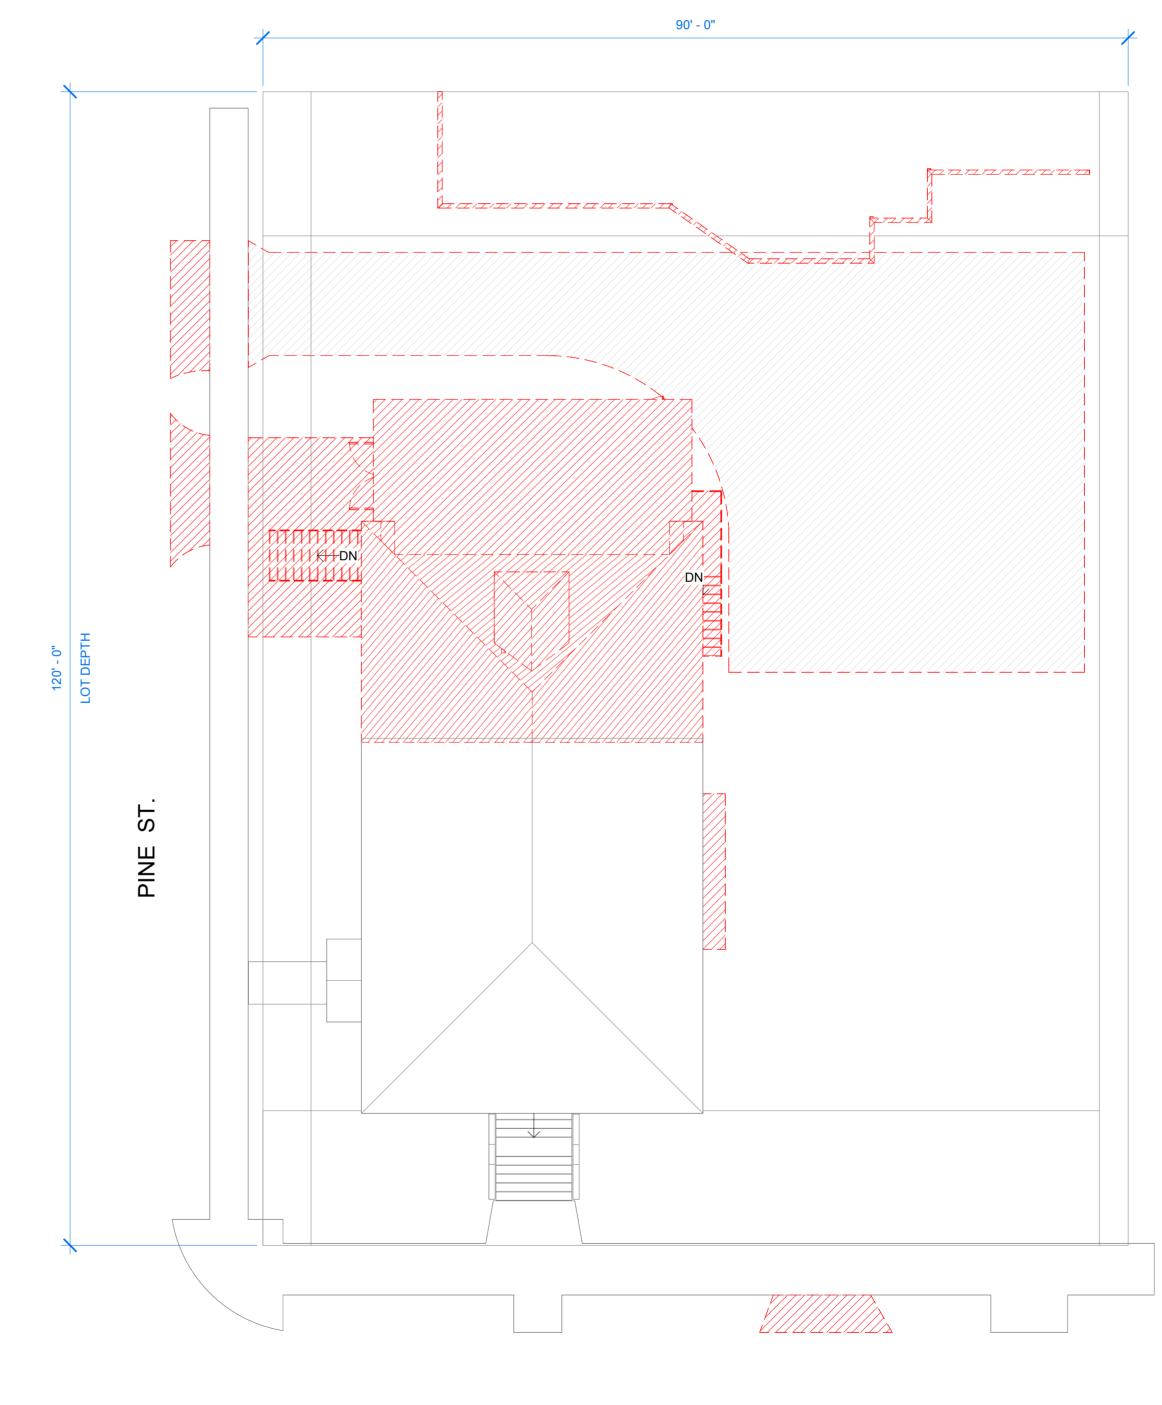

SITE PLAN - EXIST & PROPOSED

CORNER-SIDE YARD SIDE YARD\ ADDITION OF 3 UNITS TO REAR OF EXISTING N-02 BUILDING · • • • •

SITE PLAN- EXISTING 1" = 10'-0"

TOTAL LOT AREA: 4720 SF 1600 SF. PERVIOUS / OPEN AT GRADE ZIMPEL ST. SITE PLAN- PROPOSED 1" = 10'-0"

ZIMPEL ST.

PROJECT STATUS

A1.1

Description

FLOOR PLANS -EXISTING/DEMO

PROJECT STATUS

A2.1


DEMO AT SIDES AND REAR 300 SF (RIGHT) 600 (LEFT)

3192 SF TOTAL SF (SIDES AND REAR) 1450 TOTAL DEMO (45%) - NOT TO EXCEED 49%

> LESS THAN 50% DEMO AT ROOF 982 SF DEMOLISHED OF 2617 (37%)

- CONTRACTOR TO VERIFY, BEFORE DEMOLITION, ANY EXISTING MECHANICAL OR ELECTRICAL SYSTEMS IN EXISTING WALLS TO BE DEMOLISHED AS REQUIRED IN DRAWINGS AND VERIFY THROUGH ULTRASOUND TESTING ALL EXISTING SLAB CONDITIONS IN THESE AREAS. CONTRACTOR TO COORDINATE COURSE OF ACTION WITH OWNER AND ARCHITECT IN FIELD. CLOSE, CAP, AND DISCONNECT CONNECTION TO EXISTING SERVICE AS REQUIRED. REFER TO MECHANICAL, PLUMBING, AND ELECTRICAL DRAWINGS. REFER TO MEP DEMOLITION SHEETS FOR ADDITIONAL INFORMATION.
- CONTRACTOR RESPONSIBLE FOR DEMOLITION OF INDICATED WALLS & ASSOCIATED MATERIALS.
- CONTRACTOR TO BRACE EXISTING FRAMING AND STRUCTURE AS REQUIRED TO MAINTAIN STRUCTURAL INTEGRITY OF EXISTING AND TO PREVENT COLLAPSE DURING CONSTRUCTION. PROTECT EXISTING FRAMING AND MATERIALS AS NEEDED DURING CONSTRUCTION. CONTRACTOR RESPONSIBLE FOR ALL MEANS AND METHODS OR BRACING. COORDIANTE WITH ENGINEER AS NEEDED FOR SPECIAL BRACING CONDITIONS THAT MIGHT BE NECESSARY DURING DEMO/CONSTRUCTION.
- WHETHER OR NOT IT IS SPECIFICALLY INDICATED ON THE DRAWINGS, THE CONTRACTOR SHALL REMOVE AND DEMOLISH ALL EXISTING CONSTRUCTION, INCLUDING UTILITIES, WHICH WILL INTERFERE WITH NEW WORK. CONTRACTOR WILL COORDINATE SAFETY PRECAUTIONS WITH BUILDING
- ALL EXISTING CONDITIONS. THE GENERAL CONTRACTOR IS RESPONSIBLE FOR WALKING THROUGH AND ADVISING THE ARCHITECT OF READILY APPARENT DISCREPANCIES OR CONDITIONS WHICH
- CONTRACTOR TO COORDINATE LOCATION OF DUMPSTERS WITH THE OWNER. PRIOR TO SHUT DOWN OR TYING INTO ANY UTILITY, APPROVAL SHALL BE OBTAINED FROM THE BUILDING REPRESENTATIVE
- SOLELY AND COMPLETELY RESPONSIBLE FOR CONDITIONS OF THE JOB SITE, INCLUDING SAFETY OF ALL PERSONS AND PROPERTY DURING PERFORMANCE OF WORK. THIS REQUIREMENT APPLIES CONTINUOUSLY AND WILL NOT BE LIMITED TO NORMAL WORKING HOURS. THE CONTRACTOR SHALL ON THE JOB AND TO PREVENT ACCIDENTS OR INJURY TO ANY PERSONS ON, ABOUT OR ADJACENT TO THE PREMISES. THE CONTRACTOR SHALL COMPLY WITH ALL LAWS, ORDINANCES, CODES, RULES, AND REGULATIONS RELATIVE TO SAFETY AND THE PREVENTION OF ACCIDENTS. CONTRACTOR SHALL COORDINATE SAFETY PRECAUTIONS WITH BUILDING REPRESENTATIVE.

1/8" = 1'-0"

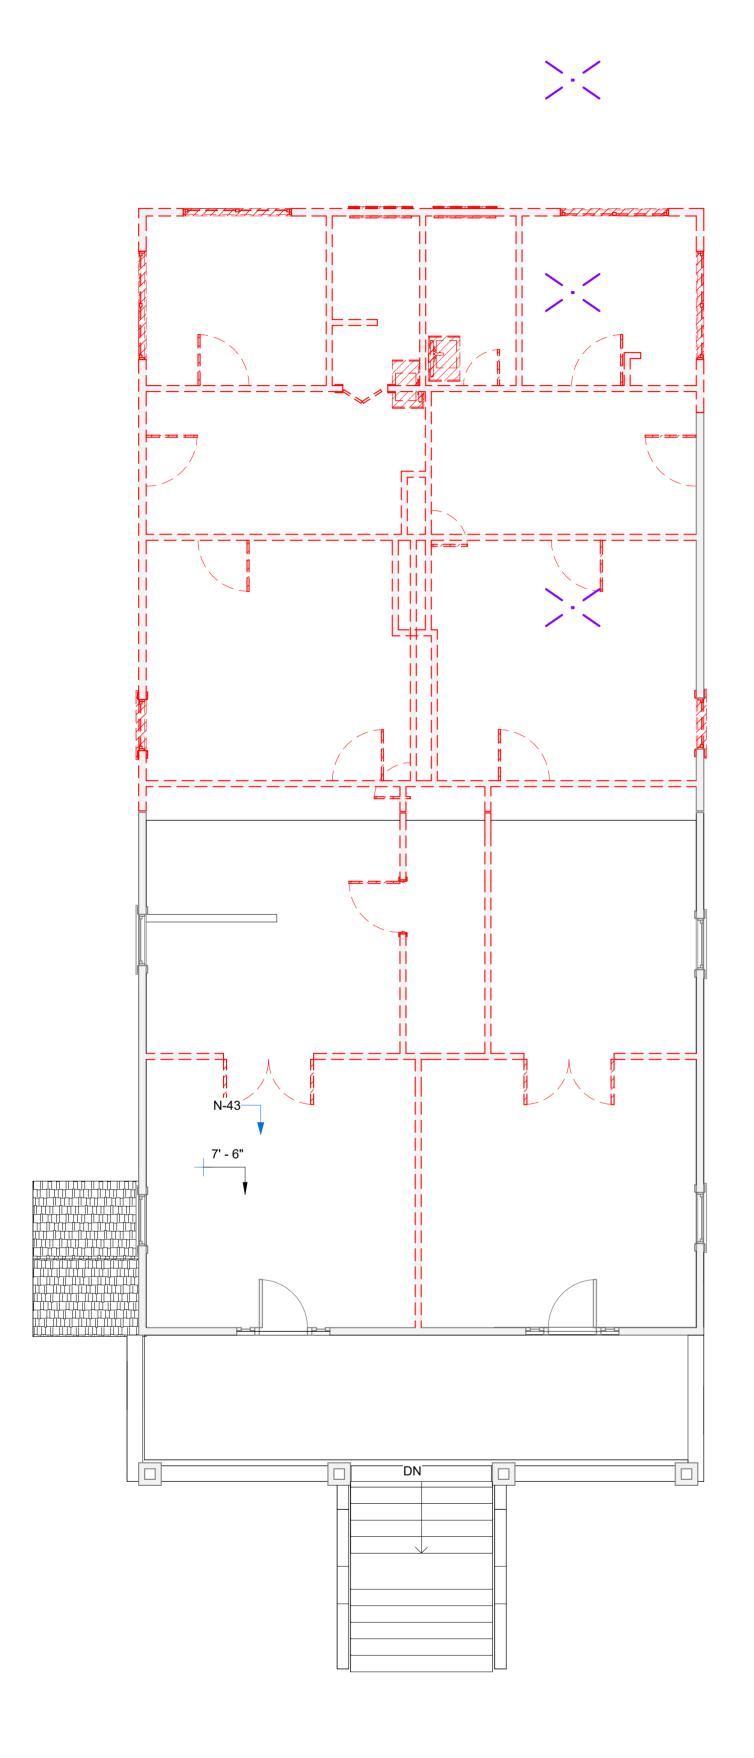

2ND FLOOR

2 | 2ND FLOOR PLAN - EXISTING/DEMO 3/16" = 1'-0"

1ST FLOOR

5' - 0"

7' - 6"

1 | 1ST FLOOR_PLAN - EXISTING/DEMO 3/16" = 1'-0"

30' - 11 1/4"

STORAGE = 1,076 SF

ADVERSELY AFFECT CONSTRUCTABILITY OF THE WORK.

CONTRACTOR TO REPAIR AS REQUIRED ALL AFFECTED ADJOINING AREAS TO MATCH NEW

IN ACCORDANCE WITH GENERALLY ACCEPTED CONSTRUCTION PRACTICES, THE CONTRACTOR WILL BE

GENERAL NOTES - DEMO

4 UNITS

2X 3 BED / 2.5 NATH @ 1215 SF INTERIOR

1X 3 BED / 2.5 BATH @ 1182 SF INTERIOR 1X 3BED / 2 BATH @ 865 SF

1076 EXISTING GROUND FLOOR STORAGE

1.1 SUMMARY: PROVIDE AND INSTALL KITCHEN APPLIANCES AS SPECIFIED AND SHOWN ON THE

1.2 SUBMITTALS: SUBMIT PRODUCT DATA SHEETS FOR EACH APPLIANCE, INCLUDING MANUFACTURER, MODEL NUMBER, AND PERFORMANCE SPECIFICATIONS. PROVIDE INSTALLATION INSTRUCTIONS AND WARRANTY INFORMATION FOR OWNER APPROVAL PRIOR TO PURCHASING.

1.3 QUALITY ASSURANCE: APPLIANCES TO BE FROM MANUFACTURERS WITH A MINIMUM OF 5 YEARS OF INDUSTRY EXPERIENCE AND POSITIVE REVIEWS. ENSURE APPLIANCES COMPLY WITH RELEVANT SAFETY AND ENERGY STAR® RATINGS.

ENERGY EFFICIENCY: ALL APPLIANCES TO MEET OR EXCEED [INSERT SPECIFIC ENERGY EFFICIENCY STANDARDS, E.G., ENERGY STAR®] TO MINIMIZE ENERGY CONSUMPTION AND OPERATIONAL COSTS. DURABILITY: APPLIANCES TO BE CONSTRUCTED OF HIGH-QUALITY MATERIALS FOR LONG-TERM RELIABILITY AND RESISTANCE TO TYPICAL WEAR AND TEAR.

NOISE LEVELS: APPLIANCES TO OPERATE WITHIN ACCEPTABLE NOISE LEVELS, ENSURING MINIMAL DISTURBANCE IN APARTMENT SETTINGS. [INSERT SPECIFIC NOISE LEVELS IF APPLICABLE, E.G.,

EASE OF USE: APPLIANCES TO FEATURE USER-FRIENDLY CONTROLS AND INTERFACES, ENSURING

3.1 INSTALLATION: INSTALL APPLIANCES ACCORDING TO MANUFACTURERS INSTRUCTIONS AN LOCAL CODES. VERIFY PROPER OPERATION AND ADJUST SETTINGS AS NEEDED. ALL POWER/WATER CONNECTORS TO BE PROVIDED.

BATHROOM FAUCET: B.O.D. MOEN DOUBLE HANDLE CENTERSET BATHROOM FAUCET FROM THE BRANTFORD COLLECTION (VALVE INCLUDED). MODEL: 66610 & SINK BASE BOD: 30 IN. W X 19 IN. D X 33 IN. H SINGLE SINK FREESTANDING BATH VANITY IN PEARL GRAY WITH WHITE CULTURED MARBLE TOP

WATER CLOSET - B.O.D. GLACIER BAY, 12 INCH ROUGH IN TWO-PIECE 1.28 GPF SINGLE FLUSH

REFIGERATOR: B.O.D. LG, 30 IN. W 20 CU. FT. TOP FREEZER REFRIGERATOR W/ MULTI-AIR FLOW AND REVERSIBLE DOOR IN STAINLESS STEEL,ENERGY STAR

REFIFERATOR: B.O.D. FRIGIDAIRE, 30 IN. 5 BURNER ELEMENT FREESTANDING ELECTRIC RANGE IN

RANGE: B.O.D. GE 30 IN. 4 BURNER ELEMENT FREE-STANDING ELECTRIC RANGE IN STAINLESS STEEL

CABINETS: B.O.D. PAINTED WOOD WITH A MINIMUM THICKNESS OF ¾ INCH FOR DOORS AND ½ INCH

SHOWER: CUSTOM BUILT SHOWER SURROUND. SCHLUTER-SHOWER SYSTEM WITH CEMENT BOARD 10) SURROUND CLAD IN SUBWAY TILE. FACUET: B.O.D. DELTA FOUNDATIONS SINGLE-HANDLE 1-SPRAY SHOWER FAUCET IN CHROME (VALVE INCLUDED). PROVIDE 5/16 IN. TEMPERED GLASS SHOWER DOOR,

(5) KITCHEN SINK: STANDARD 30" SINGLE BOWL UNDERMOUNT KITCHEN SINK. STAINLESS STEEL.

MICROWAVE: B.O.D. GE, 1.6 CU. FT. OVER-THE-RANGE MICROWAVE IN STAINLESS STEEL. RE-CIRCULATING VENT CONFIGURATION.

(3) COUNTERTOP - 2CM GRANITE W/BACKSPLASH, OWNER TO CHOOSE COLOR

9 FOR CABINET BOXES. SOFT CLOSERS AND HARDWARE INCLUDED.

PRODUCT BASIS OF DESIGN (B.O.D.) SELECTIONS

3.2 TESTING: TEST ALL APPLIANCES TO ENSURE THEY ARE OPERATING CORRECTLY AND

4477 SF LIVING TOTAL (INTERIOR)

250 SF EXISTING FRONT PORCH

SECTION 114000 - KITCHEN APPLIANCES

2.1 PERFORMANCE CRITERIA:

DISHWASHERS ≤ 50 DBA]

EFFICIENTLY.

60 SF NEW PORCHES + REAR DECK

2. PRODUCTS: SEE INDIVIDUAL KEY NOTES FOR PRODUCTS

EASE OF OPERATION FOR ALL RESIDENTS.

ELONGATED TOILET IN WHITE SEAT INCLUDED

BLACK WITH EVENTEMP AND STEAM CLEAN

2nd


/ RENOVATION St. 701

Description



FLOOR PLANS -PROPOSED

PROJECT STATUS

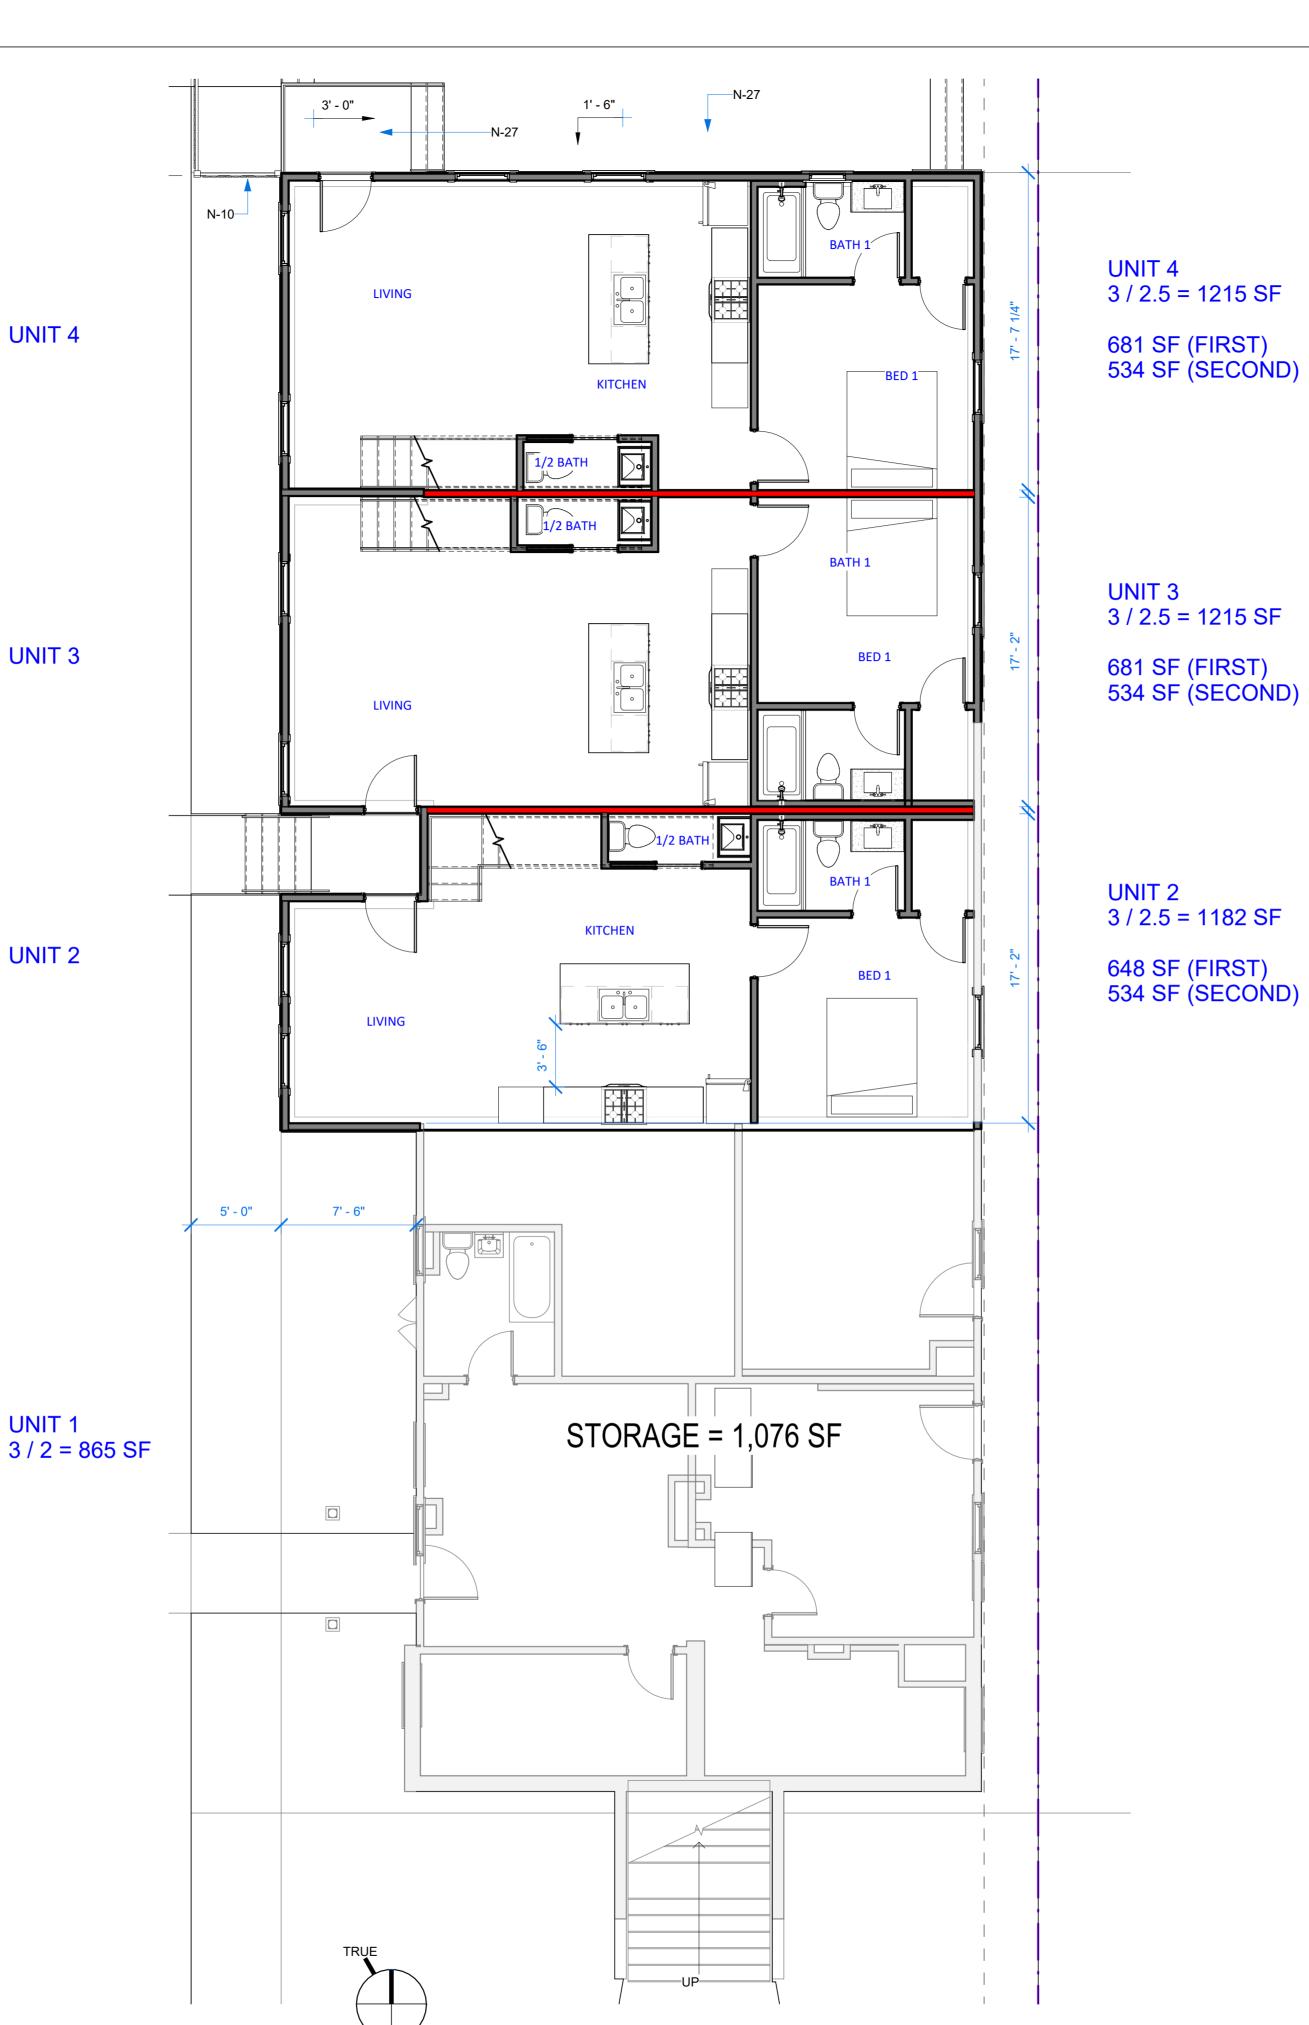

2ND FLOOR 2808 GROSS SF

2 | 2ND FLOOR PLAN | 3/16" = 1'-0"

BED 3

BED 3

7' - 6"

KITCHEN

UNIT 4

UNIT 3

UNIT 2

BED 2

1ST FLOOR 3225 GROSS SF

1 ST FLOOR_PLAN 3/16" = 1'-0"

1 A3.1 KEY PLAN - ELEVATION - DEMO

ROOF 30' - 0"

2ND FLOOR CLG. 17' - 9"

2ND FLOOR BFE 13' - 0"_G. BFE 12' - 0"

2ND FLOOR 1ST FLOOR CLG. 6' - 6"

DEMO AT SIDES AND REAR 300 SF (RIGHT) 550 (REAR) 600 (LEFT)

KEYNOTES - SHEET Keynote Text

3192 SF TOTAL SF (SIDES AND REAR) 1450 TOTAL DEMO (45%) - NOT TO EXCEED 49%


> LESS THAN 50% DEMO AT ROOF 982 SF DEMOLISHED OF 2617 (37%)

229 Zimpel St. Orleans LA, 70118

ADDITION / RENOVATION

300 SQ FT DEMO (1321 SQ FT. FACADE TOTAL) - 23%

1 EAST ELEVATION - DEMO 3/16" = 1'-0"

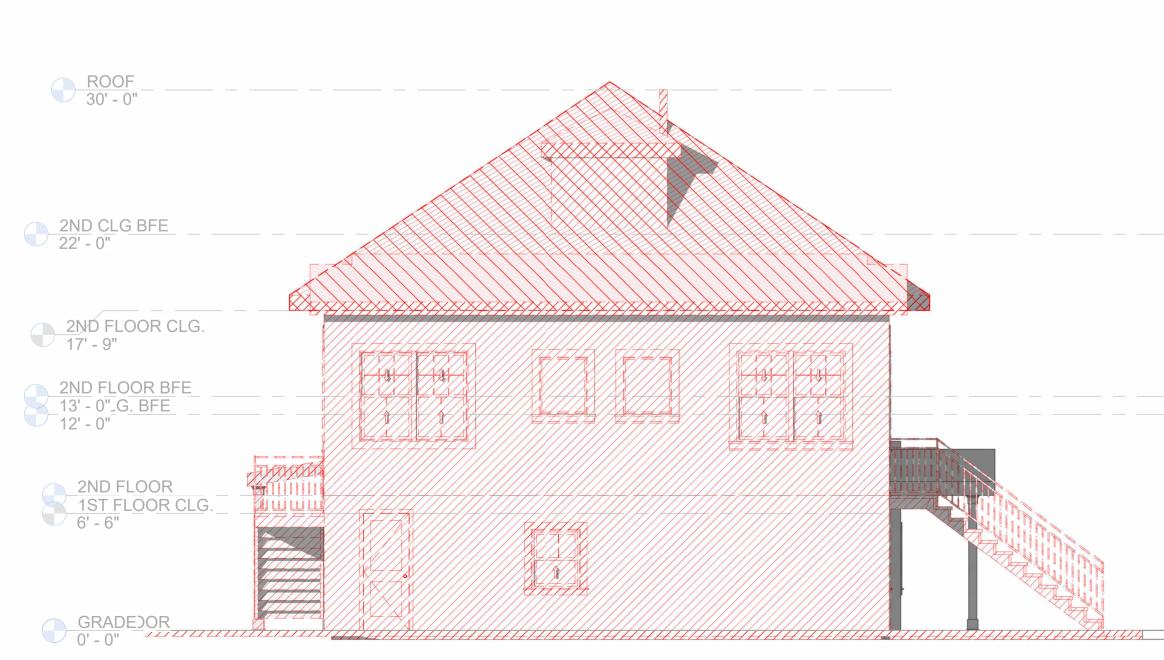


550 SQ FT DEMO (550 SQ FT. FACADE TOTAL) - 100%

2 | NORTH ELEVATION - DEMO 3/16" = 1'-0"

NO DEMO AT FRONT FACADE (0%)

3 | SOUTH ELEVATION - DEMO 3/16" = 1'-0"

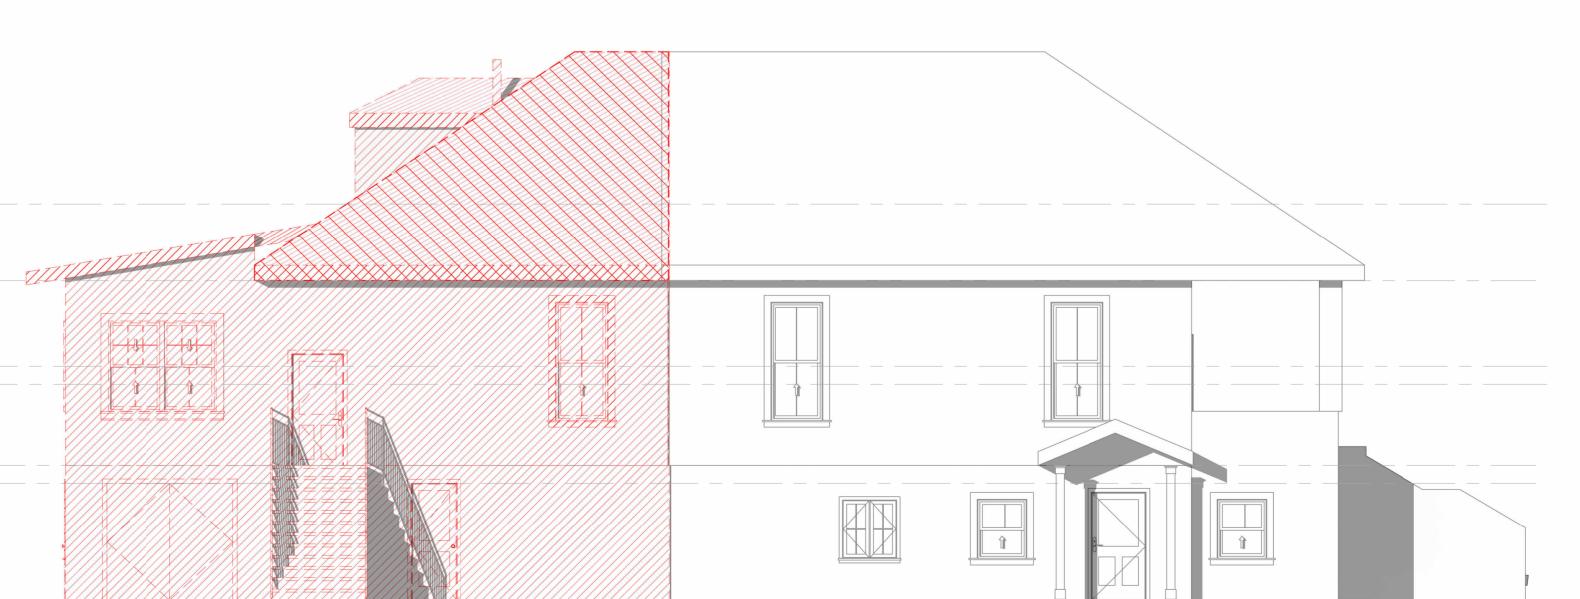

600 SQ FT DEMO (1321 SQ FT. FACADE TOTAL)

4 | WEST ELEVATION - DEMO 3/16" = 1'-0"

A3.1

EXTERIOR

ELEVATIONS -EXISTING/DEMO

PROJECT STATUS



OPTION 2

Design Advisory Committee (March 19, 2025)

The applicant summarized the three modifications that were made: 1) removal of porch, 2) relocation of entry to the rear to read like a side elevation, and 3) shifting of addition back 3 feet. The applicant stated opposition to the suggestion that the addition be made flush with the existing building. There was one comment in opposition from Susan Johnson who relayed opposition from 17 neighbors and expressed concerns about affordable rentals, increased parking demand, and concerns about the addition of 24 bedrooms. The applicant rebutted addressing a commitment to meet affordable rental requirements.

The HDLC representative took issue with the applicant's stated inability to make the addition flush. It was further stated that the changes to the side elevation are an improvement, however, it is still too large.

The CPC representative stated that they would not be supporting the proposed design as it is incompatible with the University Area Design overlay. They stated that the scale and massing is atypical relative to surrounding historic structures. The two-story addition is fundamentally incompatible with the existing structure, causing the misalignment of architectural features.

The CPC representative made a motion for DENIAL, that was seconded by the HDLC representative and unanimously adopted.

CPC DRAWINGS

SMFA 4PLEX - ADDITION / RENOVATION

7229 Zimpel St. New Orleans LA, 70118

OAK ST.

EXISTING

BUILDING

ZIMPEL ST.

SITE PLAN- PROPOSED - COVER

1" = 10'-0"

V V V · • • • •

v v v v

43' - 0"



		SHEET LIST			
Sheet lumber	Sheet Name	Sheet Issue Date	Current Revision	Current Revision Date	Current Revision Description
RCHITE	CTURAL				
1.1	SITE PLAN - EXIST & PROPOSED	1.28.2025			
2.1	FLOOR PLANS - EXISTING/DEMO	1.28.2025			
2.2	FLOOR PLANS - PROPOSED	1.28.2025			
3.1	EXTERIOR ELEVATIONS - EXISTING/DEMO	1.28.2025			
3.2	EXTERIOR ELEVATIONS - PROPOSED	1.28.2025			
TLE		'	•		
1.1	TITLE SHEET	01/16/25			
RCHITE	CTURE				
SK-1	PRESENTATION PLANS	01/16/25			
			•		

• RESIDENTIAL STR IZD

PROPOSED DEVELOPMENT:

CONSTRUCTION TYPE:

OCCUPANCY TYPE:

APPLICABLE CODES:

STORAGE)

YES / YES

IBC: RESIDENTIAL (R-2)

SPRINKLERED / FIRE ALARM:

ZONING DISTRICT: HU-RD2 HISTORIC URBAN TWO-FAMILY RESIDENTIAL

UNIVERSITY AREA OFF-STREET PARKING OVERLAY DISTRICT

NFPA: RESIDENTIAL, GROSS SF: 5863 (INCLUDING UNDER HOUSE

EXPOSURE B, IN ACCORDANCE WITH 2021 IBC, SECTION 1609)

(BUILDINGS, STRUCTURES, APPURTENANCES AND PARTS THEREOF BE DESIGNED TO WITHSTAND A BASIC (NOMINAL) WIND SPEED OF 130 MPH,

HDLC DISTRICT: NOHDLC UPTOWN PARTIAL

IBC/IFC: NFPA: COMMON TERMINOLOGY:

TYPE V-A V (000) PROTECTED COMBUSTIBLE

• 2021 IBC WITH NEW ORLEANS CODE ADOPTIONS

• 2021 INTERNATIONAL ENERGY CONSERVATION CODE 2021 INTERNATIONAL EXISTING BUILDING CODE

• 2021 INTERNATIONAL MECHANICAL CODE

• NFPA 70, 2020 NATIONAL ELECTRIC CODE

• 2021 LOUISIANA STATE PLUMBING CODE

2021 INTERNATIONAL FUEL CODE


NEW LOT B DIMENSIONS: 47' X 120'

No.	Description	
		_
	/	

TITLE SHEET

PROJECT STATUS

01/16/25

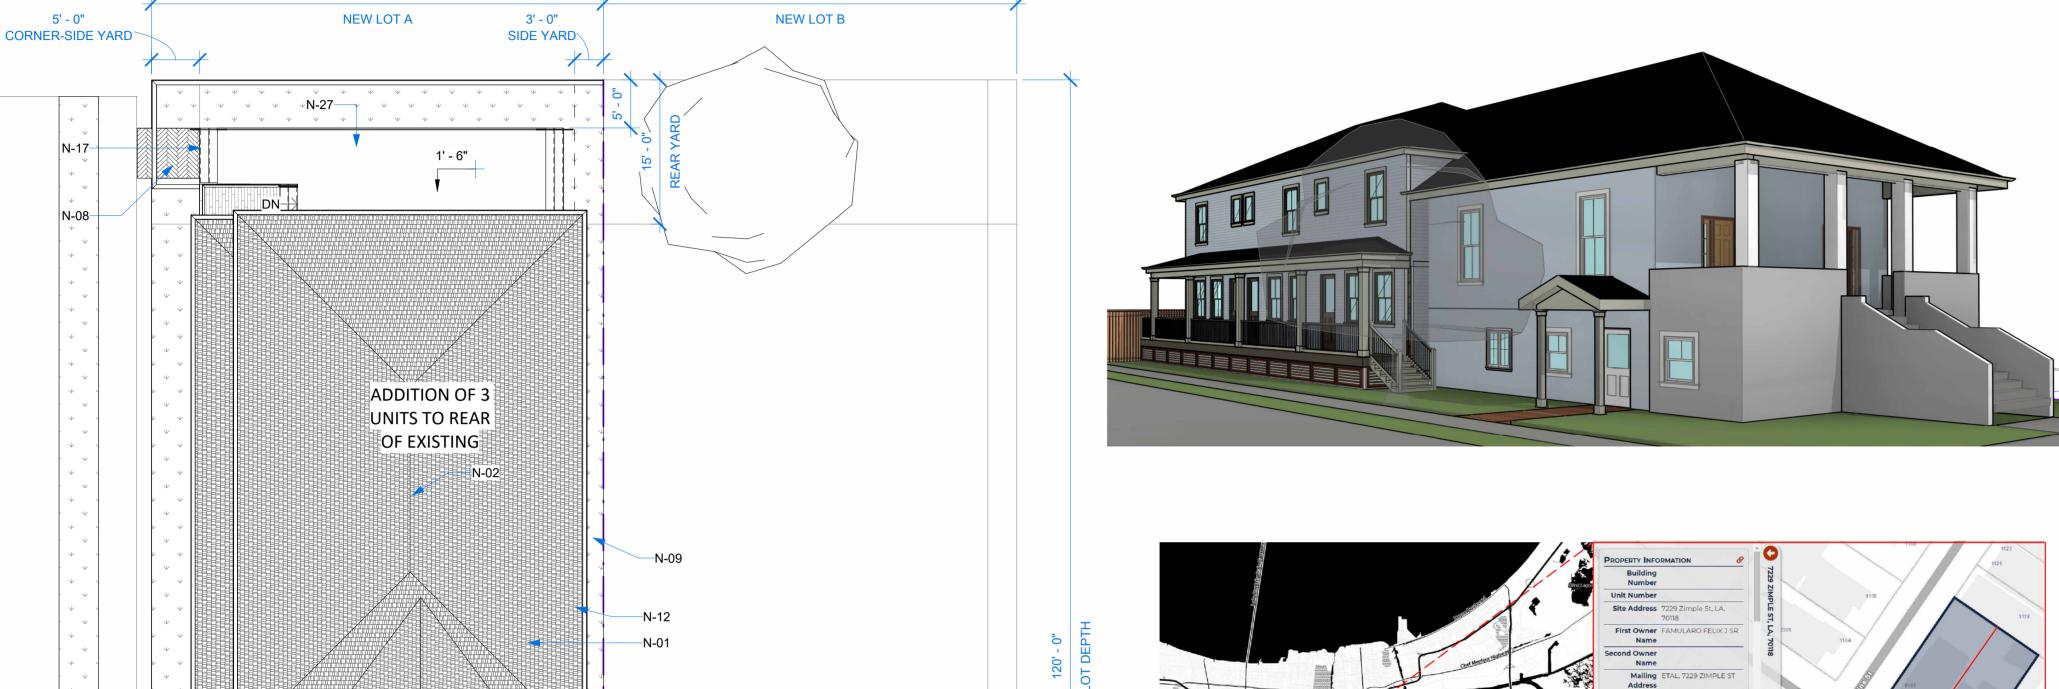

	KEYNOTES - SHEET			
Key Value	Keynote Text			
N-01	EXISTING ROOF RECENTLY REPLACED. PROVIDE BATT INSULATION AT ATTIC CEILING AND CONDITION ATTIC AS REQ'D FOR IECC REQUIREMENTS. RE: MEP.			
N-02	RIDGE VENT AT ROOF, TYP.			
N-08	NEW PERVIOUS PAVERS THIS LOCATION			
N-09	NEW GRADING/SOD AS REQ'D.			
N-12	6" ALUMINUM BAKED HALF ROUND STYLE GUTTERS CONNECTED TO ALUMINUM ENAMEL BAKED 4" CIRCULAR DOWNSPOUTS BELOW, TYP. FOR ALL INSTANCES. TYP. FOI ALL INSTANCES. PROVIDE SPLASH-BLOCK OR DOWNSPOU' BOOT AS REQ'D.			
N-17	EXTERIOR WD. STAIR TO MATCH WD. PORCH/DECK. TREATED FRAMING, TYP. RE: DETAILS / STRUCT.			
N-27	AERITAS HERITAGE TONGUE AND GROOVE DECKING INSTALLED OVER DOUBLE SLEEPERS WHERE REQ'D (JOIST DROPPED 3", RE: STRUCT.) SLOPE NEW DECKING TO DRAIN (1/4 OVER 1' MIN.) PROVIDE ICE AND WATER SHIELD AND FLASHING AS REQ'D. RE: DETAILS			

	PARISH	1000 S NORMAN C FRANCIS PKWY
COMPLIANCE METHOD	CHECK	NEW ORLEANS, LA 70125 504-383-3748
PRESCRIPTIVE	✓	ZACH@ZACHSMITHCONSULTING.COM
RESCHECK (HTTP://WWW.ENERGYCODES.GOV/RESCHECK)		MEP ENGINEER
COMCHECK (HTTP://WWW.ENERGYCODES.GOV/COMCHECK)		TBD
BUILDING AREA	VALUE	STRUCTURAL/CIVIL ENGINEER
TOTAL AREA (SQ FT) OF CONDITIONED SPACE	4477	AP DESIGN GROUP JOSHUA JUNEAU, PE 504-410-5322
INSULATION VALUES (R402)	ENTER R VALUE	JJUNEAU@AP-ENG.COM
CEILNG/ROOF	R-38	
WALLS	R-13	
BASEMENT	/ N/A	
FLOOR	/ R-13	
SLAB	/ N/A	PROJECT INFORMATION
CRAWLSPACE	/ N/A	
HEATING EQUIPMENT	EFFICIENCY (BTU'S/RATING)	1. THE GENERAL CONTRACTOR IS RE
ELECTRIC TBD. SEE GENERAL NOTE 1 BELOW.	TBD. SEE GENERAL NOTE 1 BELOW.	AND SPECIFICATIONS NECESSARY
GAS TBD. SEE GENERAL NOTE 1 BELOW.	TBD. SEE GENERAL NOTE 1 BELOW.	 TO THE GENERAL CONTRACTOR A ARCHITECT OF ANY ERRORS, OMIS
COOLING EQUIPMENT	EFFICIENCY (BTU/SEER)	CONSTRUCTION DOCUMENTS.
TBD. SEE GENERAL NOTE 1 BELOW.	/ GREATER THAN OF EQUAL TO 10 HSPF/16 SEER AIR SOURCE HEAT PUMP GREATER THAN OR EQUAL TO 3.5 COP GROUND SOURCE HEAT PUMP	 ALL DIMENSIONS ON THE FLOOR P EXTERIOR WALLS, CENTER OF STU
FENESTRATION U VALUE	U-VALUE	COLUMNS, AND FACES OF EXISTIN
.40 MAX		4. IN ACCORDANCE WITH GENERALL' COMPLETELY RESPONSIBLE FOR (
FENESTRATION SHGC	SHGC	DURING PERFORMANCE OF WORK WORKING HOURS. THE CONTRACT
.25 MAX.		PUBLIC AND/OR WORK PERSONS (
SKYLIGHT U VALUE	U-VALUE	ADJACENT TO THE PREMISES. THE REGULATIONS RELATIVE TO SAFE
N/A		5. WHETHER OR NOT SPECIFICALLY I

mation regarding A/C and Heating equipment and efficiency to be determined by sub-contractor according to Heat Load/Manual J calculations of prior to mechanical inspection.)

Energy Code Compliance Summary IECC 2021

AND SPECIFICATIONS NECESSARY TO BID AND/OR CONSTRUCT THIS PROJECT.

CLIMATE ZONE 2A FOR ORLEANS

2.	TO THE GENERAL CONTRACTOR AND ALL SUBCONTRACTORS: ALL CONTRACTORS ARE RESPONSIBLE TO NOTIFY THE
	ARCHITECT OF ANY ERRORS, OMISSIONS OR DISCREPANCIES PRIOR TO MAKING ANY CHANGES TO THE
	CONSTRUCTION DOCUMENTS.
3.	ALL DIMENSIONS ON THE FLOOR PLANS. UNLESS OTHERWISE NOTED. ARE TAKEN FROM INSIDE FACE OF STUDS OF

ACE OF STUDS OF EXTERIOR WALLS, CENTER OF STUDS OF NEW INTERIOR PARTITIONS, FACES OR CENTERLINE OF STRUCTURAL COLUMNS, AND FACES OF EXISTING WALLS.

IN ACCORDANCE WITH GENERALLY ACCEPTED CONSTRUCTION PRACTICES, THE CONTRACTOR WILL BE SOLELY AND COMPLETELY RESPONSIBLE FOR CONDITIONS OF THE JOB SITE, INCLUDING SAFETY OF ALL PERSONS AND PROPERTY DURING PERFORMANCE OF WORK. THIS REQUIREMENT WILL APPLY CONTINUOUSLY AND NOT BE LIMITED TO NORMAL WORKING HOURS. THE CONTRACTOR SHALL TAKE ALL NECESSARY PRECAUTIONS TO INSURE THE SAFETY OF THE PUBLIC AND/OR WORK PERSONS ON THE JOB TO PREVENT ACCIDENTS OR INJURY TO ANY PERSON ON, ABOUT OR ADJACENT TO THE PREMISES. THE CONTRACTOR SHALL COMPLY WITH ALL LAWS, ORDINANCES, CODES, RULES AND REGULATIONS RELATIVE TO SAFETY AND THE PREVENTION OF ACCIDENTS.

THE GENERAL CONTRACTOR IS RESPONSIBLE TO SUPPLY ALL SUBCONTRACTORS WITH CONSTRUCTION DRAWINGS

WHETHER OR NOT SPECIFICALLY INDICATED ON THE DRAWINGS, ALL CONTRACTORS SHALL BE RESPONSIBLE FOR REMOVING OR DEMOLISHING EXISTING CONSTRUCTION (INCLUDING UTILITIES) WHICH WILL INTERFERE WITH NEW

PRIOR TO THE SHUT-DOWN OR TYING INTO ANY UTILITY, APPROVAL SHALL BE OBTAINED FROM THE OWNER'S REPRESENTATIVE.

COORDINATE WITH OWNER'S REPRESENTATIVE THE LOCATION OF CONTRACTOR'S EQUIPMENT AND MATERIAL

THE CONSTRUCTION DRAWINGS CONTAIN INFORMATION FOR MULTIPLE CONTRACTORS. OWNER PROVIDED AND INSTALLED ITEMS ARE SHOWN FOR INFORMATIVE PURPOSES. THE GENERAL CONTRACTOR SHALL VERIFY OWNER PROVIDED AND INSTALLED ITEMS AND COORDINATE INSTALLATION WITH OWNER'S REPRESENTATIVE TO AVOID CONFLICTS OR DISCREPANCIES.

CONTRACTOR SHALL PROVIDE AND INSTALL ALL MATERIALS IN ACCORDANCE WITH ALL LOCAL, STATE, AND FEDERAL

ALL PERMIT FEES SHALL BE PAID BY CONTRACTOR.

CONTRACTOR SHALL BE RESPONSIBLE FOR AND PAY FOR ALL UTILITY DEPOSITS, IMPACT FEES AND CONNECTION

TOTAL LOT AREA: 4720 SF 1600 SF. PERVIOUS / OPEN AT GRADE (31%) NO CHANGES TO FRONT YARD PERMEABILITY: ETR OPEN AREA: 31% (1465 SF) ZONING: HU-RD2

OVERLAY: LOWER NINTH WARD REDEVELOPMENT INTERIUM ZONING DISTRICT

REQUIRMENTS: COMPLIANCE: MIN. LOT SIZE 2,250 SF MIN. PERMIABLE AREA FRONT YARD SETBACK AVG SURROUNDING (NONE) YES SIDE YARD SETBACK YES REAR YARD SETBACK 20% of lot depth or 15, whichever is YES PARKING*

ZONING HU-RD2

GENERAL NOTES - PROJECT

REQ:

EXISTING MULTI FAMILY BUILDING CONVERTED INTO SMFA AFFORDABLE 4-

ADDITION / STRUCTURAL RENO

SFM, LEVEL OF ALTERATION

THROUGHTOUT

LEVEL 4

JAMES SPALT

7229 ZIMPLE ST

NEW ORLEANS LA 70118

JS@NDVRPARTNERS.COM

ZACH SMITH CONSULTING & DESIGN

PLEX. 3 NEW UNITS ON REAR. LESS THAN

FRONT FACADE TO REMAIN. NEW MEP


OAK ST.

DEMO AT SIDES AND REAR 300 SF (RIGHT) 550 (REAR) 600 (LEFT)

3192 SF TOTAL SF (SIDES AND REAR) 1450 TOTAL DEMO (45%) - NOT TO EXCEED 49%

LESS THAN 50% DEMO AT ROOF

982 SF DEMOLISHED OF 2617 (37%)

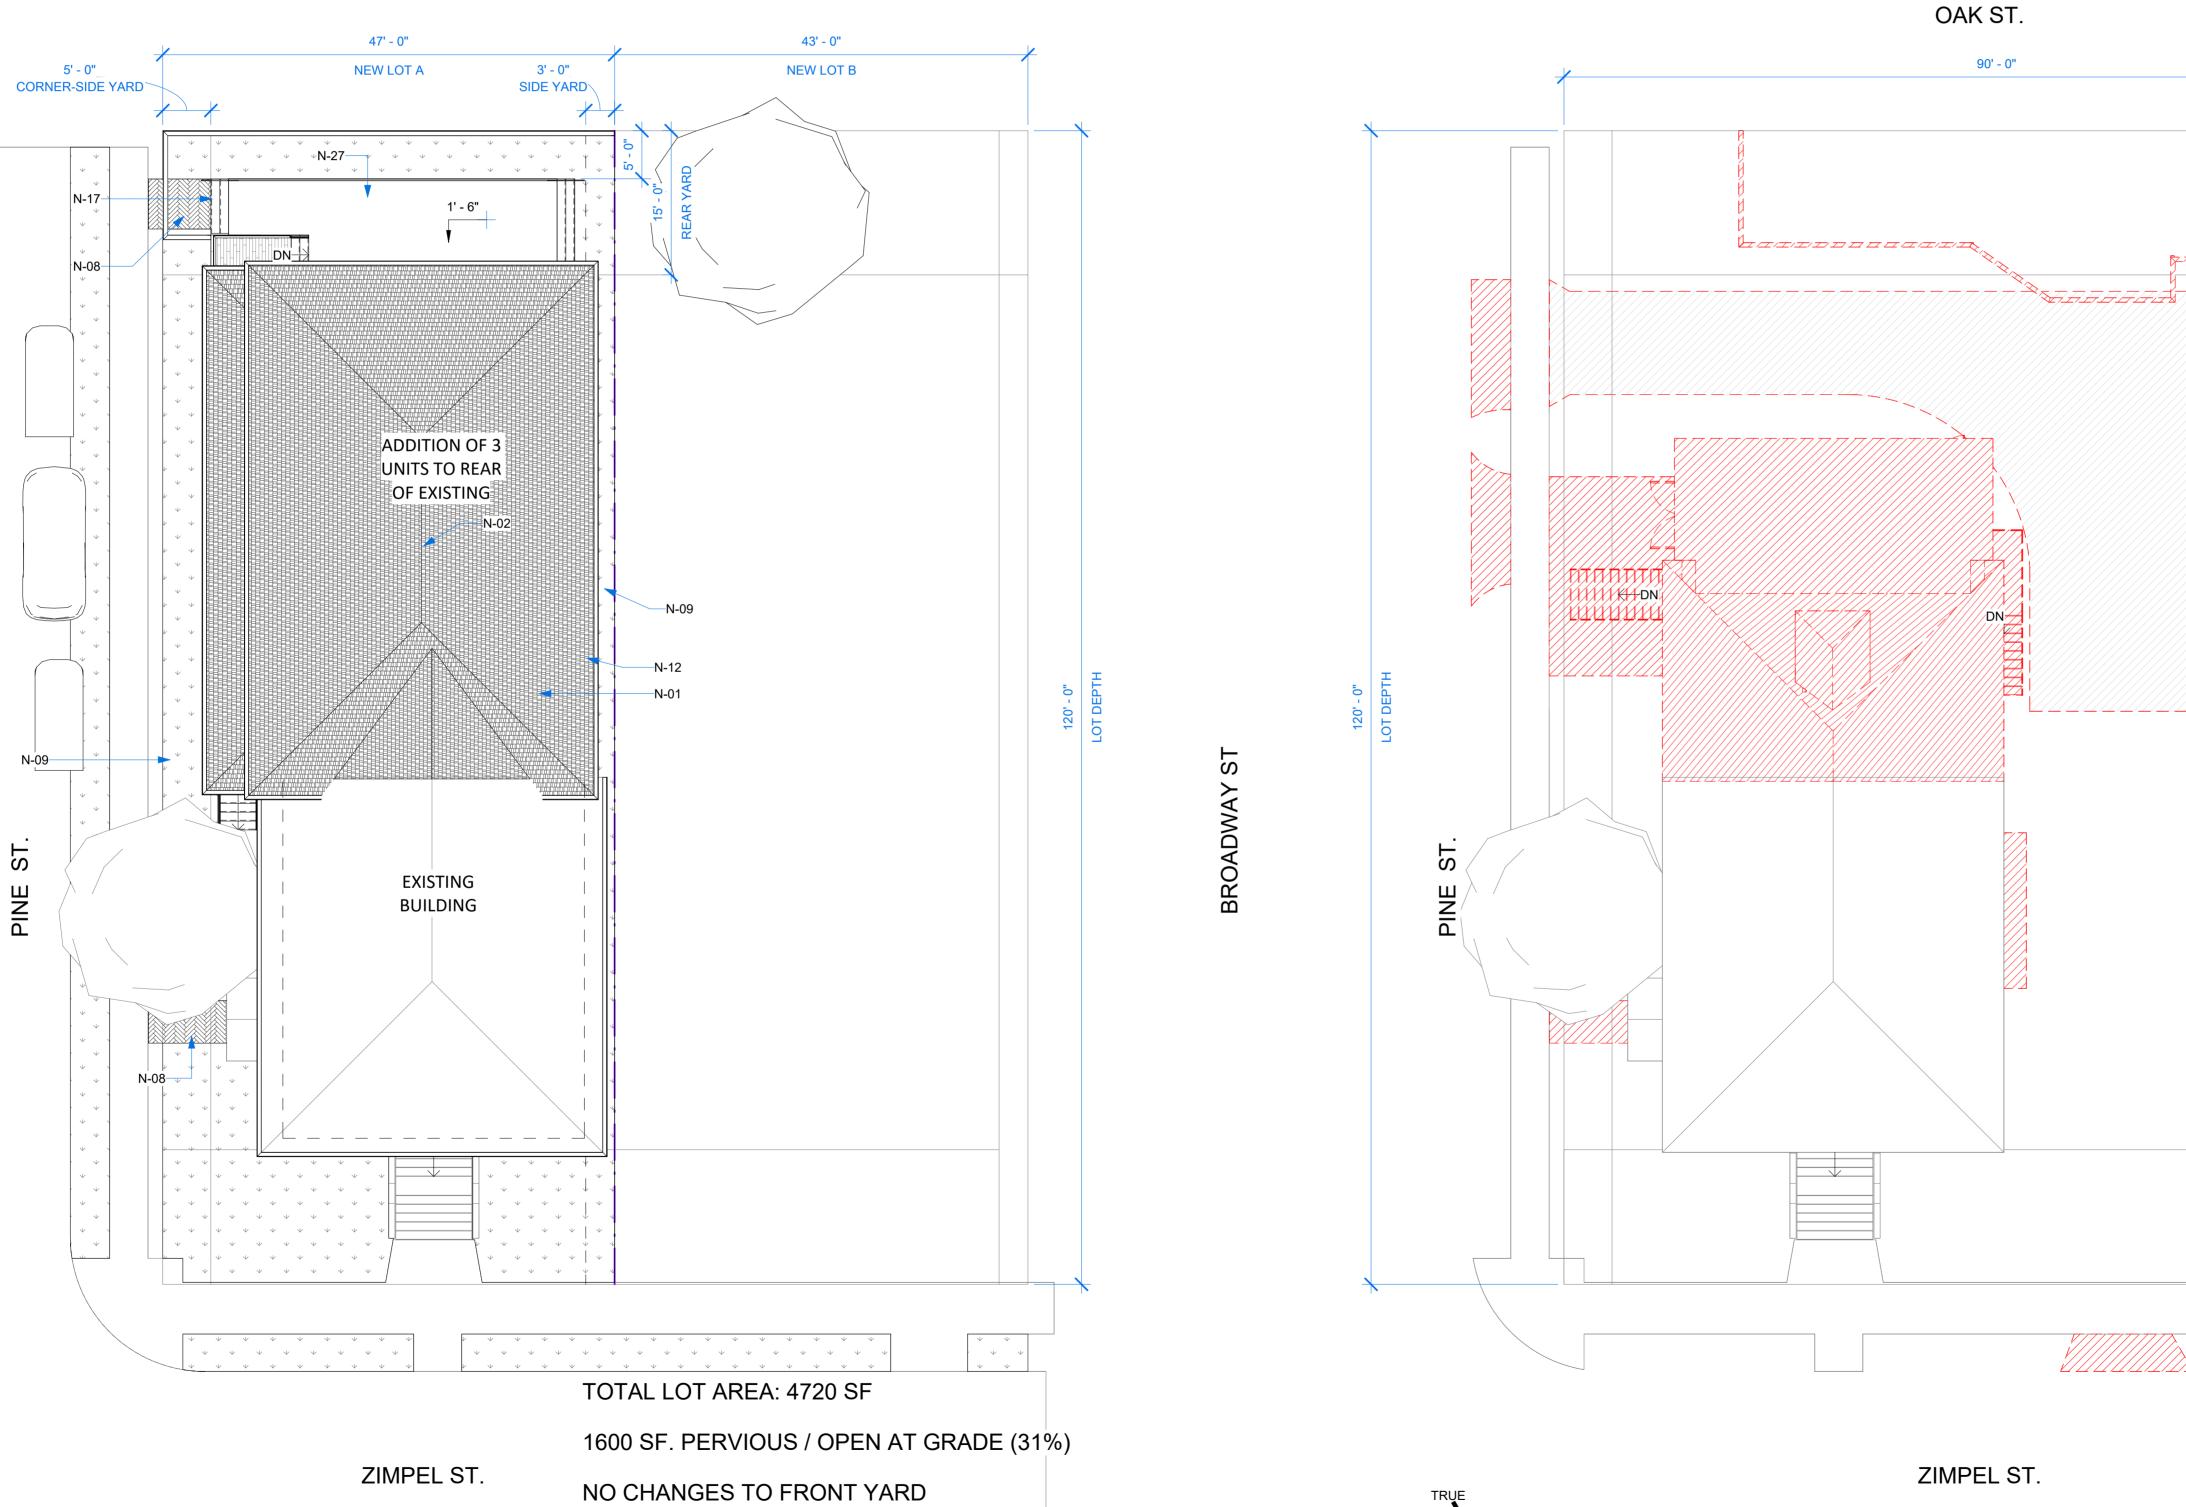

SITE PLAN- EXISTING 1" = 10'-0"

SITE PLAN - EXIST & PROPOSED

PROJECT STATUS 1.28.2025

A1.1

SITE PLAN- PROPOSED 1" = 10'-0"

PERMEABILITY: ETR

OPEN AREA: 31% (1465 SF)

Description

FLOOR PLANS -EXISTING/DEMO

PROJECT STATUS

1.28.2025

30' - 11 1/4" 5' - 0" 7' - 6" STORAGE = 1,076 SF

2ND FLOOR

2 | 2ND FLOOR PLAN - EXISTING/DEMO 3/16" = 1'-0"

1ST FLOOR

1 | 1ST FLOOR_PLAN - EXISTING/DEMO 3/16" = 1'-0"

DEMO AT SIDES AND REAR 300 SF (RIGHT) 600 (LEFT)

3192 SF TOTAL SF (SIDES AND REAR) 1450 TOTAL DEMO (45%) - NOT TO EXCEED 49%

> LESS THAN 50% DEMO AT ROOF 982 SF DEMOLISHED OF 2617 (37%)

- CONTRACTOR TO VERIFY, BEFORE DEMOLITION, ANY EXISTING MECHANICAL OR ELECTRICAL SYSTEMS IN EXISTING WALLS TO BE DEMOLISHED AS REQUIRED IN DRAWINGS AND VERIFY THROUGH ULTRASOUND TESTING ALL EXISTING SLAB CONDITIONS IN THESE AREAS. CONTRACTOR TO COORDINATE COURSE OF ACTION WITH OWNER AND ARCHITECT IN FIELD. CLOSE, CAP, AND DISCONNECT CONNECTION TO EXISTING SERVICE AS REQUIRED. REFER TO MECHANICAL, PLUMBING, AND ELECTRICAL DRAWINGS. REFER TO MEP DEMOLITION SHEETS FOR ADDITIONAL INFORMATION.
- CONTRACTOR RESPONSIBLE FOR DEMOLITION OF INDICATED WALLS & ASSOCIATED MATERIALS.
- CONTRACTOR TO BRACE EXISTING FRAMING AND STRUCTURE AS REQUIRED TO MAINTAIN STRUCTURAL INTEGRITY OF EXISTING AND TO PREVENT COLLAPSE DURING CONSTRUCTION. PROTECT EXISTING FRAMING AND MATERIALS AS NEEDED DURING CONSTRUCTION. CONTRACTOR RESPONSIBLE FOR ALL MEANS AND METHODS OR BRACING. COORDIANTE WITH ENGINEER AS NEEDED FOR SPECIAL BRACING CONDITIONS THAT MIGHT BE NECESSARY DURING DEMO/CONSTRUCTION.
- WHETHER OR NOT IT IS SPECIFICALLY INDICATED ON THE DRAWINGS, THE CONTRACTOR SHALL REMOVE AND DEMOLISH ALL EXISTING CONSTRUCTION, INCLUDING UTILITIES, WHICH WILL INTERFERE WITH NEW WORK. CONTRACTOR WILL COORDINATE SAFETY PRECAUTIONS WITH BUILDING
- ALL EXISTING CONDITIONS. THE GENERAL CONTRACTOR IS RESPONSIBLE FOR WALKING THROUGH AND ADVISING THE ARCHITECT OF READILY APPARENT DISCREPANCIES OR CONDITIONS WHICH ADVERSELY AFFECT CONSTRUCTABILITY OF THE WORK.
- CONTRACTOR TO COORDINATE LOCATION OF DUMPSTERS WITH THE OWNER. PRIOR TO SHUT DOWN OR TYING INTO ANY UTILITY, APPROVAL SHALL BE OBTAINED FROM THE BUILDING REPRESENTATIVE
- CONTRACTOR TO REPAIR AS REQUIRED ALL AFFECTED ADJOINING AREAS TO MATCH NEW
- IN ACCORDANCE WITH GENERALLY ACCEPTED CONSTRUCTION PRACTICES, THE CONTRACTOR WILL BE SOLELY AND COMPLETELY RESPONSIBLE FOR CONDITIONS OF THE JOB SITE, INCLUDING SAFETY OF ALL PERSONS AND PROPERTY DURING PERFORMANCE OF WORK. THIS REQUIREMENT APPLIES CONTINUOUSLY AND WILL NOT BE LIMITED TO NORMAL WORKING HOURS. THE CONTRACTOR SHALL ON THE JOB AND TO PREVENT ACCIDENTS OR INJURY TO ANY PERSONS ON, ABOUT OR ADJACENT TO THE PREMISES. THE CONTRACTOR SHALL COMPLY WITH ALL LAWS, ORDINANCES, CODES, RULES, AND REGULATIONS RELATIVE TO SAFETY AND THE PREVENTION OF ACCIDENTS. CONTRACTOR SHALL COORDINATE SAFETY PRECAUTIONS WITH BUILDING REPRESENTATIVE.

GENERAL NOTES - DEMO

1/8" = 1'-0"

A2.1

KEYNOTES - SHEET Key Value EXTERIOR WD GUARDRAIL @ 36" A.F.F. PROVIDE BLOCKING (OR DRILL AND EPOXY AT CONCRETE) AS REQ'D FOR MOUNT AERITAS HERITAGE TONGUE AND GROOVE DECKING INSTALLED OVER DOUBLE SLEEPERS WHERE REQ'D (JOIST DROPPED 3", RE: STRUCT.) SLOPE NEW DECKING TO DRAIN (1/4 OVER 1 MIN.) PROVIDE ICE AND WATER SHIELD AND FLASHING AS REQ'D. RE: DETAILS TILE FLOORS AT THIS LOCATION, CONTRACTOR TO COORDINATE SELECTIONS AND GROUT COLOR WITH OWNER PRIOR TO PURCHASE AND INSTALLATION. PROVIDE CEMENT BACKER AS REQ'D AT SHOWER SURROUNDS AND BASE. VANITY, SINK, TUB, TOILET, AND , PLUMBING FIXTURES TO BE CHOSEN BY OWNER; CONTRACTOR TO COORDINATE WITH OWNER / FIXTURE PROVIDER. CONTRACTOR TO LAYOU WORK AND MAKE OWNER AWARE OF ANY CLEARANCE ISSUES PRIOR TO INSTALL. NEW SINK AT COUNTERTOP. COORDINATE SELECTION WITH OWNER. PROVIDE GARBAGE DISPOSAL AND BUTTON (ELEC OUTLET) AT KITCHEN SINKS, TYP. COORDINATE FAUCET APPLIANCES AT THIS LOCATION TO BE SELECTED BY OWNER, CONTRACTOR TO COORDINATE CONTRACTOR TO PROVIDE PROTECTION AT APPLIANCES AND FLOOR UNTIL FINAL COMPLETION. TO BE TURNED OVER AS NEW, FREE OF BLEMISHES / DENTS. GAS (OR ELEC.) RANGE OVEN. PROVIDE HOOD EXHAUST AT WALL (OR WITH DOWNDRAFT HOOD UNDER JOISTS) GC COORDINATE EXHAUST ROUTING TO EXISTING HOOD VENTS WASHER AND GAS (OR ELECTRIC) DRYER AT THIS LOCATION; APPLIANCE TO BE SELECTED BY OWNER, CONTRACTOR TO COORDINATE PRIOR TO PURCHASE AND INSTALL. PROVIDE DRAIN PAN AT UNDERSIDE OF WASHER. CONTRACTOR TO PROVIDE PROTECTION UNTIL FINAL COMPLETION. TO BE TURNED OVER AS NEW, FREE OF BLEMISHES / DENTS. PROVIDE POWER OUTLET AND EXHAUST AS REQ'D. COUNTER-TOP. COORDINATE SELECTION WITH OWNER. CABINETRY, STONE, AND FIXTURES TO BE SELECTED BY OWNER; CONTRACTOR TO COORDINATE SELECTIONS & INSTALLATION WITH CABINET, STONE, AND FIXTURE PROVIDER\$ PROVIDE PROTECTION FOR EACH AFTER INSTALL.

4 UNITS

3X 3 BED / 2.5 BATH @ 1194 SF INTERIOR 1X 3BED / 2 BATH @ 865 SF (EXISTING FOOTPRINT)

4477 SF LIVING TOTAL (INTERIOR)

300 SF NEW SIDE PORCH 330 SF REAR DECK

5077 SF GROSS

250 SF EXISTING FRONT PORCH 1076 EXISTING GROUND FLOOR STORAGE

SECTION 114000 - KITCHEN APPLIANCES

1.1 SUMMARY: PROVIDE AND INSTALL KITCHEN APPLIANCES AS SPECIFIED AND SHOWN ON THE

1.2 SUBMITTALS: <u>SUBMIT PRODUCT DATA SHEETS FOR EACH APPLIANCE</u>, <u>INCLUDING</u>

MANUFACTURER, <u>MODEL NUMBER</u>, <u>AND PERFORMANCE SPECIFICATIONS</u>. <u>PROVIDE INSTALLATION INSTRUCTIONS AND WARRANTY INFORMATION FOR OWNER APPROVAL PRIOR TO PURCHASING</u>.

1.3 QUALITY ASSURANCE: APPLIANCES TO BE FROM MANUFACTURERS WITH A MINIMUM OF 5 YEARS OF INDUSTRY EXPERIENCE AND POSITIVE REVIEWS. ENSURE APPLIANCES COMPLYINGS SAFETY AND ENERGY STANDARDS, INCLUDING UL, ETL, AND ENERGY STAR® RATINGS.

2.1 PERFORMANCE CRITERIA:

2. PRODUCTS: SEE INDIVIDUAL KEY NOTES FOR PRODUCTS

ENERGY EFFICIENCY: ALL APPLIANCES TO MEET OR EXCEED [INSERT SPECIFIC ENERGY EFFICIENCY STANDARDS, E.G., ENERGY STAR®] TO MINIMIZE ENERGY CONSUMPTION AND OPERATIONAL COSTS. DURABILITY: APPLIANCES TO BE CONSTRUCTED OF HIGH-QUALITY MATERIALS FOR LONG-TERM RELIABILITY AND RESISTANCE TO TYPICAL WEAR AND TEAR.

NOISE LEVELS: APPLIANCES TO OPERATE WITHIN ACCEPTABLE NOISE LEVELS, ENSURING MINIMAL DISTURBANCE IN APARTMENT SETTINGS. [INSERT SPECIFIC NOISE LEVELS IF APPLICABLE, E.G.,

EASE OF USE: APPLIANCES TO FEATURE USER-FRIENDLY CONTROLS AND INTERFACES, ENSURING EASE OF OPERATION FOR ALL RESIDENTS. 3.1 INSTALLATION: INSTALL APPLIANCES ACCORDING TO MANUFACTURERS INSTRUCTIONS AN LOCAL CODES. VERIFY PROPER OPERATION AND ADJUST SETTINGS AS NEEDED. ALL POWER/WATER CONNECTORS TO BE PROVIDED.

3.2 TESTING: TEST ALL APPLIANCES TO ENSURE THEY ARE OPERATING CORRECTLY AND

- BATHROOM FAUCET: B.O.D. MOEN DOUBLE HANDLE CENTERSET BATHROOM FAUCET FROM THE BRANTFORD COLLECTION (VALVE INCLUDED). MODEL: 66610 & SINK BASE BOD: 30 IN. W X 19 IN. D X 33 IN. H SINGLE SINK FREESTANDING BATH VANITY IN PEARL GRAY WITH WHITE CULTURED MARBLE TOP
- WATER CLOSET B.O.D. GLACIER BAY, 12 INCH ROUGH IN TWO-PIECE 1.28 GPF SINGLE FLUSH
- ELONGATED TOILET IN WHITE SEAT INCLUDED
- 3 COUNTERTOP 2CM GRANITE W/BACKSPLASH, OWNER TO CHOOSE COLOR
- REFIGERATOR: B.O.D. LG, 30 IN. W 20 CU. FT. TOP FREEZER REFRIGERATOR W/ MULTI-AIR FLOW AND REVERSIBLE DOOR IN STAINLESS STEEL, ENERGY STAR
- (5) KITCHEN SINK: STANDARD 30" SINGLE BOWL UNDERMOUNT KITCHEN SINK. STAINLESS STEEL.
- REFIFERATOR: B.O.D. FRIGIDAIRE, 30 IN. 5 BURNER ELEMENT FREESTANDING ELECTRIC RANGE IN BLACK WITH EVENTEMP AND STEAM CLEAN
- MICROWAVE: B.O.D. GE, 1.6 CU. FT. OVER-THE-RANGE MICROWAVE IN STAINLESS STEEL. RE-CIRCULATING VENT CONFIGURATION.
- RANGE: B.O.D. GE 30 IN. 4 BURNER ELEMENT FREE-STANDING ELECTRIC RANGE IN STAINLESS STEEL
- CABINETS: B.O.D. PAINTED WOOD WITH A MINIMUM THICKNESS OF ¾ INCH FOR DOORS AND ½ INCH 9 FOR CABINET BOXES. SOFT CLOSERS AND HARDWARE INCLUDED.
- SHOWER: CUSTOM BUILT SHOWER SURROUND. SCHLUTER-SHOWER SYSTEM WITH CEMENT BOARD 10 SURROUND CLAD IN SUBWAY TILE. FACUET: B.O.D. DELTA FOUNDATIONS SINGLE-HANDLE 1-SPRAY SHOWER FAUCET IN CHROME (VALVE INCLUDED). PROVIDE 5/16 IN. TEMPERED GLASS SHOWER DOOR,

PRODUCT BASIS OF DESIGN (B.O.D.) SELECTIONS

2nd

/ RENOVATION St.

Description

FLOOR PLANS -PROPOSED

PROJECT STATUS 1.28.2025

3/16" = 1'-0"

CLOS D208

CLOS C208

BED 3 C206

LIVING / KITCHEN A201 C205

B204

LAUNDRY

C202

LAUNDRY

-N-48.4

UNIT 3

3/2 = 865 SF

KEY PLAN - ELEVATION - DEMO

ROOF 30' - 0"

2ND FLOOR CLG. 17' - 9"

2ND FLOOR BFE 13' - 0"_G. BFE 12' - 0"

2ND FLOOR 1ST FLOOR CLG. 6' - 6"

DEMO AT SIDES AND REAR 300 SF (RIGHT) 550 (REAR) 600 (LEFT)

300 SQ FT DEMO (1321 SQ FT. FACADE TOTAL) - 23%

3192 SF TOTAL SF (SIDES AND REAR) 1450 TOTAL DEMO (45%) - NOT TO EXCEED 49%

> LESS THAN 50% DEMO AT ROOF 982 SF DEMOLISHED OF 2617 (37%)

KEYNOTES - SHEET Keynote Text

229 Zimpel St. Orleans LA, 70118

ADDITION / RENOVATION

1 EAST ELEVATION - DEMO 3/16" = 1'-0"

600 SQ FT DEMO (1321 SQ FT. FACADE TOTAL)

4 | WEST ELEVATION - DEMO 3/16" = 1'-0"

2ND CLG BFE 22' - 0" 2ND FLOOR CLG. 17' - 9" 2ND FLOOR BFE 13' - 0"_G. BFE 12' - 0" 2ND FLOOR 1ST FLOOR CLG. 6' - 6"

550 SQ FT DEMO (550 SQ FT. FACADE TOTAL) - 100%

2 | NORTH ELEVATION - DEMO 3/16" = 1'-0"

NO DEMO AT FRONT FACADE (0%)

3 | SOUTH ELEVATION - DEMO 3/16" = 1'-0"


A3.1


1.28.2025

EXTERIOR

ELEVATIONS -EXISTING/DEMO

PROJECT STATUS

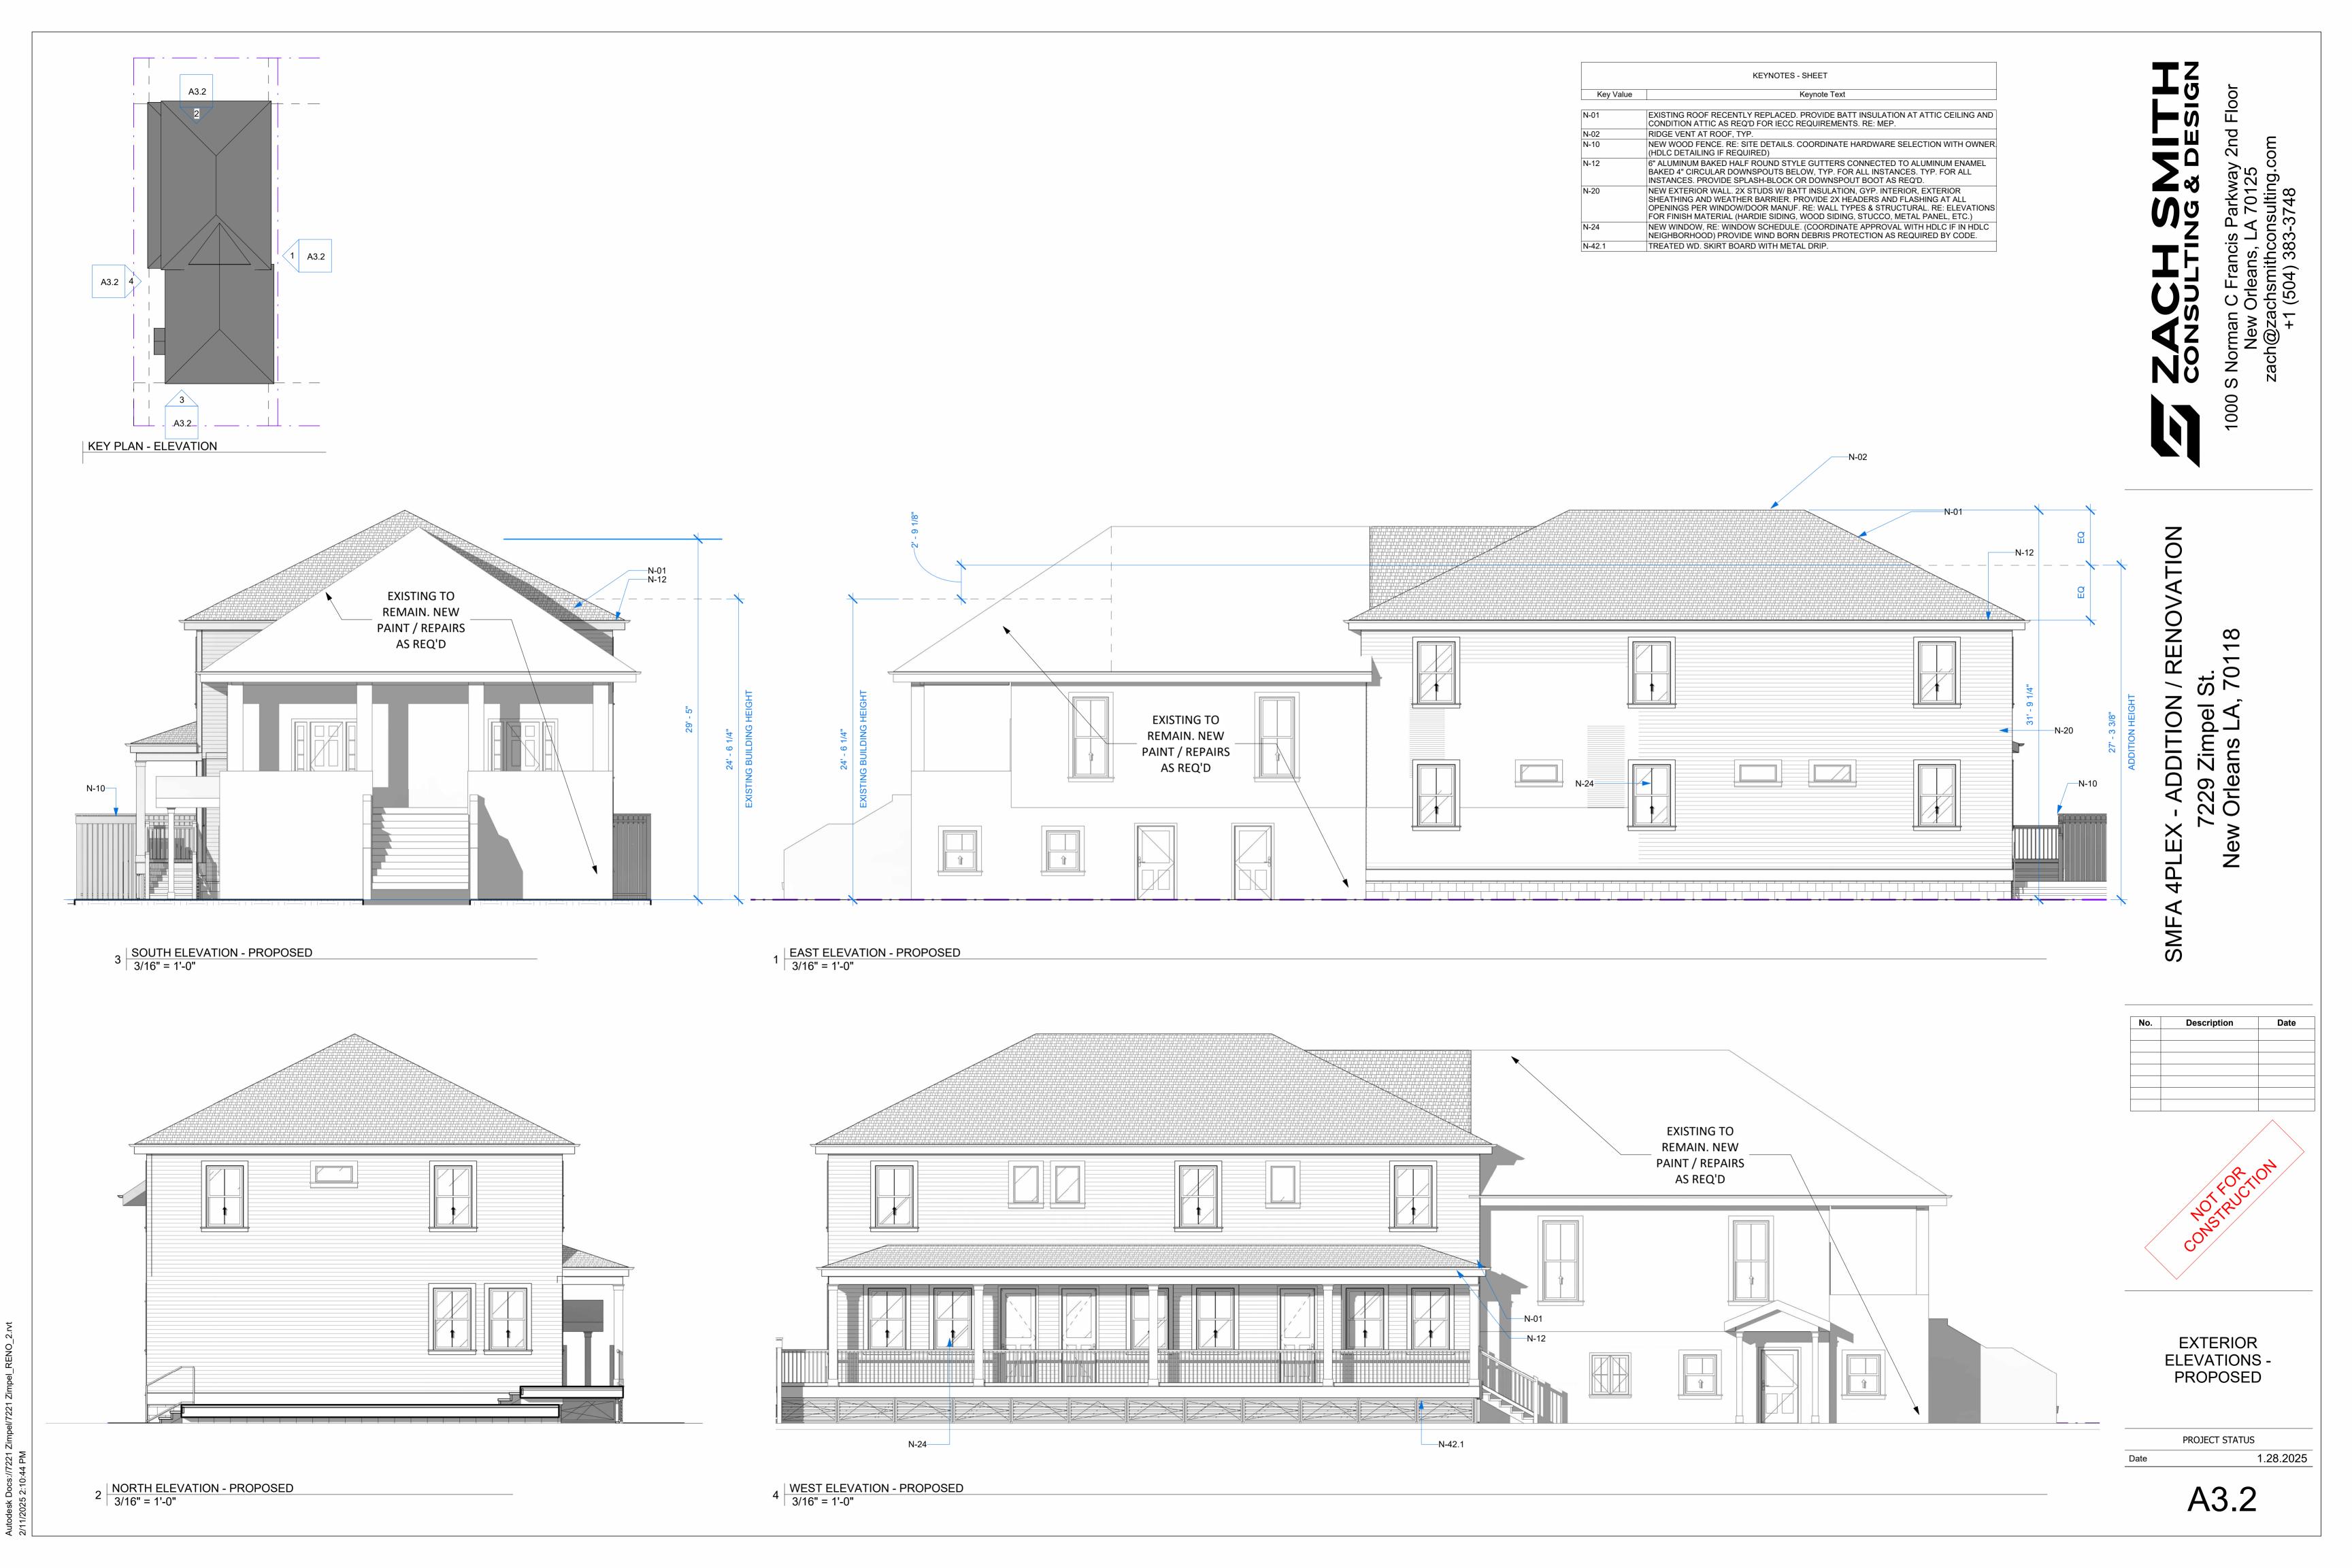

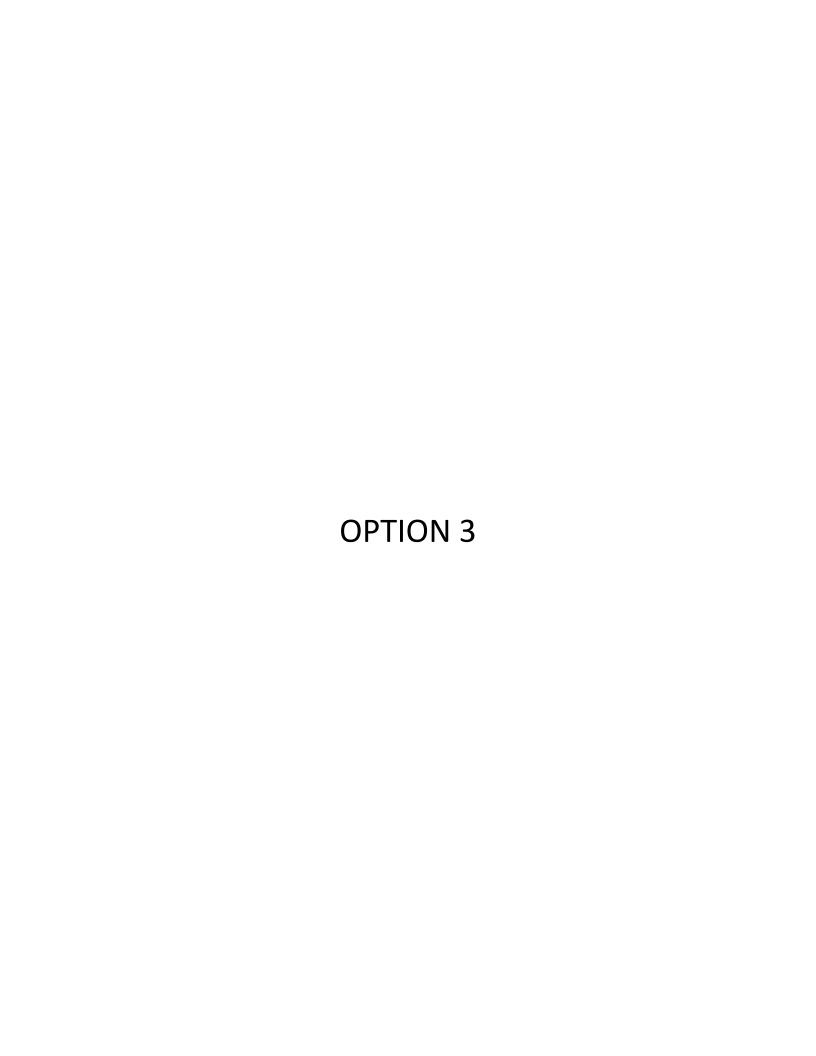

CPC DRAWINGS

SMFA 4PLEX - ADDITION / RENOVATION

7229 Zimpel St. New Orleans LA, 70118

OAK ST.

3' - 0"

SIDE YARD

NEW LOT A

2STORY ADDITION AT REAR

EXISTING

BUILDING

5' - 0"

CORNER-SIDE YARD

43' - 0"

NEW LOT B



		SHEET LIST			
Sheet Number	Sheet Name	Sheet Issue Date	Current Revision	Current Revision Date	Current Revision Description
A3.3	NEIGHBORHOOD MASSING	03/25/25			
41.1	SITE PLAN - EXIST & PROPOSED	1.28.2025			
A2.1	FLOOR PLANS - EXISTING/DEMO	1.28.2025			
A 2.2	FLOOR PLANS - PROPOSED	1.28.2025			
A3.1	EXTERIOR ELEVATIONS - EXISTING/DEMO	1.28.2025			
43.2	EXTERIOR ELEVATIONS - PROPOSED	1.28.2025			
TITLE				,	
Γ1.1	TITLE SHEET	01/16/25			
ARCHITE	CTURE				
ASK-1	PRESENTATION PLANS	01/16/25			



Description

TITLE SHEET

PROJECT STATUS

01/16/25



Energy Code Compliance Summary IECC 2021

KEYNOTES - SHEET			
Key Value	Keynote Text		
N-08	NEW PERVIOUS PAVERS THIS LOCATION		
N-09	NEW GRADING/SOD AS REQ'D.		
N-17	EXTERIOR WD. STAIR TO MATCH WD. PORCH/DECK. TREATED FRAMING, TYP. RE: DETAILS / STRUCT.		
N-27	AERITAS HERITAGE TONGUE AND GROOVE DECKING INSTALLED OVER DOUBLE SLEEPERS WHERE REQ'D (JOIST DROPPED 3", RE: STRUCT.) SLOPE NEW DECKING TO DRAIN (1/4 OVER 1' MIN.) PROVIDE ICE AND WATER SHIELD AND FLASHING AS REQ'D. RE: DETAILS		

COMPLIANCE METHOD	CHECK
PRESCRIPTIVE	✓
RESCHECK	
(HTTP://WWW.ENERGYCODES.GOV/RESCHECK)	
COMCHECK (HTTP://WWW.ENERGYCODES.GOV/COMCHECK)	
BUILDING AREA	VALUE
BOILDING AIRLA	1
TOTAL AREA (SQ FT) OF CONDITIONED SPACE	4477
INSULATION VALUES (R402)	ENTER R VALUE
CEILNG/ROOF	R-38
WALLS	R-13
BASEMENT	/ N/A
FLOOR	/ R-13
SLAB	/ N/A
CRAWLSPACE	/ N/A
HEATING EQUIPMENT	EFFICIENCY (BTU'S/RATING)
ELECTRIC TBD. SEE GENERAL NOTE 1 BELOW.	TBD. SEE GENERAL NOTE 1 BELOW.
GAS TBD. SEE GENERAL NOTE 1 BELOW.	TBD. SEE GENERAL NOTE 1 BELOW.
COOLING EQUIPMENT	EFFICIENCY (BTU/SEER)
TBD. SEE GENERAL NOTE 1 BELOW.	/ GREATER THAN OF EQUAL TO 10 HSPF/16 SEER AIR SOURCE HEAT PU GREATER THAN OR EQUAL TO 3.5 COP GROUND SOURCE HEAT PUN
FENESTRATION U VALUE	U-VALUE
.40 MAX	
FENESTRATION SHGC	SHGC
.25 MAX.	
SKYLIGHT U VALUE	U-VALUE
N/A	

504-410-5322

CLIMATE ZONE 2A FOR ORLEANS

JJUNEAU@AP-ENG.COM

OVERLAY DISTRICT:

• RESIDENTIAL STR IZD

PROPOSED DEVELOPMENT:

CONSTRUCTION TYPE:

OCCUPANCY TYPE:

APPLICABLE CODES:

STORAGE)

YES / YES

IBC: RESIDENTIAL (R-2)

SPRINKLERED / FIRE ALARM:

ZONING DISTRICT: HU-RD2 HISTORIC URBAN TWO-FAMILY RESIDENTIAL

UNIVERSITY AREA OFF-STREET PARKING OVERLAY DISTRICT

NFPA: RESIDENTIAL, GROSS SF: 6026 (INCLUDING UNDER HOUSE

(BUILDINGS, STRUCTURES, APPURTENANCES AND PARTS THEREOF BE DESIGNED TO WITHSTAND A BASIC (NOMINAL) WIND SPEED OF 130 MPH.

HDLC DISTRICT: NOHDLC UPTOWN PARTIAL

IBC/IFC: NFPA: COMMON TERMINOLOGY:

TYPE V-A V (000) PROTECTED COMBUSTIBLE

• 2021 IBC WITH NEW ORLEANS CODE ADOPTIONS

2021 INTERNATIONAL EXISTING BUILDING CODE

NEW LOT B DIMENSIONS: 47' X 120'

EXISTING MULTI FAMILY BUILDING

CONVERTED INTO SMFA AFFORDABLE 4-PLEX. 3 NEW UNITS ON REAR. LESS THAN 50% DEMO OF SIDES AND REAR. EXISTING FRONT FACADE TO REMAIN. NEW MEP **THROUGHTOUT**

ADDITION / STRUCTURAL RENO

SFM, LEVEL OF ALTERATION LEVEL 4

JAMES SPALT 7229 ZIMPLE ST

NEW ORLEANS LA 70118 JS@NDVRPARTNERS.COM

ZACH SMITH CONSULTING & DESIGN 1000 S NORMAN C FRANCIS PKWY NEW ORLEANS, LA 70125 504-383-3748 ZACH@ZACHSMITHCONSULTING.COM

MEP ENGINEER

STRUCTURAL/CIVIL ENGINEER AP DESIGN GROUP JOSHUA JUNEAU, PE

EXPOSURE B, IN ACCORDANCE WITH 2021 IBC, SECTION 1609) • 2021 INTERNATIONAL MECHANICAL CODE

• 2021 LOUISIANA STATE PLUMBING CODE • NFPA 70, 2020 NATIONAL ELECTRIC CODE 2021 INTERNATIONAL FUEL CODE • 2021 INTERNATIONAL ENERGY CONSERVATION CODE

PROJECT INFORMATION

THE GENERAL CONTRACTOR IS RESPONSIBLE TO SUPPLY ALL SUBCONTRACTORS WITH CONSTRUCTION DRAWINGS AND SPECIFICATIONS NECESSARY TO BID AND/OR CONSTRUCT THIS PROJECT. TO THE GENERAL CONTRACTOR AND ALL SUBCONTRACTORS: ALL CONTRACTORS ARE RESPONSIBLE TO NOTIFY THE

ARCHITECT OF ANY ERRORS, OMISSIONS OR DISCREPANCIES PRIOR TO MAKING ANY CHANGES TO THE CONSTRUCTION DOCUMENTS. ALL DIMENSIONS ON THE FLOOR PLANS, UNLESS OTHERWISE NOTED, ARE TAKEN FROM INSIDE FACE OF STUDS OF EXTERIOR WALLS, CENTER OF STUDS OF NEW INTERIOR PARTITIONS, FACES OR CENTERLINE OF STRUCTURAL

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ALL PERMIT FEES SHALL BE PAID BY CONTRACTOR.

CONTRACTOR SHALL BE RESPONSIBLE FOR AND PAY FOR ALL UTILITY DEPOSITS, IMPACT FEES AND CONNECTION

GENERAL NOTES - PROJECT

1600 SF. PERVIOUS / OPEN AT GRADE (31%) ZIMPEL ST. NO CHANGES TO FRONT YARD PERMEABILITY: ETR SITE PLAN- PROPOSED - COVER OPEN AREA: 31% (1465 SF) 1" = 10'-0" ZONING: HU-RD2

· • • • • • • • V V V · • • • •

v v v v

REQUIRMENTS: REQ: COMPLIANCE: MIN. LOT SIZE 2,250 SF MIN. PERMIABLE AREA FRONT YARD SETBACK AVG SURROUNDING (NONE) YES SIDE YARD SETBACK YES 20% of lot depth or 15, whichever is REAR YARD SETBACK YES PARKING*

ZONING HU-RD2

OVERLAY: LOWER NINTH WARD

REDEVELOPMENT INTERIUM ZONING DISTRICT

TOTAL LOT AREA: 4720 SF


OAK ST.

DEMO AT SIDES AND REAR 300 SF (RIGHT) 550 (REAR) 600 (LEFT)

3192 SF TOTAL SF (SIDES AND REAR) 1450 TOTAL DEMO (45%) - NOT TO EXCEED 49%

> LESS THAN 50% DEMO AT ROOF 982 SF DEMOLISHED OF 2617 (37%)

OAK ST. 90' - 0" ZIMPEL ST.

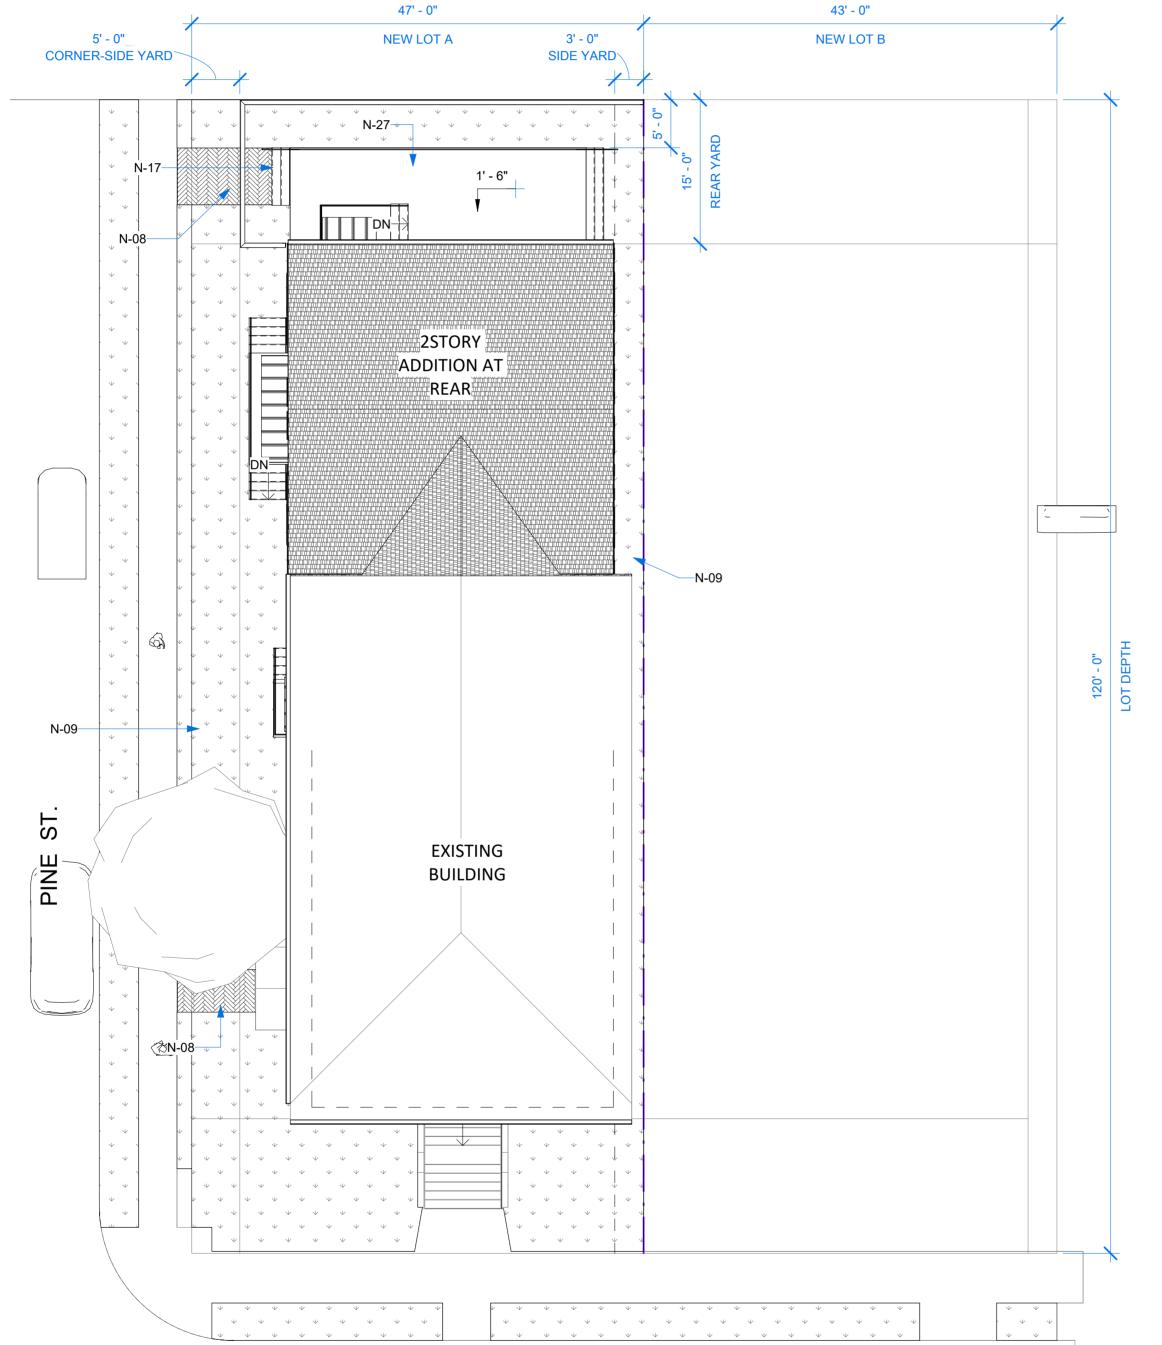

ZIMPEL ST.

SITE PLAN- PROPOSED 1" = 10'-0"

TOTAL LOT AREA: 4720 SF

1600 SF. PERVIOUS / OPEN AT GRADE (31%)

NO CHANGES TO FRONT YARD PERMEABILITY: ETR

OPEN AREA: 31% (1465 SF)

SITE PLAN- EXISTING 1" = 10'-0"

229 Zimpel St. Orleans LA, 70118

SITE PLAN - EXIST & PROPOSED

PROJECT STATUS 1.28.2025

A1.1

Description

FLOOR PLANS -EXISTING/DEMO

PROJECT STATUS

1.28.2025

GENERAL NOTES - DEMO

30' - 11 1/4" ____________ 5' - 0" 7' - 6" STORAGE = 1,076 SF

2ND FLOOR

2 | 2ND FLOOR PLAN - EXISTING/DEMO 3/16" = 1'-0"

N-43

1ST FLOOR

1 | 1ST FLOOR_PLAN - EXISTING/DEMO 3/16" = 1'-0"

DEMO AT SIDES AND REAR 300 SF (RIGHT) 600 (LEFT)

3192 SF TOTAL SF (SIDES AND REAR) 1450 TOTAL DEMO (45%) - NOT TO EXCEED 49%

> LESS THAN 50% DEMO AT ROOF 982 SF DEMOLISHED OF 2617 (37%)

- CONTRACTOR TO VERIFY, BEFORE DEMOLITION, ANY EXISTING MECHANICAL OR ELECTRICAL SYSTEMS IN EXISTING WALLS TO BE DEMOLISHED AS REQUIRED IN DRAWINGS AND VERIFY THROUGH ULTRASOUND TESTING ALL EXISTING SLAB CONDITIONS IN THESE AREAS. CONTRACTOR TO COORDINATE COURSE OF ACTION WITH OWNER AND ARCHITECT IN FIELD. CLOSE, CAP, AND DISCONNECT CONNECTION TO EXISTING SERVICE AS REQUIRED. REFER TO MECHANICAL, PLUMBING, AND ELECTRICAL DRAWINGS. REFER TO MEP DEMOLITION SHEETS FOR ADDITIONAL INFORMATION.
- CONTRACTOR RESPONSIBLE FOR DEMOLITION OF INDICATED WALLS & ASSOCIATED MATERIALS.
- CONTRACTOR TO BRACE EXISTING FRAMING AND STRUCTURE AS REQUIRED TO MAINTAIN STRUCTURAL INTEGRITY OF EXISTING AND TO PREVENT COLLAPSE DURING CONSTRUCTION. PROTECT EXISTING FRAMING AND MATERIALS AS NEEDED DURING CONSTRUCTION. CONTRACTOR RESPONSIBLE FOR ALL MEANS AND METHODS OR BRACING. COORDIANTE WITH ENGINEER AS NEEDED FOR SPECIAL BRACING CONDITIONS THAT MIGHT BE NECESSARY DURING DEMO/CONSTRUCTION.
- WHETHER OR NOT IT IS SPECIFICALLY INDICATED ON THE DRAWINGS, THE CONTRACTOR SHALL REMOVE AND DEMOLISH ALL EXISTING CONSTRUCTION, INCLUDING UTILITIES, WHICH WILL INTERFERE WITH NEW WORK. CONTRACTOR WILL COORDINATE SAFETY PRECAUTIONS WITH BUILDING
- ALL EXISTING CONDITIONS. THE GENERAL CONTRACTOR IS RESPONSIBLE FOR WALKING THROUGH AND ADVISING THE ARCHITECT OF READILY APPARENT DISCREPANCIES OR CONDITIONS WHICH ADVERSELY AFFECT CONSTRUCTABILITY OF THE WORK.
- CONTRACTOR TO COORDINATE LOCATION OF DUMPSTERS WITH THE OWNER. PRIOR TO SHUT DOWN OR TYING INTO ANY UTILITY, APPROVAL SHALL BE OBTAINED FROM THE BUILDING REPRESENTATIVE
- CONTRACTOR TO REPAIR AS REQUIRED ALL AFFECTED ADJOINING AREAS TO MATCH NEW
- IN ACCORDANCE WITH GENERALLY ACCEPTED CONSTRUCTION PRACTICES, THE CONTRACTOR WILL BE SOLELY AND COMPLETELY RESPONSIBLE FOR CONDITIONS OF THE JOB SITE, INCLUDING SAFETY OF ALL PERSONS AND PROPERTY DURING PERFORMANCE OF WORK. THIS REQUIREMENT APPLIES CONTINUOUSLY AND WILL NOT BE LIMITED TO NORMAL WORKING HOURS. THE CONTRACTOR SHALL ON THE JOB AND TO PREVENT ACCIDENTS OR INJURY TO ANY PERSONS ON, ABOUT OR ADJACENT TO THE PREMISES. THE CONTRACTOR SHALL COMPLY WITH ALL LAWS, ORDINANCES, CODES, RULES, AND REGULATIONS RELATIVE TO SAFETY AND THE PREVENTION OF ACCIDENTS. CONTRACTOR SHALL COORDINATE SAFETY PRECAUTIONS WITH BUILDING REPRESENTATIVE.

1/8" = 1'-0"

A2.1

BED 3 D206

BED 3 B205

LIVING / KITCHEN

3 2ND FLOOR BFE

UNIT 4

(D)

-N-48.4

UNIT 3

(C)

UNIT 2

(B)

3/2 = 865 SF

LAUNDRY

KEYNOTES - SHEET Key Value EXTERIOR WD GUARDRAIL @ 36" A.F.F. PROVIDE BLOCKING (OR DRILL AND EPOXY AT CONCRETE) AS REQ'D FOR MOUNT AERITAS HERITAGE TONGUE AND GROOVE DECKING INSTALLED OVER DOUBLE SLEEPERS WHERE REQ'D (JOIST DROPPED 3", RE: STRUCT.) SLOPE NEW DECKING TO DRAIN (1/4 OVER 1 MIN.) PROVIDE ICE AND WATER SHIELD AND FLASHING AS REQ'D. RE: DETAILS TILE FLOORS AT THIS LOCATION, CONTRACTOR TO COORDINATE SELECTIONS AND GROUT COLOR WITH OWNER PRIOR TO PURCHASE AND INSTALLATION. PROVIDE CEMENT BACKER AS REQ'D AT SHOWER SURROUNDS AND BASE. NEW SINK AT COUNTERTOP. COORDINATE SELECTION WITH OWNER. PROVIDE GARBAGE DISPOSAL AND BUTTON (ELEC OUTLET) AT KITCHEN SINKS, TYP. COORDINATE FAUCET WASHER AND GAS (OR ELECTRIC) DRYER AT THIS LOCATION; APPLIANCE TO BE SELECTED BY COUNTER-TOP. COORDINATE SELECTION WITH OWNER.

GAS (OR ELEC.) RANGE OVEN. PROVIDE HOOD EXHAUST AT WALL (OR WITH DOWNDRAFT HOOD UNDER JOISTS) GC COORDINATE EXHAUST ROUTING TO EXISTING HOOD VENTS OWNER, CONTRACTOR TO COORDINATE PRIOR TO PURCHASE AND INSTALL. PROVIDE DRAIN PAN AT UNDERSIDE OF WASHER. CONTRACTOR TO PROVIDE PROTECTION UNTIL FINAL COMPLETION. TO BE TURNED OVER AS NEW, FREE OF BLEMISHES / DENTS. PROVIDE POWER / OUTLET AND EXHAUST AS REQ'D. CABINETRY, STONE, AND FIXTURES TO BE SELECTED BY OWNER; CONTRACTOR TO COORDINATE SELECTIONS & INSTALLATION WITH CABINET, STONE, AND FIXTURE PROVIDERS. PROVIDE PROTECTION FOR EACH AFTER INSTALL.

4 UNITS

2X 3 BED / 2.5 BATH @ 1150 SF INTERIOR 1X 2 BED / 2.5 BATH @ 737 SF INTERIOR 1X 3BED / 2 BATH @ 950 SF (EXISTING FOOTPRINT)

3987 SF LIVING TOTAL (INTERIOR)

330 SF REAR DECK

5030 SF GROSS

250 SF EXISTING FRONT PORCH 1076 EXISTING GROUND FLOOR STORAGE

SECTION 114000 - KITCHEN APPLIANCES

1.1 SUMMARY: PROVIDE AND INSTALL KITCHEN APPLIANCES AS SPECIFIED AND SHOWN ON THE

1.2 SUBMITTALS: SUBMIT PRODUCT DATA SHEETS FOR EACH APPLIANCE, INCLUDING
MANUFACTURER, MODEL NUMBER, AND PERFORMANCE SPECIFICATIONS. PROVIDE INSTALLATION
INSTRUCTIONS AND WARRANTY INFORMATION FOR OWNER APPROVAL PRIOR TO PURCHASING.
1.3 QUALITY ASSURANCE: APPLIANCES TO BE FROM MANUFACTURERS WITH A MINIMUM OF 5 YEARS
OF INDUSTRY EXPERIENCE AND POSITIVE REVIEWS. ENSURE APPLIANCES COMPLY WITH RELEVANT
SAFETY AND ENERGY STAR® RATINGS.

2. PRODUCTS: SEE INDIVIDUAL KEY NOTES FOR PRODUCTS 2.1 PERFORMANCE CRITERIA:

ENERGY EFFICIENCY: ALL APPLIANCES TO MEET OR EXCEED [INSERT SPECIFIC ENERGY EFFICIENCY STANDARDS, E.G., ENERGY STAR®] TO MINIMIZE ENERGY CONSUMPTION AND OPERATIONAL COSTS. DURABILITY: APPLIANCES TO BE CONSTRUCTED OF HIGH-QUALITY MATERIALS FOR LONG-TERM RELIABILITY AND RESISTANCE TO TYPICAL WEAR AND TEAR.

NOISE LEVELS: APPLIANCES TO OPERATE WITHIN ACCEPTABLE NOISE LEVELS, ENSURING MINIMAL DISTURBANCE IN APARTMENT SETTINGS. [INSERT SPECIFIC NOISE LEVELS IF APPLICABLE, E.G.,

EASE OF USE: APPLIANCES TO FEATURE USER-FRIENDLY CONTROLS AND INTERFACES, ENSURING EASE OF OPERATION FOR ALL RESIDENTS.

3.1 INSTALLATION: INSTALL APPLIANCES ACCORDING TO MANUFACTURERS INSTRUCTIONS AN LOCAL CODES. VERIFY PROPER OPERATION AND ADJUST SETTINGS AS NEEDED. ALL POWER/WATER CONNECTORS TO BE PROVIDED. 3.2 TESTING: TEST ALL APPLIANCES TO ENSURE THEY ARE OPERATING CORRECTLY AND

- BATHROOM FAUCET: B.O.D. MOEN DOUBLE HANDLE CENTERSET BATHROOM FAUCET FROM THE BRANTFORD COLLECTION (VALVE INCLUDED). MODEL: 66610 & SINK BASE BOD: 30 IN. W X 19 IN. D X 33 IN. H SINGLE SINK FREESTANDING BATH VANITY IN PEARL GRAY WITH WHITE CULTURED MARBLE TOP
- WATER CLOSET B.O.D. GLACIER BAY, 12 INCH ROUGH IN TWO-PIECE 1.28 GPF SINGLE FLUSH ELONGATED TOILET IN WHITE SEAT INCLUDED
- (3) COUNTERTOP 2CM GRANITE W/BACKSPLASH, OWNER TO CHOOSE COLOR
- REFIGERATOR: B.O.D. LG, 30 IN. W 20 CU. FT. TOP FREEZER REFRIGERATOR W/ MULTI-AIR FLOW AND REVERSIBLE DOOR IN STAINLESS STEEL, ENERGY STAR
- (5) KITCHEN SINK: STANDARD 30" SINGLE BOWL UNDERMOUNT KITCHEN SINK. STAINLESS STEEL.
- REFIFERATOR: B.O.D. FRIGIDAIRE, 30 IN. 5 BURNER ELEMENT FREESTANDING ELECTRIC RANGE IN BLACK WITH EVENTEMP AND STEAM CLEAN
- MICROWAVE: B.O.D. GE, 1.6 CU. FT. OVER-THE-RANGE MICROWAVE IN STAINLESS STEEL. RE-CIRCULATING VENT CONFIGURATION.
- RANGE: B.O.D. GE 30 IN. 4 BURNER ELEMENT FREE-STANDING ELECTRIC RANGE IN STAINLESS STEEL
- CABINETS: B.O.D. PAINTED WOOD WITH A MINIMUM THICKNESS OF ¾ INCH FOR DOORS AND ½ INCH 9 FOR CABINET BOXES. SOFT CLOSERS AND HARDWARE INCLUDED.
- SHOWER: CUSTOM BUILT SHOWER SURROUND. SCHLUTER-SHOWER SYSTEM WITH CEMENT BOARD 10 SURROUND CLAD IN SUBWAY TILE. FACUET: B.O.D. DELTA FOUNDATIONS SINGLE-HANDLE 1-SPRAY SHOWER FAUCET IN CHROME (VALVE INCLUDED). PROVIDE 5/16 IN. TEMPERED GLASS SHOWER DOOR,

PRODUCT BASIS OF DESIGN (B.O.D.) SELECTIONS

2nd

/ RENOV St. 70

Description

FLOOR PLANS -PROPOSED

PROJECT STATUS 1.28.2025

A3.1 4 1 A3.1 KEY PLAN - ELEVATION - DEMO

ROOF 30' - 0"

2ND FLOOR CLG. 17' - 9"

2ND FLOOR BFE 13' - 0"_G. BFE 12' - 0"

2ND FLOOR 1ST FLOOR CLG. 6' - 6"

DEMO AT SIDES AND REAR 275 SF (RIGHT)

550 (REAR) 600 (LEFT)

3192 SF TOTAL SF (SIDES AND REAR) 1425 TOTAL DEMO (45%) - NOT TO EXCEED 49%

LESS THAN 50% DEMO AT ROOF 982 SF DEMOLISHED OF 2617 (37%) KEYNOTES - SHEET Keynote Text

229 Zimpel St. Orleans LA, 70118

ADDITION / RENOVATION

Î 275 SQ FT DEMO (1321 SQ FT. FACADE TOTAL) - 20%

1 EAST ELEVATION - DEMO 3/16" = 1'-0"



550 SQ FT DEMO (550 SQ FT. FACADE TOTAL) - 100%

2 | NORTH ELEVATION - DEMO 3/16" = 1'-0"

NO DEMO AT FRONT FACADE (0%)

3 | SOUTH ELEVATION - DEMO 3/16" = 1'-0"




600 SQ FT DEMO (1321 SQ FT. FACADE TOTAL)

4 | WEST ELEVATION - DEMO 3/16" = 1'-0"


EXTERIOR ELEVATIONS -EXISTING/DEMO

PROJECT STATUS 1.28.2025

A3.1

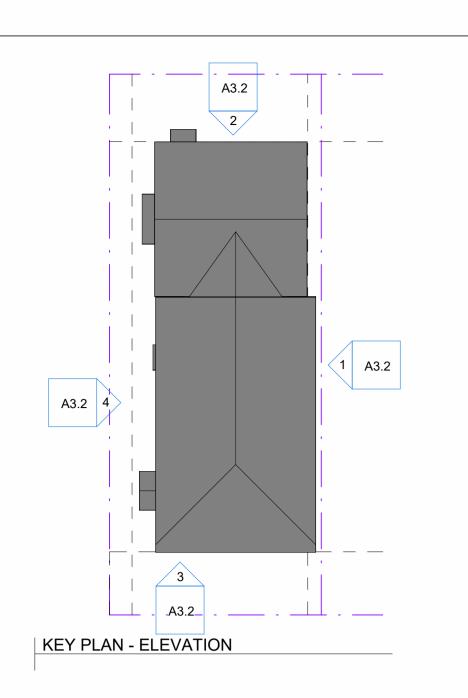

3 SOUTH ELEVATION - PROPOSED 3/16" = 1'-0"

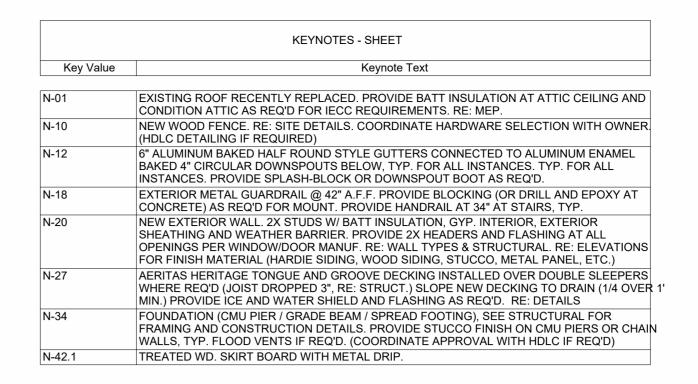




2nd

PLEX - ADDITION / RENOVATION

MFA 4PLEX - ADDITION / RENOVAT 7229 Zimpel St. New Orleans LA, 70118

1 EAST ELEVATION - PROPOSED
3/16" = 1'-0"

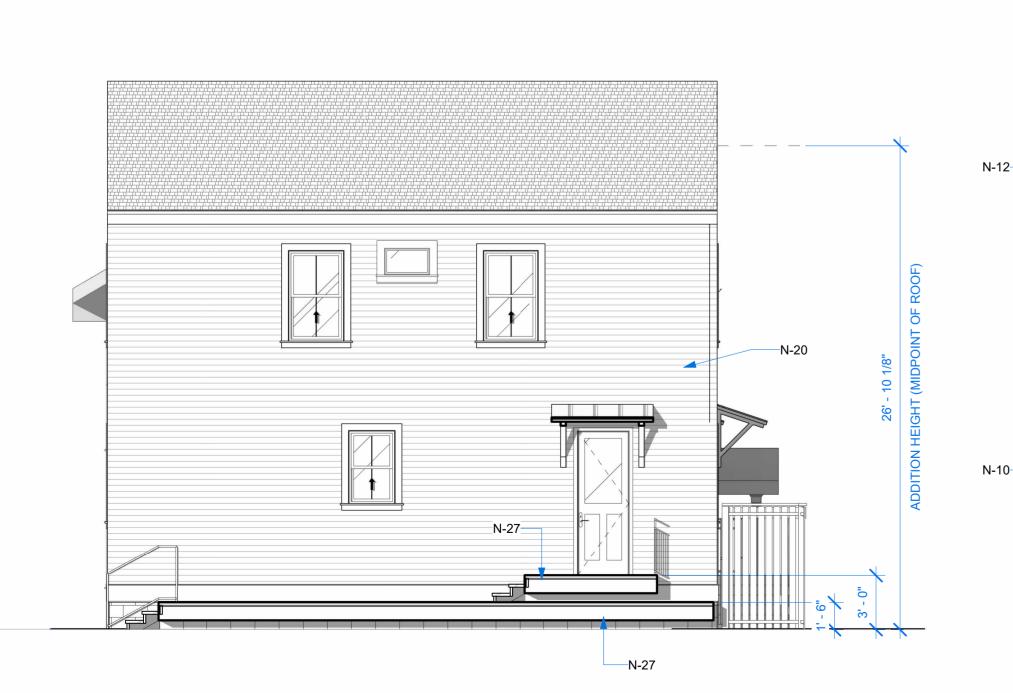

EXISTING TO

REMAIN. NEW
PAINT / REPAIRS
AS REQ'D

EXISTING TO REMAIN. NEW PAINT / REPAIRS AS REQU

EXISTING TO REMAIN. NEW PAINT / REPAIRS AS REQ'D

> EXTERIOR ELEVATIONS -PROPOSED

PROJECT STATUS
ate 1.28.2025

4 WEST ELEVATION - PROPOSED
3/16" = 1'-0"

2 NORTH ELEVATION - PROPOSED
3/16" = 1'-0"

A3.2







7301 OAK ST.











7604 FRERET ST.

7328 PLUM ST



PROPOSED REAR ADDITION AT 2771 ZIMPEL ST.

No.	Description
	NOT P
	46
	40 KR
	CONS
	\


A3.3

03/25/25

PROJECT STATUS

NEIGHBORHOOD MASSING

7201 OAK ST.

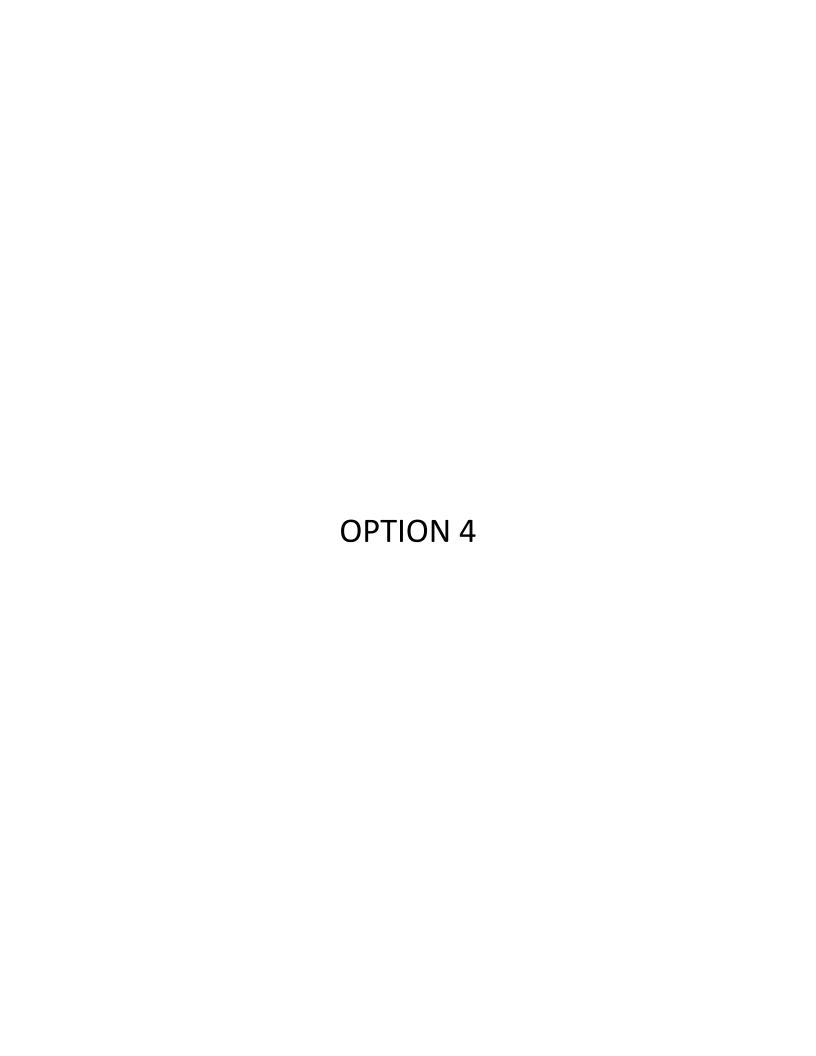

CPC DRAWINGS

SMFA 4PLEX - ADDITION / RENOVATION

7229 Zimpel St. New Orleans LA, 70118

OAK ST.

3' - 0"

SIDE YARD

NEW LOT A

2STORY **ADDITION AT** REAR

EXISTING

BUILDING

ZIMPEL ST.

SITE PLAN- PROPOSED - COVER

1" = 10'-0"

· • • • • • • • V V V · • • • •

v v v v

5' - 0"

CORNER-SIDE YARD

43' - 0"

NEW LOT B



		SHEET LIST			
Sheet	<u>.</u>	Sheet Issue	Current	Current	Current Revision
Number	Sheet Name	Date	Revision	Revision Date	Description
A3.3	NEIGHBORHOOD MASSING	03/25/25			
ARCHITE	CTURAL				
A1.1	SITE PLAN - EXIST & PROPOSED	1.28.2025			
A2.1	FLOOR PLANS - EXISTING/DEMO	1.28.2025			
A2.2	FLOOR PLANS - PROPOSED	1.28.2025			
A3.1	EXTERIOR ELEVATIONS - EXISTING/DEMO	1.28.2025			
A3.2	EXTERIOR ELEVATIONS - PROPOSED	1.28.2025			
TITLE					
T1.1	TITLE SHEET	01/16/25			
ARCHITE	CTURE				
ASK-1	PRESENTATION PLANS	01/16/25			

Description

TITLE SHEET

PROJECT STATUS

01/16/25



Energy Code Compliance Summary IECC 2021

FENESTRATION U VALUE

FENESTRATION SHGC

Value	Keynote Text	COMPLIANCE METHOD	
7 3 3		PRESCRIPTIVE	
N-08 N-09	NEW PERVIOUS PAVERS THIS LOCATION NEW GRADING/SOD AS REQ'D.	RESCHECK (HTTP://WWW.ENERGYCODES.GOV/RESCHECK)	
N-17	EXTERIOR WD. STAIR TO MATCH WD. PORCH/DECK. TREATED FRAMING, TYP. RE: DETAILS / STRUCT.	COMCHECK (HTTP://WWW.ENERGYCODES.GOV/COMCHECK)	
N-27	AERITAS HERITAGE TONGUE AND GROOVE DECKING INSTALLED OVER DOUBLE SLEEPERS WHERE REQ'D (JOIST	BUILDING AREA	
	DROPPED 3", RE: STRUCT.) SLOPE NEW DECKING TO DRAIN (1/4 OVER 1' MIN.) PROVIDE ICE AND WATER SHIELD AND FLASHING AS REQ'D. RE: DETAILS	TOTAL AREA (SQ FT) OF CONDITIONED SPACE	
		INSULATION VALUES (R402)	
		CEILNG/ROOF	
		WALLS	
		BASEMENT	
		FLOOR	
		SLAB	
		CRAWLSPACE	
		HEATING EQUIPMENT	
		ELECTRIC TBD. SEE GENERAL NOTE 1 BELOW.	
		GAS TBD. SEE GENERAL NOTE 1 BELOW.	
		COOLING EQUIPMENT	
		TBD. SEE GENERAL NOTE 1 BELOW.	

KEYNOTES - SHEET

SKYLIGHT U VALUE	U-VALUE
N/A	
GENERAL NOTES: 1. Missing information regarding A/C and Heating equipment and efficiency to be submitted prior to mechanical inspection.)	to be determined by sub-contractor according to Heat Load/Manual J calculations

TOTAL LOT AREA: 4720 SF

1600 SF. PERVIOUS / OPEN AT GRADE (31%)

NO CHANGES TO FRONT YARD PERMEABILITY: ETR

OPEN AREA: 31% (1465 SF)

ZONING: HU-RD2 OVERLAY: LOWER NINTH WARD REDEVELOPMENT INTERIUM ZONING DISTRICT

REQUIRMENTS: REQ: COMPLIANCE: MIN. LOT SIZE 2,250 SF MIN. PERMIABLE AREA FRONT YARD SETBACK AVG SURROUNDING (NONE) YES SIDE YARD SETBACK YES REAR YARD SETBACK 20% of lot depth or 15, whichever is YES PARKING*

ZONING HU-RD2

EXISTING MULTI FAMILY BUILDING CONVERTED INTO SMFA AFFORDABLE 4-PLEX. 3 NEW UNITS ON REAR, LESS THAN FRONT FACADE TO REMAIN. NEW MEP **THROUGHTOUT**

ADDITION / STRUCTURAL RENO

SFM, LEVEL OF ALTERATION

JAMES SPALT

LEVEL 4

7229 ZIMPLE ST **NEW ORLEANS LA 70118** JS@NDVRPARTNERS.COM

CLIMATE ZONE 2A FOR ORLEANS

CHECK

VALUE

ENTER R VALUE

EFFICIENCY (BTU'S/RATING)

TBD. SEE GENERAL NOTE 1 BELOW.

EFFICIENCY (BTU/SEER)

U-VALUE

SHGC

ZACH SMITH CONSULTING & DESIGN 1000 S NORMAN C FRANCIS PKWY NEW ORLEANS, LA 70125 504-383-3748 ZACH@ZACHSMITHCONSULTING.COM

MEP ENGINEER

AP DESIGN GROUP

504-410-5322 JJUNEAU@AP-ENG.COM

STRUCTURAL/CIVIL ENGINEER JOSHUA JUNEAU, PE

STORAGE)

OCCUPANCY TYPE:

• RESIDENTIAL STR IZD

PROPOSED DEVELOPMENT:

CONSTRUCTION TYPE:

IBC: RESIDENTIAL (R-2) NFPA: RESIDENTIAL, GROSS SF: 6026 (INCLUDING UNDER HOUSE

SPRINKLERED / FIRE ALARM: YES / YES

APPLICABLE CODES:

• 2021 IBC WITH NEW ORLEANS CODE ADOPTIONS

HDLC DISTRICT: NOHDLC UPTOWN PARTIAL

IBC/IFC: NFPA: COMMON TERMINOLOGY:

TYPE V-A V (000) PROTECTED COMBUSTIBLE

NEW LOT B DIMENSIONS: 47' X 120'

(BUILDINGS, STRUCTURES, APPURTENANCES AND PARTS THEREOF BE DESIGNED TO WITHSTAND A BASIC (NOMINAL) WIND SPEED OF 130 MPH, EXPOSURE B, IN ACCORDANCE WITH 2021 IBC, SECTION 1609)

ZONING DISTRICT: HU-RD2 HISTORIC URBAN TWO-FAMILY RESIDENTIAL

UNIVERSITY AREA OFF-STREET PARKING OVERLAY DISTRICT

• 2021 INTERNATIONAL MECHANICAL CODE

• 2021 LOUISIANA STATE PLUMBING CODE • NFPA 70, 2020 NATIONAL ELECTRIC CODE

 2021 INTERNATIONAL FUEL CODE • 2021 INTERNATIONAL ENERGY CONSERVATION CODE

• 2021 INTERNATIONAL EXISTING BUILDING CODE

PROJECT INFORMATION

THE GENERAL CONTRACTOR IS RESPONSIBLE TO SUPPLY ALL SUBCONTRACTORS WITH CONSTRUCTION DRAWINGS AND SPECIFICATIONS NECESSARY TO BID AND/OR CONSTRUCT THIS PROJECT.

TO THE GENERAL CONTRACTOR AND ALL SUBCONTRACTORS: ALL CONTRACTORS ARE RESPONSIBLE TO NOTIFY THE ARCHITECT OF ANY ERRORS, OMISSIONS OR DISCREPANCIES PRIOR TO MAKING ANY CHANGES TO THE CONSTRUCTION DOCUMENTS.

ALL DIMENSIONS ON THE FLOOR PLANS, UNLESS OTHERWISE NOTED, ARE TAKEN FROM INSIDE FACE OF STUDS OF EXTERIOR WALLS, CENTER OF STUDS OF NEW INTERIOR PARTITIONS, FACES OR CENTERLINE OF STRUCTURAL COLUMNS, AND FACES OF EXISTING WALLS.

IN ACCORDANCE WITH GENERALLY ACCEPTED CONSTRUCTION PRACTICES, THE CONTRACTOR WILL BE SOLELY AND COMPLETELY RESPONSIBLE FOR CONDITIONS OF THE JOB SITE, INCLUDING SAFETY OF ALL PERSONS AND PROPERTY DURING PERFORMANCE OF WORK. THIS REQUIREMENT WILL APPLY CONTINUOUSLY AND NOT BE LIMITED TO NORMAL WORKING HOURS. THE CONTRACTOR SHALL TAKE ALL NECESSARY PRECAUTIONS TO INSURE THE SAFETY OF THE PUBLIC AND/OR WORK PERSONS ON THE JOB TO PREVENT ACCIDENTS OR INJURY TO ANY PERSON ON, ABOUT OR ADJACENT TO THE PREMISES. THE CONTRACTOR SHALL COMPLY WITH ALL LAWS, ORDINANCES, CODES, RULES AND REGULATIONS RELATIVE TO SAFETY AND THE PREVENTION OF ACCIDENTS.

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PRIOR TO THE SHUT-DOWN OR TYING INTO ANY UTILITY, APPROVAL SHALL BE OBTAINED FROM THE OWNER'S

REPRESENTATIVE. COORDINATE WITH OWNER'S REPRESENTATIVE THE LOCATION OF CONTRACTOR'S EQUIPMENT AND MATERIAL

THE CONSTRUCTION DRAWINGS CONTAIN INFORMATION FOR MULTIPLE CONTRACTORS. OWNER PROVIDED AND INSTALLED ITEMS ARE SHOWN FOR INFORMATIVE PURPOSES. THE GENERAL CONTRACTOR SHALL VERIFY OWNER PROVIDED AND INSTALLED ITEMS AND COORDINATE INSTALLATION WITH OWNER'S REPRESENTATIVE TO AVOID CONFLICTS OR DISCREPANCIES.

CONTRACTOR SHALL PROVIDE AND INSTALL ALL MATERIALS IN ACCORDANCE WITH ALL LOCAL, STATE, AND FEDERAL

ALL PERMIT FEES SHALL BE PAID BY CONTRACTOR.

CONTRACTOR SHALL BE RESPONSIBLE FOR AND PAY FOR ALL UTILITY DEPOSITS, IMPACT FEES AND CONNECTION

GENERAL NOTES - PROJECT

DEMO AT SIDES AND REAR 300 SF (RIGHT) 550 (REAR) 600 (LEFT)

3192 SF TOTAL SF (SIDES AND REAR) 1450 TOTAL DEMO (45%) - NOT TO EXCEED 49%

> LESS THAN 50% DEMO AT ROOF 982 SF DEMOLISHED OF 2617 (37%)

OAK ST. 90' - 0"


ZIMPEL ST.

St. , 70118

SITE PLAN - EXIST & PROPOSED

PROJECT STATUS 1.28.2025

A1.1

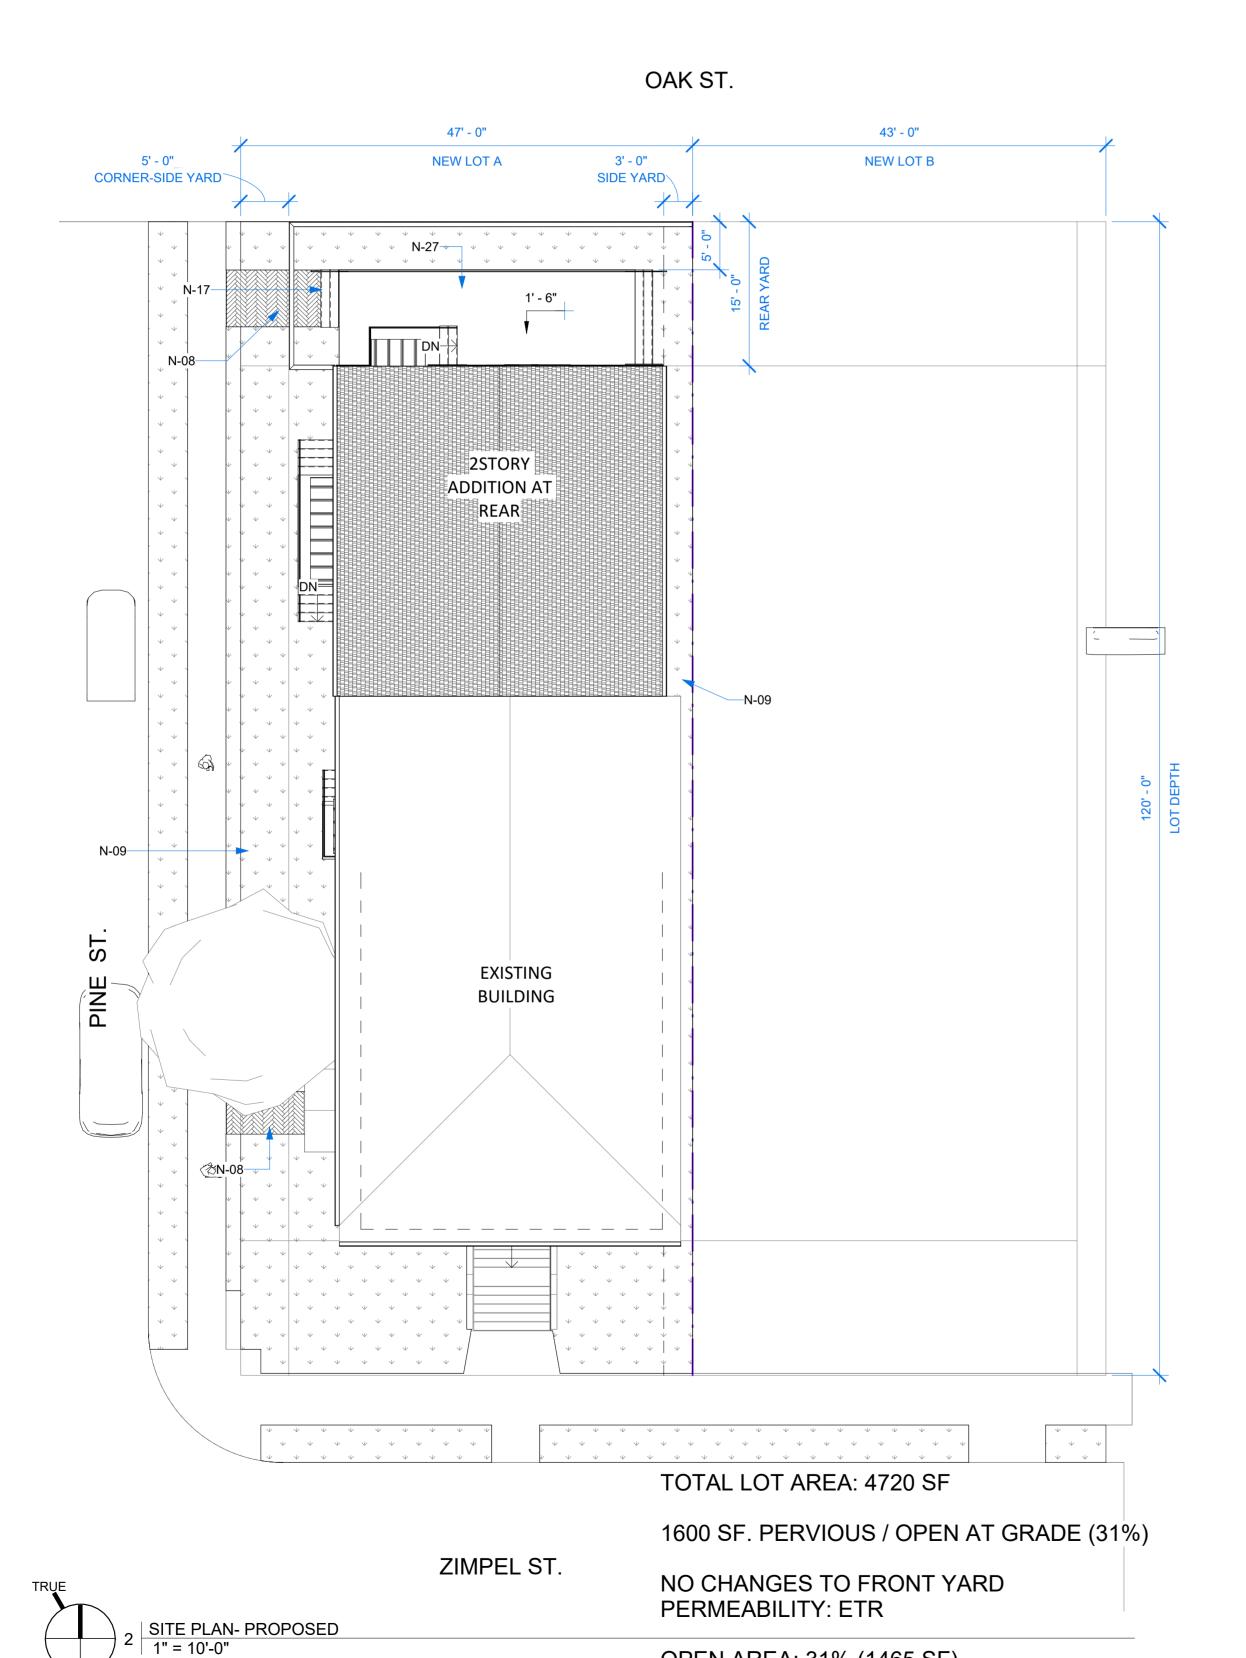

OPEN AREA: 31% (1465 SF)

SITE PLAN- EXISTING 1" = 10'-0"

Description

FLOOR PLANS -EXISTING/DEMO

PROJECT STATUS

1.28.2025

A2.1

30' - 11 1/4" ____________ 5' - 0" 7' - 6" STORAGE = 1,076 SF

2ND FLOOR

2 | 2ND FLOOR PLAN - EXISTING/DEMO 3/16" = 1'-0"

N-43

1ST FLOOR

1 | 1ST FLOOR_PLAN - EXISTING/DEMO 3/16" = 1'-0"

DEMO AT SIDES AND REAR 300 SF (RIGHT) 600 (LEFT)

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- CONTRACTOR TO REPAIR AS REQUIRED ALL AFFECTED ADJOINING AREAS TO MATCH NEW
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GENERAL NOTES - DEMO

1/8" = 1'-0"

47' - 0"

KEYNOTES - SHEET Key Value EXTERIOR WD GUARDRAIL @ 36" A.F.F. PROVIDE BLOCKING (OR DRILL AND EPOXY AT CONCRETE) AS REQ'D FOR MOUNT AERITAS HERITAGE TONGUE AND GROOVE DECKING INSTALLED OVER DOUBLE SLEEPERS WHERE REQ'D (JOIST DROPPED 3", RE: STRUCT.) SLOPE NEW DECKING TO DRAIN (1/4 OVER 1 MIN.) PROVIDE ICE AND WATER SHIELD AND FLASHING AS REQ'D. RE: DETAILS TILE FLOORS AT THIS LOCATION, CONTRACTOR TO COORDINATE SELECTIONS AND GROUT COLOR WITH OWNER PRIOR TO PURCHASE AND INSTALLATION. PROVIDE CEMENT BACKER AS REQ'D AT SHOWER SURROUNDS AND BASE. NEW SINK AT COUNTERTOP. COORDINATE SELECTION WITH OWNER. PROVIDE GARBAGE DISPOSAL AND BUTTON (ELEC OUTLET) AT KITCHEN SINKS, TYP. COORDINATE FAUCET GAS (OR ELEC.) RANGE OVEN. PROVIDE HOOD EXHAUST AT WALL (OR WITH DOWNDRAFT HOOD UNDER JOISTS) GC COORDINATE EXHAUST ROUTING TO EXISTING HOOD VENTS WASHER AND GAS (OR ELECTRIC) DRYER AT THIS LOCATION; APPLIANCE TO BE SELECTED BY OWNER, CONTRACTOR TO COORDINATE PRIOR TO PURCHASE AND INSTALL. PROVIDE DRAIN PAN AT UNDERSIDE OF WASHER. CONTRACTOR TO PROVIDE PROTECTION UNTIL FINAL COMPLETION. TO BE TURNED OVER AS NEW, FREE OF BLEMISHES / DENTS. PROVIDE POWER / OUTLET AND EXHAUST AS REQ'D. COUNTER-TOP. COORDINATE SELECTION WITH OWNER. CABINETRY, STONE, AND FIXTURES TO BE SELECTED BY OWNER; CONTRACTOR TO COORDINATE SELECTIONS & INSTALLATION WITH CABINET, STONE, AND FIXTURE PROVIDERS. PROVIDE PROTECTION FOR EACH AFTER INSTALL.

4 UNITS

2X 3 BED / 2.5 BATH @ 1150 SF INTERIOR 1X 2 BED / 2.5 BATH @ 737 SF INTERIOR 1X 3BED / 2 BATH @ 950 SF (EXISTING FOOTPRINT)

3987 SF LIVING TOTAL (INTERIOR)

330 SF REAR DECK

5030 SF GROSS

250 SF EXISTING FRONT PORCH 1076 EXISTING GROUND FLOOR STORAGE

SECTION 114000 - KITCHEN APPLIANCES

1.1 SUMMARY: PROVIDE AND INSTALL KITCHEN APPLIANCES AS SPECIFIED AND SHOWN ON THE

1.2 SUBMITTALS: SUBMIT PRODUCT DATA SHEETS FOR EACH APPLIANCE, INCLUDING MANUFACTURER, MODEL NUMBER, AND PERFORMANCE SPECIFICATIONS. PROVIDE INSTALLATION INSTRUCTIONS AND WARRANTY INFORMATION FOR OWNER APPROVAL PRIOR TO PURCHASING.

1.3 QUALITY ASSURANCE: APPLIANCES TO BE FROM MANUFACTURERS WITH A MINIMUM OF 5 YEARS OF INDUSTRY EXPERIENCE AND POSITIVE REVIEWS. ENSURE APPLIANCES COMPLY WITH RELEVANT SAFETY AND ENERGY STAN® RATINGS.

2. PRODUCTS: SEE INDIVIDUAL KEY NOTES FOR PRODUCTS 2.1 PERFORMANCE CRITERIA:

ENERGY EFFICIENCY: ALL APPLIANCES TO MEET OR EXCEED [INSERT SPECIFIC ENERGY EFFICIENCY STANDARDS, E.G., ENERGY STAR®] TO MINIMIZE ENERGY CONSUMPTION AND OPERATIONAL COSTS. DURABILITY: APPLIANCES TO BE CONSTRUCTED OF HIGH-QUALITY MATERIALS FOR LONG-TERM RELIABILITY AND RESISTANCE TO TYPICAL WEAR AND TEAR.

NOISE LEVELS: APPLIANCES TO OPERATE WITHIN ACCEPTABLE NOISE LEVELS, ENSURING MINIMAL DISTURBANCE IN APARTMENT SETTINGS. [INSERT SPECIFIC NOISE LEVELS IF APPLICABLE, E.G.,

EASE OF USE: APPLIANCES TO FEATURE USER-FRIENDLY CONTROLS AND INTERFACES, ENSURING EASE OF OPERATION FOR ALL RESIDENTS.

3.1 INSTALLATION: INSTALL APPLIANCES ACCORDING TO MANUFACTURERS INSTRUCTIONS AN LOCAL CODES. VERIFY PROPER OPERATION AND ADJUST SETTINGS AS NEEDED. ALL POWER/WATER CONNECTORS TO BE PROVIDED. 3.2 TESTING: TEST ALL APPLIANCES TO ENSURE THEY ARE OPERATING CORRECTLY AND

- BATHROOM FAUCET: B.O.D. MOEN DOUBLE HANDLE CENTERSET BATHROOM FAUCET FROM THE BRANTFORD COLLECTION (VALVE INCLUDED). MODEL: 66610 & SINK BASE BOD: 30 IN. W X 19 IN. D X 33 IN. H SINGLE SINK FREESTANDING BATH VANITY IN PEARL GRAY WITH WHITE CULTURED MARBLE TOP
- WATER CLOSET B.O.D. GLACIER BAY, 12 INCH ROUGH IN TWO-PIECE 1.28 GPF SINGLE FLUSH ELONGATED TOILET IN WHITE SEAT INCLUDED
- (3) COUNTERTOP 2CM GRANITE W/BACKSPLASH, OWNER TO CHOOSE COLOR
- REFIGERATOR: B.O.D. LG, 30 IN. W 20 CU. FT. TOP FREEZER REFRIGERATOR W/ MULTI-AIR FLOW AND REVERSIBLE DOOR IN STAINLESS STEEL, ENERGY STAR
- (5) KITCHEN SINK: STANDARD 30" SINGLE BOWL UNDERMOUNT KITCHEN SINK. STAINLESS STEEL.
- REFIFERATOR: B.O.D. FRIGIDAIRE, 30 IN. 5 BURNER ELEMENT FREESTANDING ELECTRIC RANGE IN BLACK WITH EVENTEMP AND STEAM CLEAN
- MICROWAVE: B.O.D. GE, 1.6 CU. FT. OVER-THE-RANGE MICROWAVE IN STAINLESS STEEL. RE-CIRCULATING VENT CONFIGURATION.
- RANGE: B.O.D. GE 30 IN. 4 BURNER ELEMENT FREE-STANDING ELECTRIC RANGE IN STAINLESS STEEL
- CABINETS: B.O.D. PAINTED WOOD WITH A MINIMUM THICKNESS OF ¾ INCH FOR DOORS AND ½ INCH 9 FOR CABINET BOXES. SOFT CLOSERS AND HARDWARE INCLUDED.
- SHOWER: CUSTOM BUILT SHOWER SURROUND. SCHLUTER-SHOWER SYSTEM WITH CEMENT BOARD 10 SURROUND CLAD IN SUBWAY TILE. FACUET: B.O.D. DELTA FOUNDATIONS SINGLE-HANDLE 1-SPRAY SHOWER FAUCET IN CHROME (VALVE INCLUDED). PROVIDE 5/16 IN. TEMPERED GLASS SHOWER DOOR,

PRODUCT BASIS OF DESIGN (B.O.D.) SELECTIONS

2nd

/ RENOV St. 70

Description

FLOOR PLANS -PROPOSED

PROJECT STATUS 1.28.2025

3 2ND FLOOR BFE

LIVING / KITCHEN

BED 3 D206

BED 3 B205

UNIT 4

(D)

-N-48.4

UNIT 3

(C)

UNIT 2

(B)

3/2 = 865 SF

LAUNDRY

ROOF 30' - 0"

2ND FLOOR CLG. 17' - 9"

2ND FLOOR BFE 13' - 0"_G. BFE 12' - 0"

2ND FLOOR 1ST FLOOR CLG. 6' - 6"

DEMO AT SIDES AND REAR 275 SF (RIGHT) 550 (REAR) 600 (LEFT)

KEYNOTES - SHEET Keynote Text

3192 SF TOTAL SF (SIDES AND REAR) 1425 TOTAL DEMO (45%) - NOT TO EXCEED 49%

LESS THAN 50% DEMO AT ROOF 982 SF DEMOLISHED OF 2617 (37%)

229 Zimpel St. Orleans LA, 70118

ADDITION / RENOVATION

275 SQ FT DEMO (1321 SQ FT. FACADE TOTAL) - 20%

Î

1 EAST ELEVATION - DEMO 3/16" = 1'-0"



550 SQ FT DEMO (550 SQ FT. FACADE TOTAL) - 100%

2 | NORTH ELEVATION - DEMO 3/16" = 1'-0"

NO DEMO AT FRONT FACADE (0%)

3 | SOUTH ELEVATION - DEMO 3/16" = 1'-0"




600 SQ FT DEMO (1321 SQ FT. FACADE TOTAL)

4 | WEST ELEVATION - DEMO 3/16" = 1'-0"

EXTERIOR ELEVATIONS -EXISTING/DEMO

PROJECT STATUS 1.28.2025

A3.1

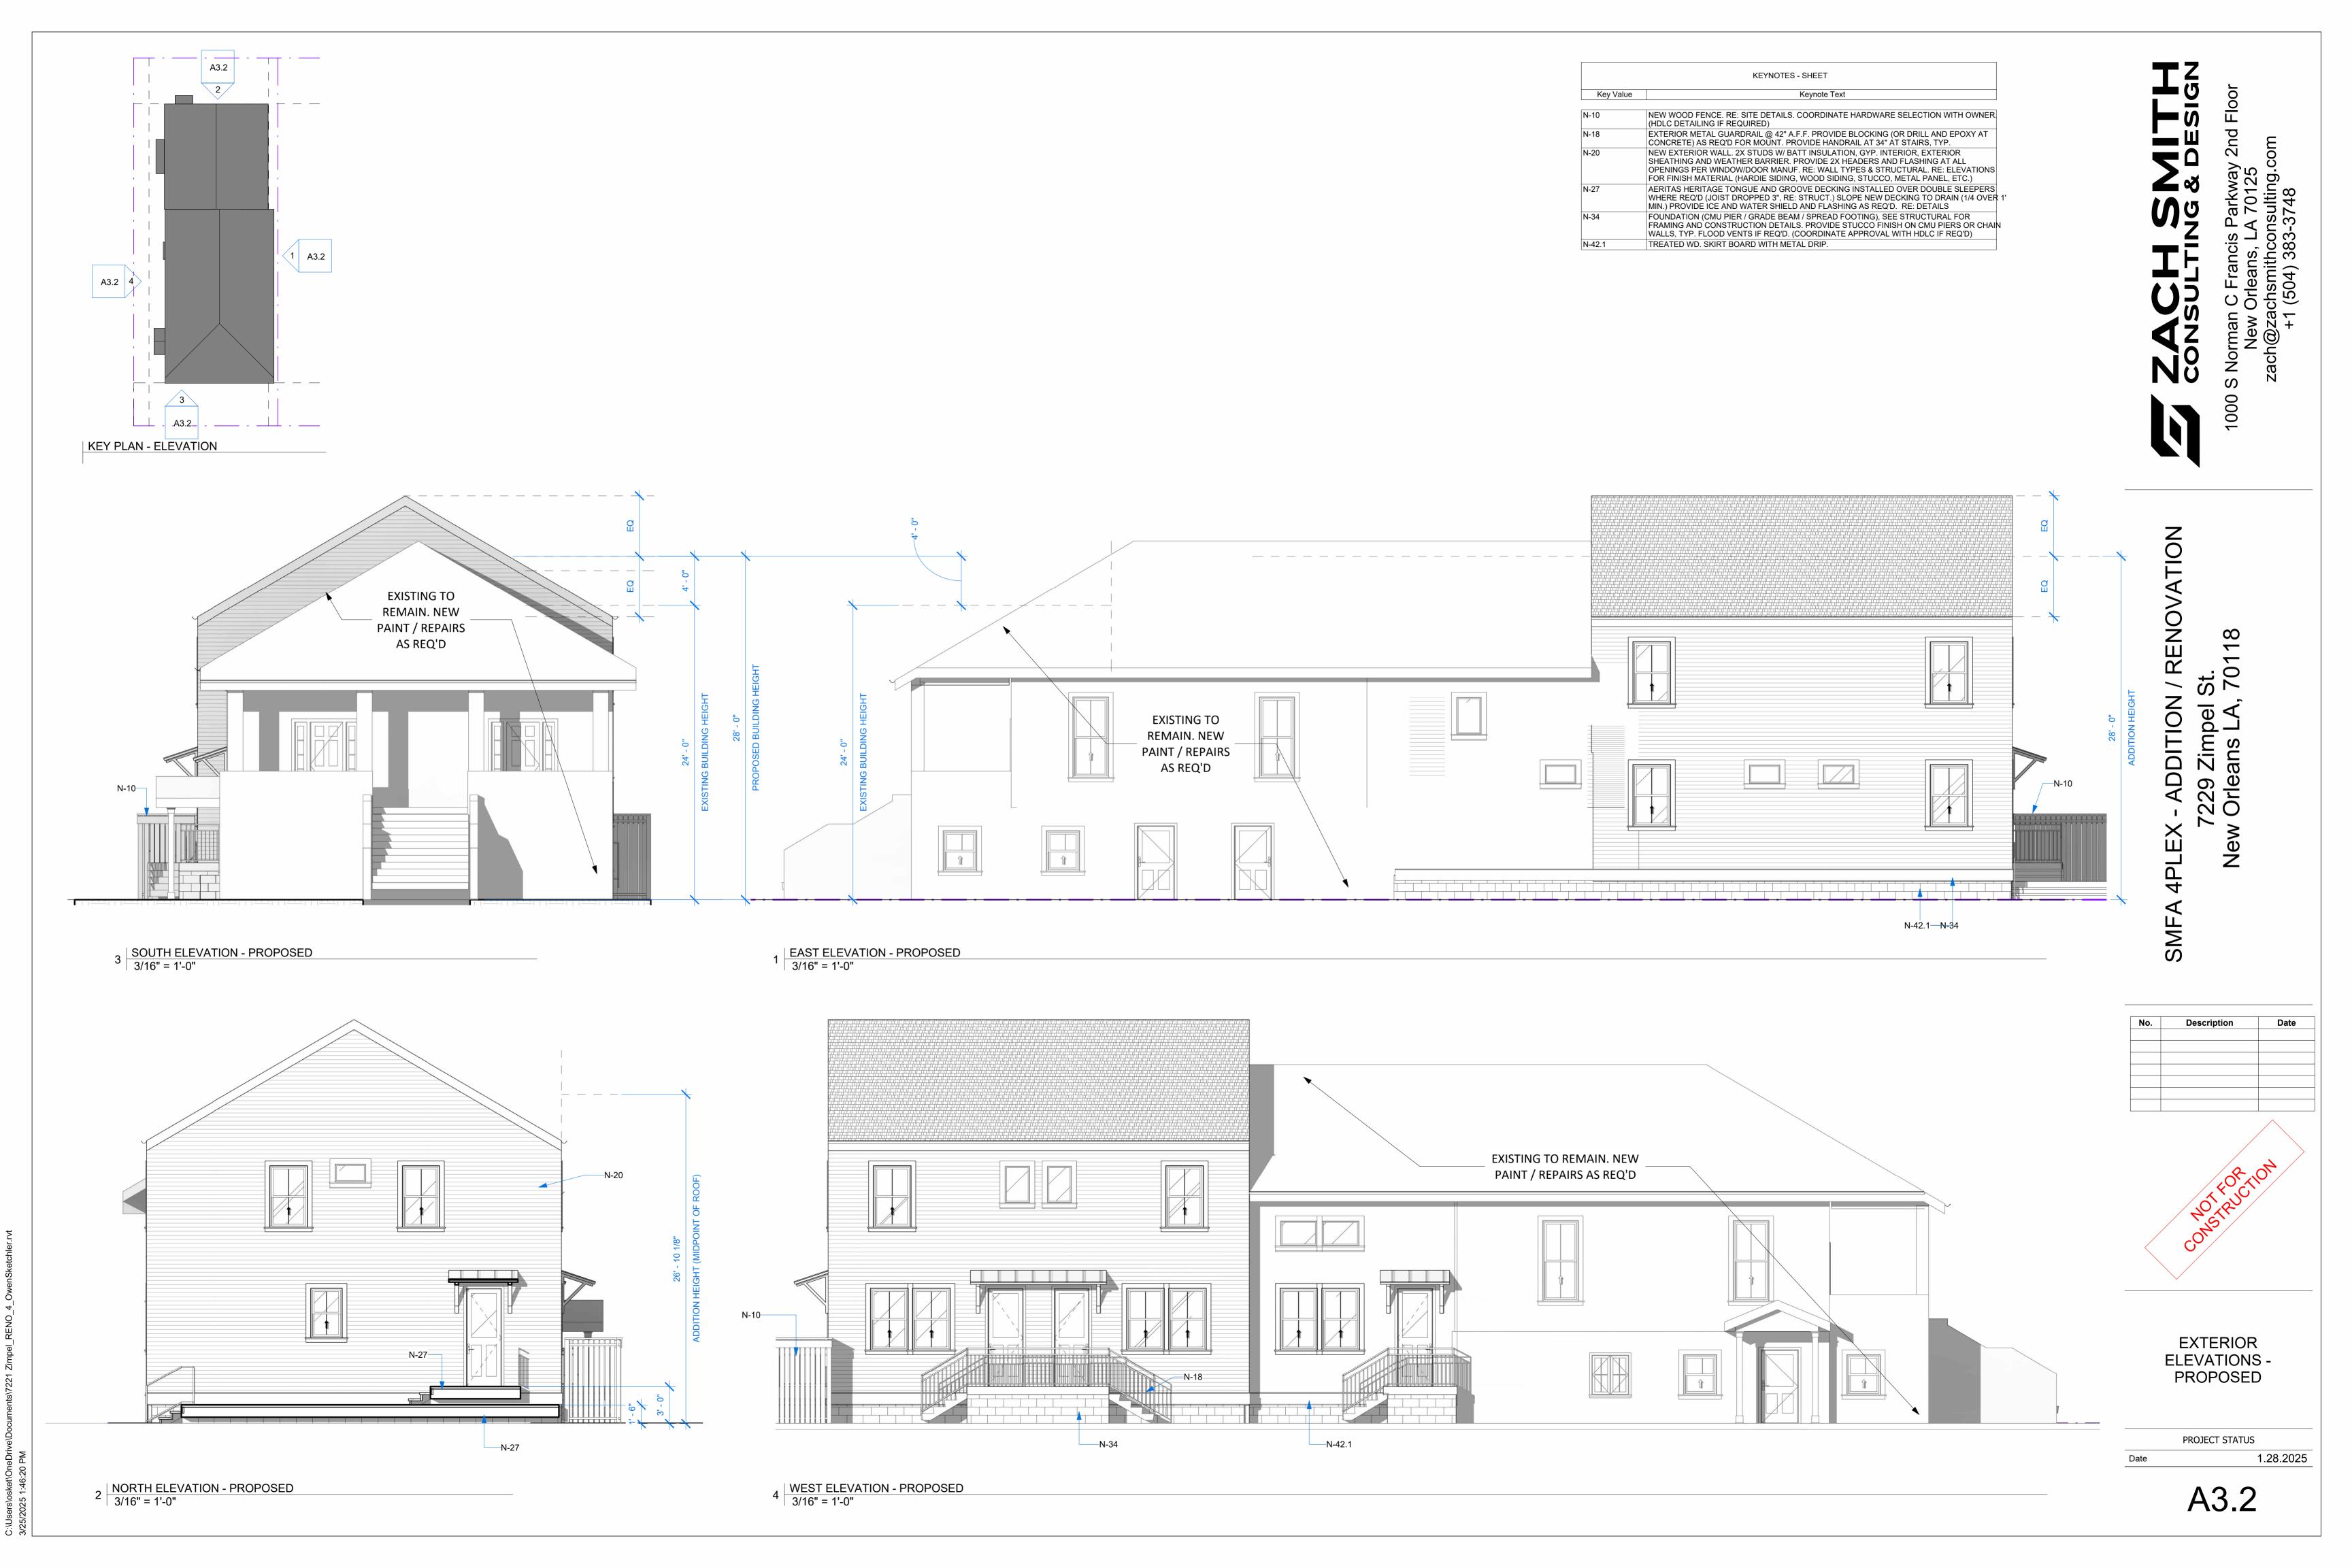








7301 OAK ST.









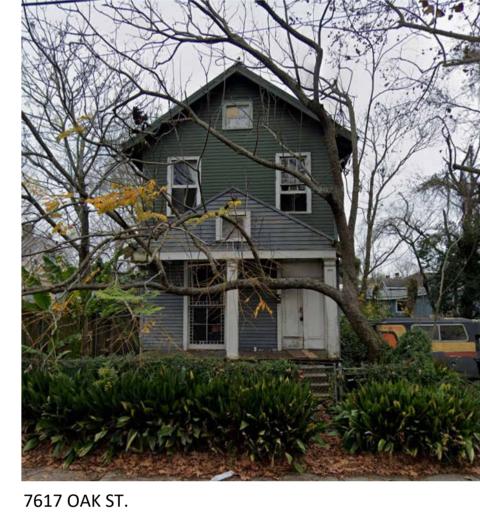

7201 OAK ST.



PROPOSED REAR ADDITION AT 2771 ZIMPEL ST.

Description	Dat
18° A	,0 ¹² /
/ X 4 (C)	`/
	NOT FOR TOUCH

NEIGHBORHOOD MASSING

PROJECT STATUS 03/25/25

A3.3

