



DEVELOPMENT PLAN AND DESIGN REVIEW APPLICATION

Please submit complete applications via email to CPCinfo@nola.gov. Applicants without the ability to submit via email should contact (504) 658-7300 to make alternative arrangements. Incomplete applications will not be accepted and will be returned to the applicant. Review time depends on the complexity of the project and can take up to 90 days.

Type of application: ☒ Design Review

Interim Zoning Districts Appeal

Moratorium Appeal

Property Location _____

APPLICANT INFORMATION

Applicant Identity: ☐ Property Owner ☐ Agent

Applicant Name _____

Applicant Address _____

City _____ State _____ Zip _____

Applicant Contact Number _____ Email _____

PROPERTY OWNER INFORMATION

SAME AS ABOVE

Property Owner Name _____

Property Owner Address _____

City _____ State _____ Zip _____

Property Owner Contact Number _____ Email _____

PROJECT DESCRIPTION

NEW CONSTRUCTION OF A 15,900 SF ADDITION TO CHILDREN'S HOSPITAL NEW ORLEANS FOR A CHILD ENRICHMENT CENTER DEVOTED TO EXHIBIT SPACE FOR PATIENT AND VISITOR USE. TWO FLOORS OF THE ADDITION ARE LOCATED ADJACENT TO THE EXISTING CONCOURSE. THE PROJECT INCLUDES AN OCCUPIABLE ROOF DECK AND FLOOR OPENINGS IN THE EXHIBIT SPACE.

REASON FOR REVIEW (REQUIRED FOR DESIGN REVIEW)

Design Overlay District Review

- ☐ Character Preservation Corridor
- ☐ Riverfront Design Overlay
- ☒ Enhancement Corridor
- ☐ University Area Design Overlay
- ☐ Corridor Transformation
- ☐ Greenway Corridor
- ☐ Others as required

Non-Design Overlay District Review

- ☐ Development over 40,000 sf
- ☐ Public Market
- ☐ CBD FAR Bonus
- ☐ Wireless Antenna/Tower
- ☐ Educational Facility

- ☐ Changes to Approved Plans
- ☐ DAC Review of Public Projects
- ☐ Others as Required

ADDITIONAL INFORMATION

Current Use _____ Proposed Use _____

Square Number _____ Lot Number _____ Permeable Open Space (sf) _____

New Development? Yes ☒ No ☐ Addition? ☒ Yes ☐ No ☐ Tenant Width _____

Existing Structure(s)? ☒ Yes ☐ No ☐ Renovations? ☐ Yes ☒ No ☐ Building Width _____

Change in Use? Yes ☒ No ☐ Existing Signs? ☐ Yes ☒ No ☐ Lot Width (sf) _____

New Sign(s)? ☒ Yes ☐ No ☐ Lot Area (sf) _____ Building Area (sf) _____

Eskew Dumez Ripple⁺

21 January 2024

Design Advisory Committee
1300 Perdido St.
New Orleans, LA 70112

Re: Design Advisory Committee Submission Narrative

Walker's Imaginarium is a 15,900 square foot addition to The Children's Hospital Henry Clay Campus. The Imaginarium will be a child enrichment center devoted to exhibit space for both patient and visitor use. The project also includes an occupiable roof deck.



The proposed design meets all the applicable design standards in the EC Enhancement Corridor Overlay District. The proposed design is consistent with the context, character, scale and materials of the existing hospital campus, as it is attached to the main building. The addition is an extension of the brand new main building. As you will see in the design, it will be difficult to see where the existing hospital ends and the addition begins.

R. Allen Eskew, 1948-2013
Mark Ripple, Retired 2022

A Professional Corporation
365 Canal Street Suite 3150
New Orleans, LA 70130

eskewdumezripple.com

Due to Children's Hospital's recent campus transformation, the entire hospital campus is pedestrian and bicycle friendly, and this addition compliments that. The addition continues the curve of the building to Henry Clay, bringing the building closer to the sidewalk and street. Additionally, the proposed addition is at the back of the campus, along the existing hospital loading docks and railroad tracks, far from the surrounding residential areas.

The proposed Imaginarium is also consistent with applicable Article 15 building design standards. The public entrance is clearly articulated from the structure mass, with its raised height and color distinction. The design features many decorative elements that define the entrances and pedestrian routes. The proposed façade uses architectural features to avoid the appearance of a blank wall. Using yellow metal louvers and glazing in variations of opacity, the entrance façade is clearly defined while honoring the favorite color of Walker Berry, the founder of the Imaginarium concept and the Kids Join the Fight Foundation. Overall, the Imaginarium will be a great addition to the Children's Hospital campus in both its use and design.



The images included on this sheet are to convey the general design intent of the project and may not be totally accurate, therefore, should not be considered part of the contract documents

WALKER'S IMAGINARIUM

200 HENRY CLAY AVENUE
NEW ORLEANS, LA 70118

ARCHITECT
EskewDumezRipple

MEP ENGINEER
IMC CONSULTING ENGINEERS

STRUCTURAL ENGINEER
MORPHY MAKOFSKY
INCORPORATED

CIVIL ENGINEER
MEYER ENGINEERS

EXHIBIT DESIGN PLANNER
GYROSCOPE INCORPORATED

LANDSCAPE ARCHITECT
SPACKMAN MOSSOP MICHAELS

COVER SHEET

1/16/2025 10:52:17 AM
Autodesk Docs://22003_Walkers Imaginarium/22003_ARCH_R04.rvt

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01-INFORMATION	6.9	EXTERIOR CURTAIN WALL AND STOREFRONT DETAILS	M2.1	FIRST FLOOR PLAN - HVAC	2.0.0	CREATIVE FLOWS & TROWS ZONE OVERVIEW	5.0.5	USED PUTTER BIN
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C1.2 ENLARGED SITE PLAN	8.2	INTERIOR ELEVATIONS	E1.0	ELECTRICAL NOTES, ABBREVIATIONS, AND SYMBOLS	2.1.7	CROWN	5.4.1	TRUSS BRIDGE
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C2.2 CIVIL DETAILS	8.4	INTERIOR DETAILS	E2.0.1	OVERALL ELECTRICAL PLAN - SMOKE EVACUATION SYSTEM	2.3.0	AIR THROWS - STRUCTURE	5.5.1	TREE FROG
C3.1 STORMWATER DETENTION TANK DETAILS	9.1	TOILET ROOMS	E2.0	ELECTRICAL PARTIAL PLAN FIRST FLOOR	2.3.1	AIR THROWS - SYSTEM	5.6.0	CRAWFISH RACING
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2.20 SECOND FLOOR PLAN	S6.2	BRACED FRAMES & DETAILS	0.0.0 INDEX		4.0.0	BAYOU BEAT ZONE OVERVIEW		
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6.3 WALL SECTIONS	P2.71	ENLARGED FLOOR PLANS - PLUMBING	1.1.0 ALL-STAR SPOTLIGHT		5.0.0	PUTT PUTT PARISHES ZONE OVERVIEW		
6.4 WALL SECTIONS	P4.0	SCHEDULES - PLUMBING	1.1.1 ALL-STAR SPOTLIGHT KIOSK		5.0.1	PUTT PUTT PARISHES ZONE PLAN		
6.5 EXTERIOR CURTAIN WALL	P5.1	RISERS - PLUMBING	1.1.2 ALL-STAR SPOTLIGHT KIOSK		5.0.2	PUTT PUTT PARISHES ZONE ELEVATIONS		
6.6 EXTERIOR STOREFRONT			1.2.0 MARCHING MUSIC		5.0.3	PUTT PUTT FURNITURE & ACCESSORIES		
6.7 EXTERIOR CURTAIN WALL			1.3.0 DANCE FLOOR		5.0.4A	PUTT ASSIST		
6.8 EXTERIOR CURTAIN WALL AND STOREFRONT	M1.0	MECHANICAL NOTES, ABBREVIATIONS, AND SYMBOLS	1.4.0 MOVES & GROVES MURAL		5.0.4B	PUTT ASSIST		

IECC 2021 ENERGY CODE COMPLIANCE, REF. C103.2

CATEGORY	REQUIRED	PROPOSED
1. ENERGY COMPLIANCE PATH, C401.2.1	PRESCRIPTIVE OR TOTAL BUILDING PERFORMANCE (ENERGY MODEL)	PRESCRIPTIVE
COMCHECK	YES	WILL PROVIDE
TOTAL AREA (SF) OF CONDITIONED SPACE		12,928 SF
INSULATION CERTIFICATE, C401.3	CERTIFICATE REQUIRED	WILL ACQUIRE UPON COMPLETION
2. INSULATION MATERIALS AND THEIR R-VALUES, C402.1.3		
INSULATION R-VALUES	ROOF: R-25ci WALLS: R-13 + R-5ci (ABOVE GRADE)	ROOF: R-25ci (TAPERED POLYISO) WALLS: R-13+R-6.3ci (BATT & MINERAL FIBER BOARD)
	SLAB-ON-GRADE FLOOR: NR	SLAB-ON-GRADE FLOOR: NR
3. FENESTRATION U-FACTORS AND SOLAR HEATH GAIN COEFFICIENTS (SHGC), C402.4		
FENESTRATION U-VALUES	0.45 (FIXED) 0.60 (OPERABLE) 0.77 (ENTRANCE DOORS)	FIXED: 0.37-0.42 OPERABLE: N/A ENTRANCE DOORS: 0.77
FENESTRATIONS SHGC	PF<0.2: 0.25 (FIXED), 0.23 (OPERABLE) 0.2+PF<0.5: 0.30 (FIXED), 0.28 (OPERABLE) PF<0.5: 0.40 (FIXED), 0.37 (OPERABLE)	FIXED: 0.24, OPERABLE: N/A FIXED: 0.24, OPERABLE: 0.23 FIXED: 0.37, OPERABLE: 0.31
4. AREA-WEIGHTED U-FACTOR AND SOLAR HEAT GAIN COEFFICIENT (SHGC) CALCULATIONS, C402.4.3.4		
INSULATION U-VALUES	ROOF: U-0.039 WALLS: U-0.077 (ABOVE GRADE) FLOOR: F-0.73	ROOF: U-0.039 (TAPERED POLYISO) WALLS: U-0.07 (BATT & MINERAL FIBER BOARD) FLOOR: NR
5. MECHANICAL SYSTEM DESIGN CRITERIA		SEE MEP DWGS, COMCHECK REPORT
6. MECHANICAL AND SERVICE WATER-HEATING SYSTEMS AND EQUIPMENT TYPES, SIZES AND EFFICIENCIES		SEE MEP DWGS, COMCHECK REPORT
7. ECONOMIZER DESCRIPTION		SEE MEP DWGS, COMCHECK REPORT
8. EQUIPMENT AND SYSTEM CONTROLS		SEE MEP DWGS, COMCHECK REPORT
9. FAN MOTOR HORSEPOWER (HP) AND CONTROLS		SEE MEP DWGS, COMCHECK REPORT
10. DUCT SEALING, DUCT AND PIPE INSULATION AND LOCATION		SEE MEP DWGS, COMCHECK REPORT
11. LIGHTING FIXTURE SCHEDULE WITH WATTAGE AND CONTROL NARRATIVE		SEE MEP DWGS, COMCHECK REPORT
12. LOCATION OF DAYLIGHT ZONES ON FLOOR PLANS		SEE MEP DWGS, COMCHECK REPORT
13. AIR BARRIER AND AIR SEALING DETAILS, INCLUDING LOCATION OF THE AIR BARRIER - BUILDING THERMAL ENVELOPE ASSEMBLIES WILL COMPLY WITH THE REQUIREMENTS OF SEC. C402.5		

LOCATION MAP



BUILDING INFORMATION

PROJECT ADDRESS	200 HENRY CLAY AVE NEW ORLEANS, LA 70118	FLOOD ZONE/FIRE ZONE	X
PROJECT DESCRIPTION	NEW CONSTRUCTION OF A 15,900 SF ADDITION TO CHILDREN'S HOSPITAL NEW ORLEANS FOR A CHILD ENRICHMENT CENTER DEVOTED TO EXHIBIT SPACE FOR PATIENT AND VISITOR USE. TWO FLOORS OF THE ADDITION ARE LOCATED ADJACENT TO THE EXISTING CONCOURSE. THE PROJECT INCLUDES AN OCCUPABLE ROOF DECK AND FLOOR OPENINGS IN THE EXHIBIT SPACE.	OCCUPANCY CLASSIFICATION (NONSEPARATED MIXED-USE) (IBC) ASSEMBLY A-3 (PRIMARY) (NFPA) ASSEMBLY (PRIMARY)	BUSINESS
BUILDING AREA	8,334 SF	CONSTRUCTION TYPE (IBC) TYPE IA (NFPA) TYPE I	EDUCATION
FIRST LEVEL	7,566 SF	FIRE PROTECTION	(IBC) STORAGE S-2 (NFPA) STORAGE
SECOND LEVEL	15,900 SF	MAJOR APPLICABLE CODES AND REGULATIONS (NOT LIMITED TO THE FOLLOWING)	PRIMARY STRUCTURAL FRAME 3 HR
TOTAL		INTERNATIONAL BUILDING CODE, 2021 EDITION WITH THE CITY OF NEW ORLEANS AMENDMENTS	BEARING WALLS 3 HR
		INTERNATIONAL MECHANICAL CODE, 2021 EDITION	EXTERIOR 3 HR
		INTERNATIONAL FUEL GAS CODE, 2021 EDITION	INTERIOR 3 HR
		NATIONAL ELECTRIC CODE, 2020 EDITION	NONBEARING WALLS AND PARTITIONS 0 HR (>10') 0 HR (<10')
		LOUISIANA STATE PLUMBING CODE, 2021 EDITION	EXTERIOR 0 HR
		NFPA LIFE SAFETY CODE, 2015	INTERIOR 0 HR
		INTERNATIONAL ENERGY CONSERVATION CODE, 2021 EDITION	FLOOR CONSTRUCTION 2 HR
		AMERICANS WITH DISABILITIES ACT ADAAG 2010	ROOF CONSTRUCTION 1.5 HR
ZONING CLASSIFICATION	MEDICAL CAMPUS (MC)	HAZARD OF CONTENTS	NFPA ORDINARY
LEGAL DESCRIPTION	BURTHEVILLE 3-6 SQ LOT C HENRY CLAY & TCHOUPITOULAS 782'VAR X 425'429 EXEMPT HOSPITAL '04 PERMIT FILE #68654 RESUBD 3-92 98 PERMITS	STAIRS AND SHAFTS	IBC 2 HR
BOUNDING STREETS	HENRY CLAY AVE & TCHOUPITOULAS ST & LEAKE AVE	IBC 712.1.9 TWO-STORY OPENINGS - OPENINGS COMPLY W// FOLLOWING: DOES NOT CONNECT MORE THAN TWO STORIES DOES NOT PENETRATE A HORIZONTAL ASSEMBLY THAT SEPARATES FIRE AREAS IS NOT CONCEALED WITHIN THE CONSTRUCTION OF A WALL OR FLOOR ASSEMBLY IS NOT OPEN TO A CORRIDOR IN GROUP I AND R OCCUPANCIES IS NOT OPEN TO A CORRIDOR ON NONSPRINKLERED FLOORS IS SEPARATED FROM FLOOR OPENINGS AND AIR TRANSFER OPENINGS SERVING OTHER FLOORS BY CONSTRUCTION CONFORMING TO REQUIRED SHAFT ENCLOSURES.	
SITE AREA	330,269 SF	NFPA 101 2015 EDITION: 8.6.9 UNENCLOSED OPENINGS 8.6.9.1 UNENCLOSED, VERTICAL OPENINGS NOT CONCEALED WITHIN THE BUILDING CONSTRUCTION SHALL BE PERMITTED AS FOLLOWS: (1) SUCH OPENINGS SHALL CONNECT NOT MORE THAN TWO ADJACENT STORIES (ONE FLOOR PIERCED ONLY). (3) SUCH OPENINGS SHALL BE SEPARATED FROM UNPROTECTED VERTICAL OPENINGS SERVING OTHER FLOORS BY A BARRIER COMPLYING WITH 8.6.5. (4) SUCH OPENINGS SHALL BE SEPARATED FROM CORRIDORS. (5) IN OTHER THAN APPROVED, EXISTING CONVENIENCE OPENINGS, SUCH OPENINGS SHALL BE SEPARATED FROM OTHER FIRE OR SMOKE COMPARTMENTS ON THE SAME FLOOR. (6) SUCH OPENINGS SHALL NOT SERVE AS A REQUIRED MEANS OF EGRESS. 8.6.9.2 WHERE PERMITTED BY CHAPTERS 11 THROUGH 43, UNENCLOSED VERTICAL OPENINGS CREATED BY CONVENIENCE STAIRWAYS SHALL COMPLY WITH ALL OF THE FOLLOWING: (1) THE CONVENIENCE STAIR OPENINGS SHALL NOT SERVE AS REQUIRED MEANS OF EGRESS. (2) THE BUILDING IS PROTECTED THROUGHOUT BY AN APPROVED, SUPERVISED AUTOMATIC SPRINKLER SYSTEM IN ACCORDANCE WITH SECTION 8.7. (3) THE CONVENIENCE STAIR OPENINGS SHALL BE PROTECTED IN ACCORDANCE WITH THE METHOD DETAILED FOR PROTECTION OF VERTICAL OPENINGS IN NFPA 13 (4) IN NEW CONSTRUCTION, THE AREA OF THE FLOOR OPENING SHALL NOT EXCEED TWICE THE HORIZONTAL PROJECTED AREA OF THE STAIRWAY. (5) FOR NEW CONSTRUCTION, SUCH OPENINGS SHALL NOT CONNECT MORE THAN FOUR CONTIGUOUS STORIES, UNLESS OTHERWISE PERMITTED BY CHAPTERS 11 - 43. PROJECT COMPLIES W/12.3.1 (ASSEMBLY SECTION OF NFPA 101) FOR CONVENIENCE OPENINGS WIN AN ASSEMBLY OCCUPANCY.	
PLUMBING FIXTURE COUNTS (IBC CHAPTER 29):			
WATER CLOSETS MEN:	A=3 = 1/125 (M) @ 183 OCCS = 1.46 B = 1/25 (M, 1ST 50') @ 9 OCCS = 0.24 E = 1/50 (M) @ 9 OCCS = 0.18 S = 1/100 (M) @ 1 OCCS = 0.01		
WATER CLOSETS WOMEN:	A=3 = 1/65 (W) @ 183 OCCS = 2.82 B = 1/25 (W, 1ST 50') @ 9 OCCS = 0.24 E = 1/50 (W) @ 9 OCCS = 0.18 S = 1/100 (W) @ 1 OCCS = 0.01		
NUMBER OF WATER CLOSETS REQUIRED = 2 MALE & 4 FEMALE			
NUMBER OF WATER CLOSETS PROVIDED = 4 ALL GENDER			
LAVORATORIES:	A=3 = 1/200 @ 365 OCCS = 1.825 B = 1/40 @ 11 OCCS = 0.275 E = 1/50 @ 18 OCCS = 0.360 S = 1/100 @ 1 OCCS = 0.010		
NUMBER OF LAVORATORIES REQUIRED = 3			
NUMBER OF LAVORATORIES PROVIDED = 8			
DRINKING FOUNTAINS:	A=3 = 1/500 @ 365 OCCS = 0.730 B = 1/100 @ 11 OCCS = 0.110 E = 1/100 @ 18 OCCS = 0.180 S = 1/1000 @ 1 OCCS = 0.001		
NUMBER OF DRINKING FOUNTAINS REQUIRED = 2			
NUMBER OF DRINKING FOUNTAINS PROVIDED = 2			
*NOTE: THIS PROJECT SUPPLEMENTS THE ADDITIONALLY REQUIRED WATER CLOSETS BY UTILIZING THE EXCESS FIXTURES LOCATED ON THE FIRST FLOOR OF THE EXISTING BUILDING. THE EXISTING BUILDING CONTAINS AN ADDITIONAL (7) MALE AND (7) FEMALE FIXTURES BEYOND WHAT WAS ORIGINALLY REQUIRED PER CODE. THESE FIXTURES ARE WITHIN THE ALLOWABLE 500' TRAVEL DISTANCE PER IBC CHAPTER 29.			

THESE DRAWINGS AND PROJECT MANUAL HAVE BEEN REVIEWED BY OUR OFFICE AND, TO THE BEST OF OUR KNOWLEDGE AND BELIEF, THEY COMPLY WITH ALL CITY REQUIREMENTS. WE SHALL OBSERVE THE WORK.

BY: *[Signature]* NO. 3650
NAME OF SIGNATORY LICENSE NUMBER

DRAFTING SYMBOLS

	DIRECTION OF 3D VIEW SHEET NUMBER ON WHICH 3D VIEW IS LOCATED 3D VIEW NUMBER		ROOM NAME ROOM NUMBER
	DIRECTION OF PHOTOGRAPH SHEET NUMBER ON WHICH PHOTOGRAPH IS LOCATED PHOTOGRAPH NUMBER		INDICATES SECTION OR DETAIL NO. 2 APPEARING ON THE SHEET NO. 6.2 WINDOW TYPE / LOUVER TYPE
	SECTION OR DETAIL NUMBER DIRECTION OF CUTTING PLANE SHEET NUMBER ON WHICH SECTION OR DETAIL IS DRAWN		DOOR OR OPENING NUMBER FINISH
	DIRECTION OF CUTTING PLANE LONGITUDINAL OR TRANSVERSE BUILDING SECTION NUMBER SHEET NUMBER ON WHICH LONGITUDINAL OR TRANSVERSE BUILDING SECTION IS DRAWN		PARTITION TYPE SMOKE PARTITION / FIRE RATING (HOURS). "S" INDICATES SMOKE PARTITION. PARTITION STC RATING (IF APPLICABLE)
	SURFACE SHOWN IN ELEVATION BUILDING ELEVATION NUMBER SHEET NUMBER ON WHICH BUILDING ELEVATION IS DRAWN		EXTERIOR WALL TYPE ("E" INDICATES EXTERIOR WALL)
	SURFACE SHOWN IN ELEVATION SHEET NUMBER ON WHICH BUILDING ELEVATION IS DRAWN CURTAINWALL / STOREFRONT ELEVATION NUMBER		REFERENCE NUMBER FOR EQUIPMENT, CONSTRUCTION, ETC. OR ANY INFORMATION TO BE CONVEYED WHICH IS REPETITIVE OR AVAILABLE SPACE PROHIBITS A WRITTEN DESCRIPTION OF ANY ITEM
	INTERIOR ELEVATION NUMBER SURFACE SHOWN IN ELEVATION SHEET NUMBER ON WHICH ELEVATION IS DRAWN		ITEMS NOT IN CONTRACT / FURNISHED BY OWNER / INSTALLED BY OWNER / INSTALLED UNDER THIS CONTRACT, ETC. (SEE CLARIFICATION OF THIS SYMBOL FOR ITS USE IN REGARD TO THIS PROJECT)
	SURFACE SHOWN IN ELEVATION SHEET NUMBER ON WHICH ELEVATION IS DRAWN INTERIOR ELEVATION NUMBER		SPECIFICATION REFERENCE (FOUND IN PROJECT MANUAL)
	DETAIL NUMBER AREA OF DETAIL SHEET NUMBER ON WHICH ENLARGED DETAIL IS DRAWN		SPECIFICATION REFERENCES ARE INDICATED FOR THE CONTRACTOR'S CONVENIENCE. LACK OF REFERENCE OR MISREFERENCE DOES NOT RELIEVE THE CONTRACTOR OF THE RESPONSIBILITY TO PROVIDE THAT MATERIAL
			NEW OR REQUIRED POINT ELEVATION EXISTING POINT ELEVATION NEW OR REQUIRED CONTOURS EXISTING CONTOURS
			TEST BORING INDICATES CASEWORK WHEN STANDARD SHEET OR PICTORIAL VIEWS ARE USED OR ELEVATIONS OF CASEWORK ARE DRAWN
			INDICATES FOOD SERVICE EQUIPMENT INDICATES A PARTICULAR TYPE OF EQUIPMENT WHICH REQUIRES SEVERAL DIGITS

MATERIALS

	CONCRETE		GLASS IN ELEVATION		WOOD (FINISH)		RESILIENT MATERIAL
	CONCRETE MASONRY UNITS		INSULATION (RIGID)		INSULATION (BATT)		WOOD (ROUGH)
	BRICK		METAL		SOIL, EARTH		
	PLASTER		GROUT		MORTAR		

ALL OF THE SYMBOLS APPEARING ON THIS SHEET MAY NOT NECESSARILY BE USED ON THIS PROJECT. FOR ADDITIONS TO AND/OR DEVIATIONS FROM THESE STANDARDS, REFER TO THE APPLICABLE DISCIPLINE'S WORK THROUGHOUT THE SET OF DRAWINGS.

PROJECT DIRECTORY

OWNER/USER

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ESKEW+DUMEZ+RIPPLE

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NEW ORLEANS, LOUISIANA 70130

WALKER'S IMAGINARIUM

200 HENRY CLAY AVENUE
NEW ORLEANS, LA 70118

EDR PROJECT NO. | 22003

PROJECT ISSUE DATE | 02 DECEMBER 2024

Conformed Set

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The intent of the Contract Documents is to include all items necessary for



06 LOADING DOCK VIEW
| 12" = 1'-0" |



05 BIOSWALE & ENTRY VIEW
| 12" = 1'-0" |



04 VIEW FROM ENTRY DRIVE
| 12" = 1'-0" |



03 EXT. CONCOURSE VIEW
| 12" = 1'-0" |



02 EXT. CONCOURSE CORNER VIEW
| 12" = 1'-0" |



01 CONCOURSE INTERIOR VIEW
| 12" = 1'-0" |

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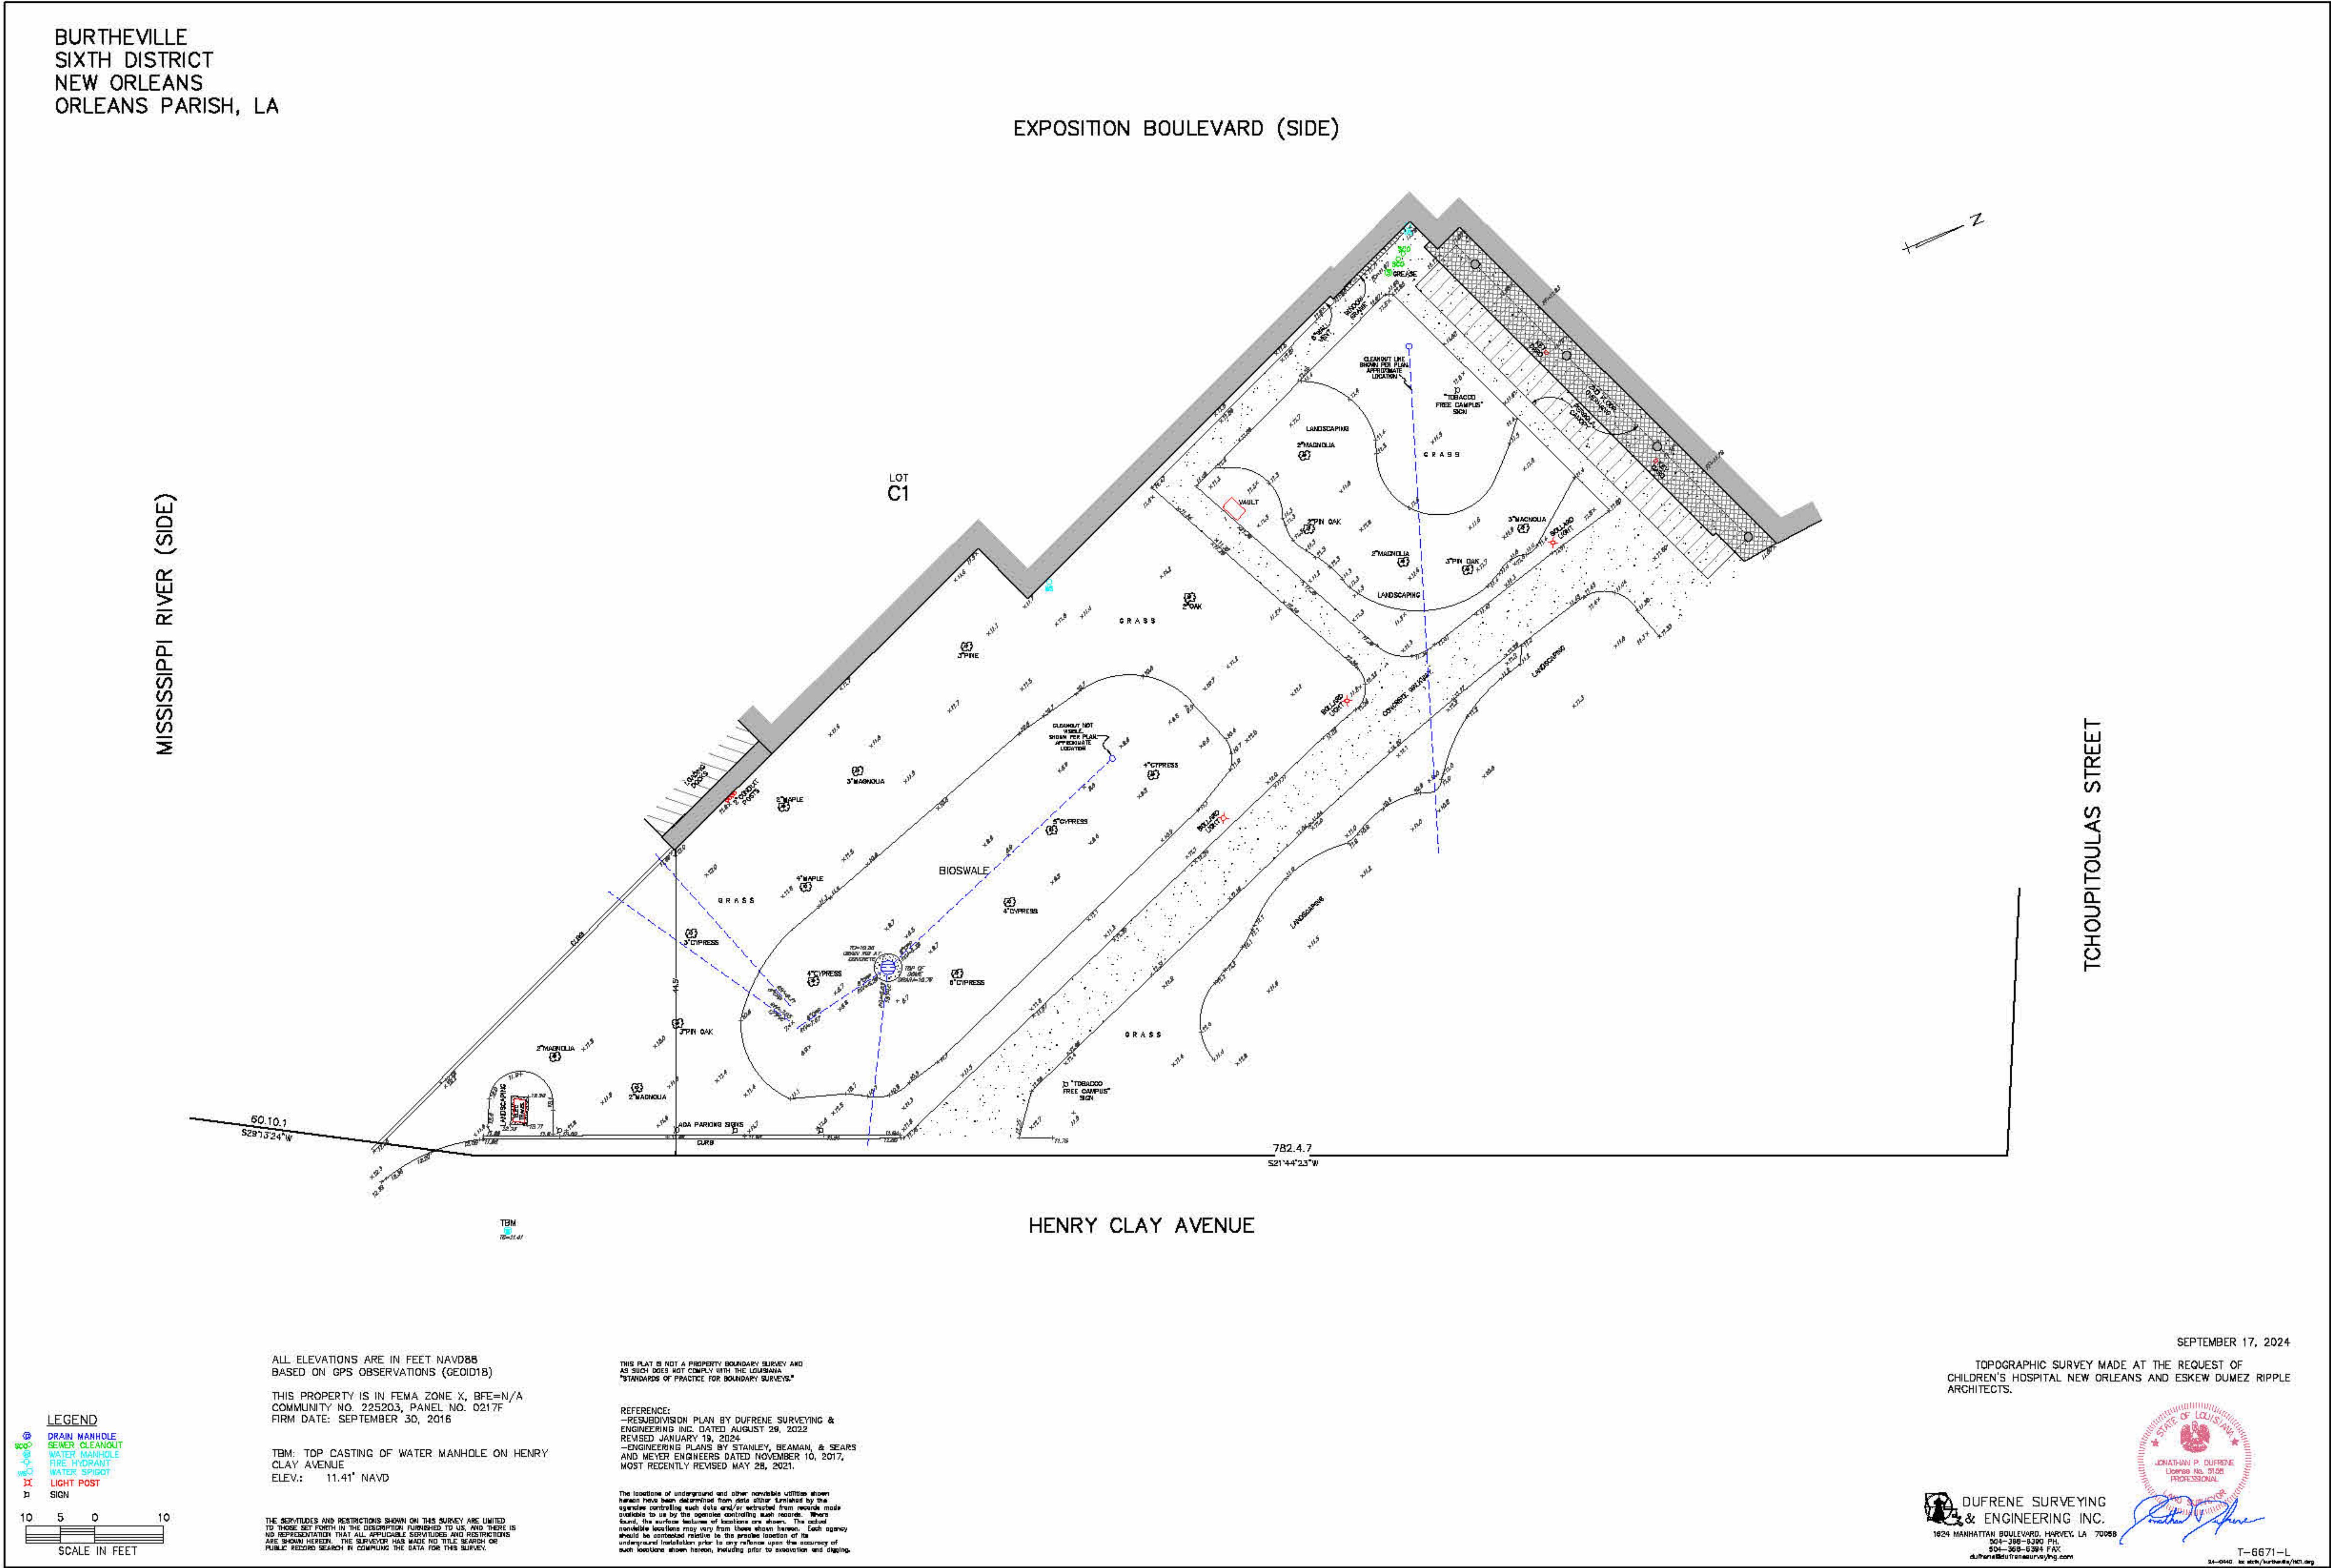
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REVISIONS

EXISTING IMAGES





WALKER'S IMAGINARIUM

200 HENRY CLAY AVENUE
NEW ORLEANS, LA 70118

EDR PROJECT NO. | 22003

02 DECEMBER
PROJECT ISSUE DATE | 2024


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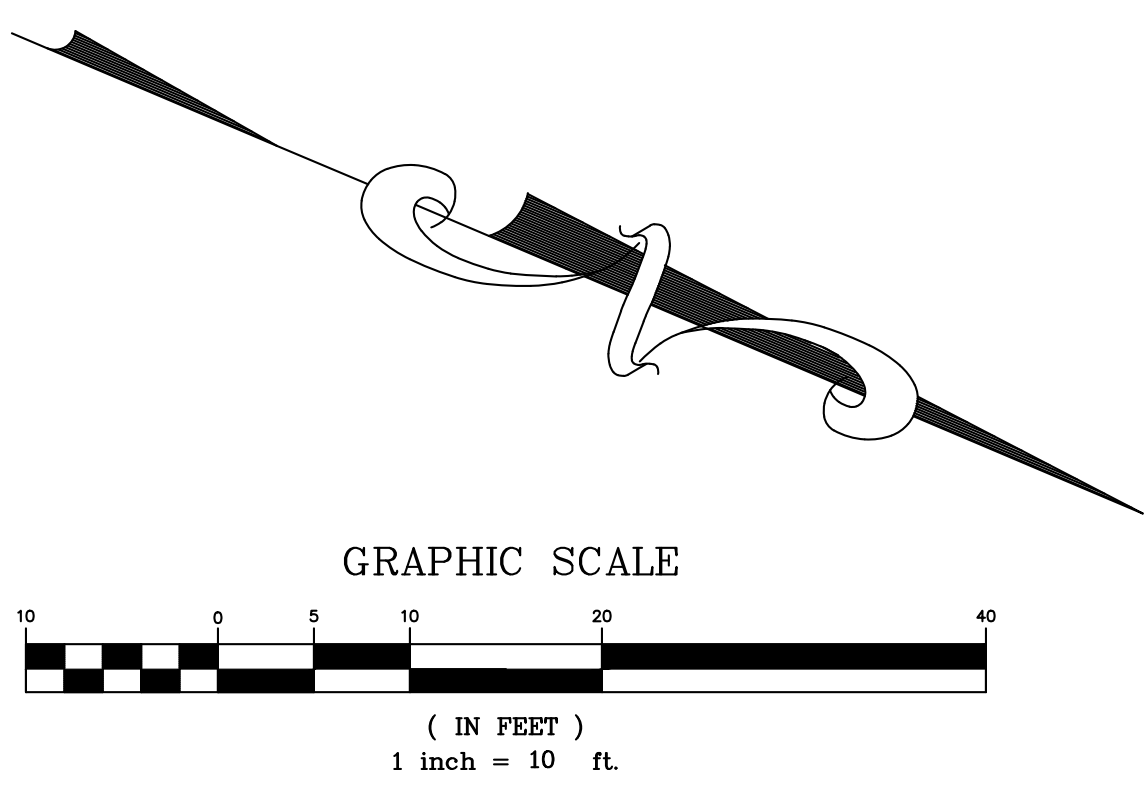
REVISIONS

SITE SURVEY



LEGEND

- DEMO EXISTING PAVEMENT
- REMOVE HEAVY DUTY PAVEMENT (LOADING DOCK/DRIVEWAY/ROAD)
- APPROXIMATE EXISTING SPOT ELEVATION PER 2021 DESIGN DRAWINGS. CONTRACTOR TO VERIFY ALL ELEVATIONS PRIOR TO CONSTRUCTION

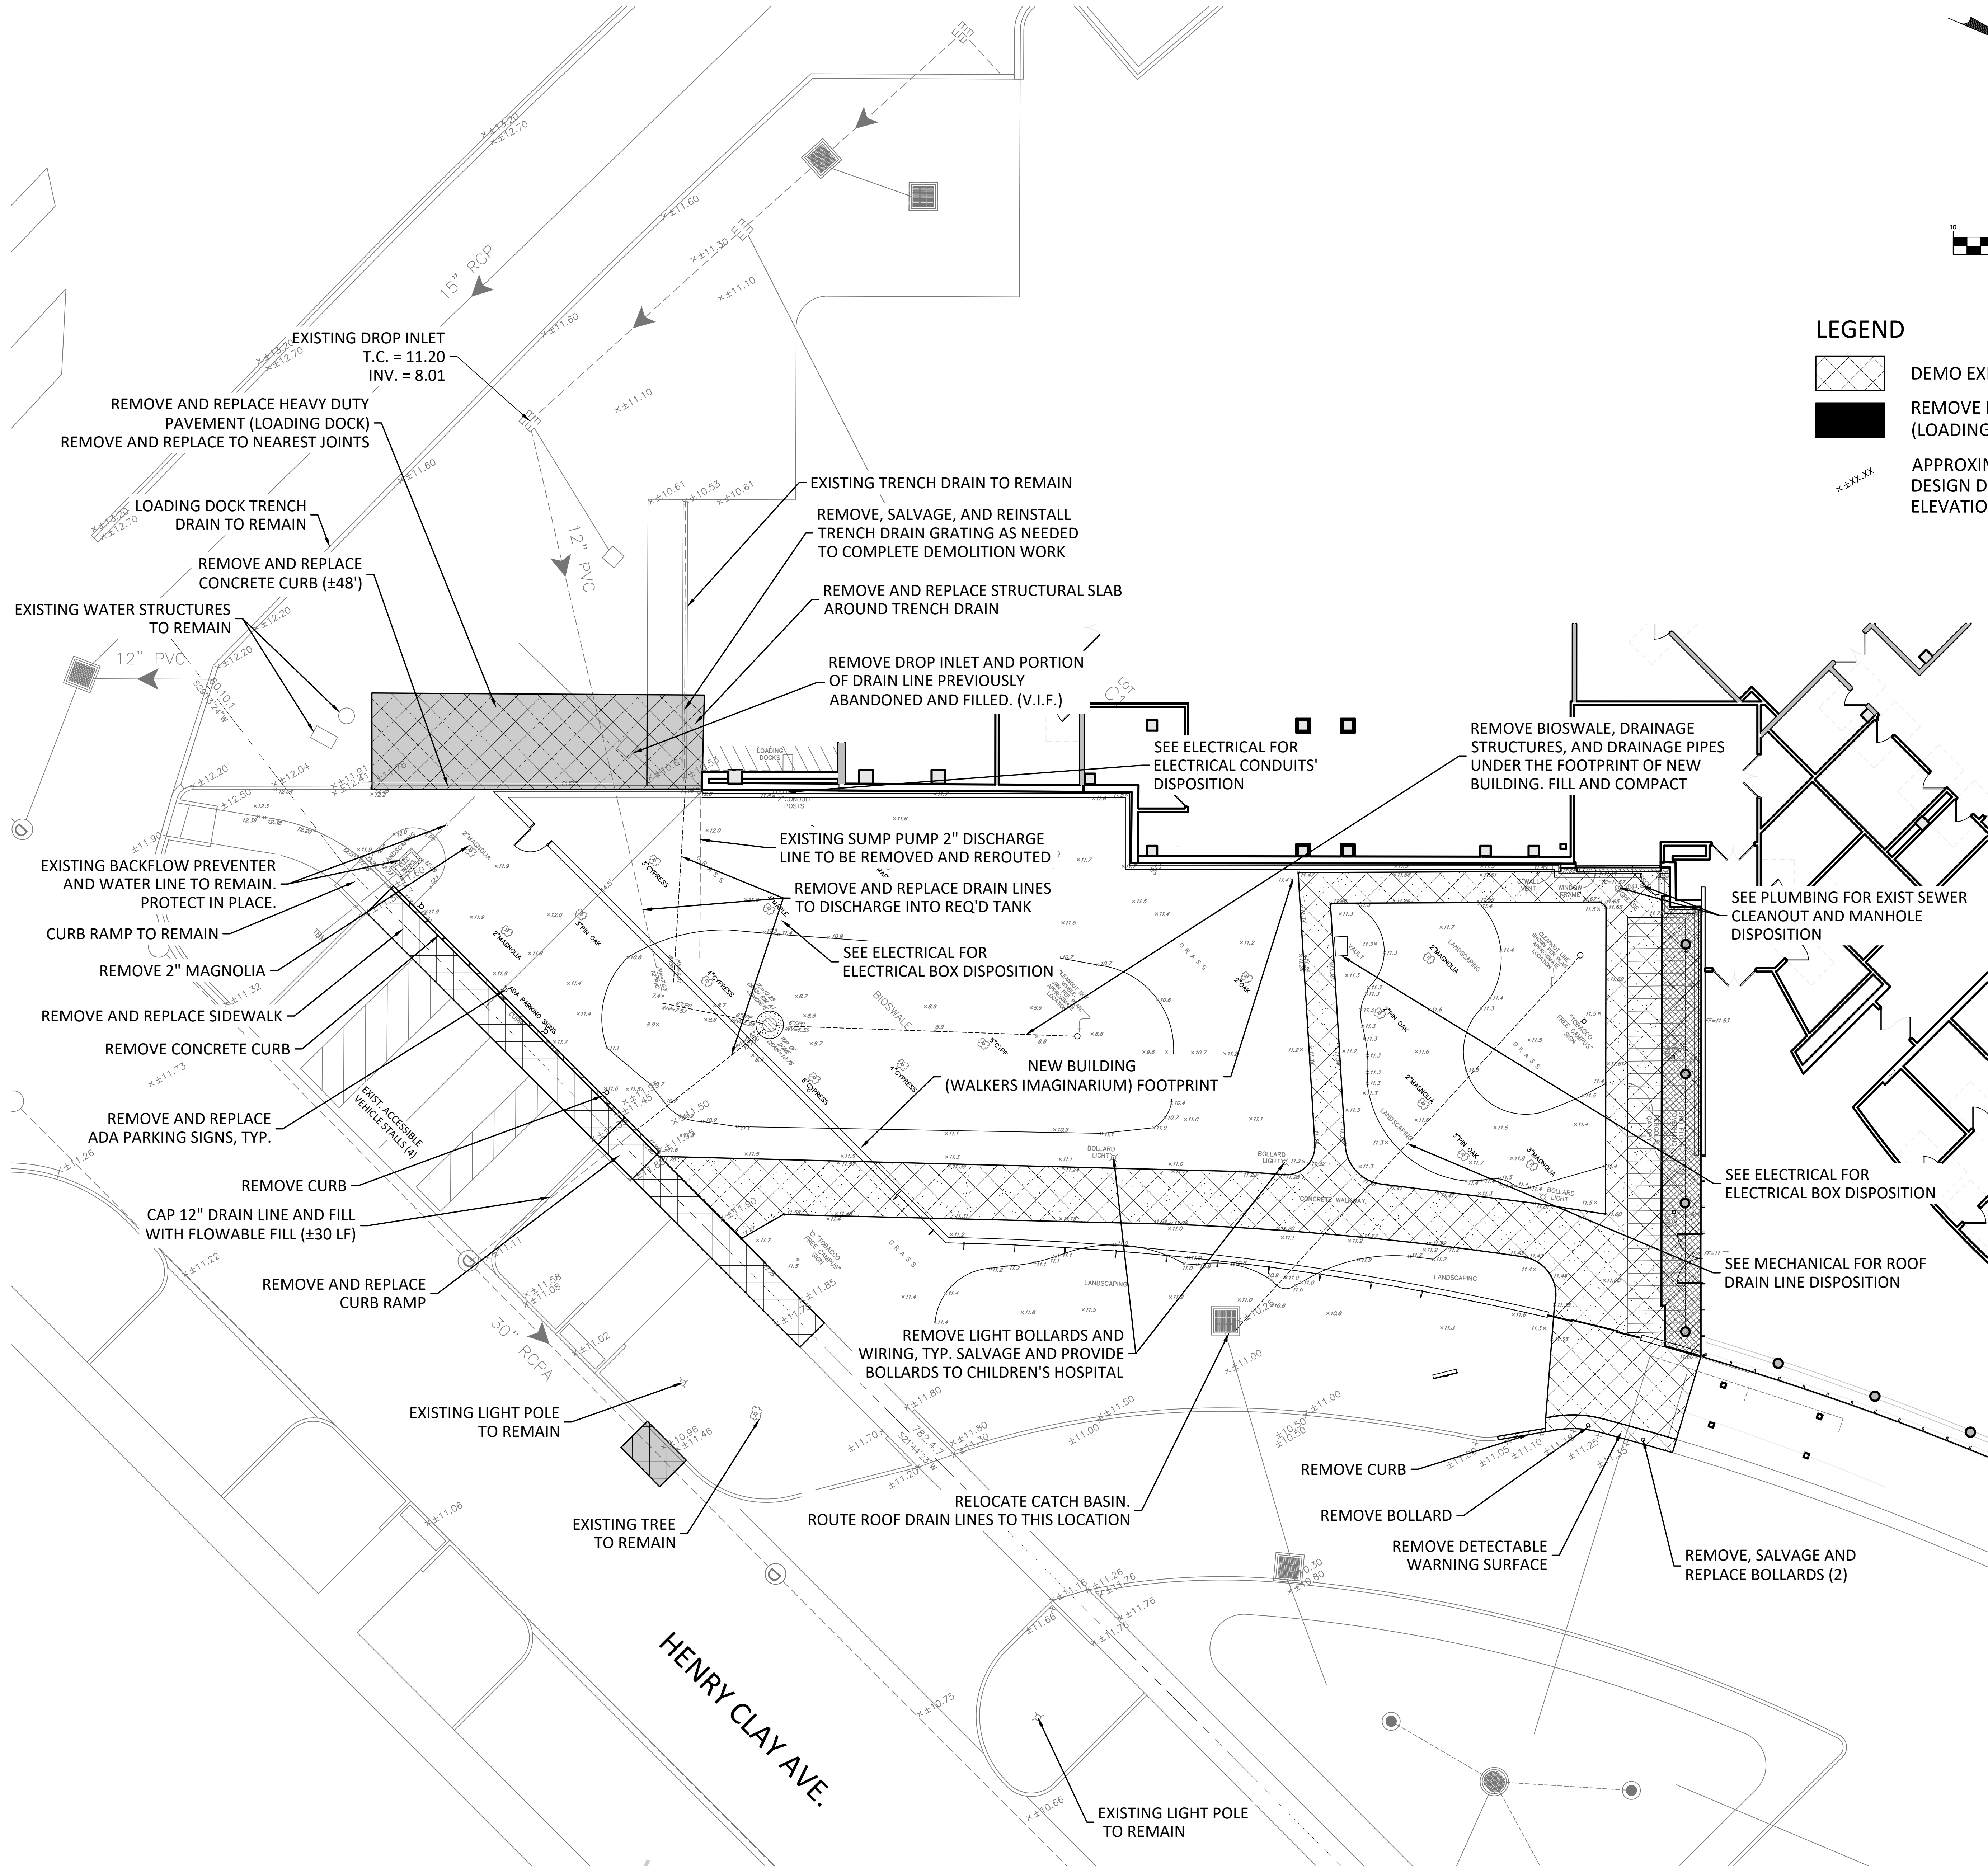

WALKER'S IMAGINARIUM

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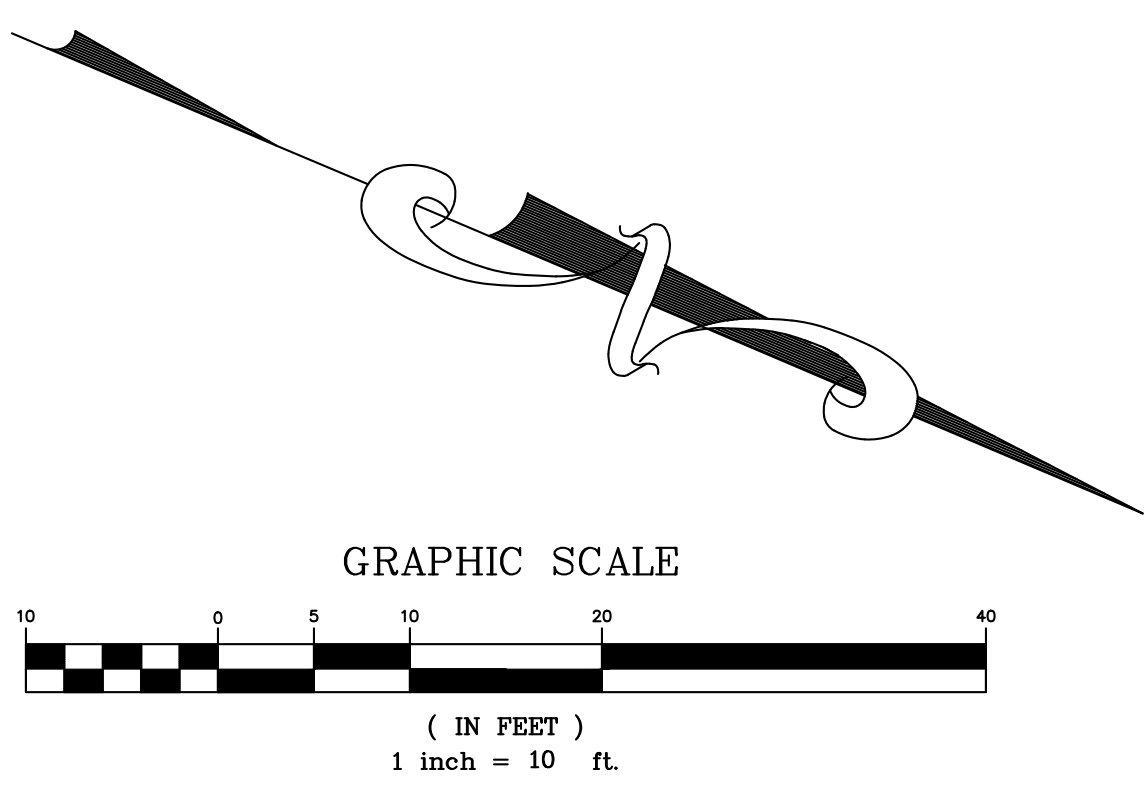
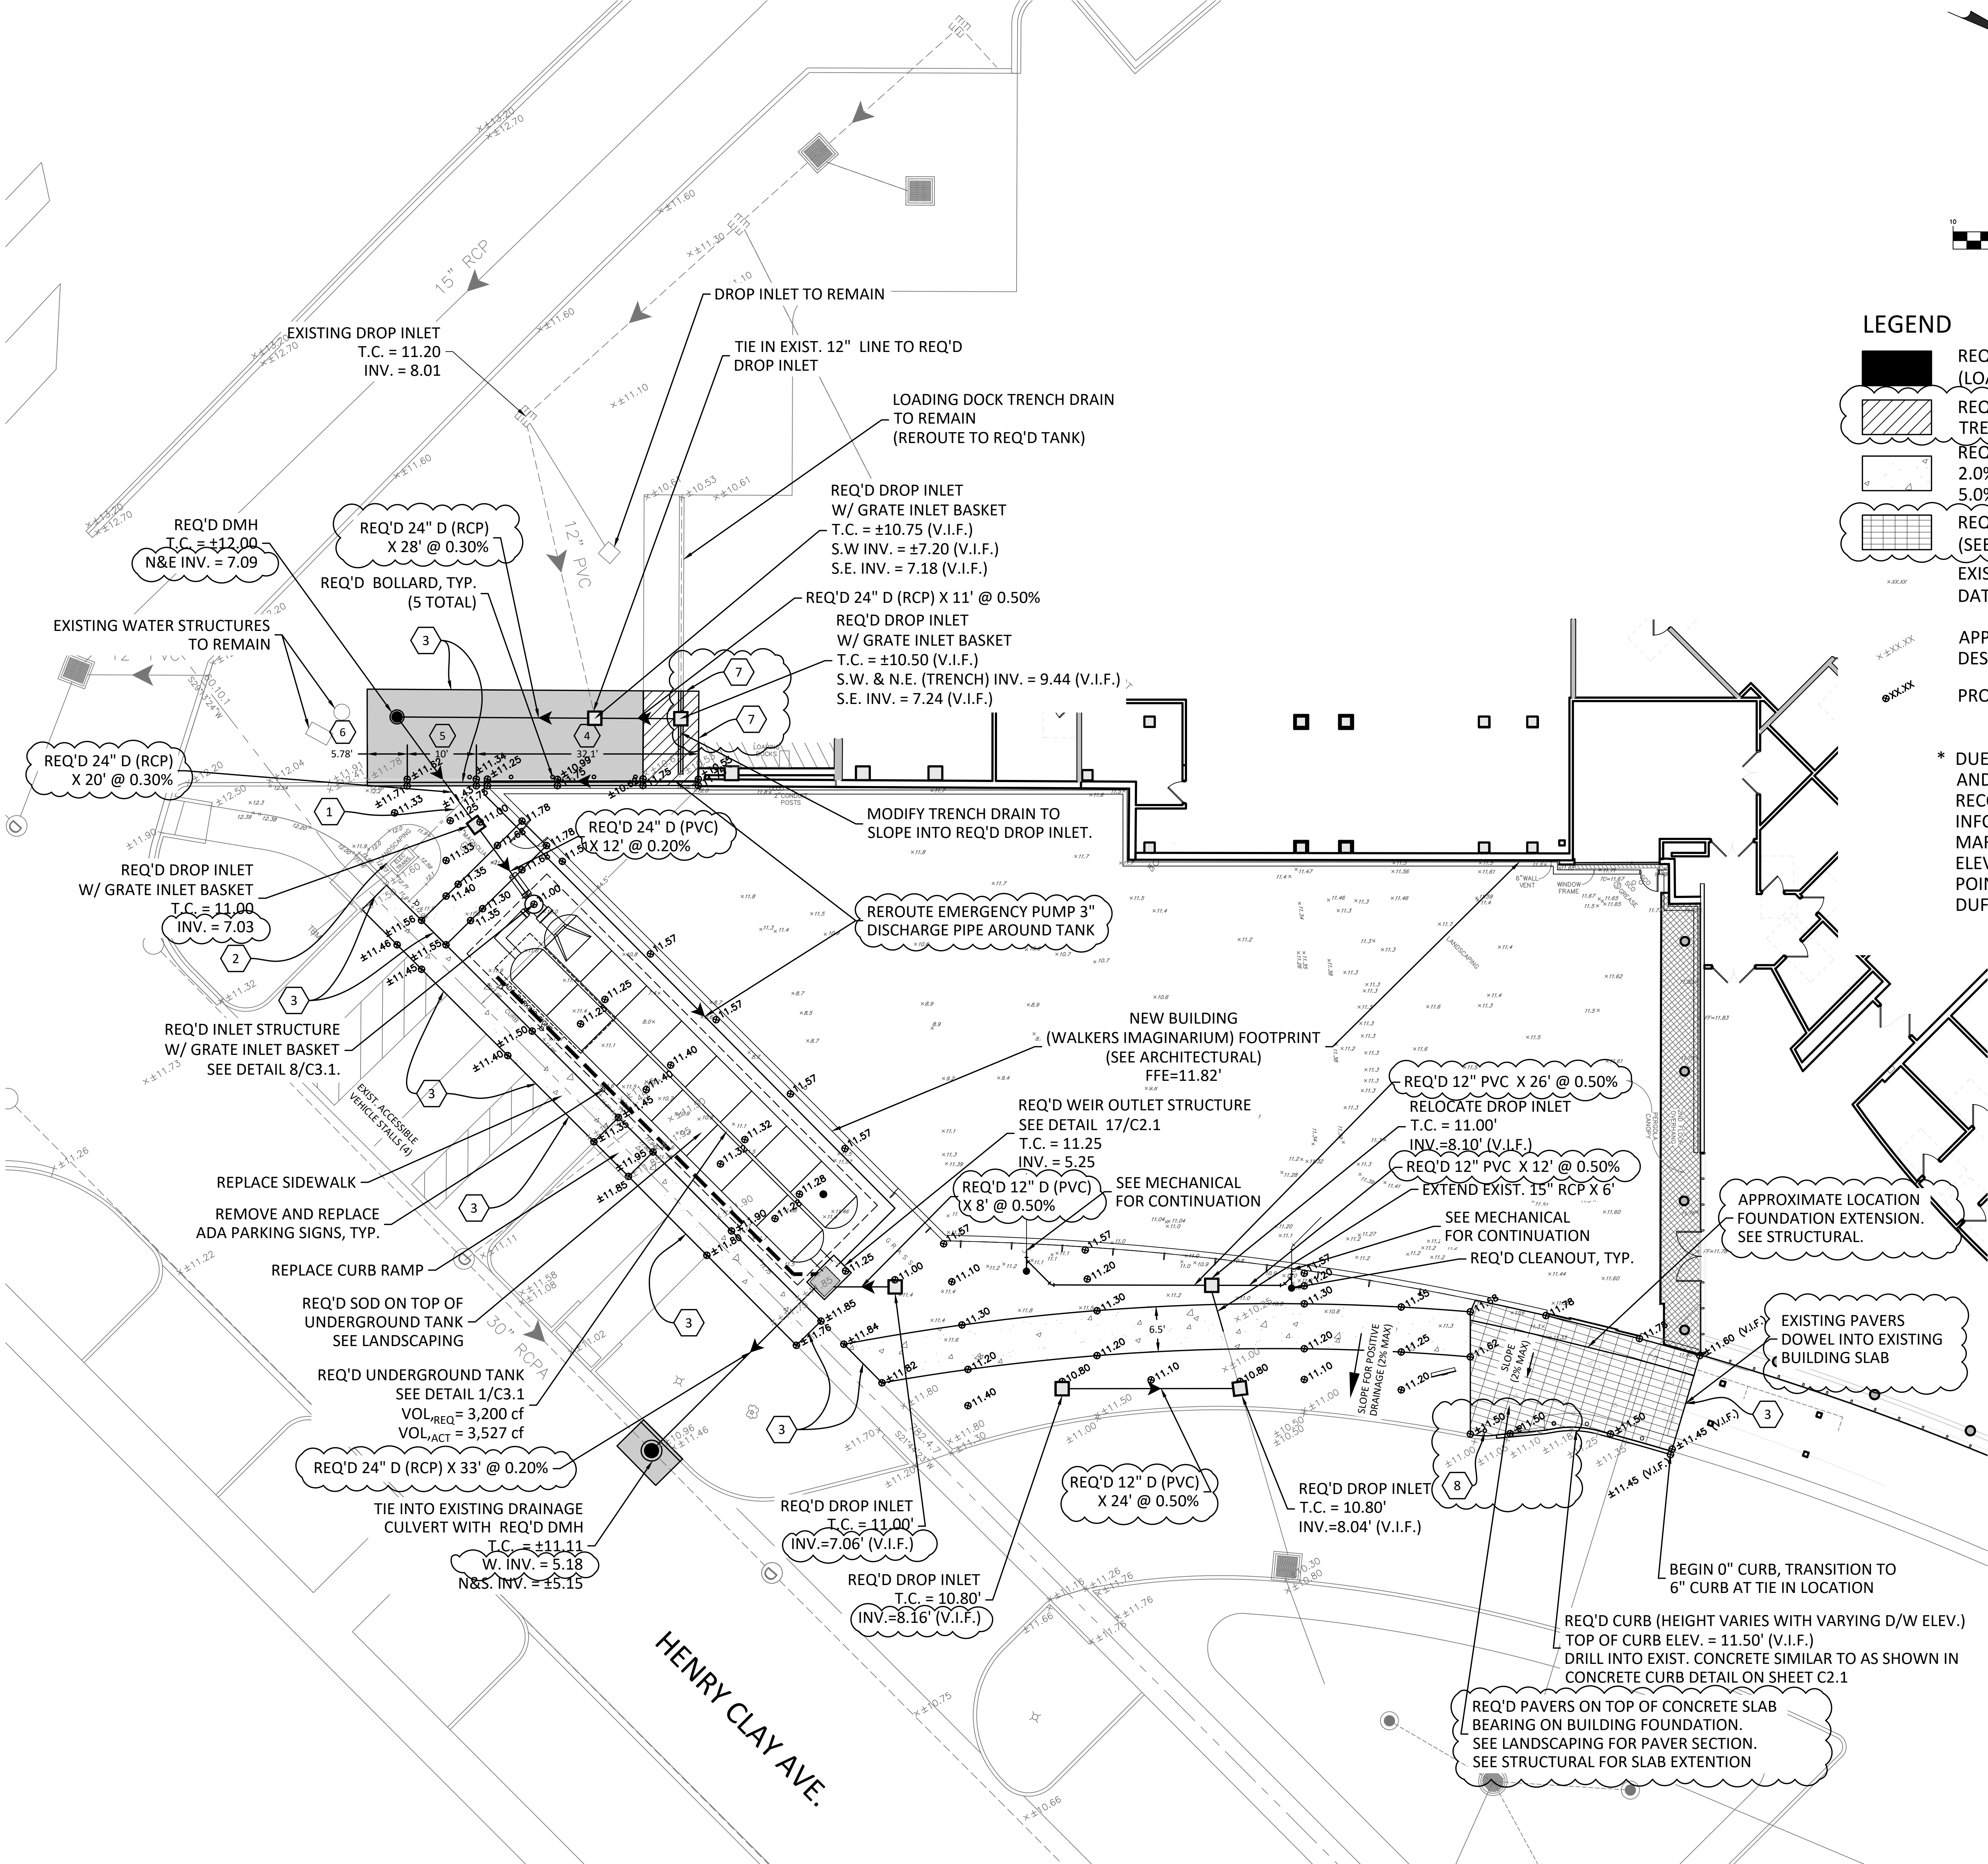
100% CONSTRUCTION DOCUMENTS

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REVISIONS

SITE DEMOLITION PLAN



LEGEND

- REQ'D HEAVY DUTY PAVEMENT (LOADING DOCK/DRIVEWAY/ROAD)
- REQ'D SLAB SAWCUT AND NEW SLAB AT TRENCH DRAIN
- REQ'D 5" THICK SIDEWALK
2.0% MAX. CROSS SLOPE
5.0% MAX. LONGITUDINAL SLOPE
- REQ'D PAVERS OVER 5" CONCRETE SLAB (SEE DETAIL 2/C2.1)
- EXISTING SPOT ELEVATION PER DUFRENE SURVEY DATED 09/2024. *
- APPROXIMATE EXISTING SPOT ELEVATION PER 2021 DESIGN DRAWINGS. *
- PROPOSED ELEVATION

* DUE TO LIMITED AMOUNT OF SURVEY INFORMATION AND DISCREPANCIES IN THE TWO SURVEYS, IT IS RECOMMENDED THAT THE SURVEYOR GET ADDITIONAL INFORMATION AS SHOWN IN THE ATTACHED SURVEY MARKUP. THERE IS A POSSIBILITY OF A 0'-0.3' ELEVATION DIFFERENCE BETWEEN CORRESPONDING POINTS ON THE 2021 DESIGN DRAWINGS AND THE 2024 DUFRENE SURVEY.



- SPECIFIC NOTES:**
- CONTRACTOR TO VERIFY DEPTH AND OFFSET AROUND NEW DRAIN LINE IF NECESSARY. COORDINATE WITH MEP DRAWINGS ON NEW WATER WORK.
 - EXIST. BACKFLOW PREVENTER AND WATER LINE TO REMAIN.
 - MATCH EXISTING GRADE
 - REPLACE RETAINING WALL (HEIGHT VARIES 6"-18") (32 LF)
 - REPLACE RETAINING WALL W/ CURB (1" HEIGHT) (10 LF)
 - TRANSITION FROM CURB TO RETAINING WALL (1" TO 6") (±5.78 LF)
 - REQ'D SLAB SAWCUT
 - REQ'D BRUSHED STAINLESS STEEL BOLLARDS STRUCTURED FOR VEHICULAR IMPACT (3). MATCH TYPE, SIZE, HEIGHT, COLOR, FINISH, AND MATERIAL TO EXISTING BOLLARDS ALONG WALKWAY.

WALKER'S IMAGINARIUM

200 HENRY CLAY AVENUE
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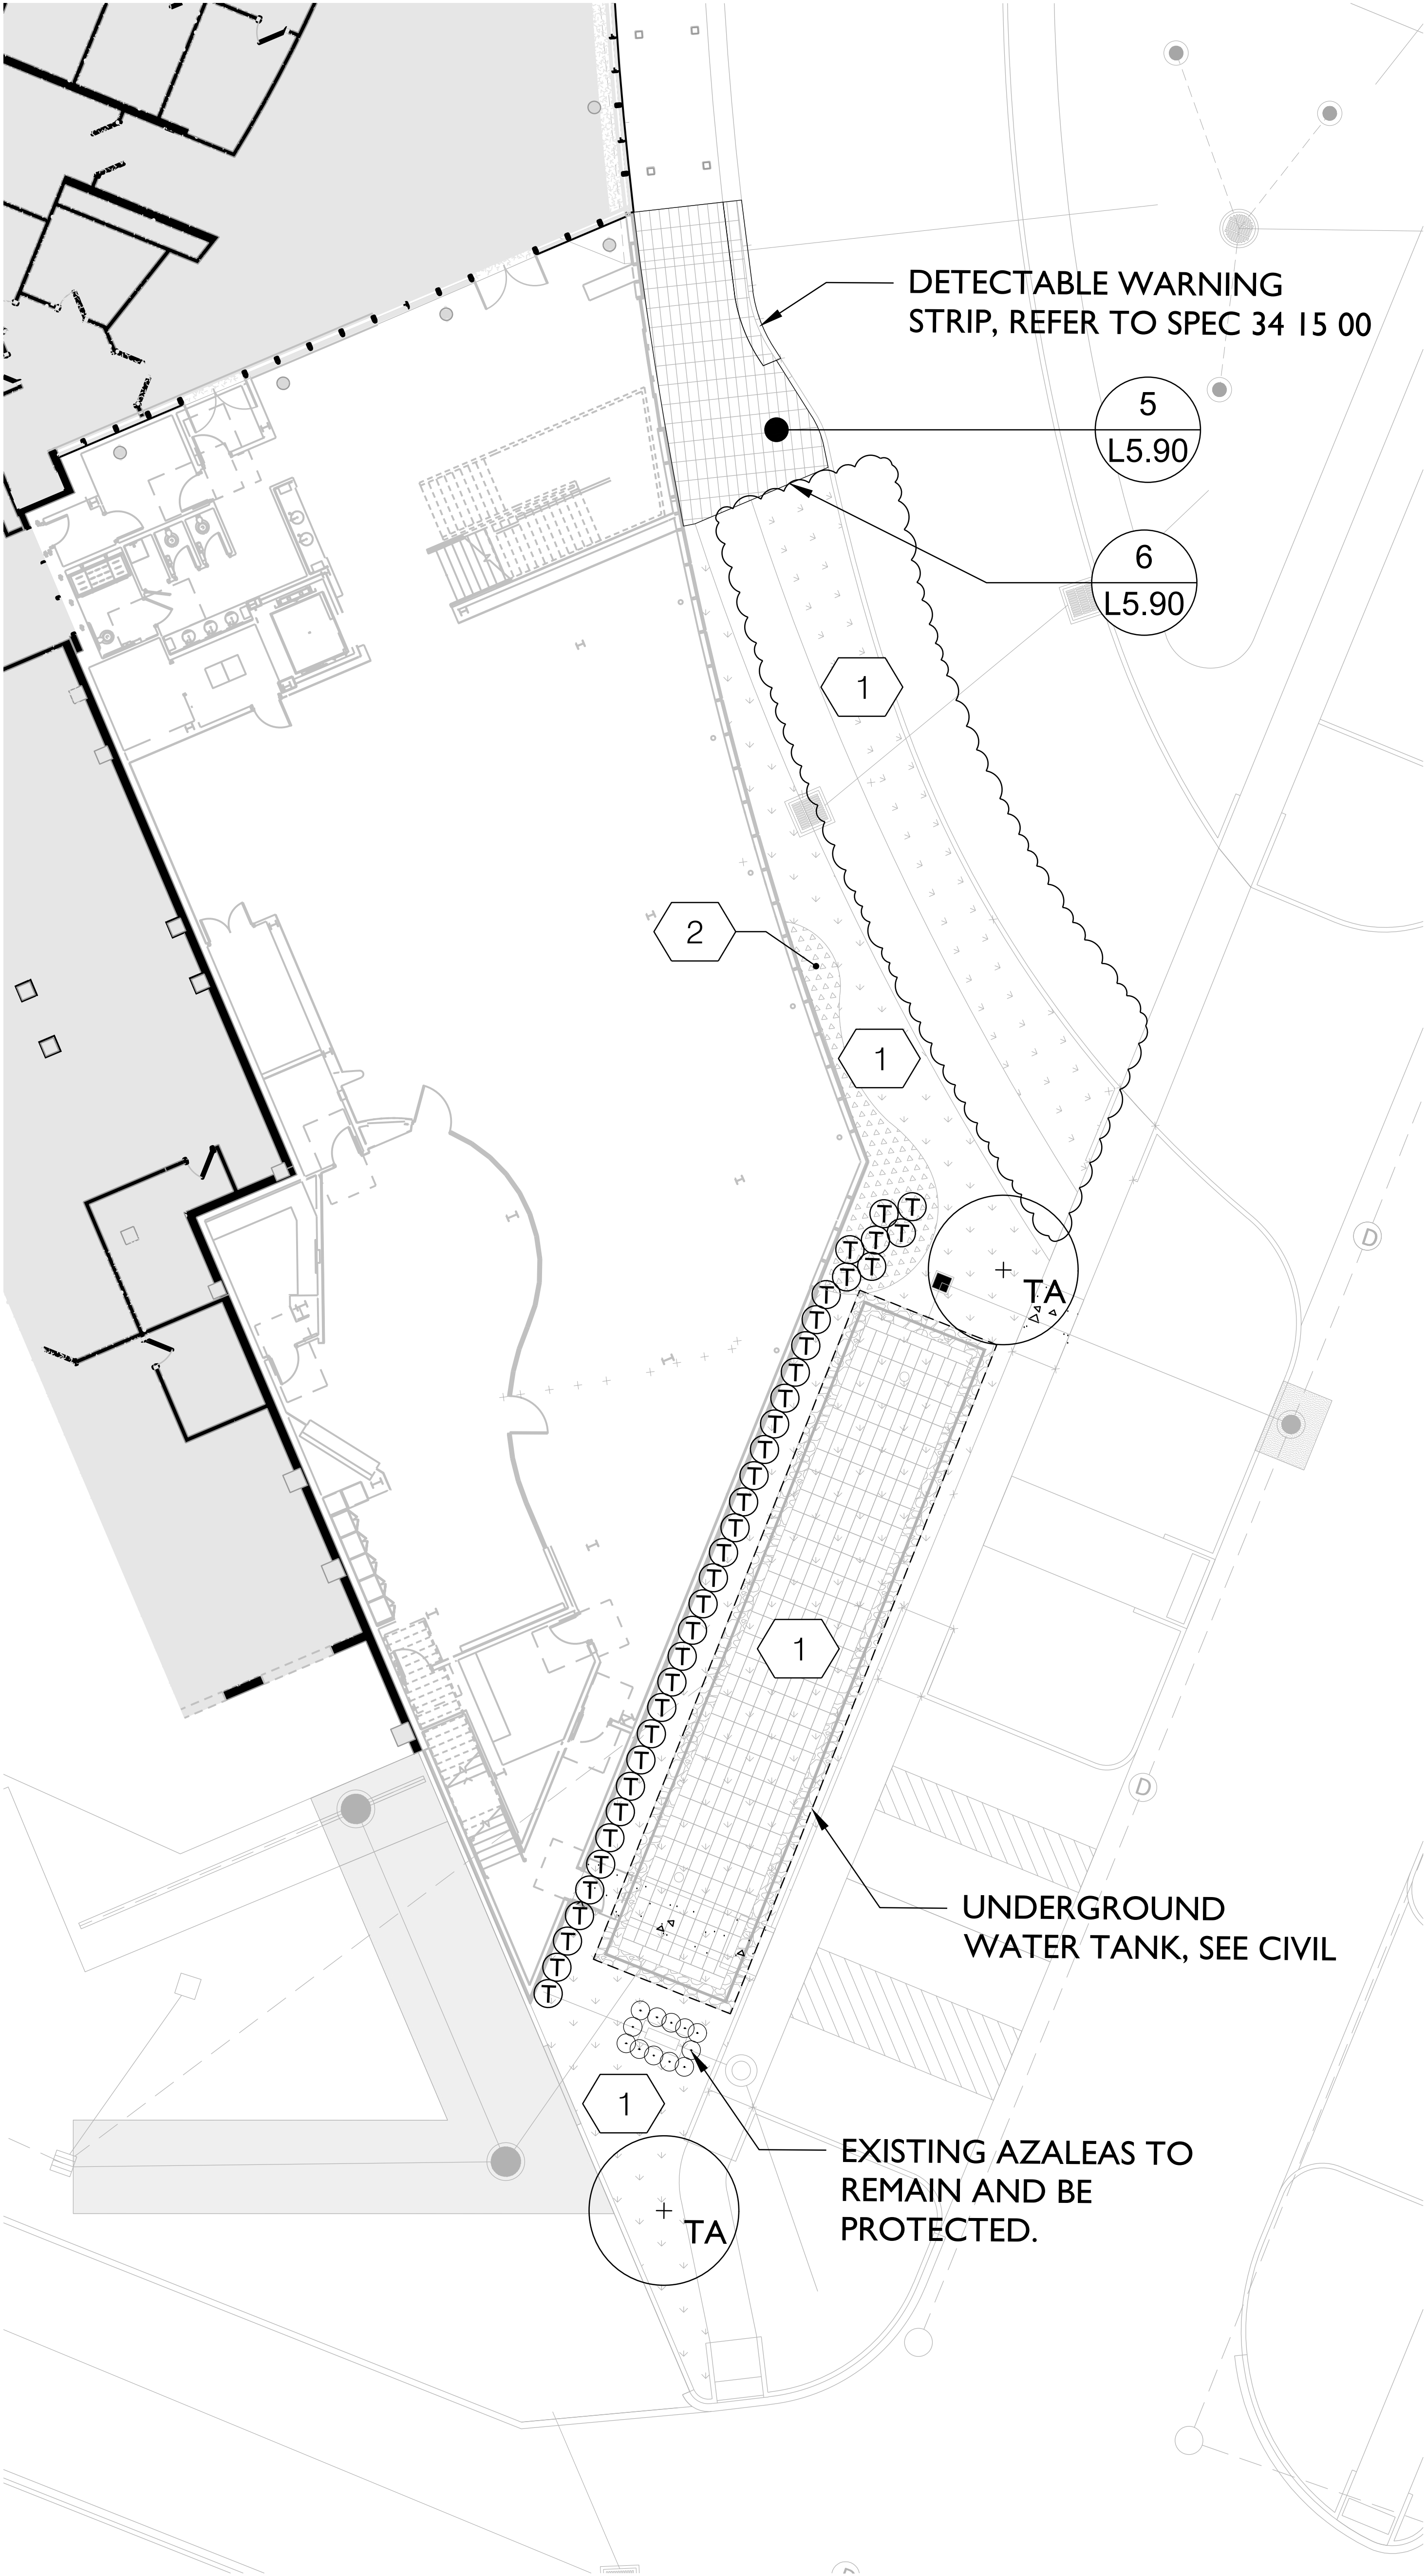
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20 DEC 2024	ADDEDNDUM 002
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DETAIL




1 LANDSCAPE PLAN
Scale: 1"=10'-0"

PLANT SCHEDULE (32 93 00)							
TREES							
SYMBOL	COMMON NAME	BOTANICAL NAME	QTY	SIZE	ROOT BALL	SPACING	NOTES
QV	LIVE OAK	Quercus virginiana	0	3" CAL	B&B	REF PLAN	
TA	BALD CYPRESS	Taxodium distichum	2	3" CAL	B&B	REF PLAN	MUST HAVE STRONG CENTRAL LEADER MIN. CROTCH HEIGHT 6'-0"

PERENNIALS/ORNAMENTAL GRASS & GROUND COVER						
SYMBOL	COMMON NAME	BOTANICAL NAME	QTY	SIZE	SPACING	NOTES
1	LAWN-SOD	Cynodon dactylon	4,070 SF			
2	AGAPANTHUS	Agapanthus africanus	260 SF	1 GAL	18" O.C.	FLOWER COLOR SHALL BE PURPLE
T	GEORGE L. TABER AZALEA	Azalea indica 'George L. Taber'	35	7 GAL	36" O.C.	
	PINE STRAW MULCH		500 SF	3" LAYER		ALL PLANT BEDS AND 3' RADIUS AROUND ALL TREES

- NOTES:
- UNLESS OTHERWISE NOTED ON THE DRAWINGS, CONTRACTOR SHALL ALWAYS USE THE STRICTER REQUIREMENT WHEN PLACING DIFFERENT SPECIES NEXT TO EACH OTHER.
 - UNLESS OTHERWISE NOTED ON DRAWINGS, ANY PLANT THAT IS LESS THAN 3 GAL SHALL BE PLACED NO FURTHER THAN 6 INCH AWAY FROM THE EDGE OF THE PLANTER/PLANTING BED ON ALL SIDES. ANY PLANT THAT IS EQUAL OR LARGER THAN 3 GAL SHALL BE PLACED NO FURTHER THAN 12 INCH AWAY FROM THE EDGE OF THE PLANTER/PLANTING BED ON ALL SIDES.
 - PLANTS SHALL BE SPACED EVENLY PER PLANTING SCHEDULE. ANY INCORRECT SPACING WILL NOT BE ACCEPTED.
 - UNLESS OTHERWISE NOTED ON THE DRAWINGS, PLANTING SOIL FINISH GRADE SHALL BE 3" BELOW THE SURROUNDING PLANTING BED/PLANTER EDGE. MULCH FINISH GRADE SHALL BE FLUSH WITH THE SURROUNDING PLANTING BED/PLANTER EDGE.
 - CONTRACTOR SHALL ARRANGE POTTED PLANTS PER PLANTING PLAN AND NOTIFY LANDSCAPE ARCHITECT 72 HOURS AHEAD TO APPROVE PLANTING LAYOUT ON SITE PRIOR TO PLANTS INSTALLATION.

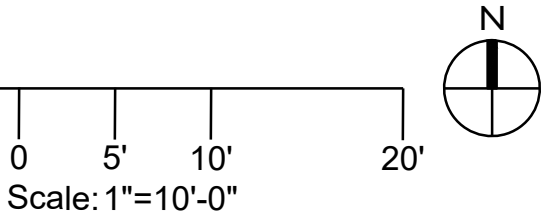

EskewDumezRipple

NEW ORLEANS, LA | WASHINGTON, DC

spackman mossop michael

1824 Sophie Wright Place, New Orleans | LA | 70130
T: 504.218.8991

GENERAL NOTES

- + PROPOSED TREE
- 1 LAWN
- T AZALEA

GENERAL NOTES

- SEE L5.90 FOR PLANTING DETAILS.
- SEE L5.10 FOR IRRIGATION PLAN.
- LANDSCAPE ARCHITECT TO CONFIRM LOCATION OF ALL PLANT MATERIALS PRIOR TO INSTALLATION.

WALKER'S IMAGINARIUM

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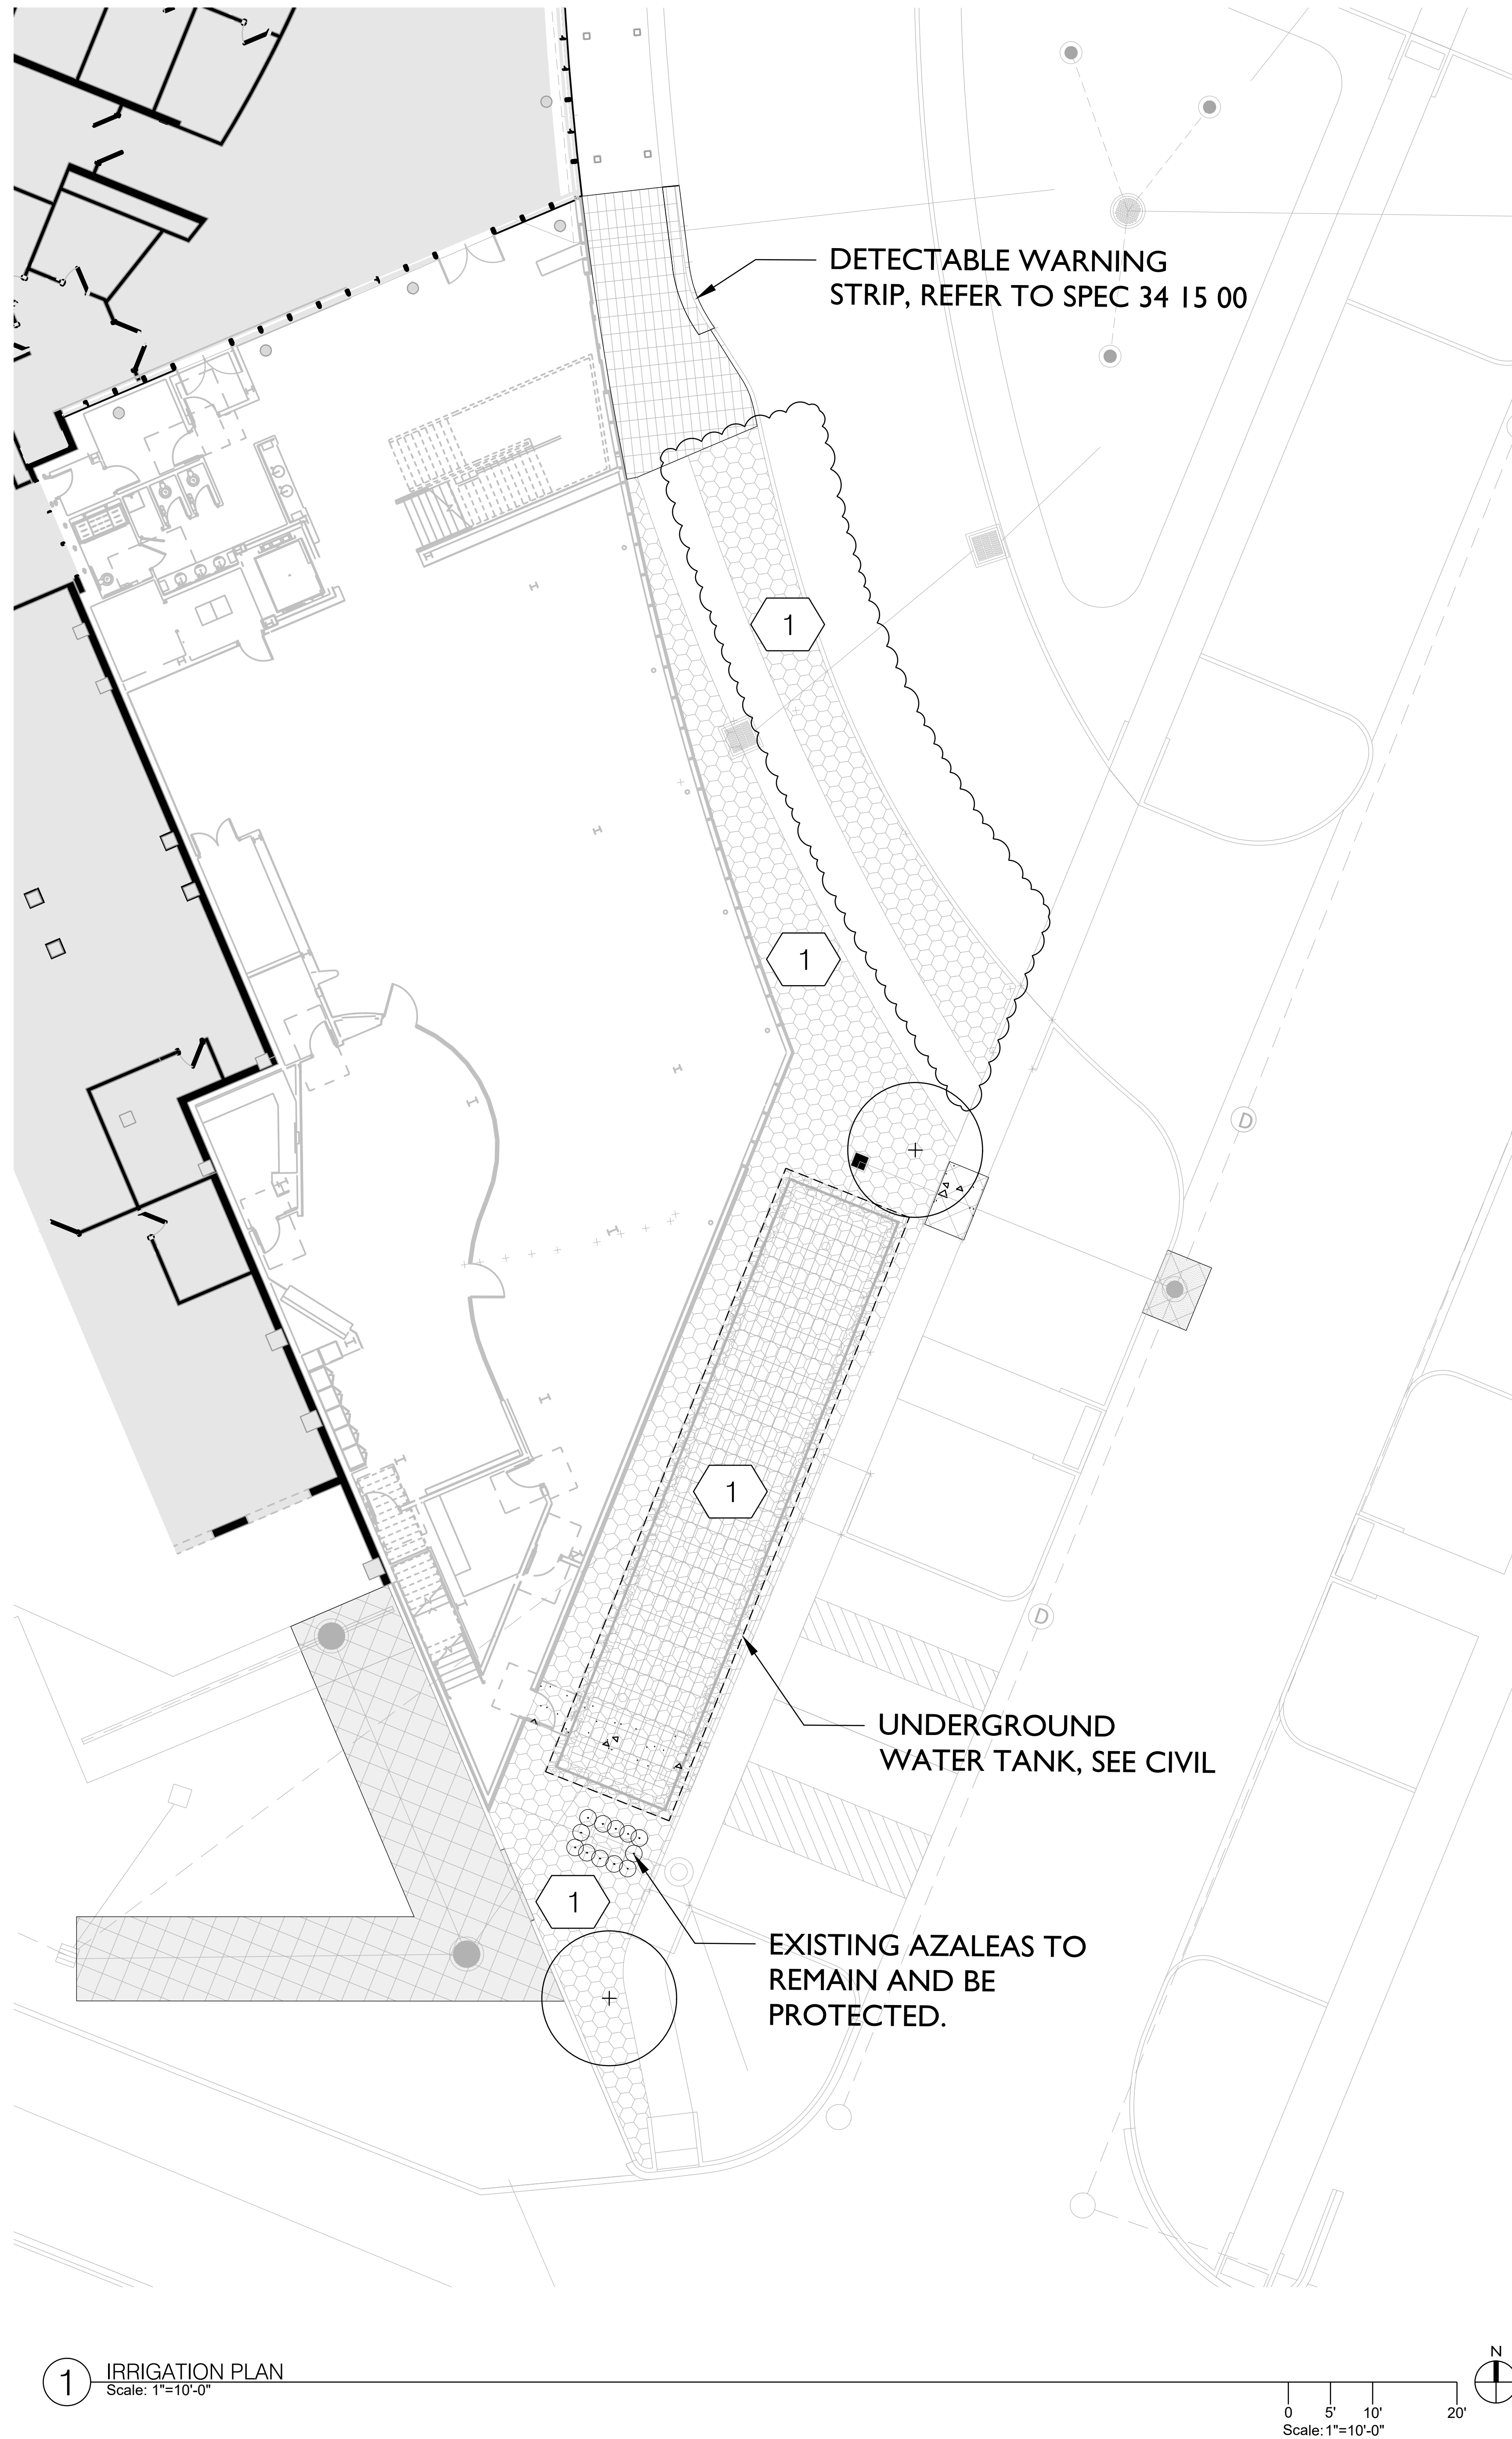
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REVISIONS
12/20/24 ADDENDUM 02

LANDSCAPE PLAN

DRAWN BY | SMM

L5.00



GENERAL NOTES



GENERAL NOTES

1. ANY PLANT MATERIAL NOT SHOWN AS IRRIGATED SHALL BE HAND WATERED DURING TIME OF ESTABLISHMENT.
2. ANY PROPOSED TREES NOT SHOWN AS IRRIGATED SHALL BE EQUIPPED WITH A SLOW RELEASE WATERING BAG (32.84.00).
3. TIE THE PROPOSED IRRIGATION SYSTEM TO THE EXISTING IRRIGATION SYSTEM.

WALKER'S IMAGINARIUM

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EDR PROJECT NO. | 22003

PROJECT ISSUE DATE | 02 DECEMBER 2024

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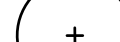

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

12/20/24 ADDENDUM 02

IRRIGATION PLAN

DRAWN BY | SMM

L5.10

PLANT SCHEDULE (32 93 00)							
TREES							
SYMBOL	COMMON NAME	BOTANICAL NAME	QTY	SIZE	ROOT BALL	SPACING	NOTES
	LIVE OAK	<i>Quercus virginiana</i>	3	3" CAL	B&B	REF PLAN	MUST HAVE STRONG CENTRAL LEADER MIN. CROTCH HEIGHT 6'-0"
	BALD CYPRESS	<i>Taxodium distichum</i>	2	3" CAL	B&B	REF PLAN	MUST HAVE STRONG CENTRAL LEADER MIN. CROTCH HEIGHT 6'-0"

PERENNIALS/ORNAMENTAL GRASS & GROUNDCOVER						
SYMBOL	COMMON NAME	BOTANICAL NAME	QTY	SIZE	SPACING	NOTES
	LAWN-SOD	<i>Cynodon dactylon</i>	4,070 SF			
	AGAPANTHUS	<i>Agapanthus africanus</i>	260 SF	1 GAL	18" O.C.	FLOWER COLOR SHALL BE PURPLE
T	GEORGE L. TABER AZALEA	<i>Azalea indica 'George L. Taber'</i>	35	7 GAL	36" O.C.	
	PINE STRAW MULCH		500 SF	3" LAYER		ALL PLANT BEDS AND 3' RADIUS AROUND ALL TREES

NOTES:

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WALKER'S IMAGINARIUM

200 HENRY CLAY AVENUE
NEW ORLEANS, LA70118

EDR PROJECT NO. | 22003

PROJECT ISSUE DATE | 02 DECEMBER 2024






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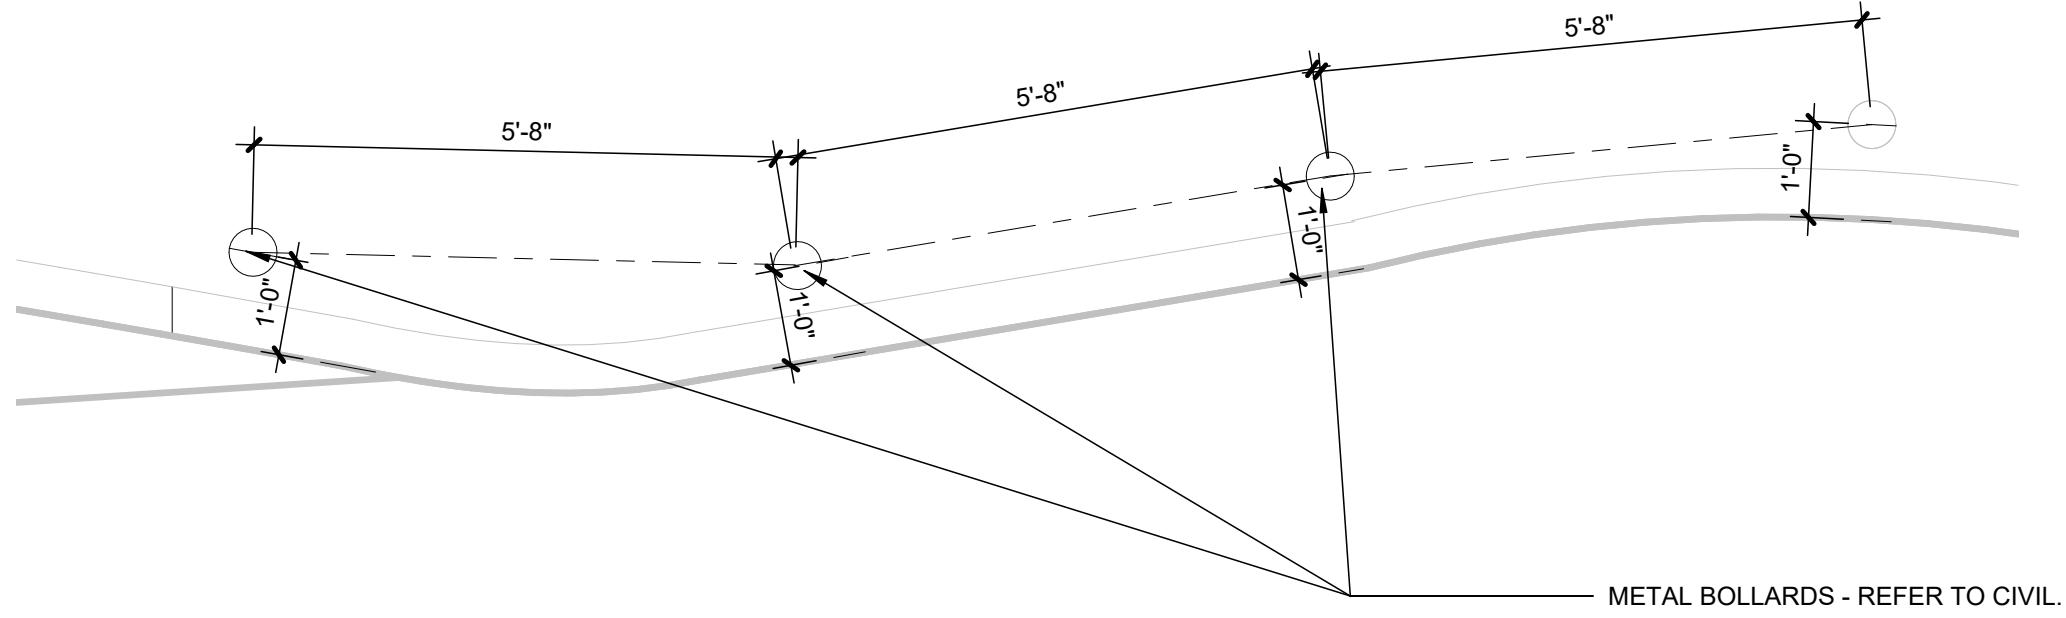
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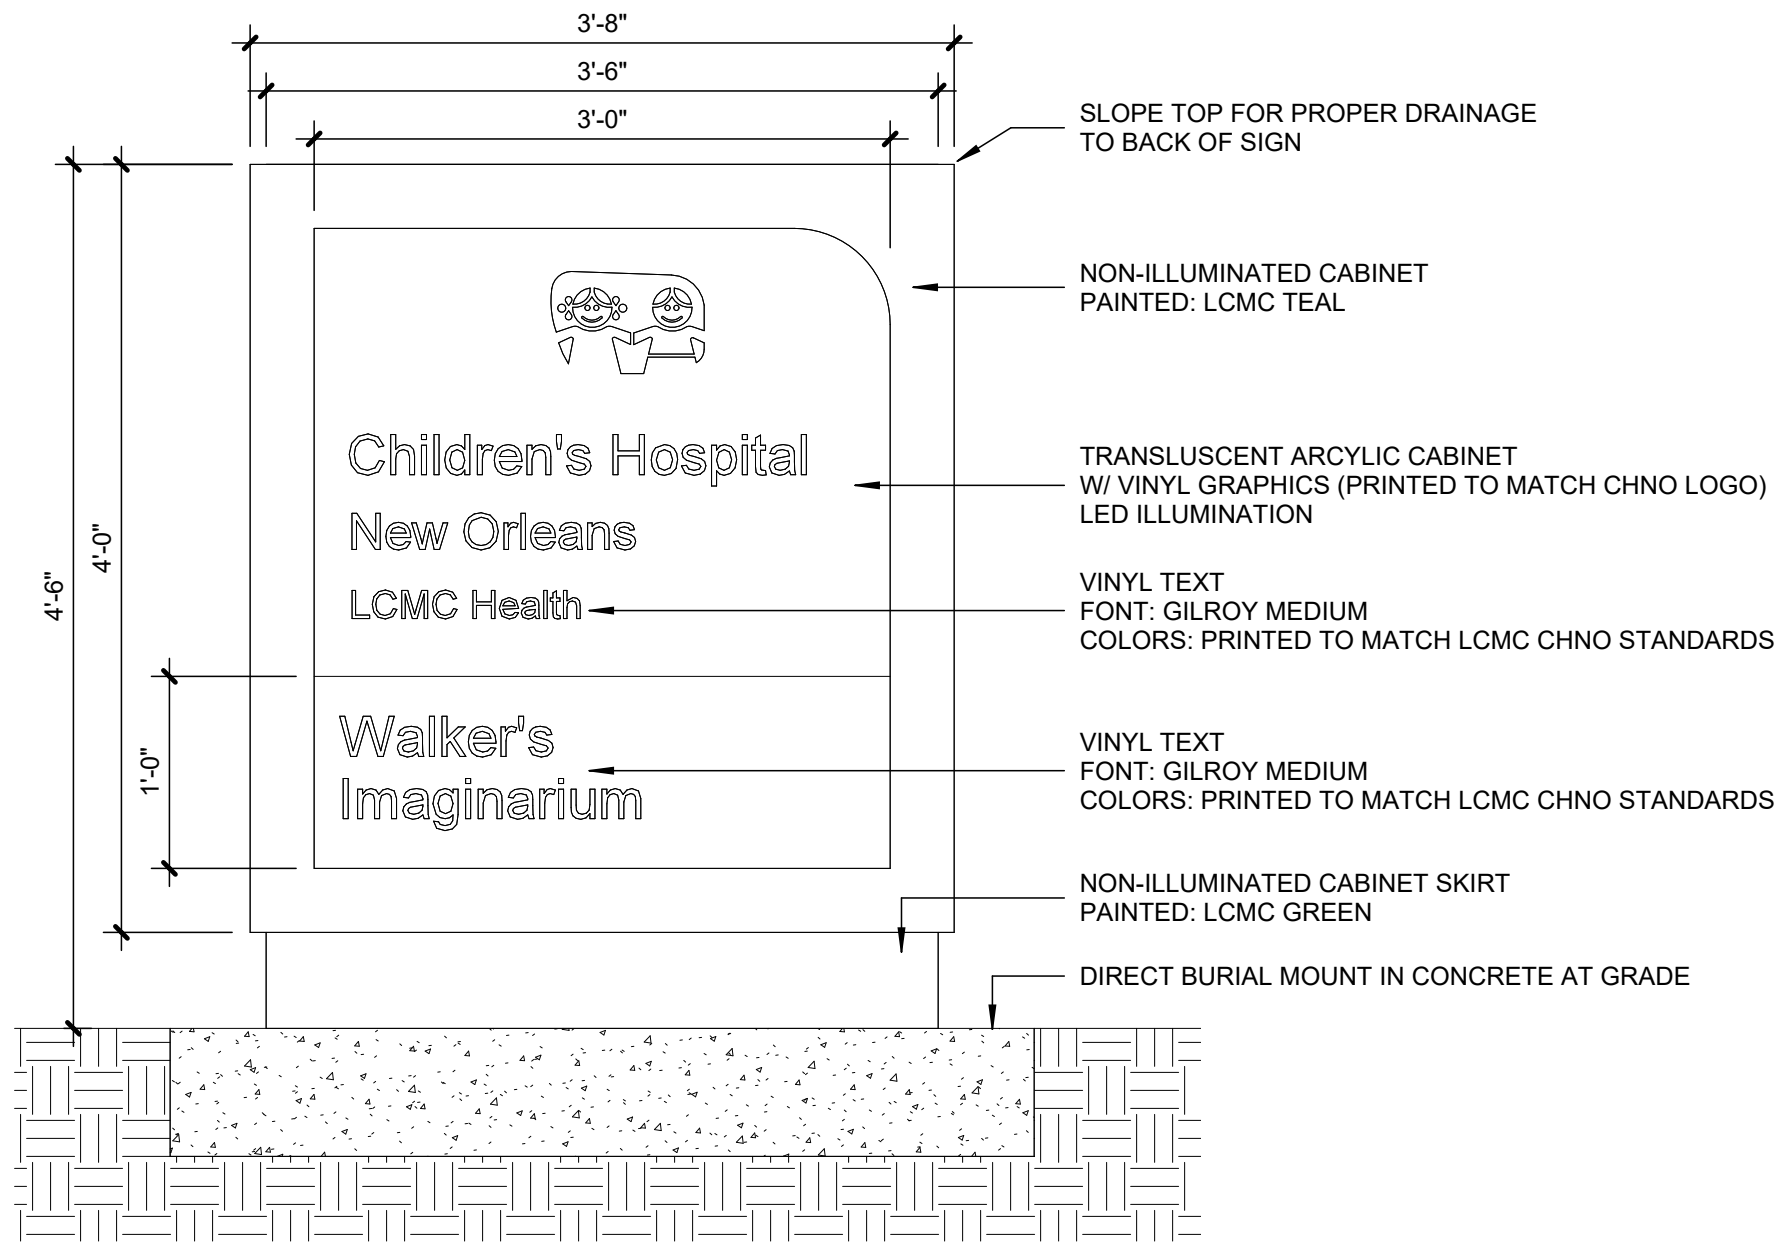
REVISIONS

PLANT SCHEDULE







04 ENLARGED SITE PLAN - METAL BOLLARDS
1.10 | 1/2" = 1'-0" |

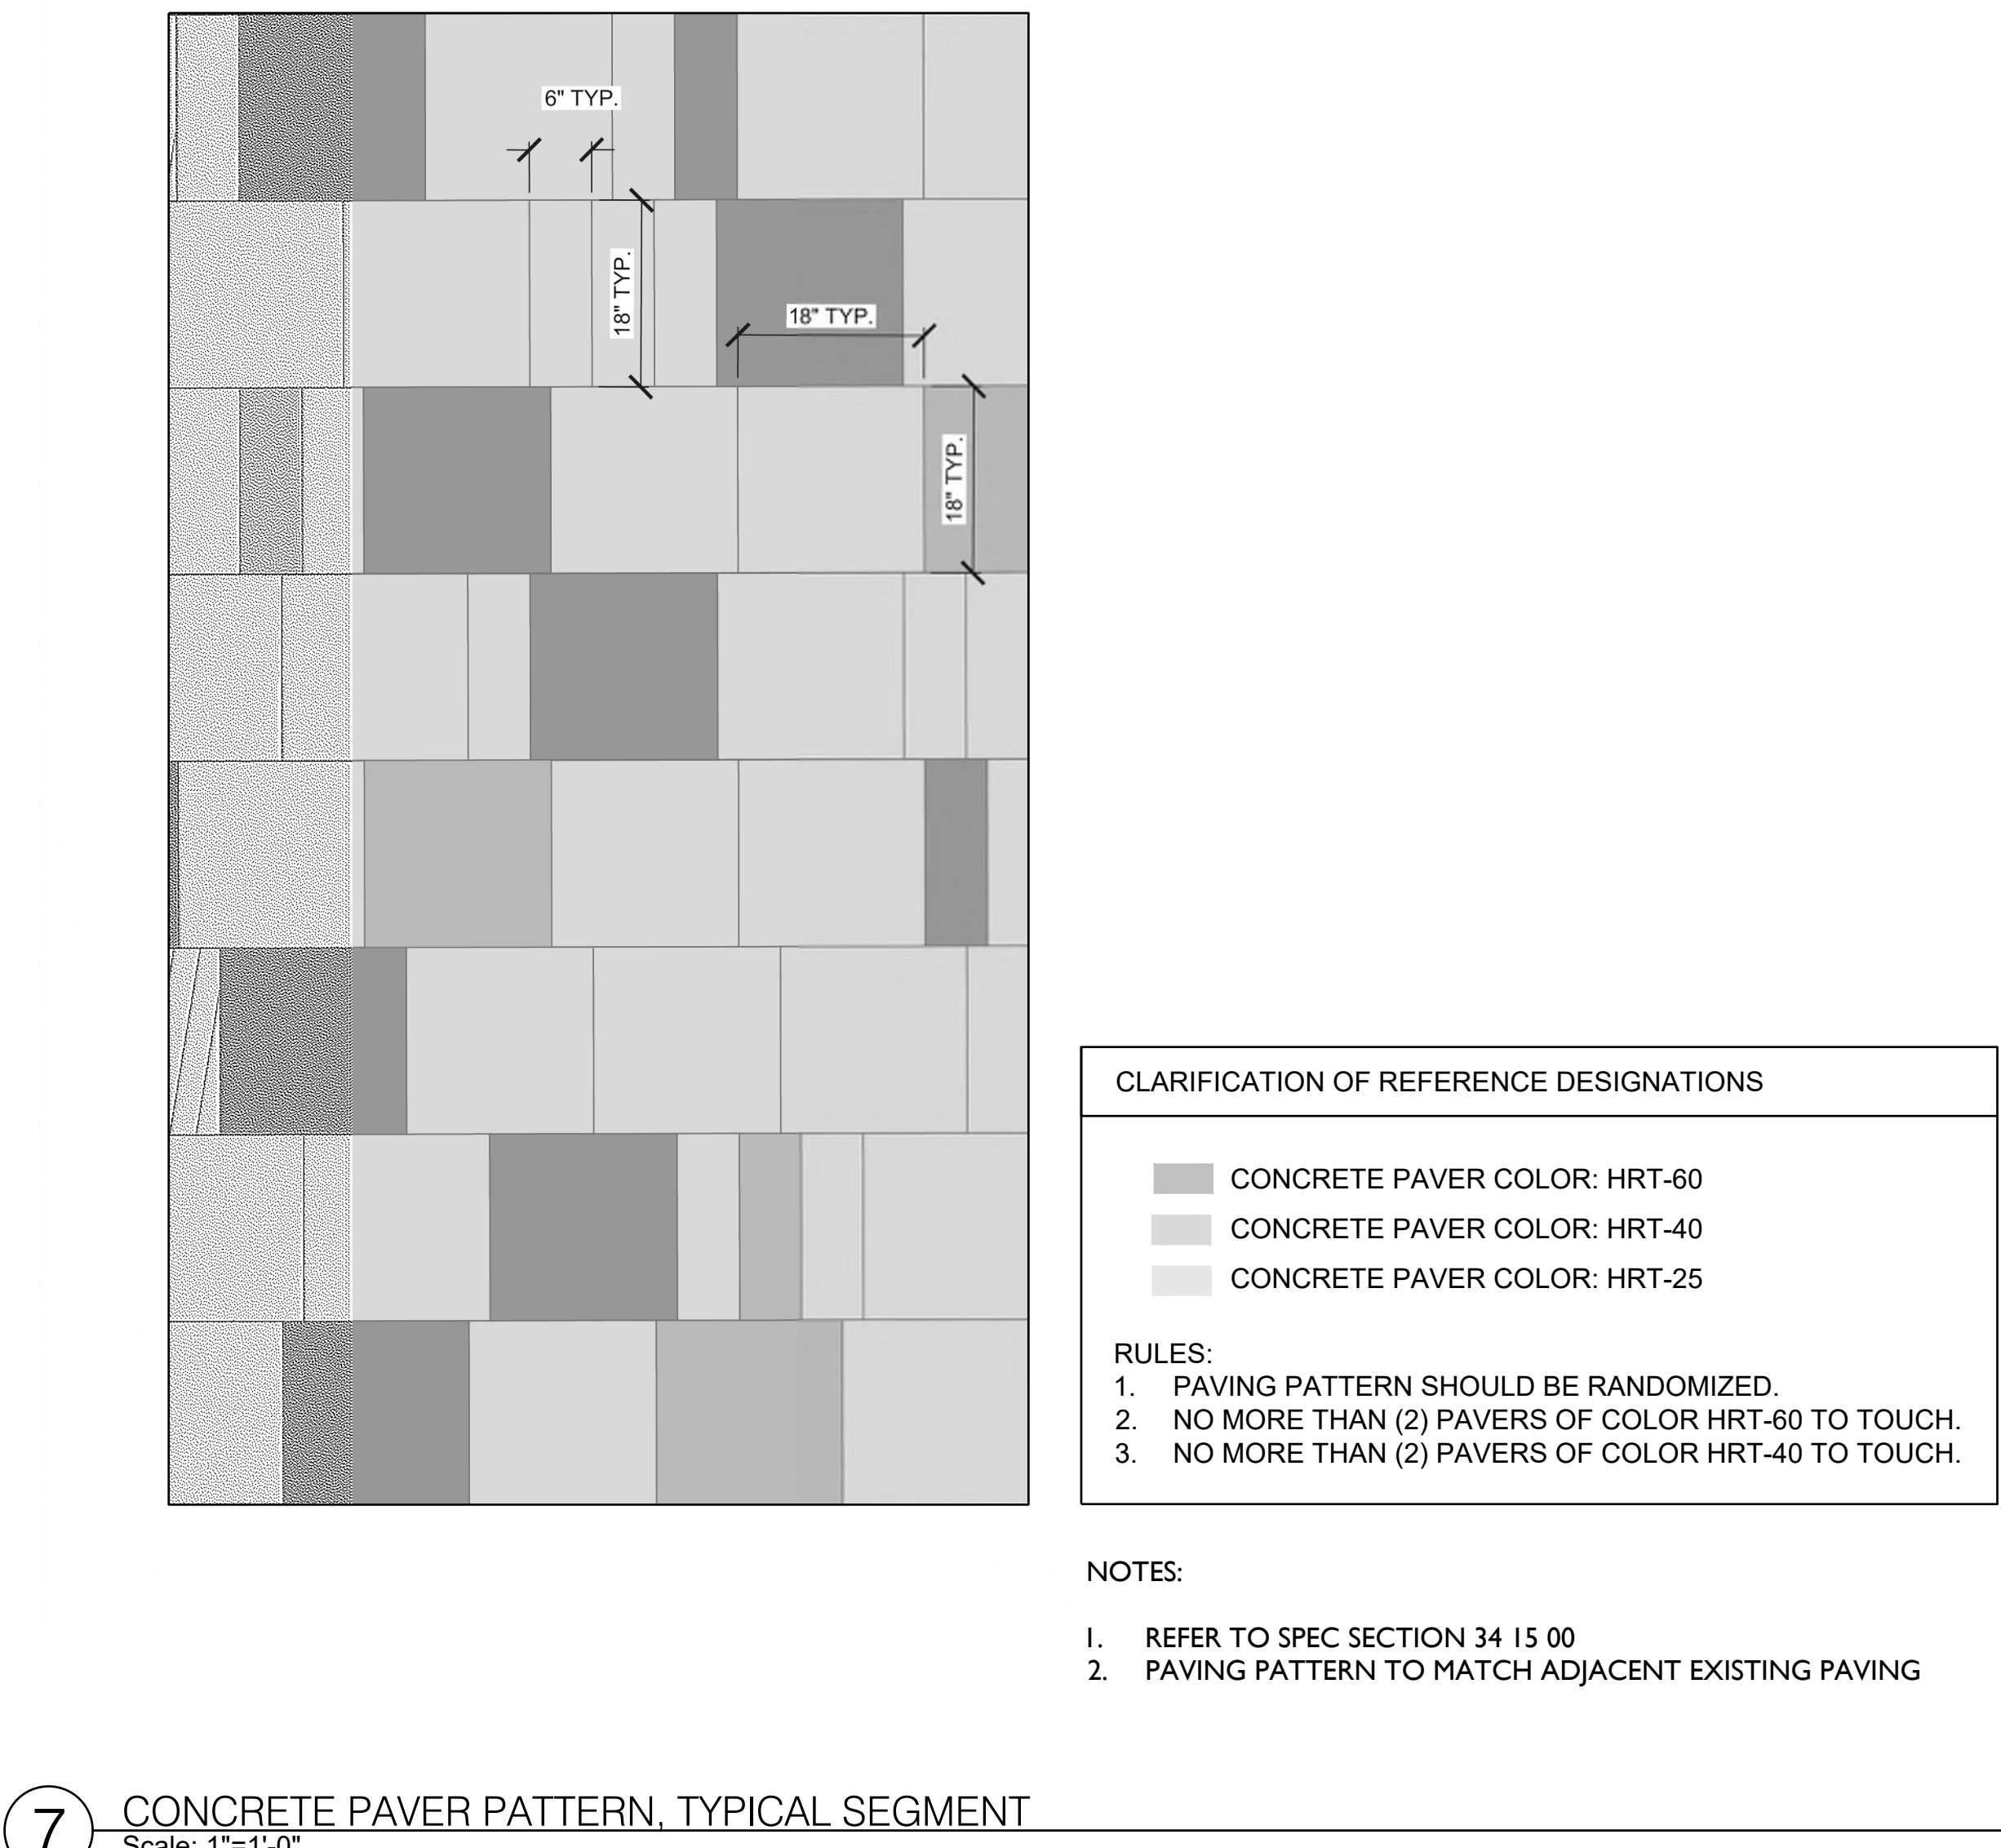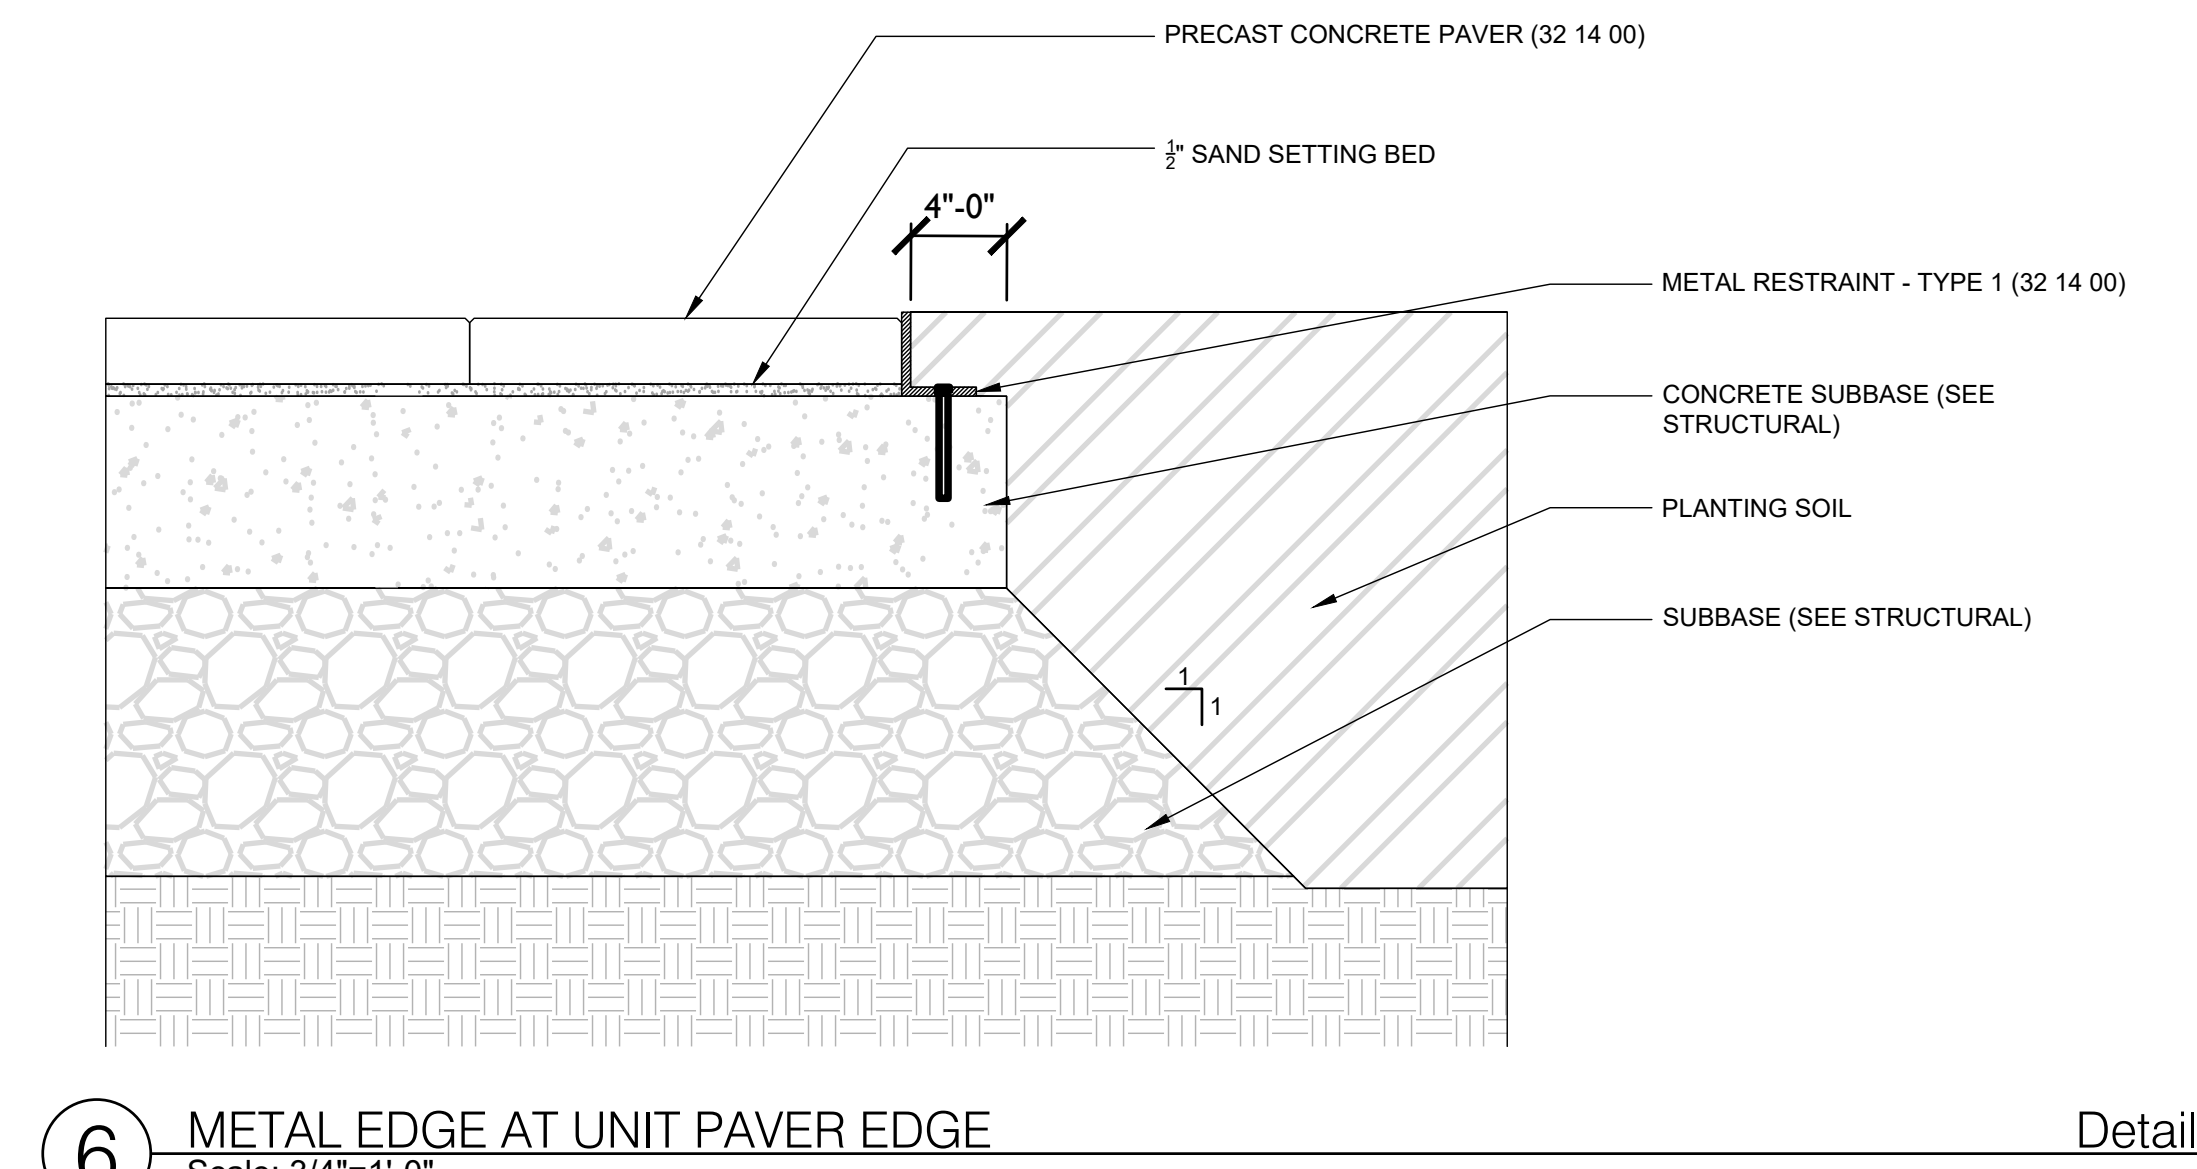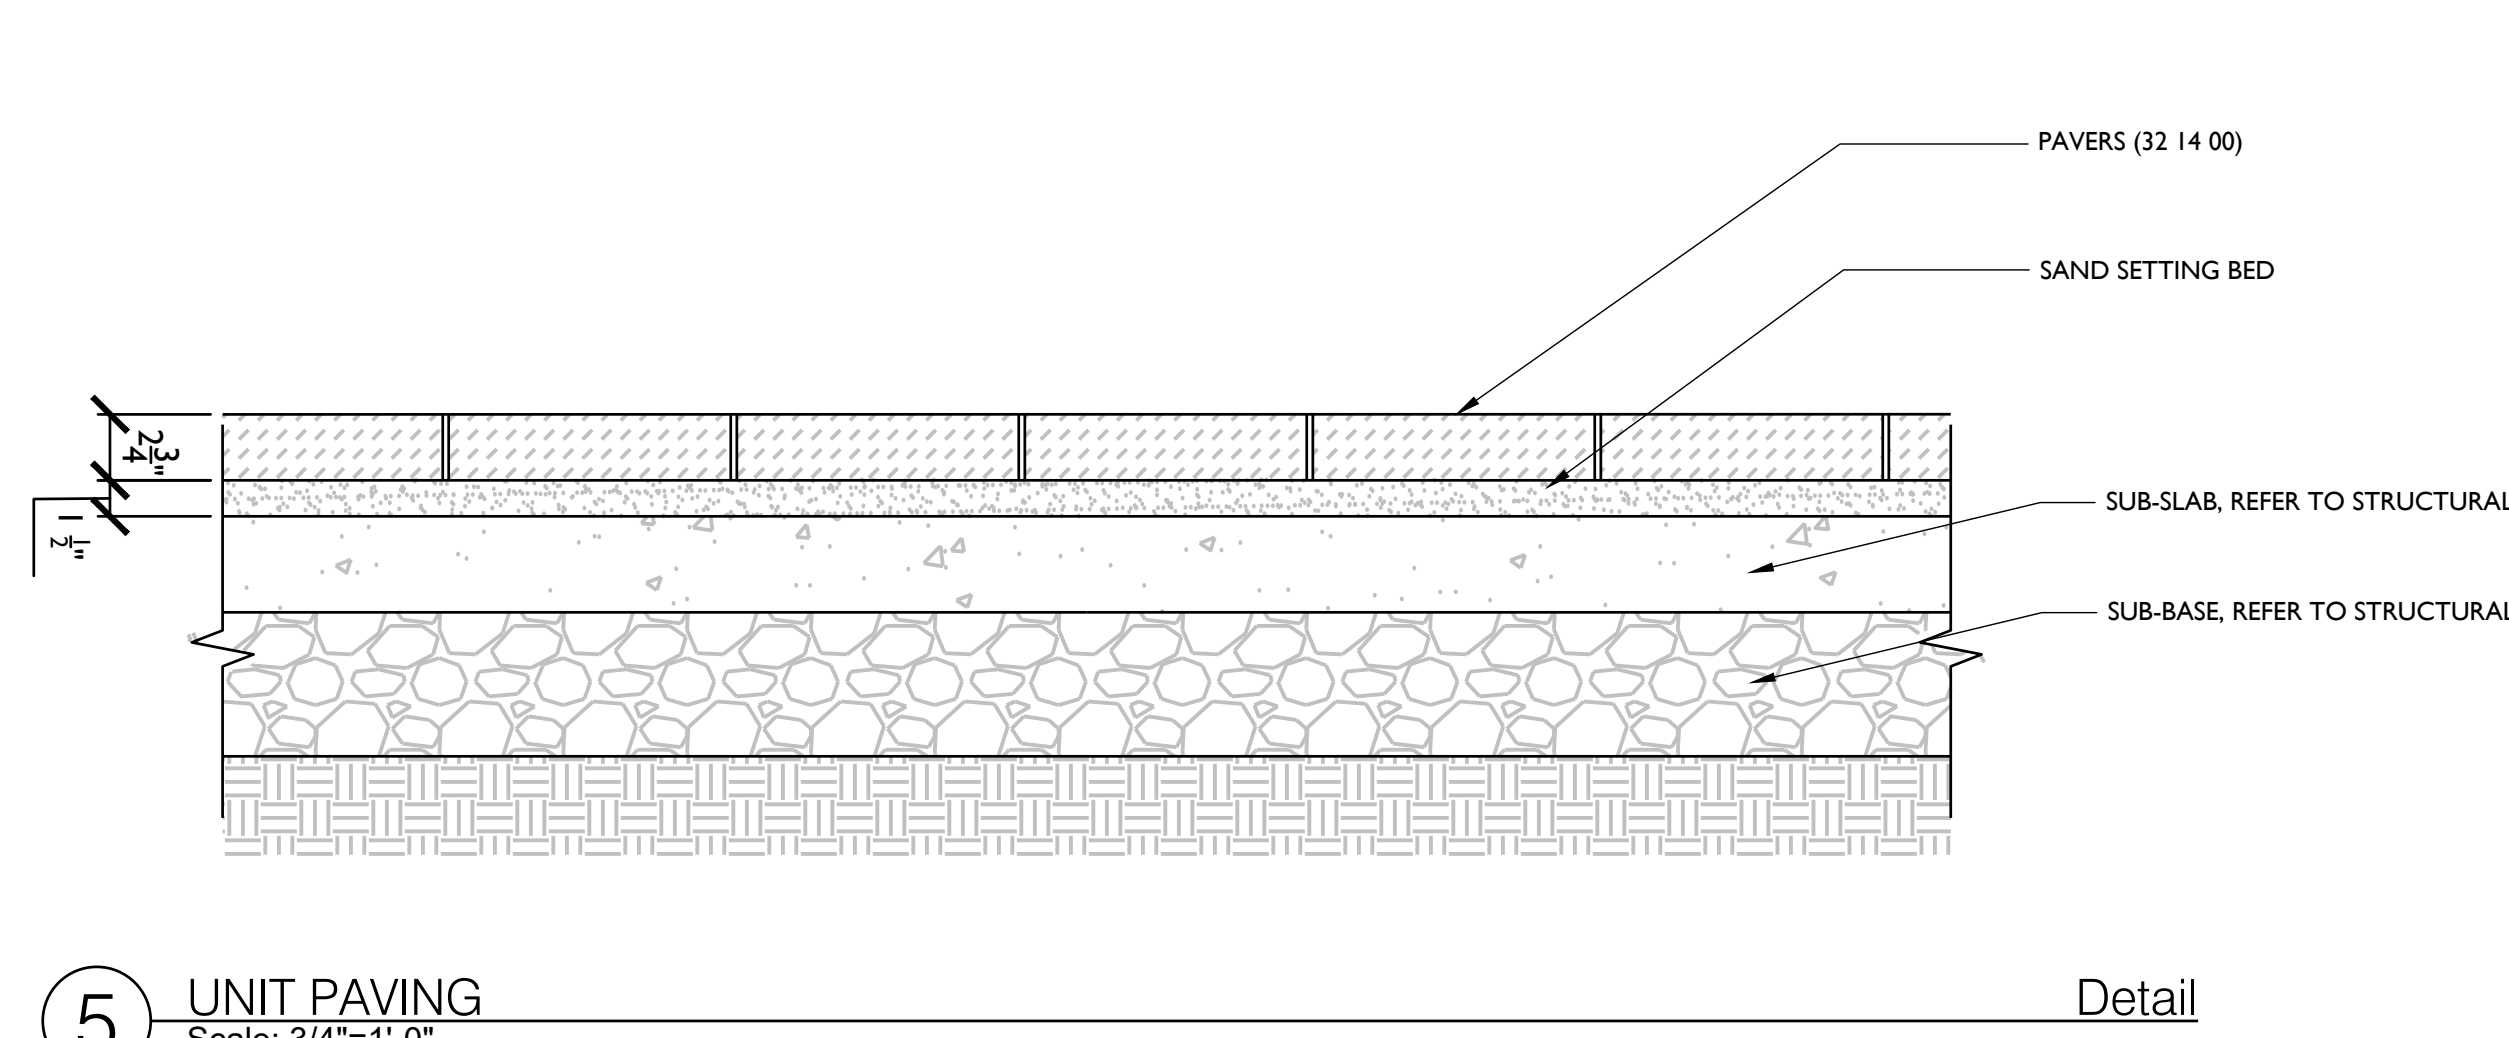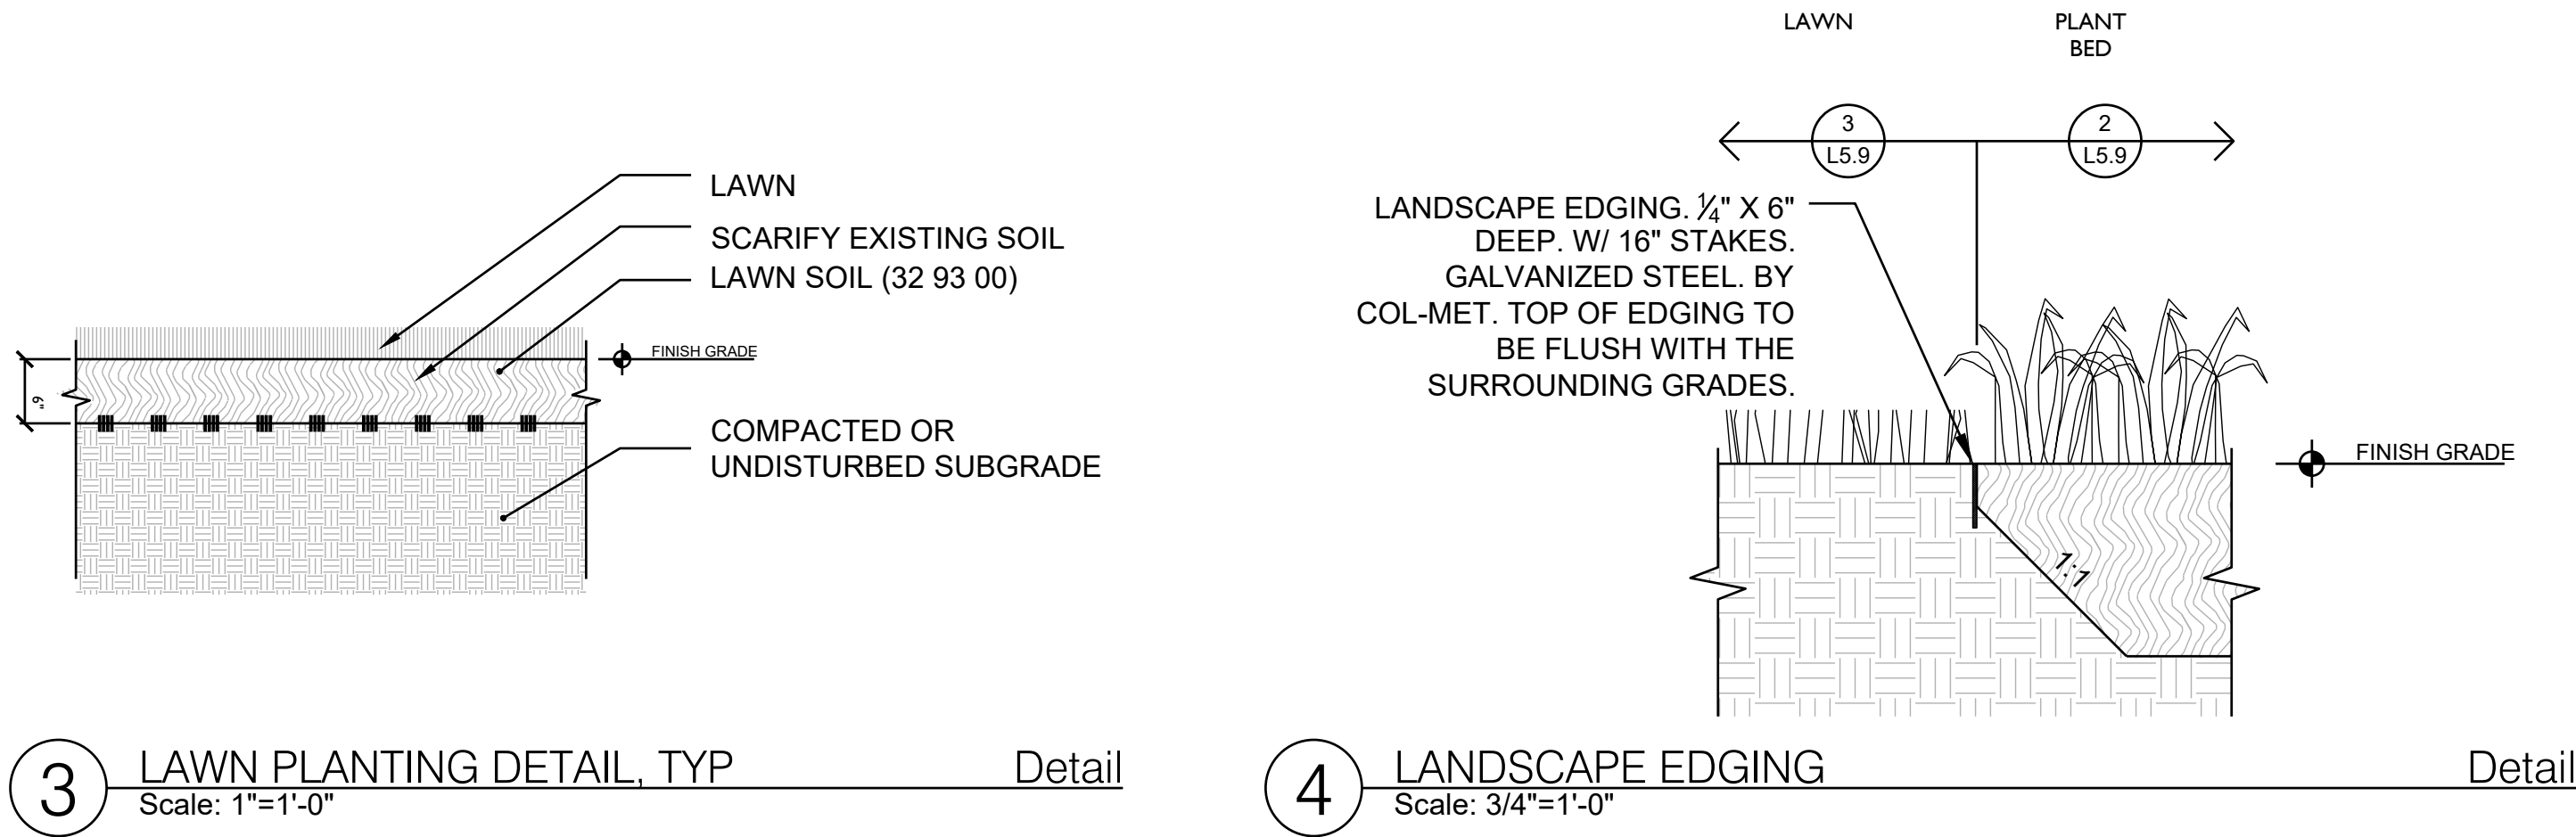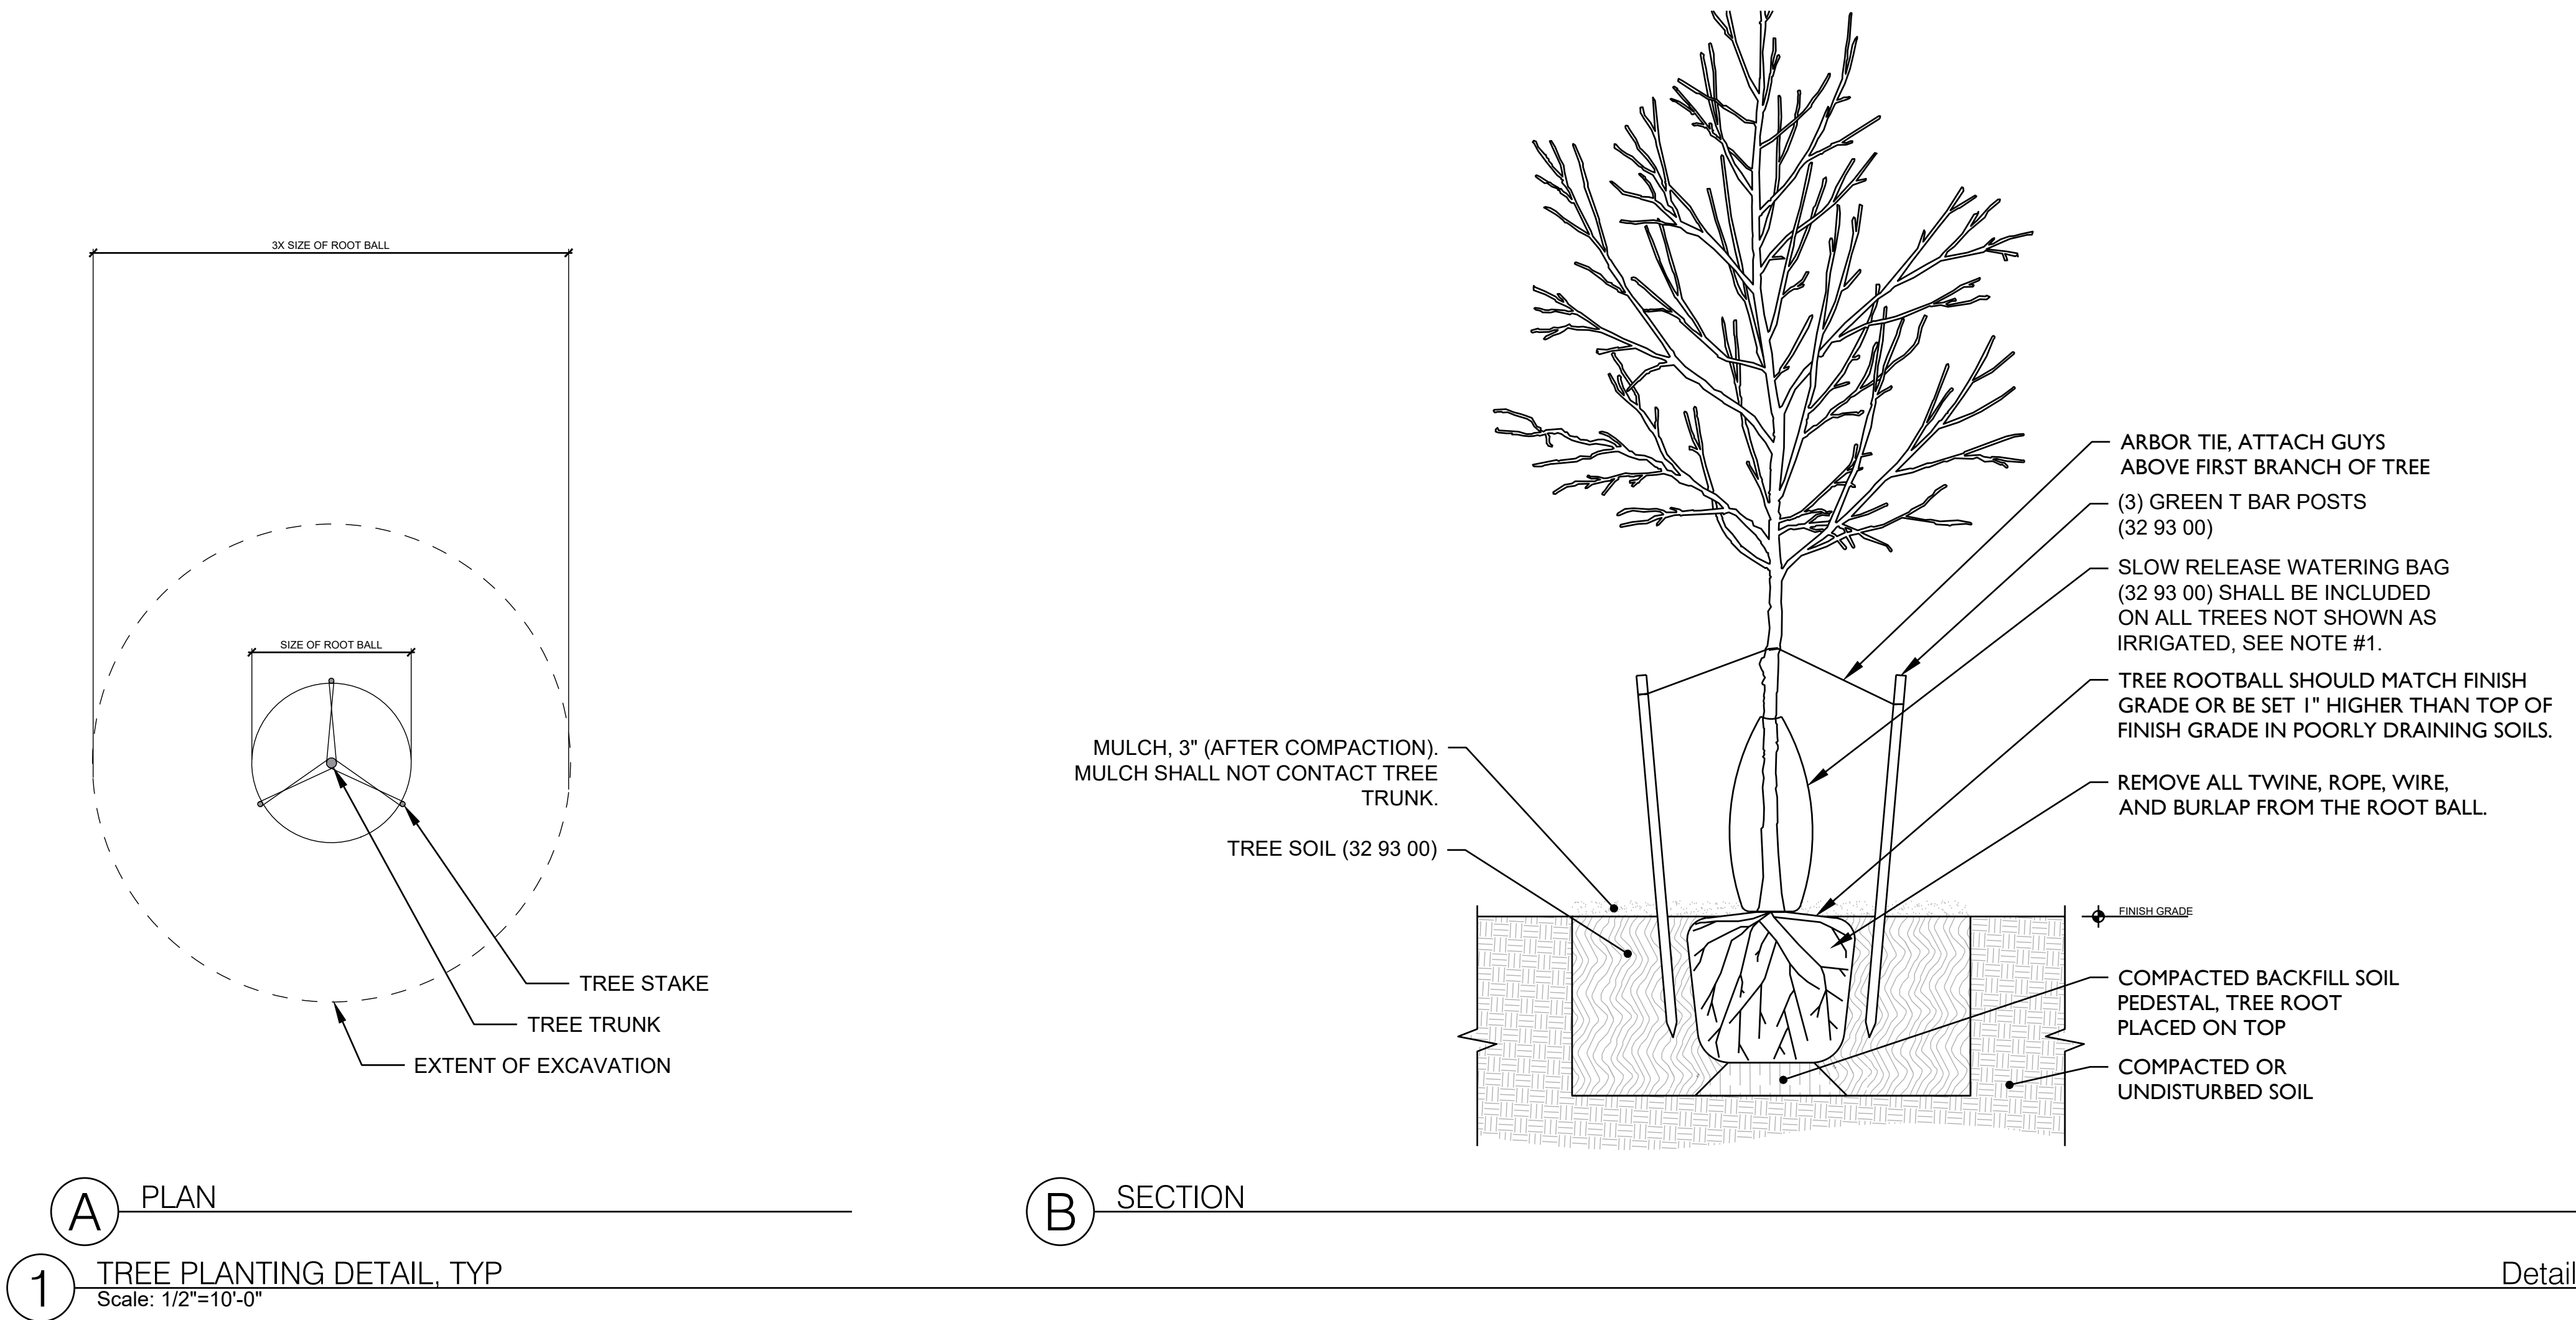

03 ELEVATION - MONUMENT SIGN
1.10 | 1" = 1'-0" |

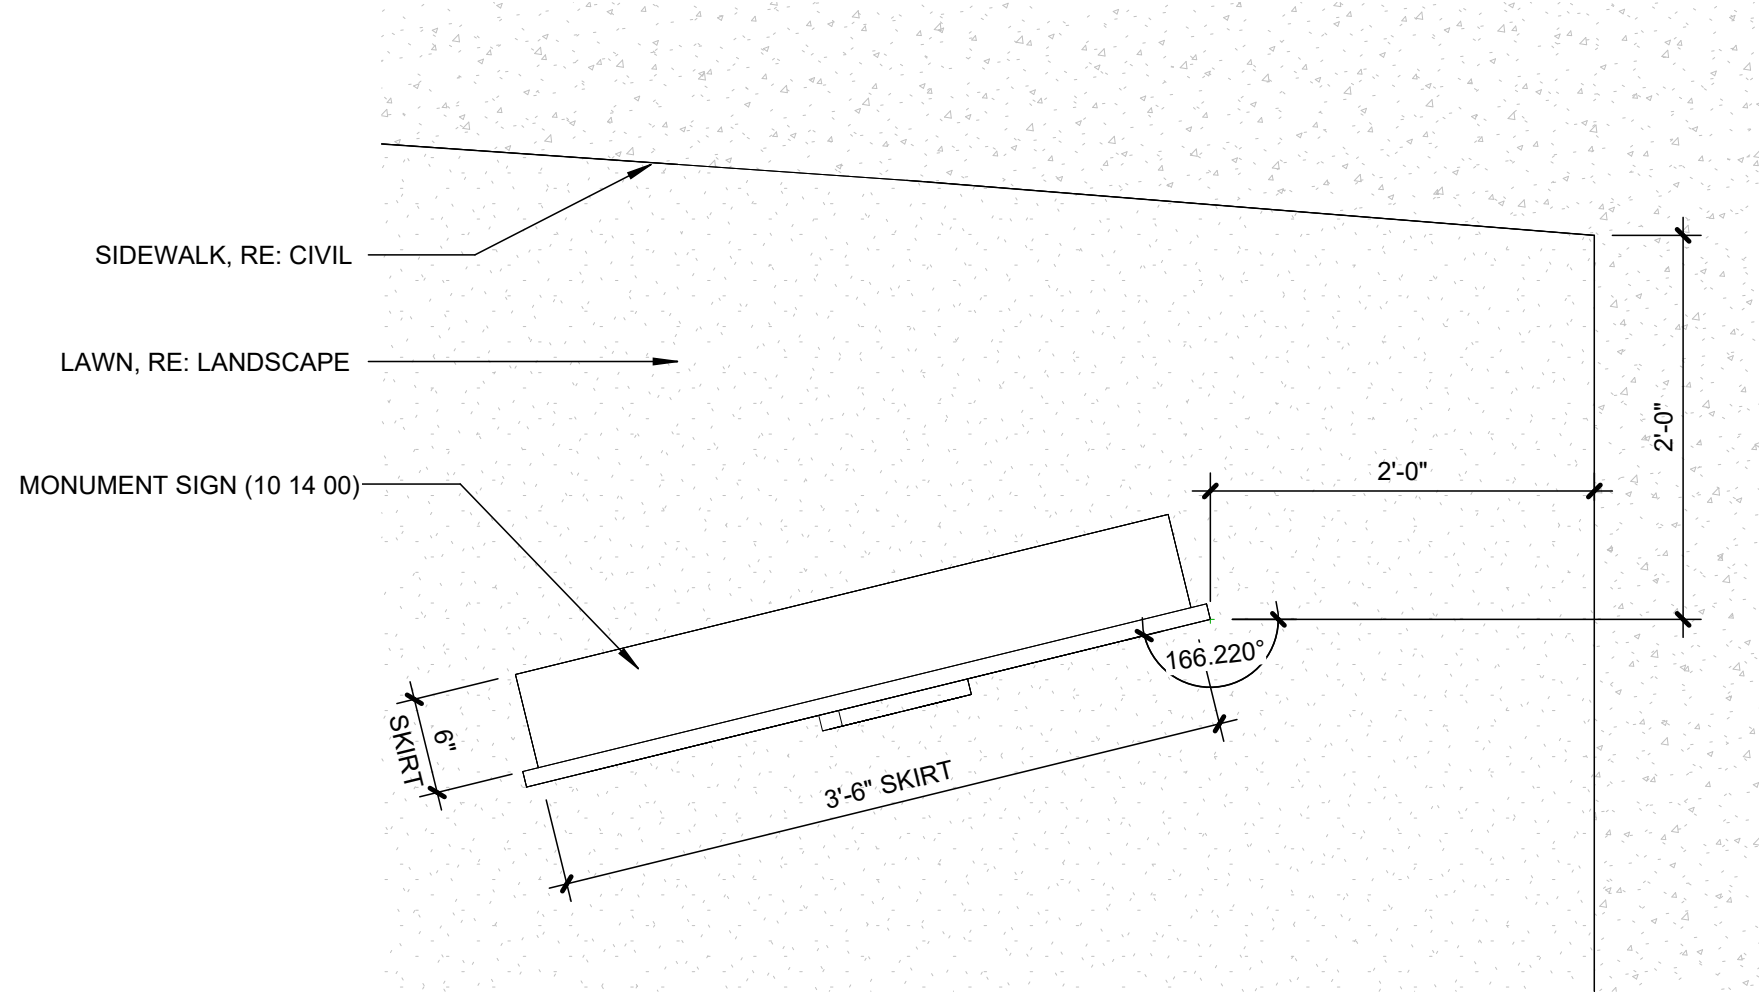

02 MONUMENT SIGN
1.10 | 1" = 1'-0" |

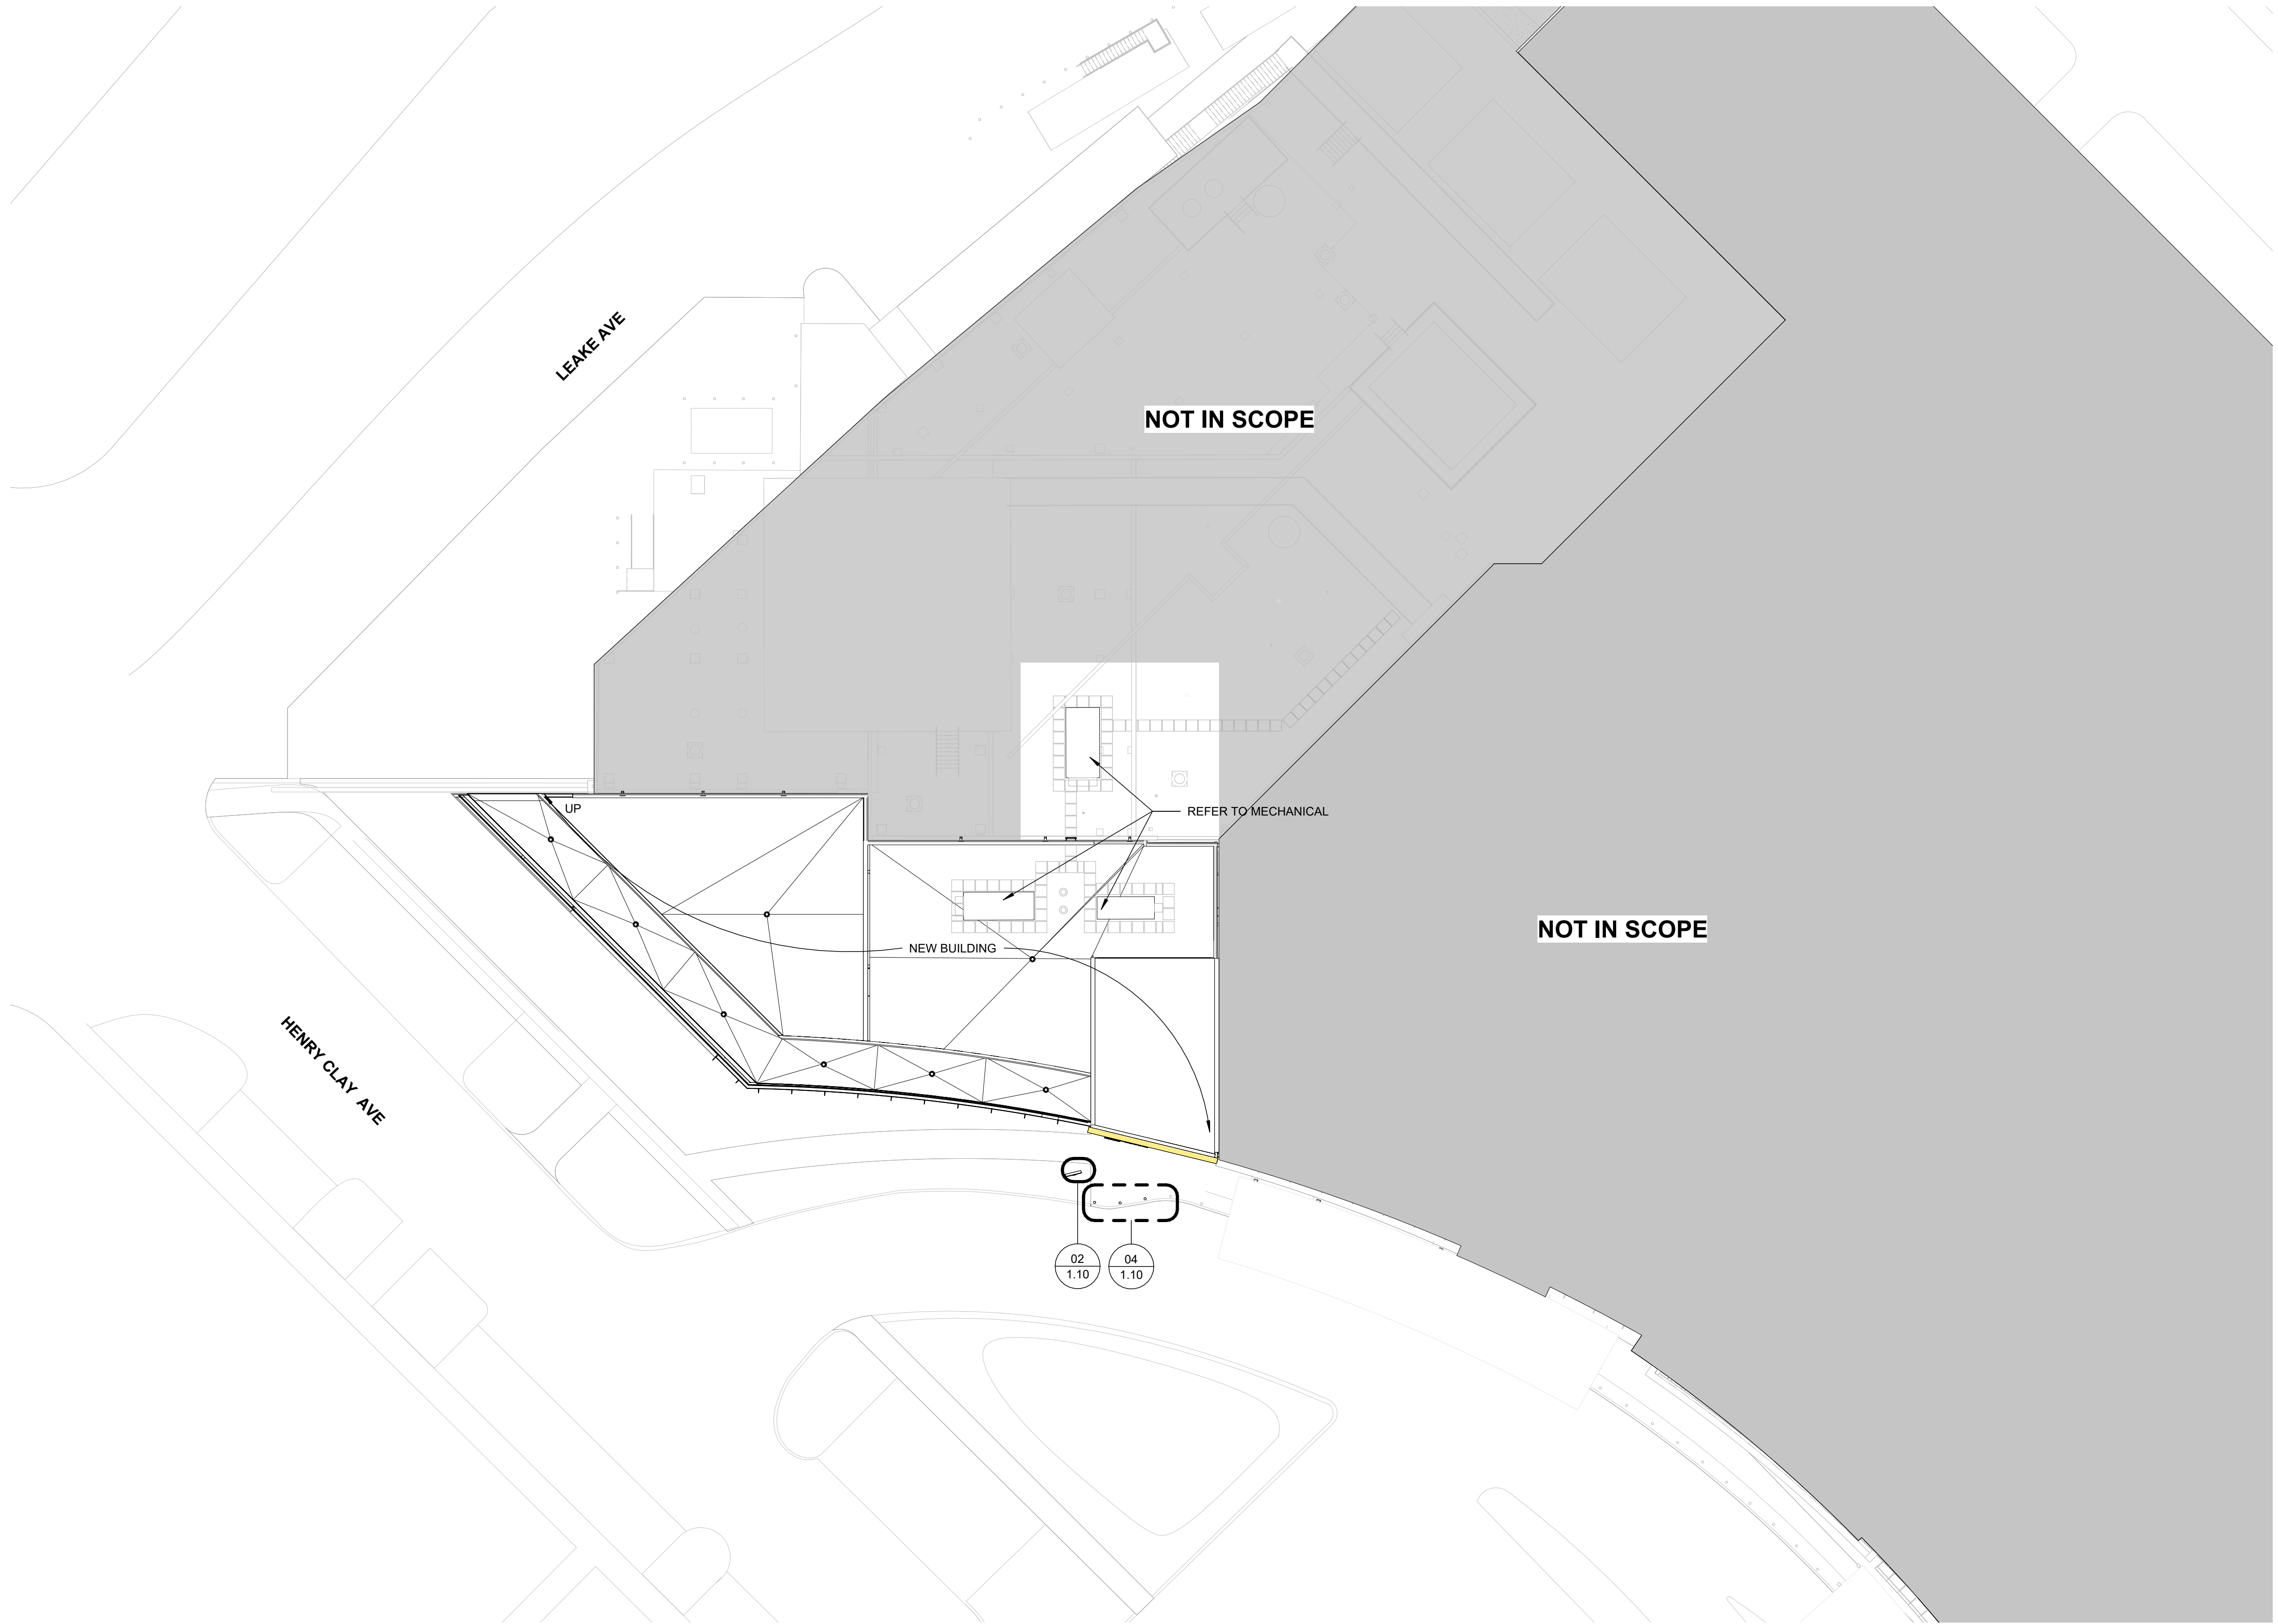

01 SITE PLAN
1" = 20'-0" |

WALKER'S IMAGINARIUM

200 HENRY CLAY AVENUE
NEW ORLEANS, LA 70118

EDR PROJECT NO. | 22003

PROJECT ISSUE DATE | 02 DECEMBER 2024


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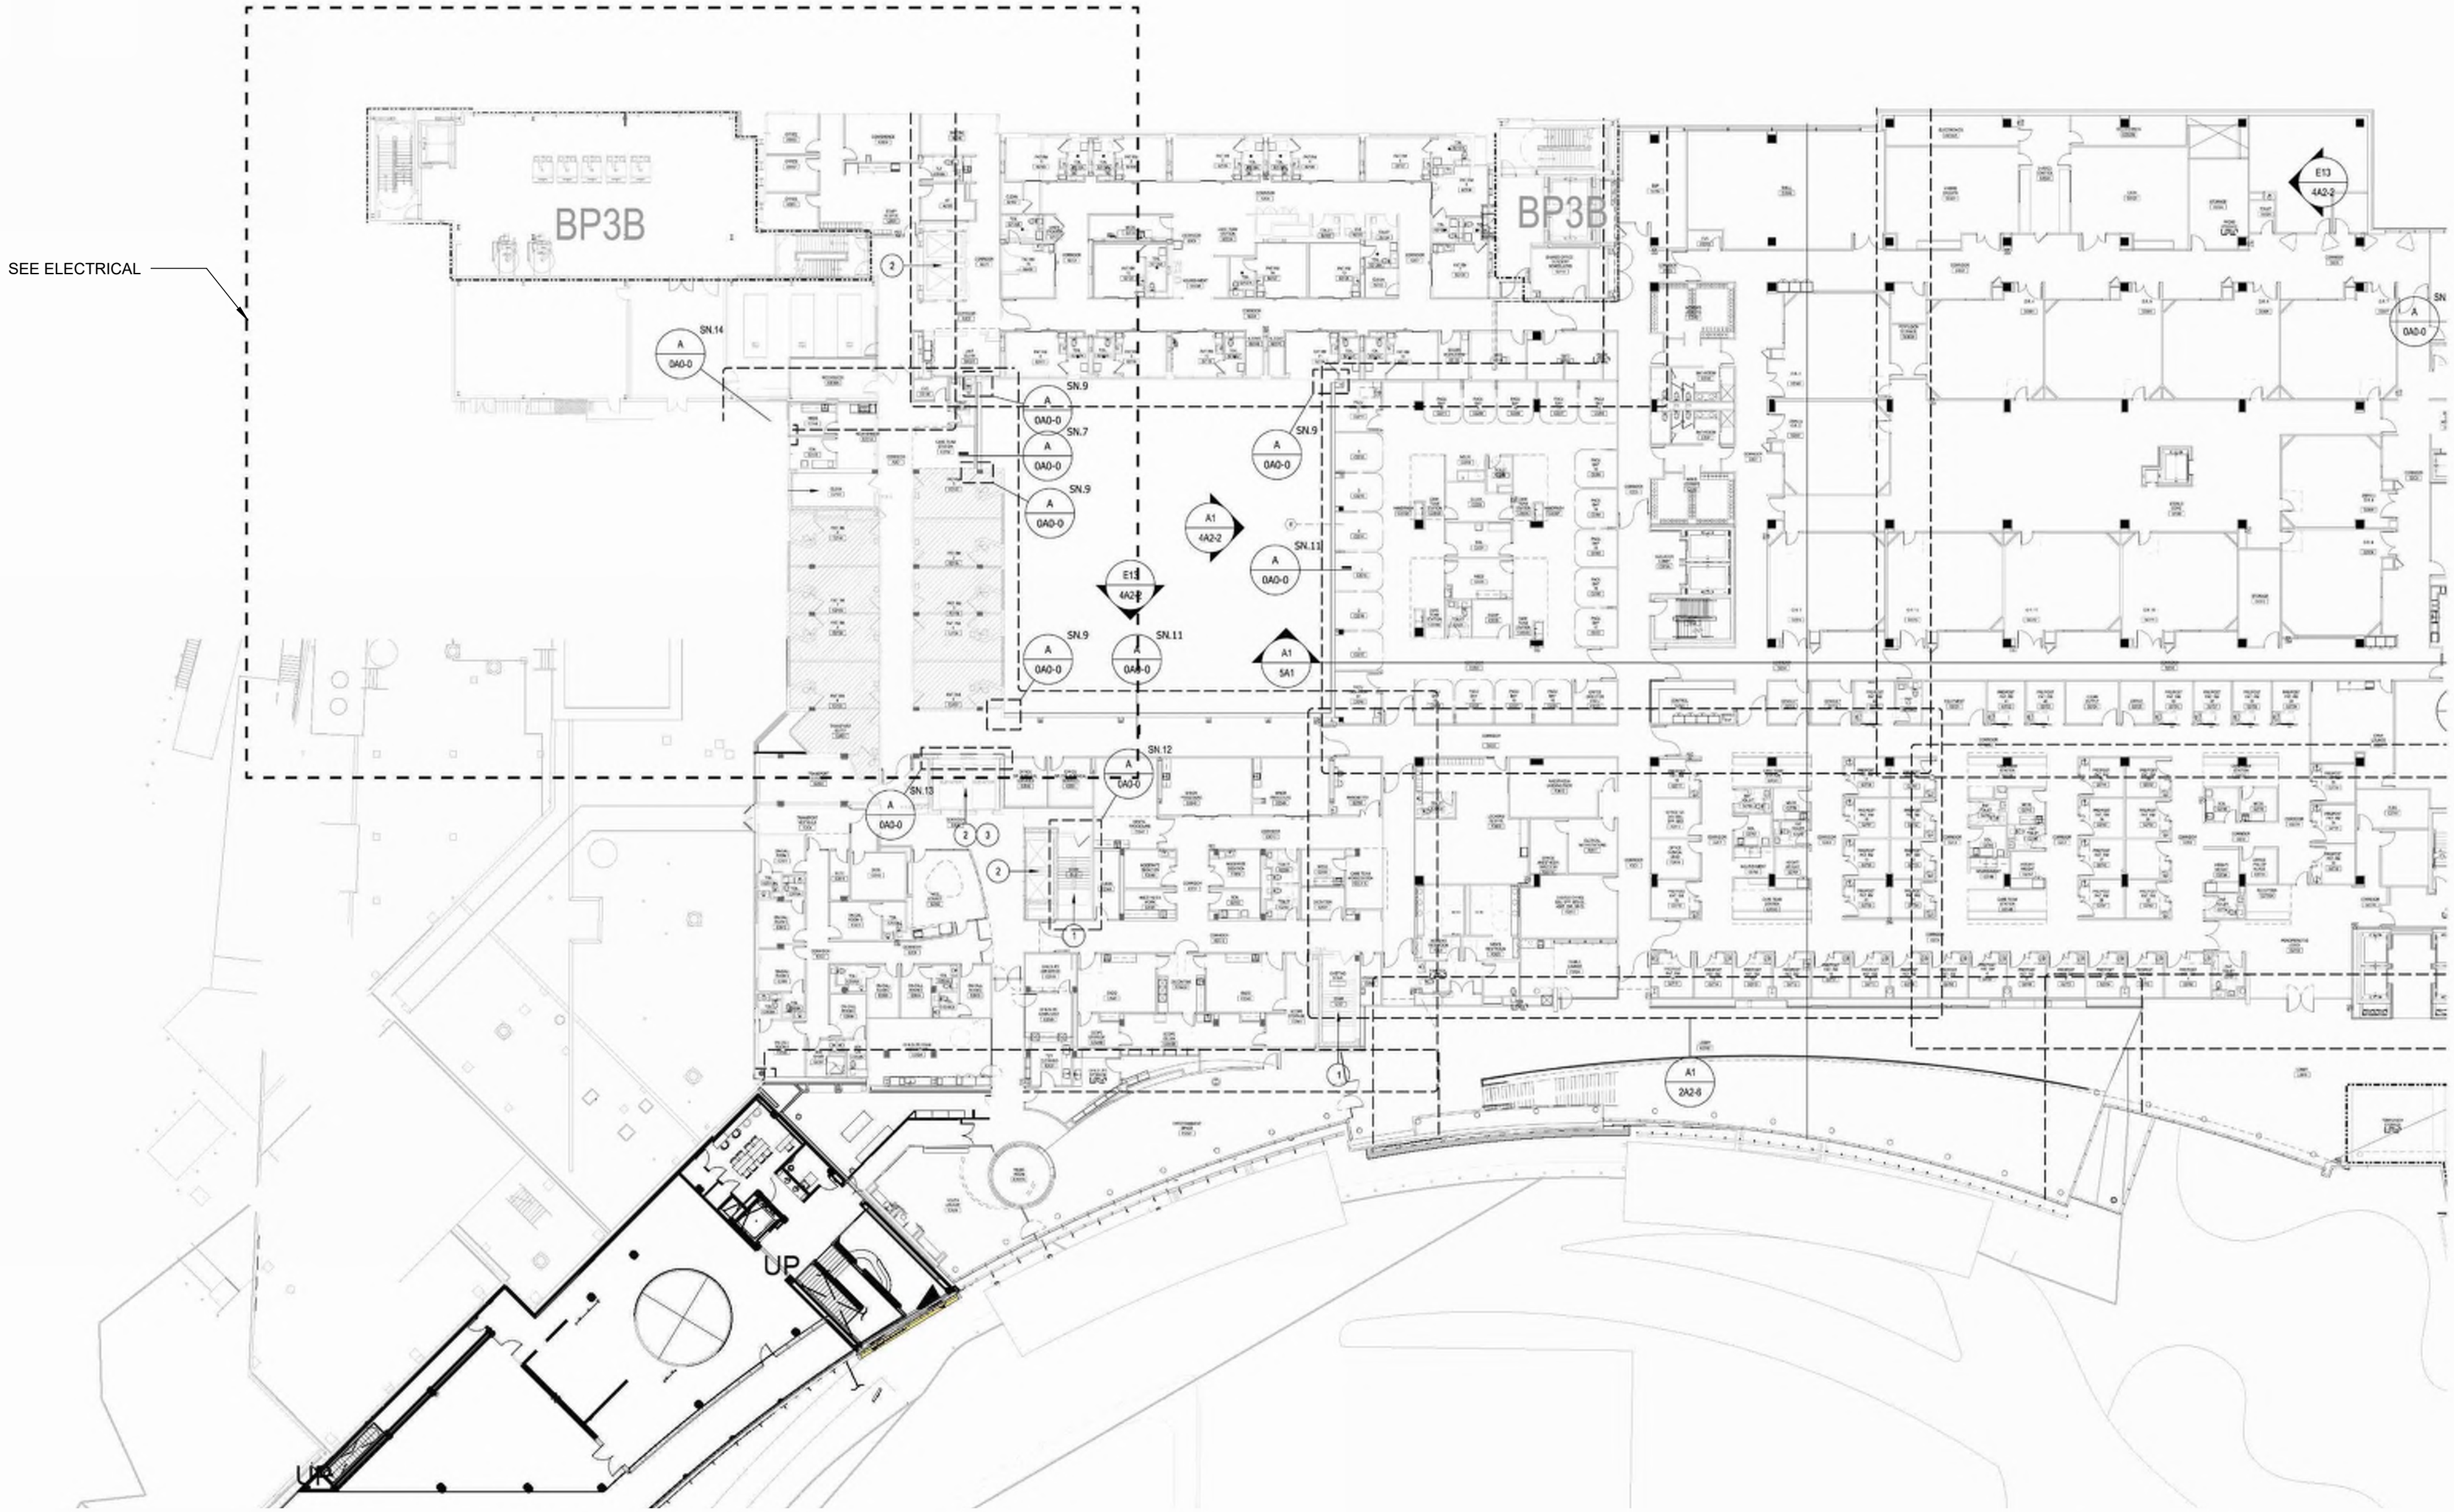
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REVISIONS
20 DEC 2024 ADDENDUM 002

SITE PLAN - ARCHITECTURAL





02 SECOND FLOOR PLAN - REFERENCE PLAN
1" = 30'-0"

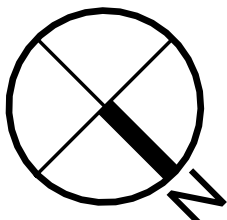

01 FIRST FLOOR PLAN - REFERENCE PLAN
1" = 30'-0"



03 Key Plan
1" = 200'-0"

WALKER'S IMAGINARIUM

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NEW ORLEANS, LA 70118

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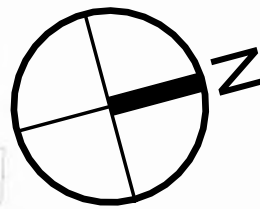
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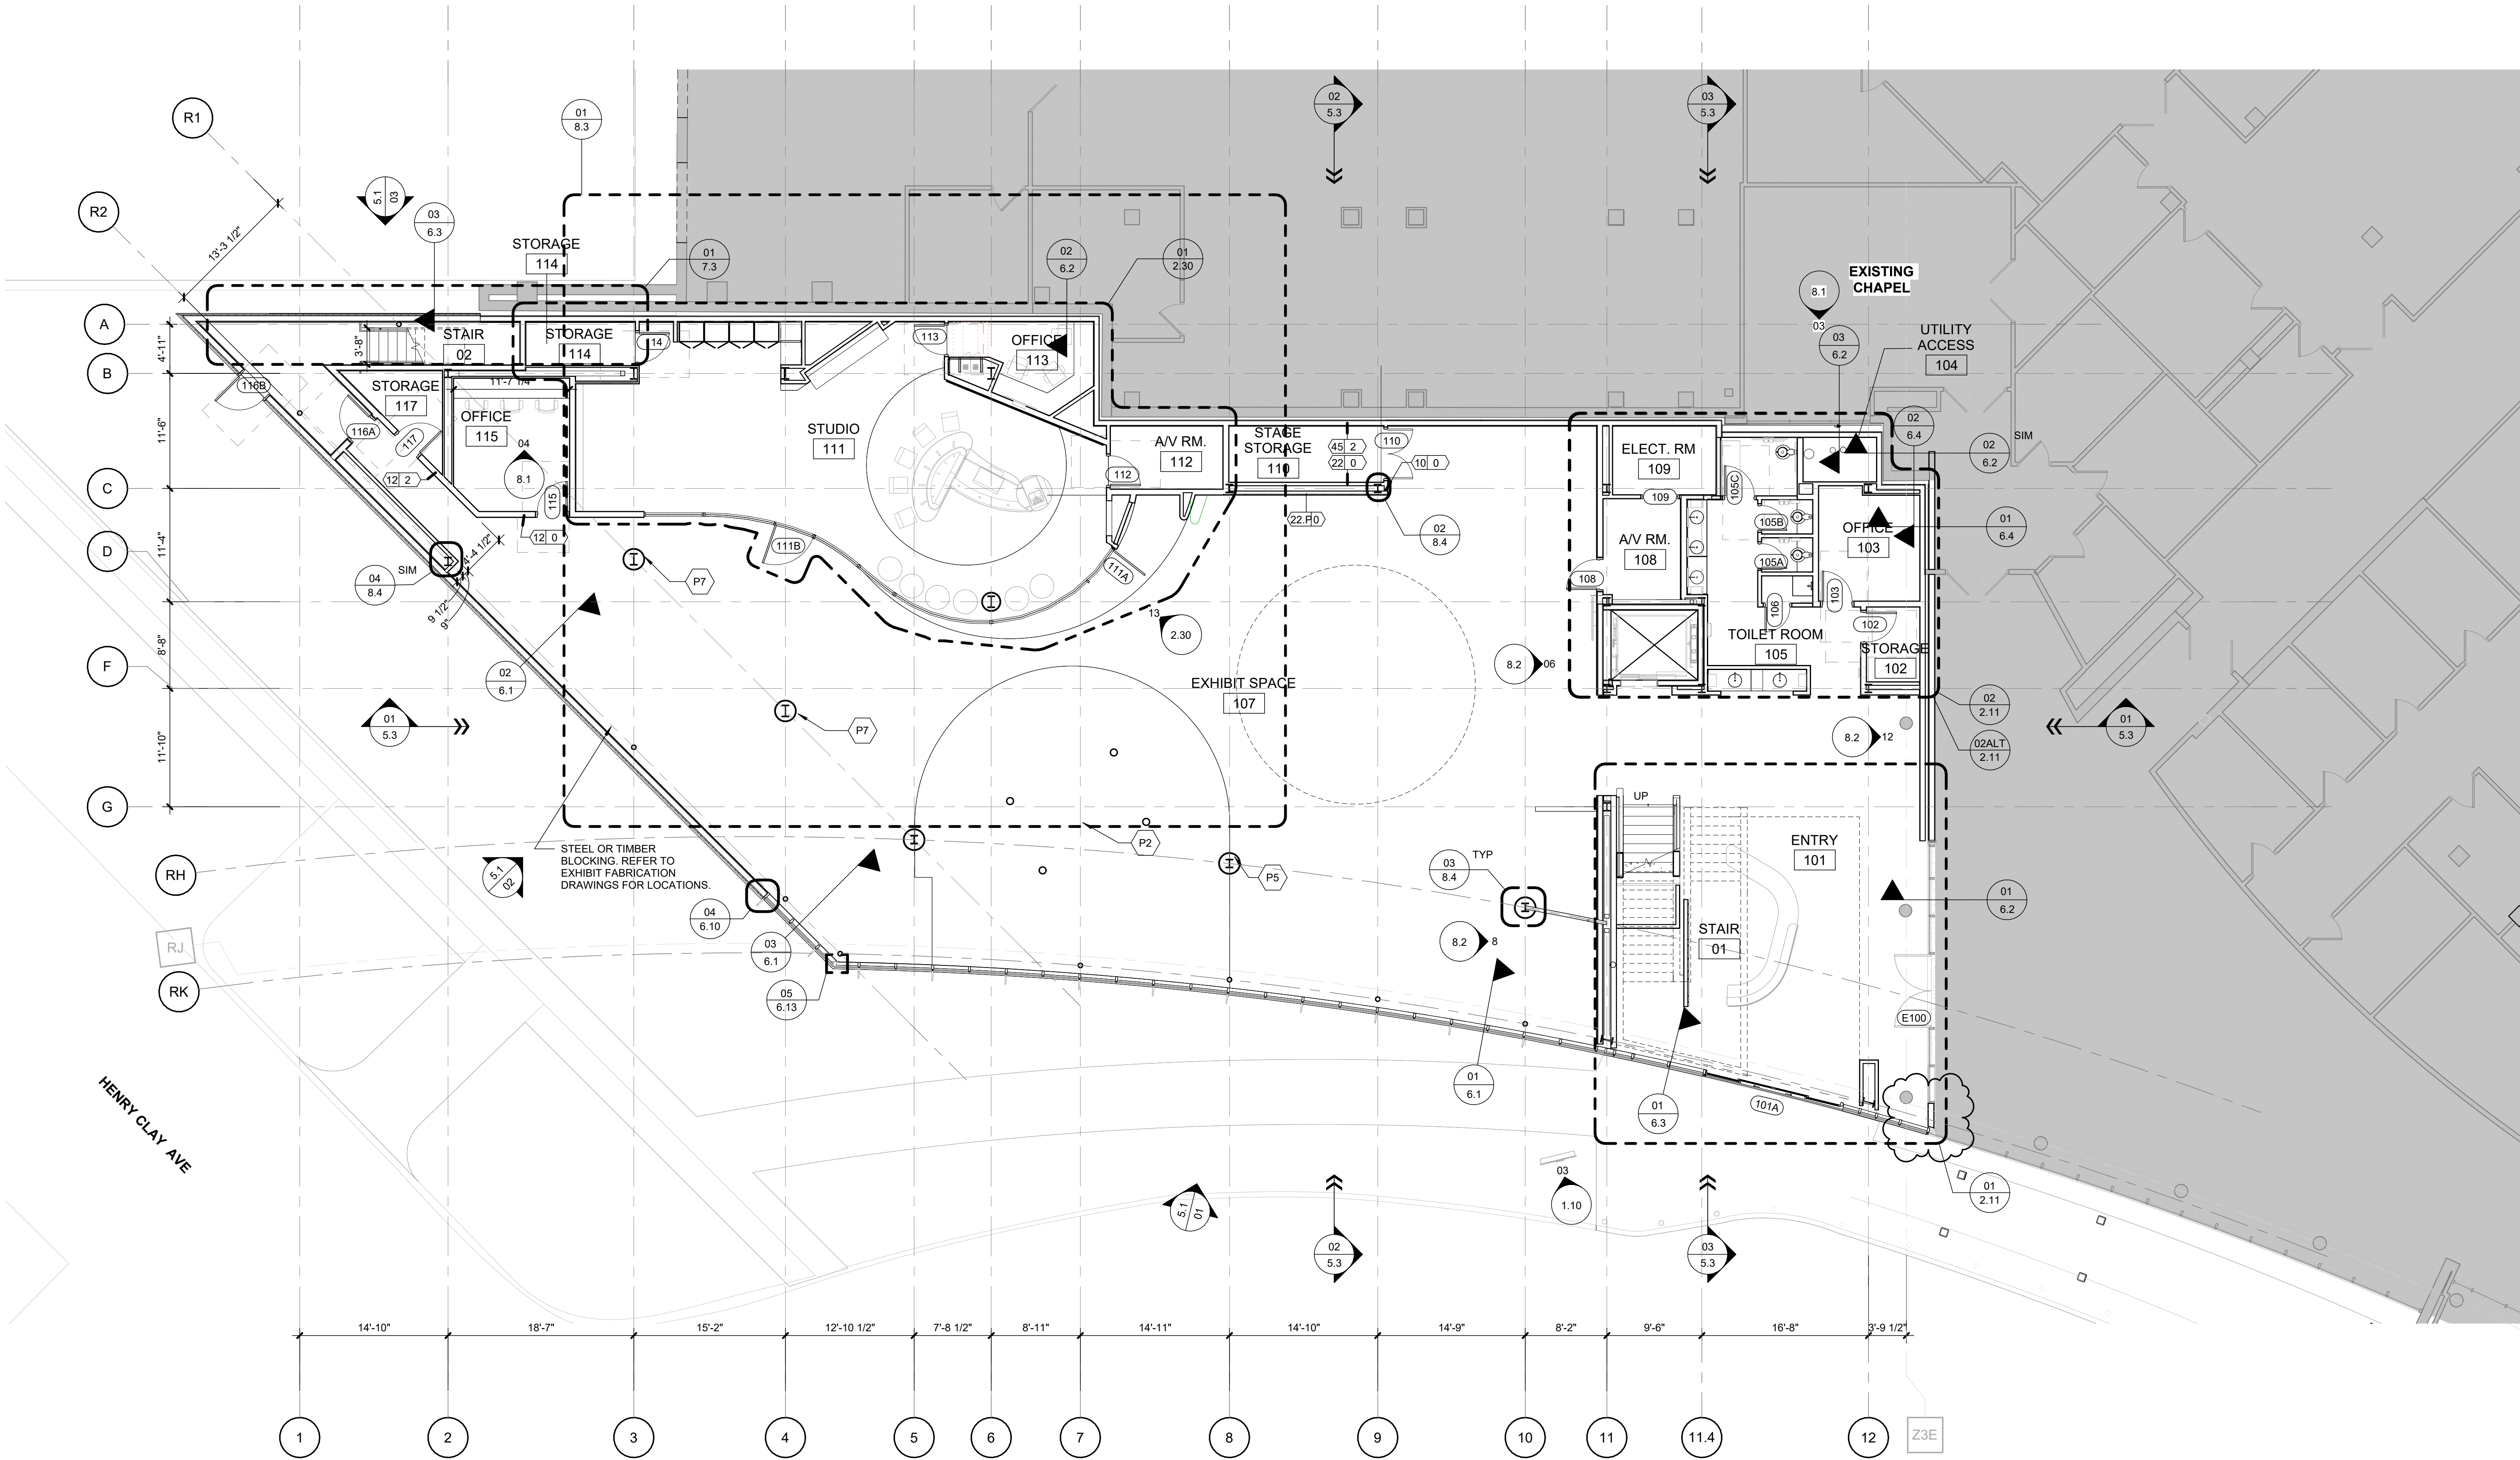
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REVISIONS

REFERENCE FLOOR PLANS



CLARIFICATION OF REFERENCE DESIGNATIONS	
P2	COORDINATE FOUNDATION WITH STRUCTURAL AND VENDOR DRAWINGS
P5	CAMERA PROVIDED BY RYAN SEACREST FOUNDATION MOUNTED TO COLUMN, MOUNTING HEIGHT AT 8'0" AFF, PROVIDE BLOCKING, PROVIDE LOW VOLTAGE AND VIDEO BACK TO SEACREST STUDIO SPACE
P7	BLOCKING TO BE PROVIDED COORDINATE LOCATION WITH EXHIBIT DESIGN PACKAGE



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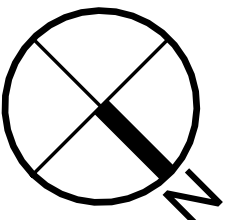
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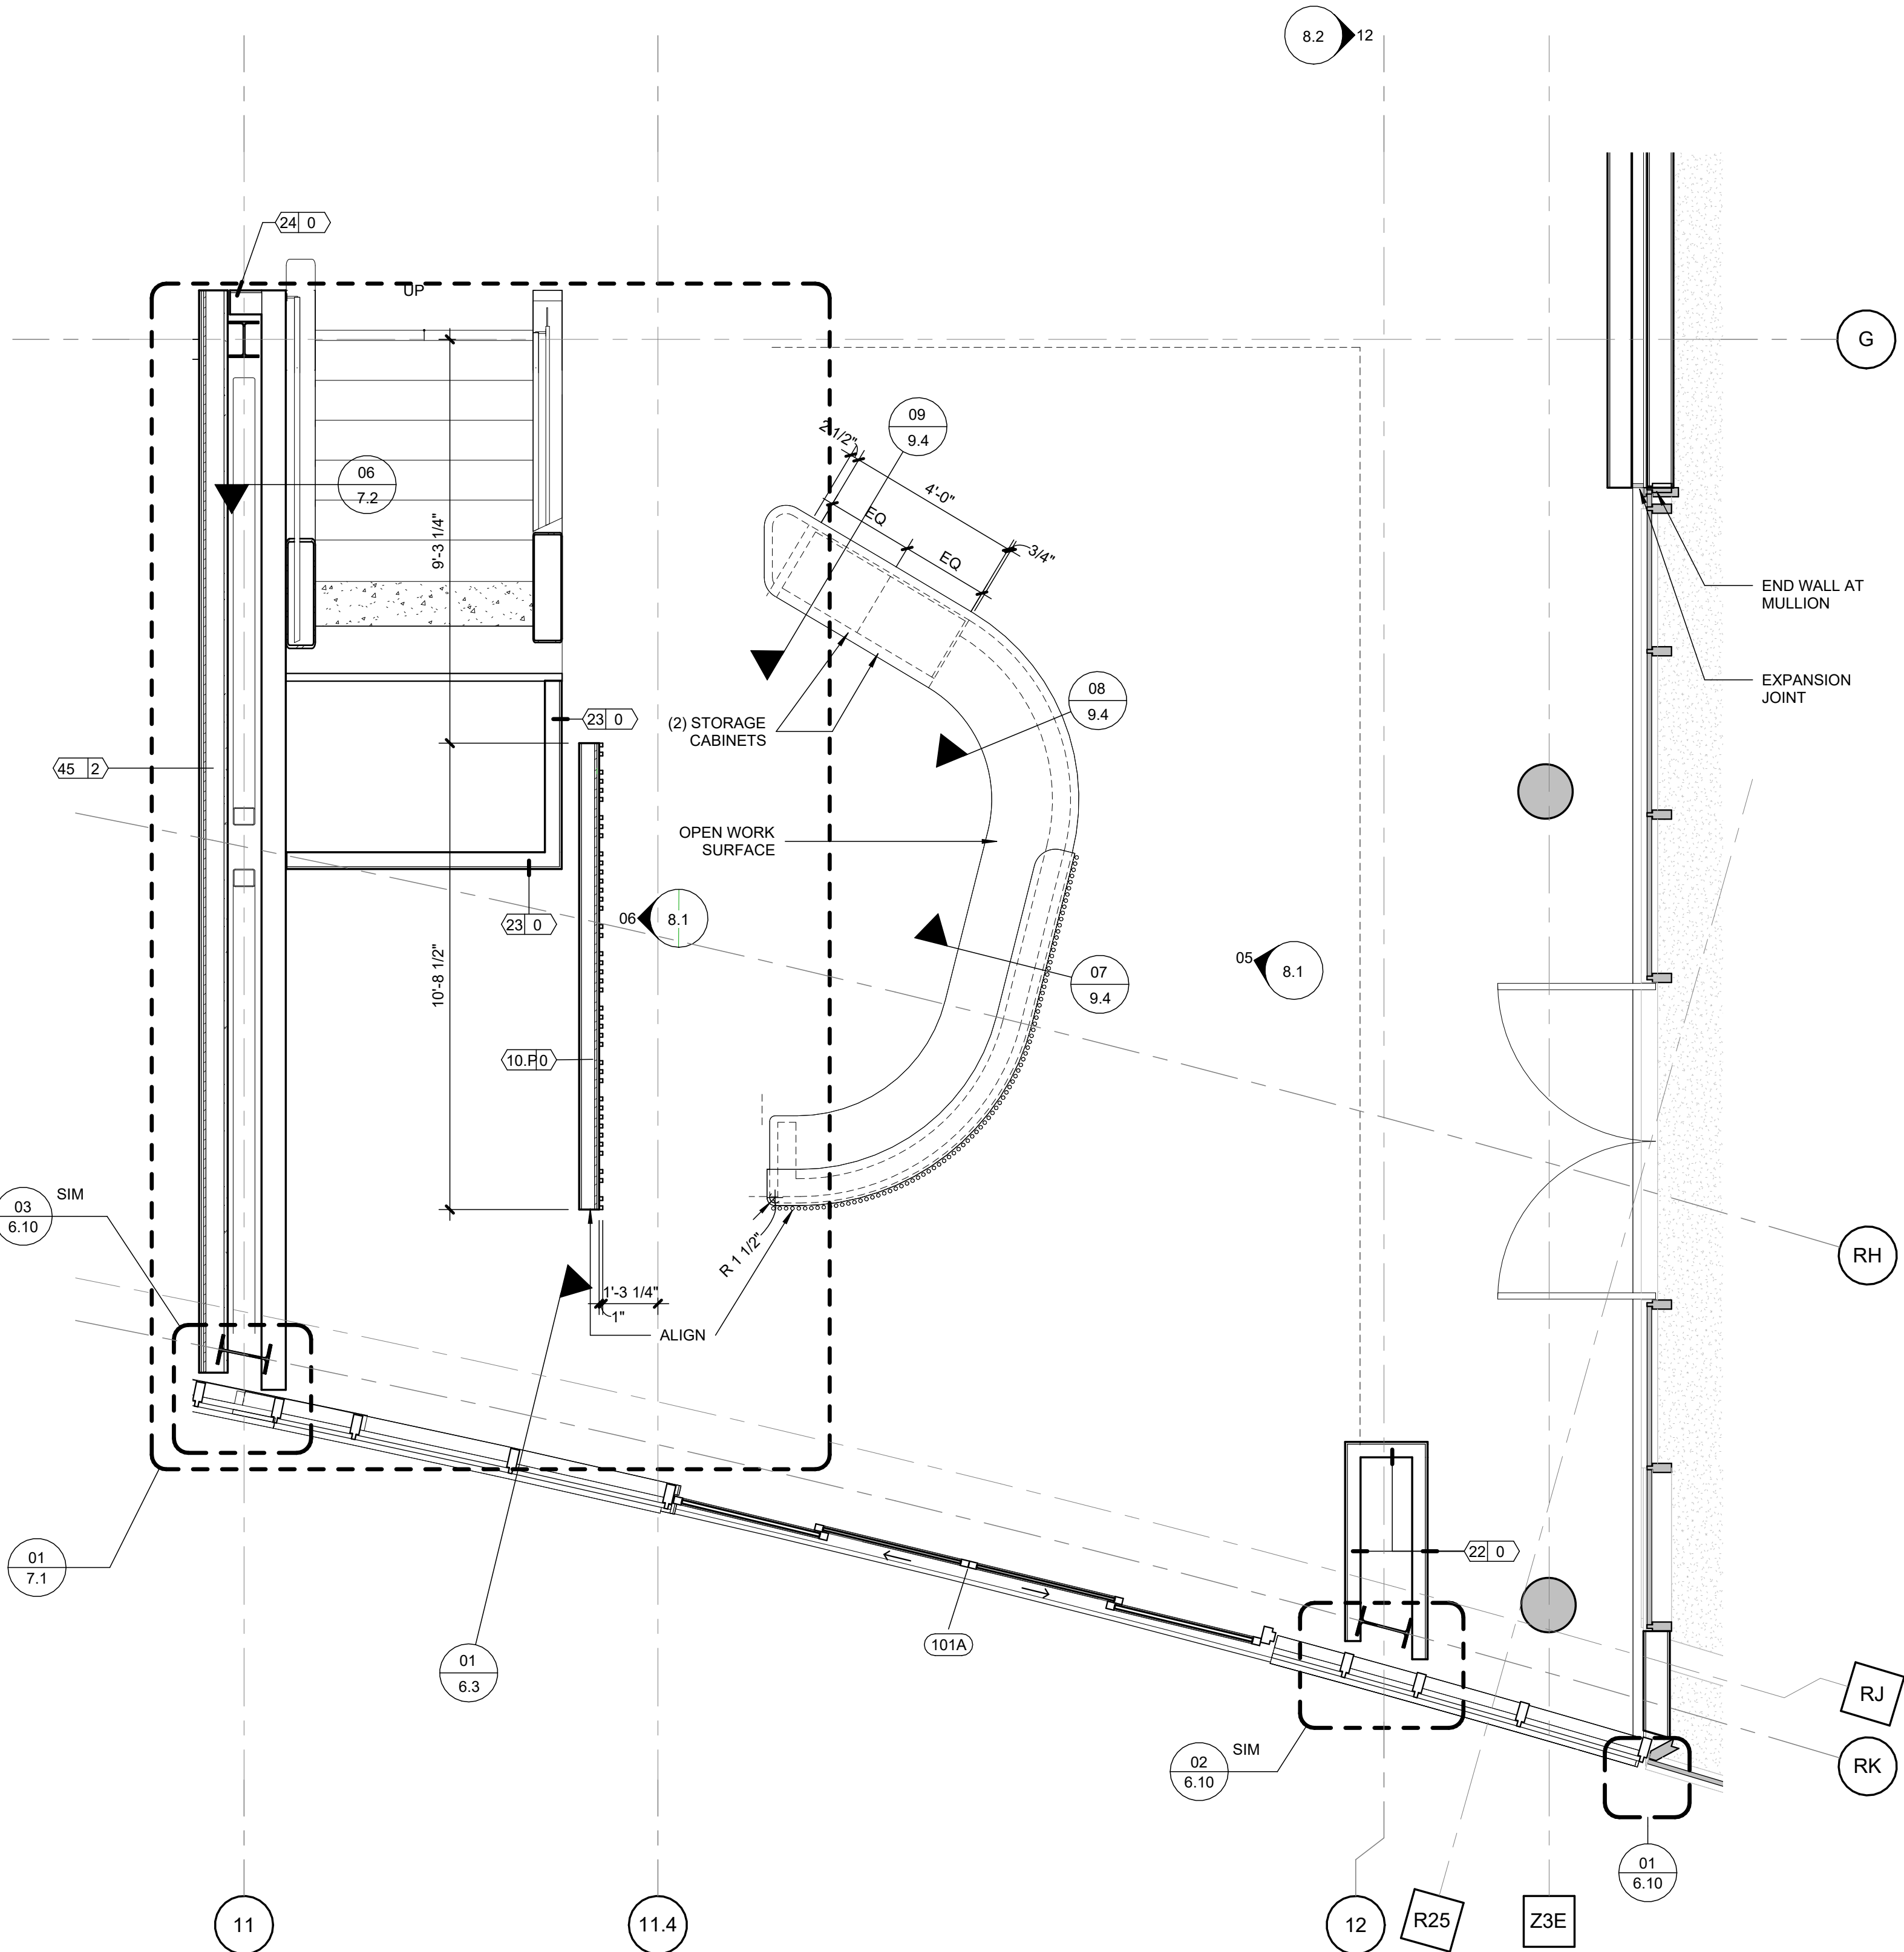
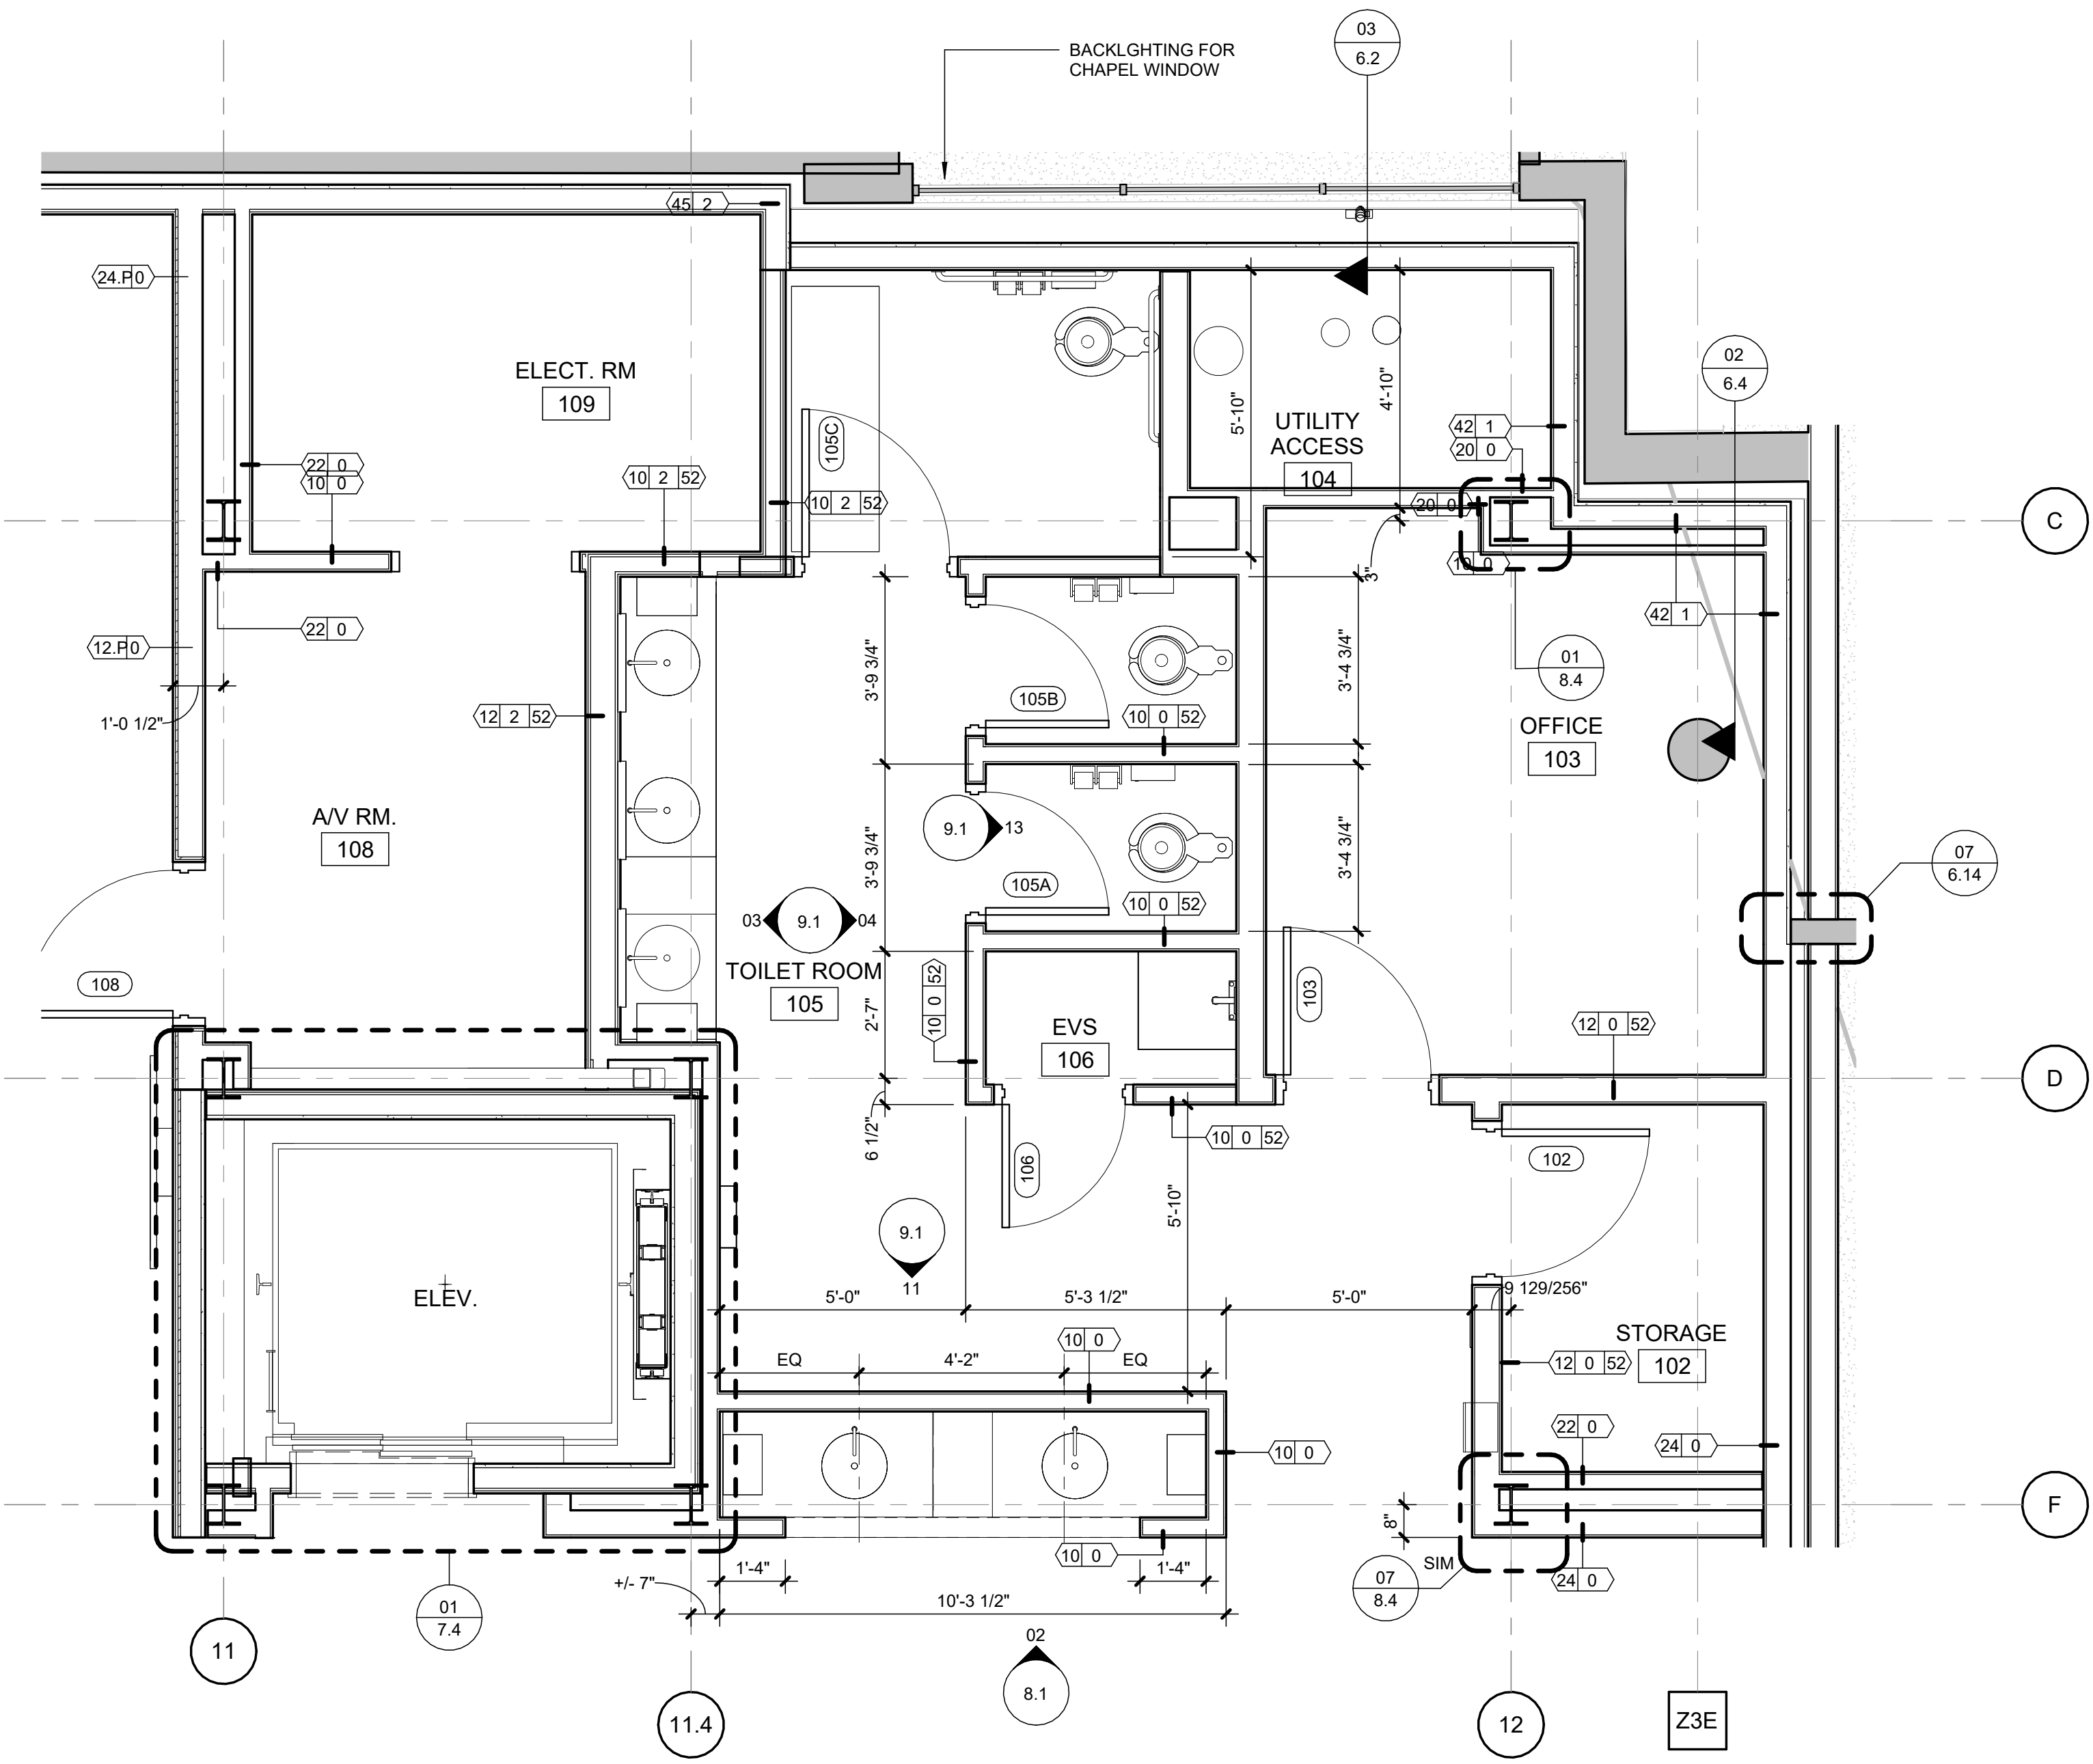
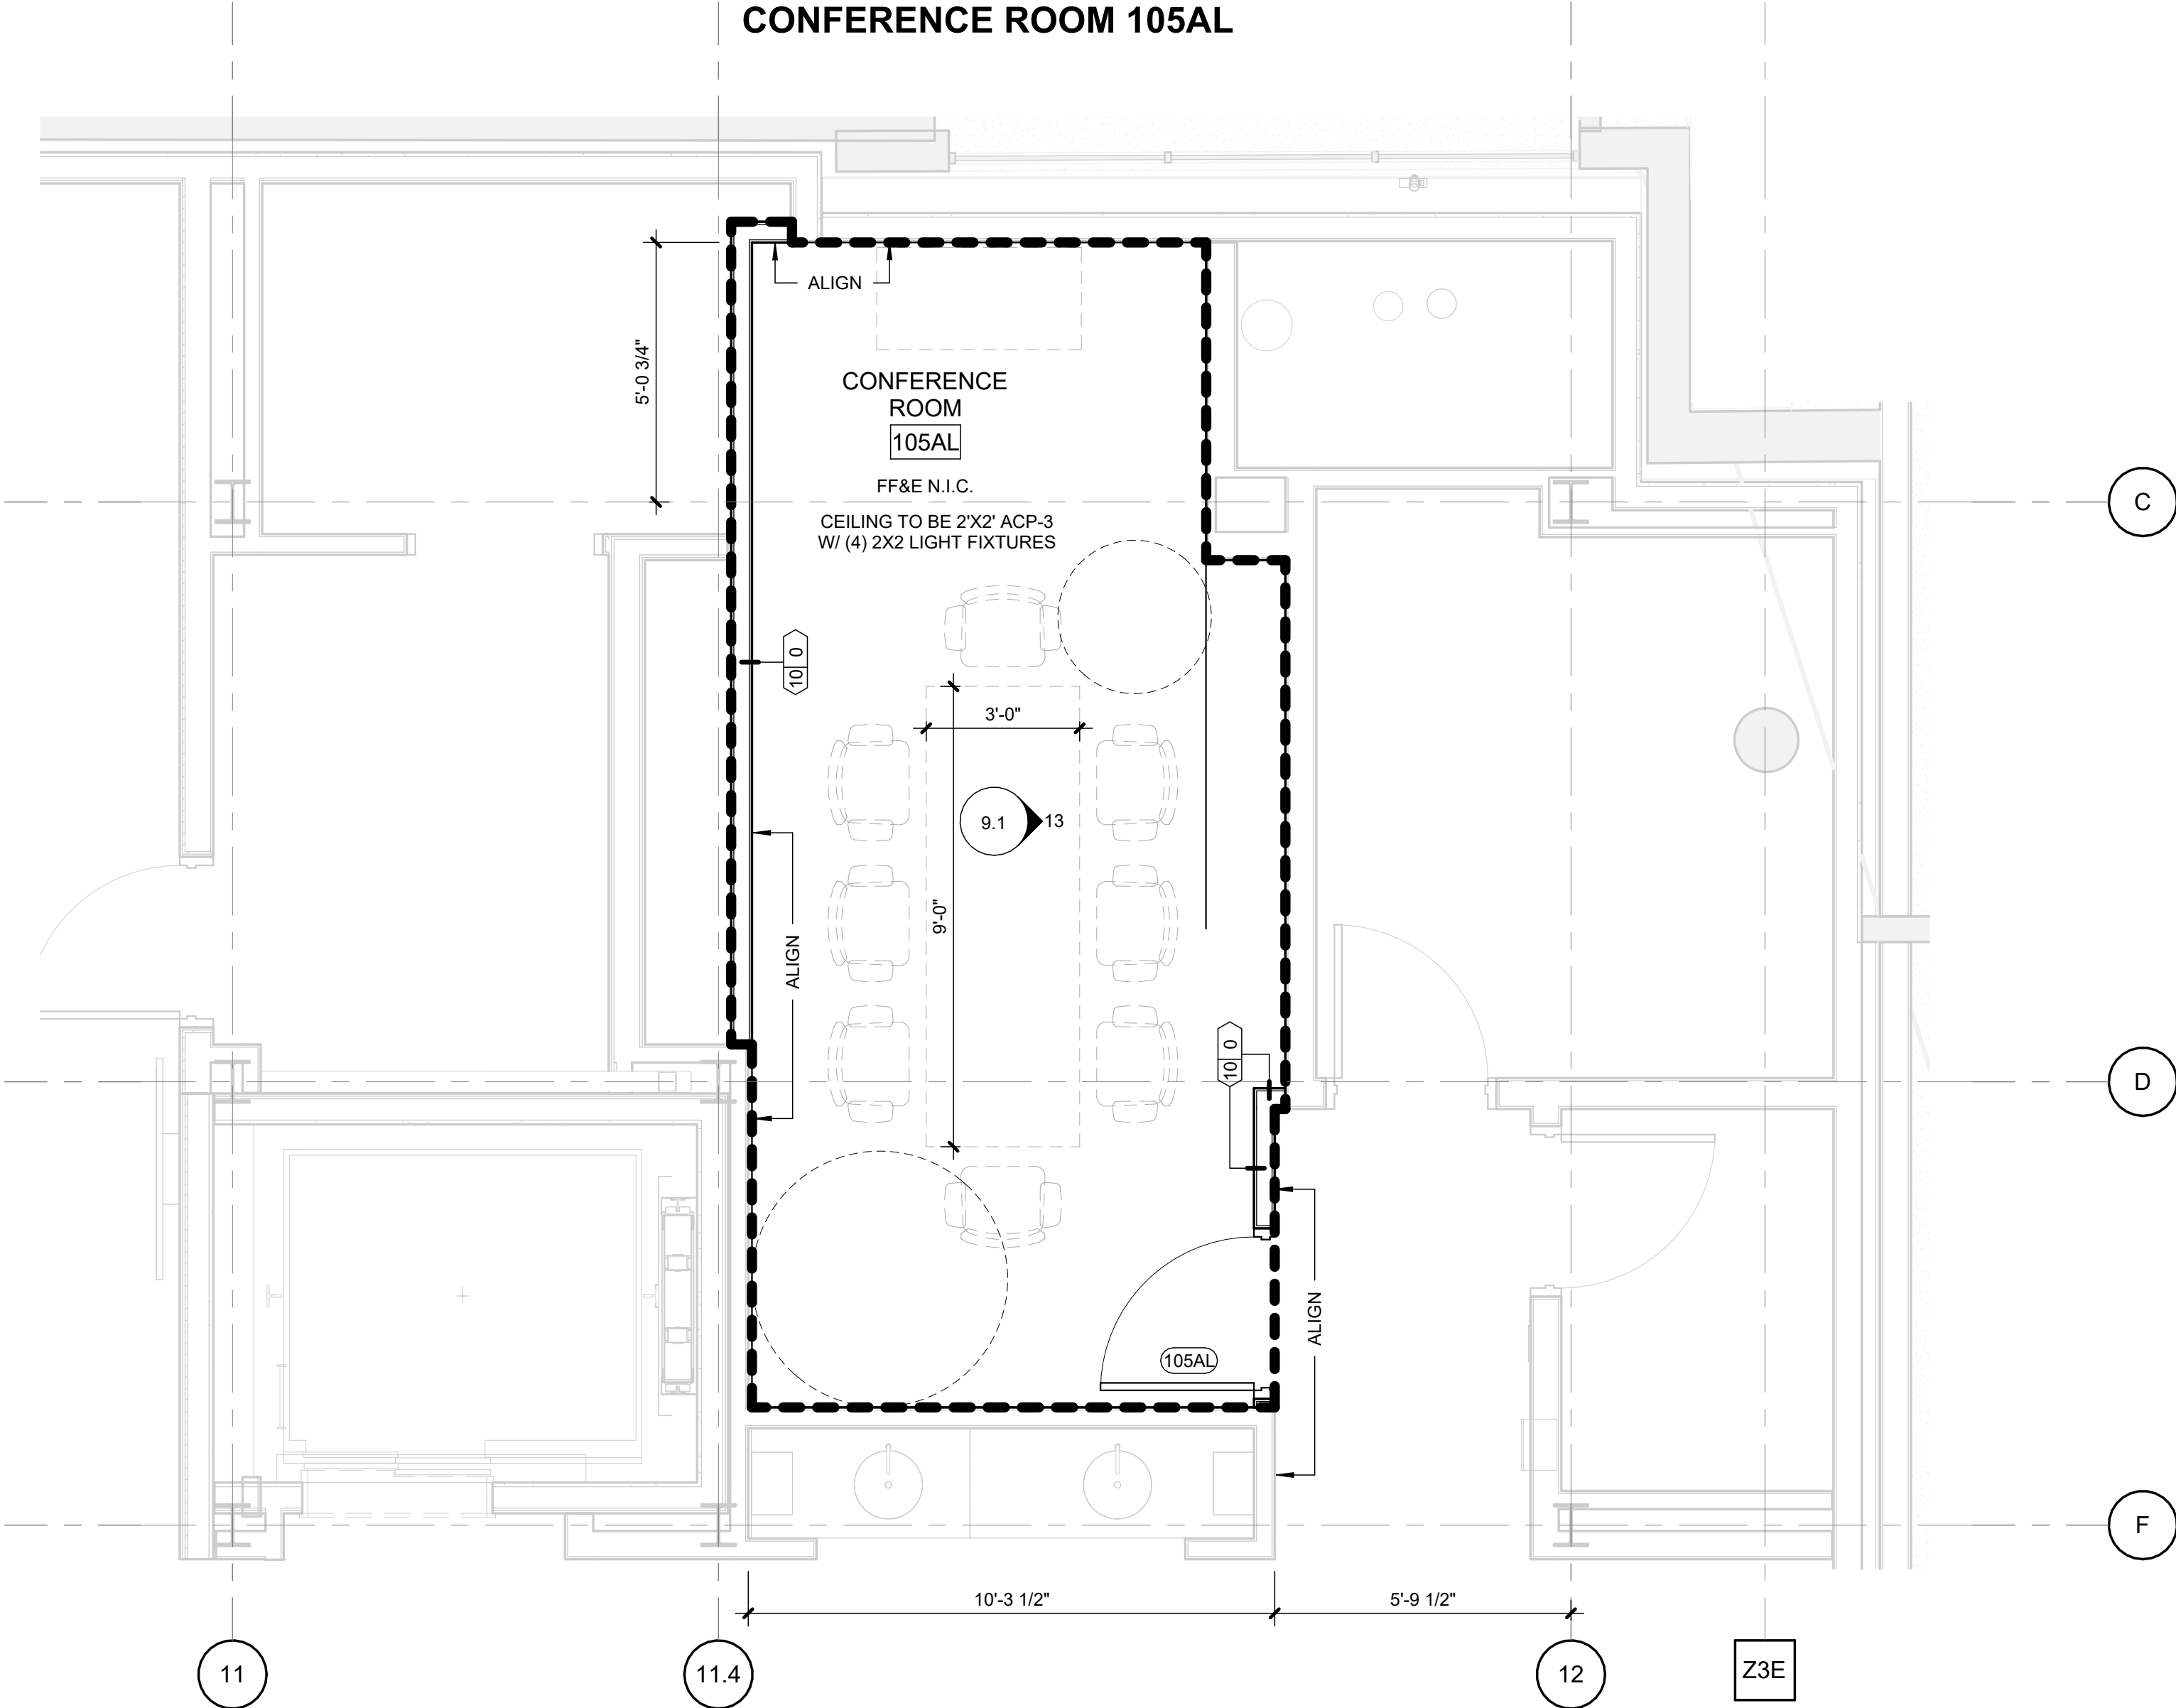
REVISIONS
20 DEC 2024 ADDENDUM 002
06 JAN 2025 ADDENDUM 005

FIRST FLOOR PLAN



1/16/2025 10:53:19 AM
Autodesk Docs://22003_Walkers Imaginarium/22003_ARCH_R24.rvt

ALTERNATE: REMOVE TOILET
ROOM 105 AND EVS 106, ADD
CONFERENCE ROOM 105AL



WALKER'S IMAGINARIUM

200 HENRY CLAY AVENUE
NEW ORLEANS, LA 70118
EDR PROJECT NO. | 22003

PROJECT ISSUE DATE | 02 DECEMBER 2024

Conformed Set

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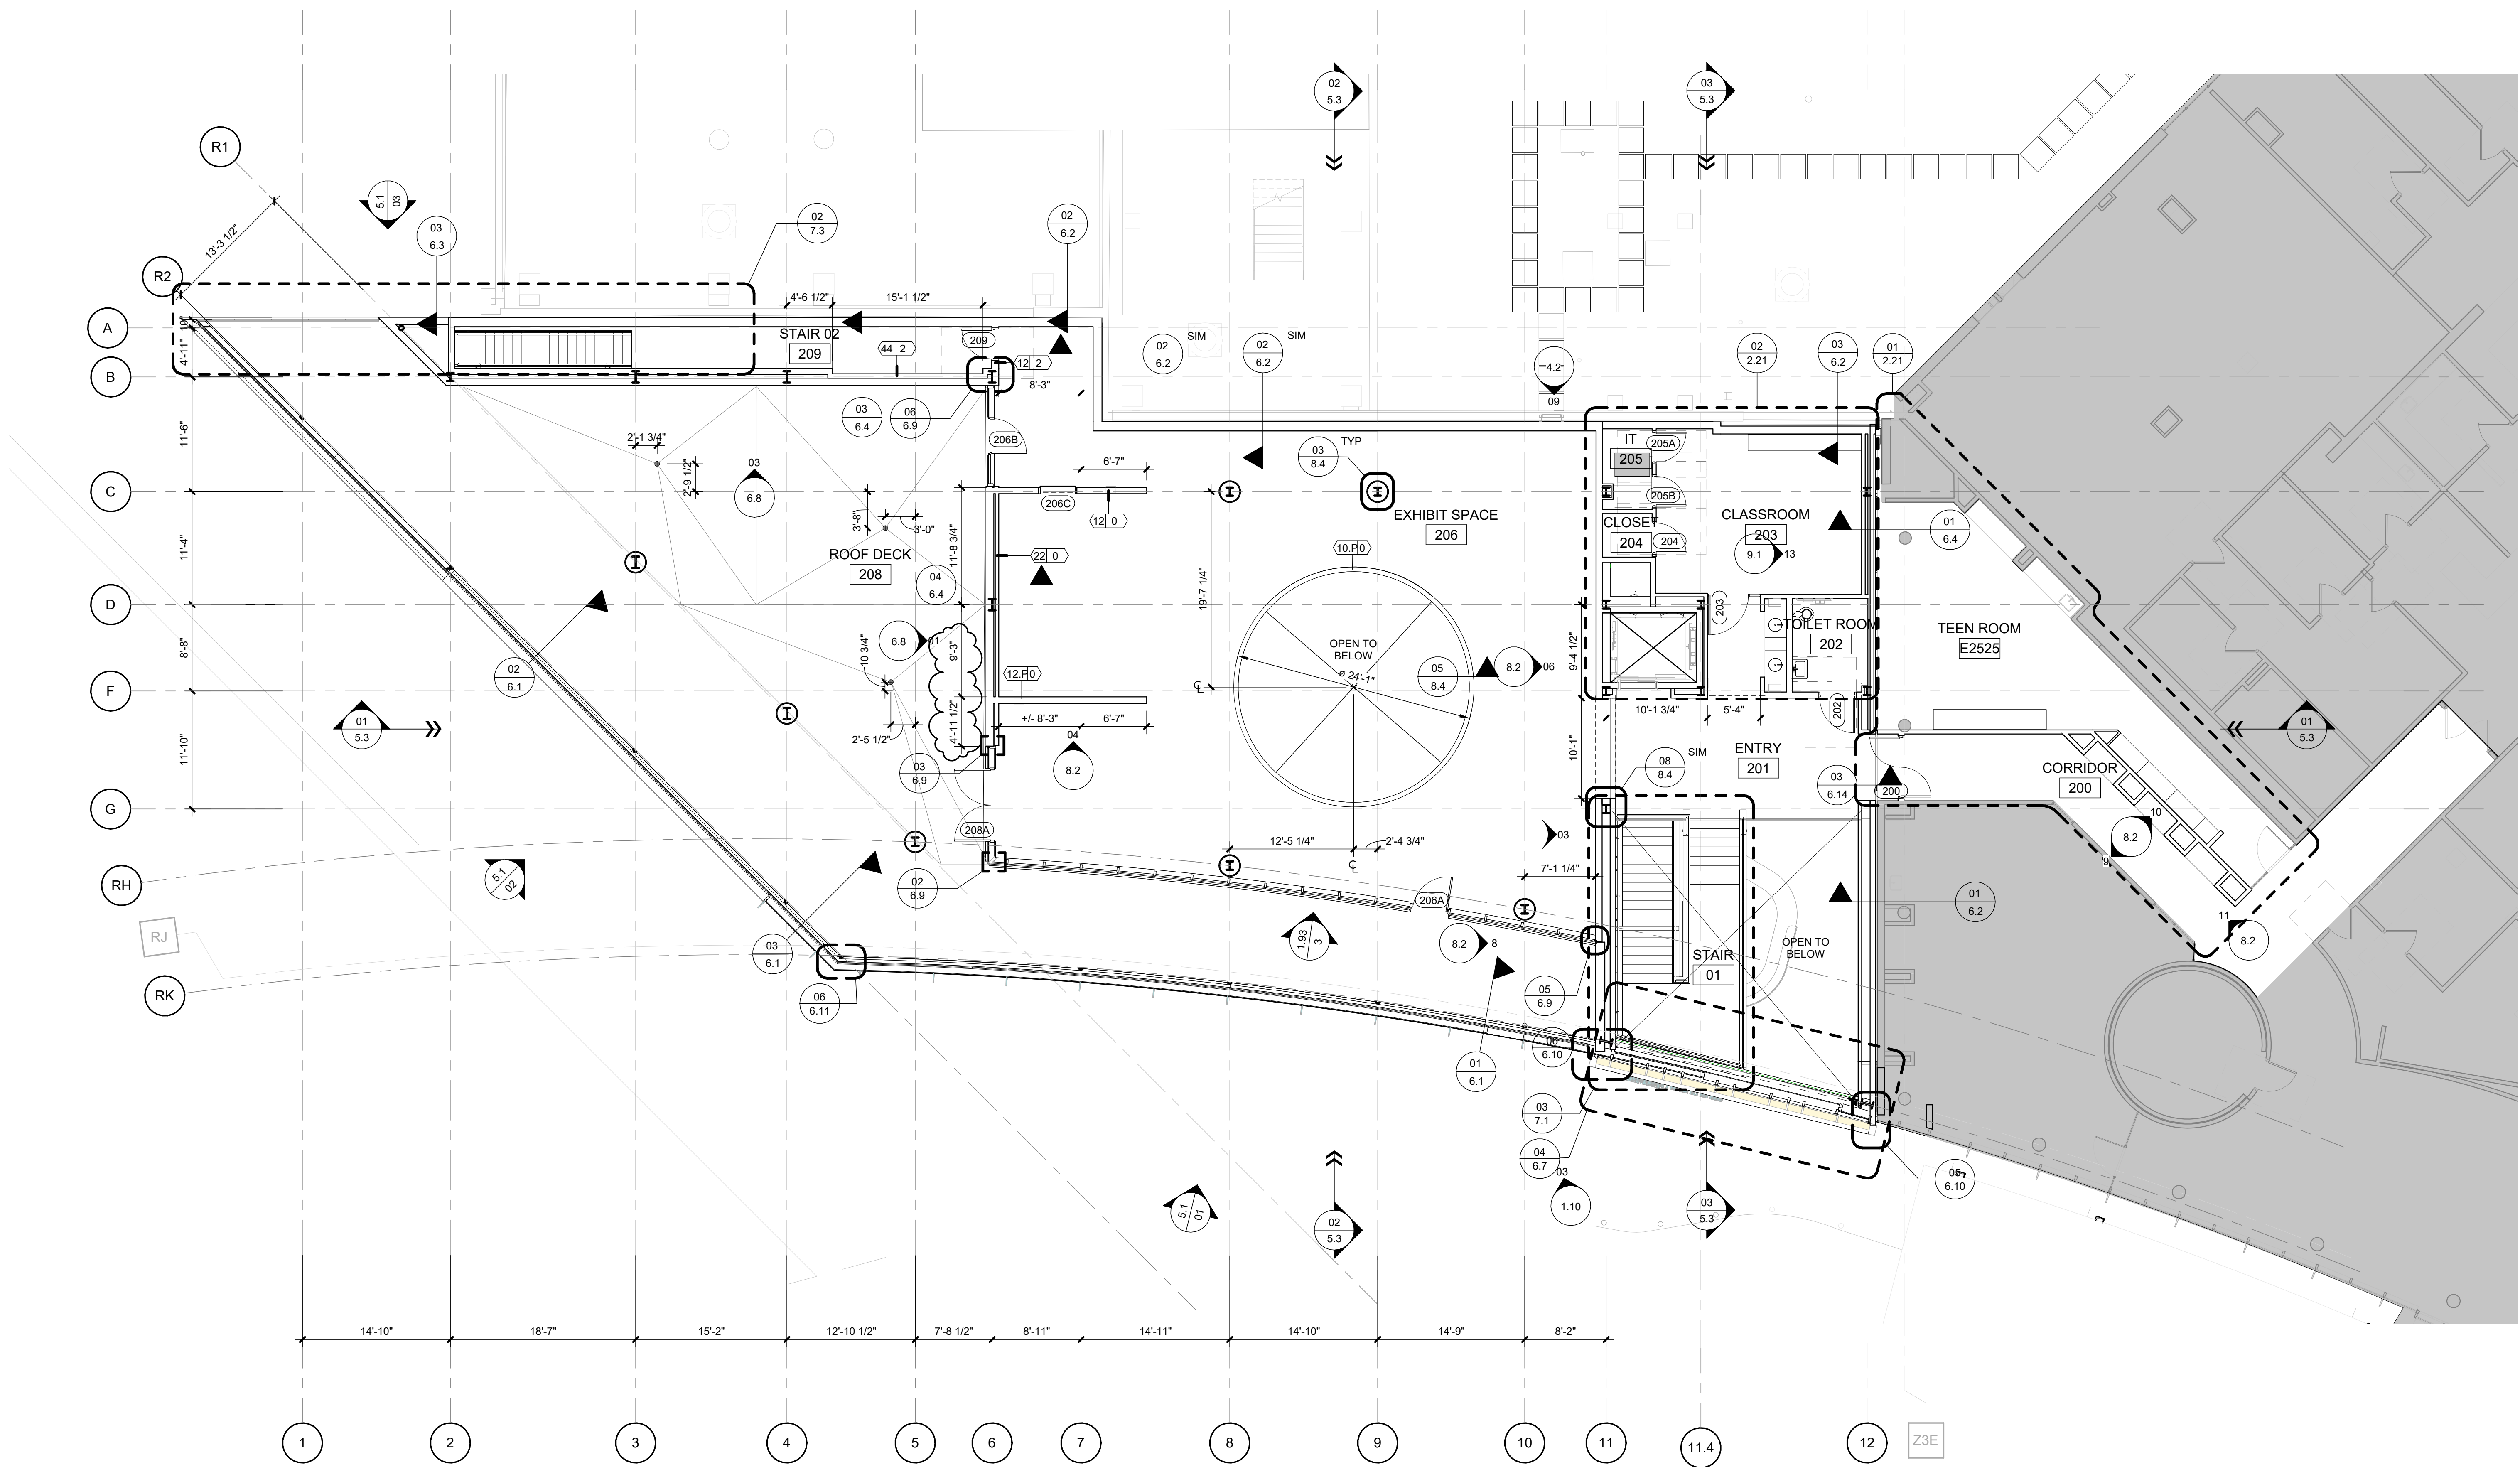
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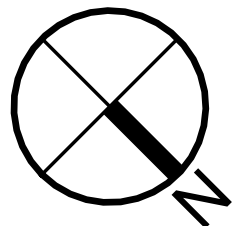
FIRST FLOOR ENLARGED PLANS

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01 SECOND FLOOR PLAN
1.21 | 1/8" = 1'-0" |



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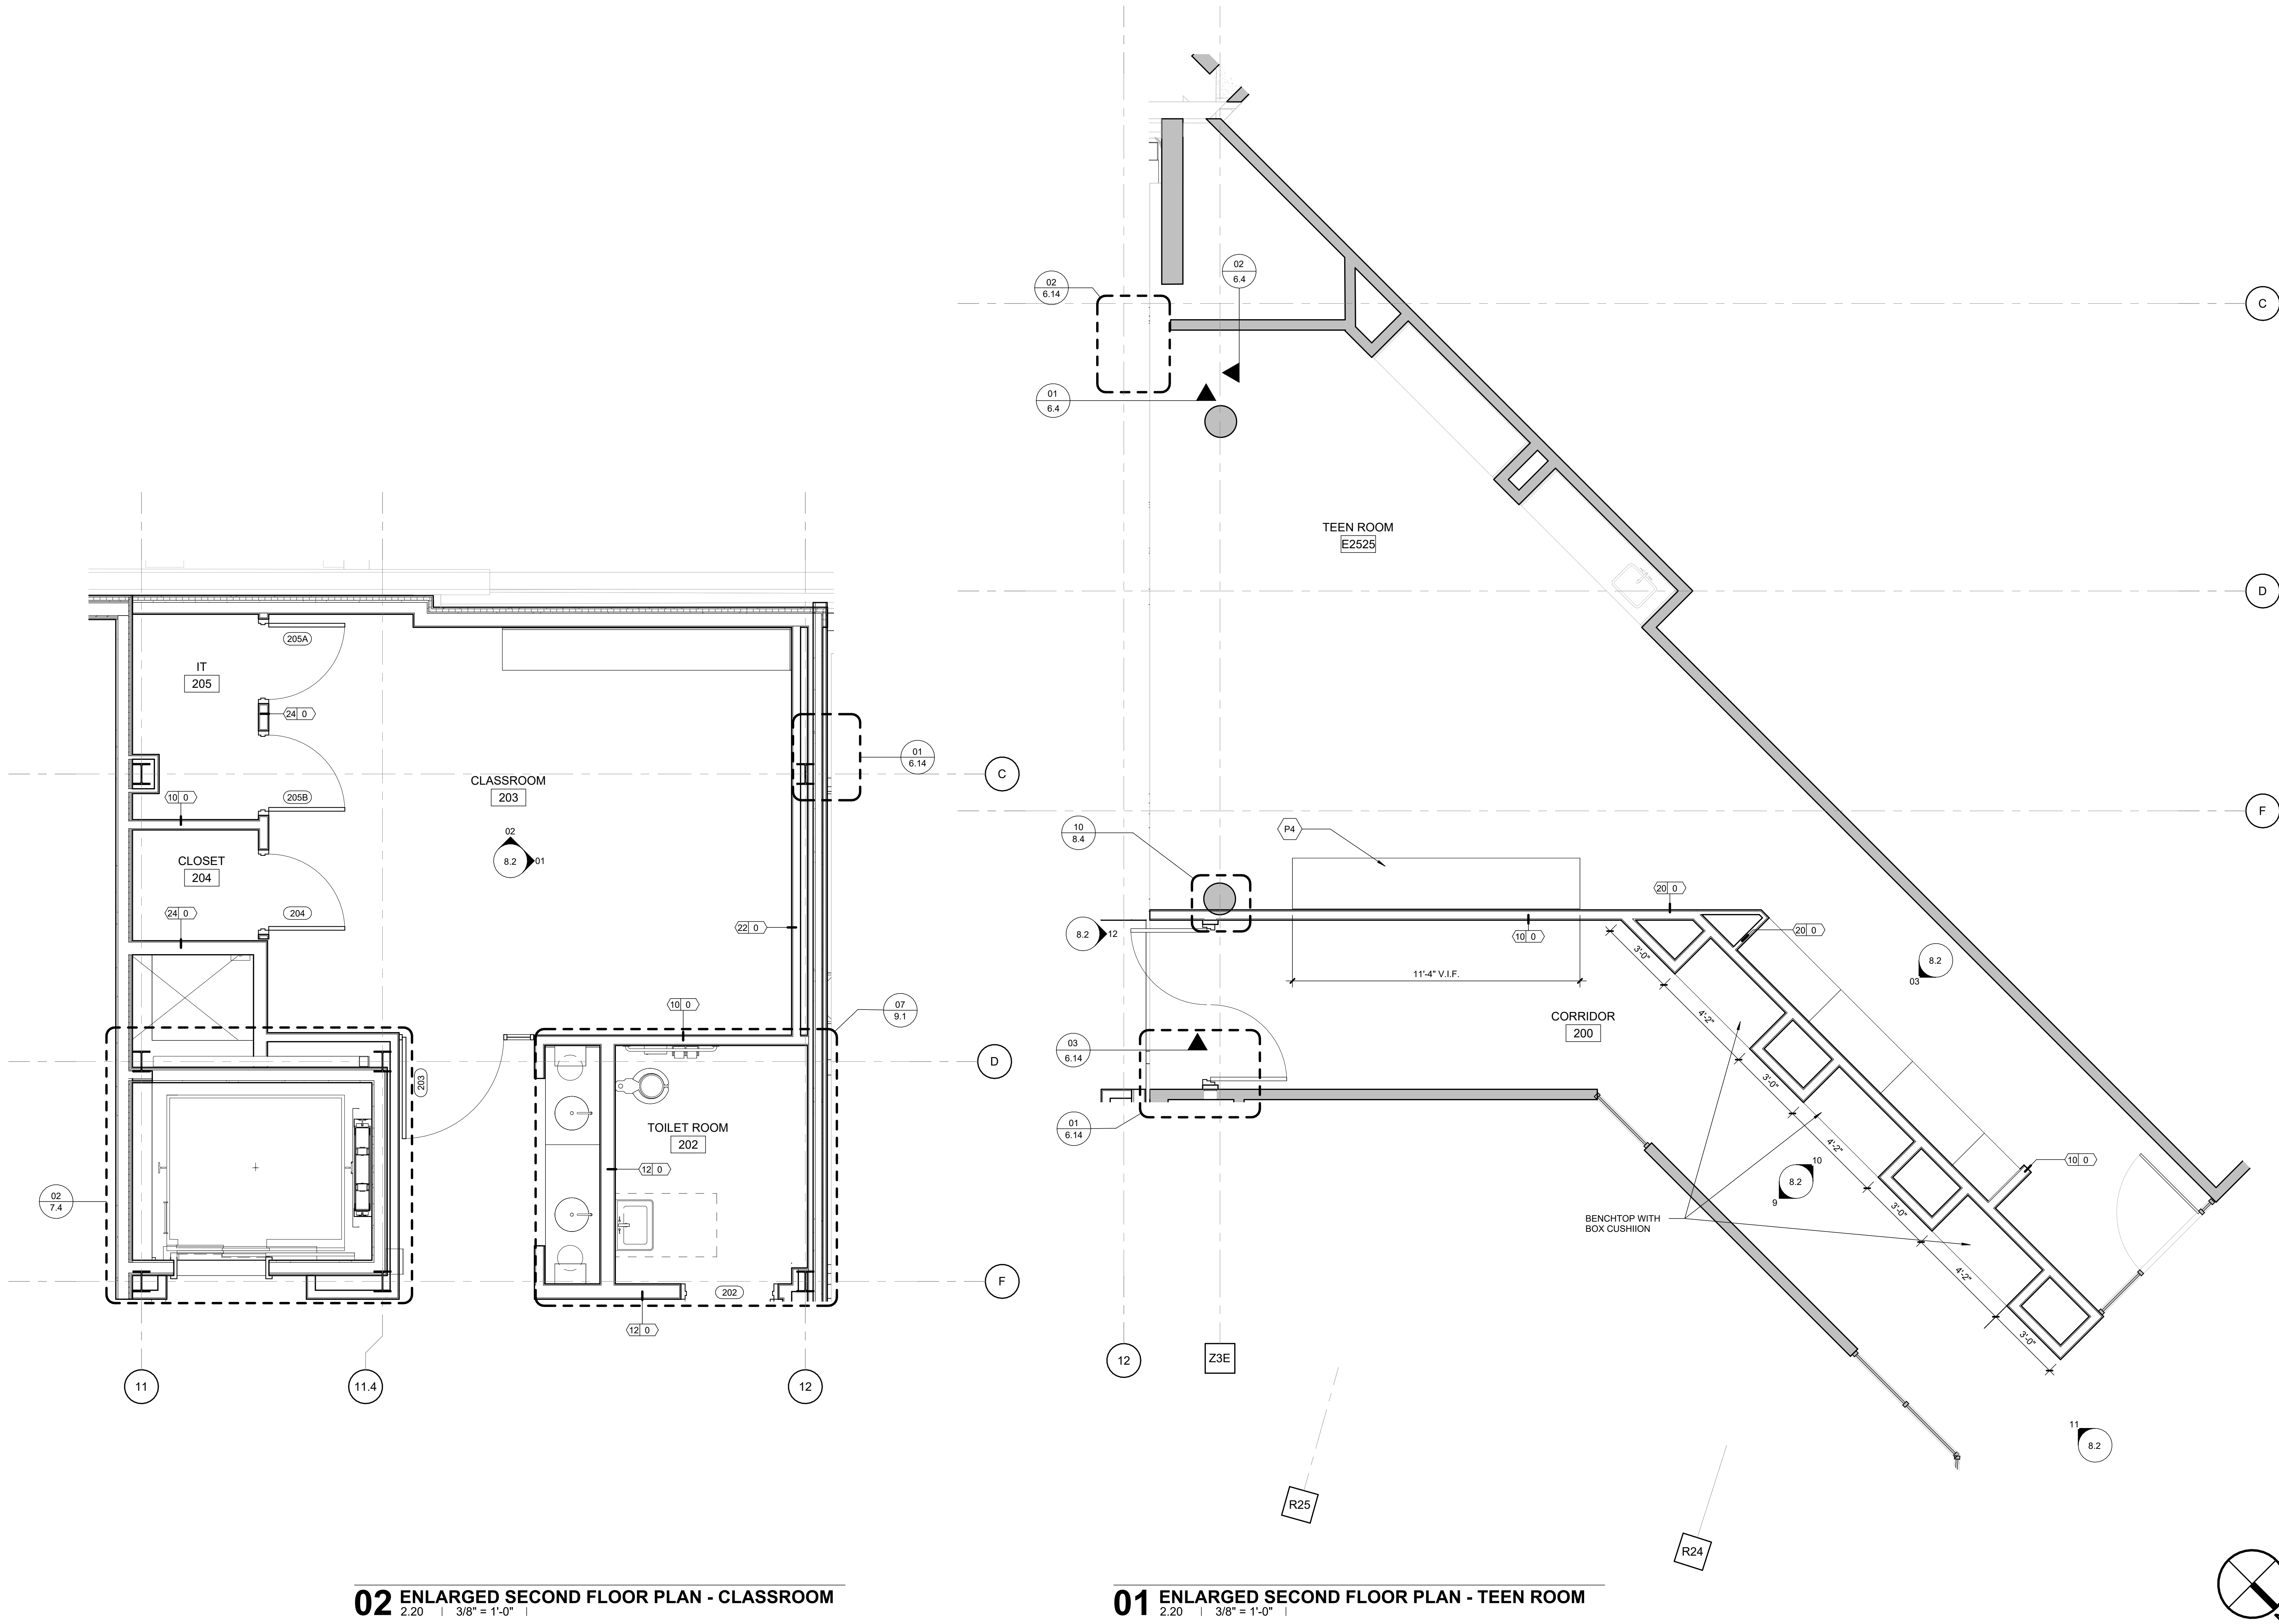
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SECOND FLOOR PLAN

1/16/2025 10:53:23 AM

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SECOND FLOOR ENLARGED PLANS

1. THESE DETAILS ARE SHOWN MAINLY TO CLARIFY THE CONSTRUCTION DETAILS OF PENETRATIONS THROUGH THE ROOFING SYSTEM. FOR THE COMPONENTS AND THICKNESSES OF THE ROOF DECK SYSTEM, REFER TO THE ROOF PLAN, FRAMING PLANS, WALL SECTIONS AND RELATED MISCELLANEOUS DETAILS AND SPECIFICATION.

2. ALL REFERENCES TO NRCA DETAILS ARE FROM THE LATEST EDITION.

R1	ROOF SCUPPER
R2	ROOF DRAIN
R4	ROOF GUTTER
R5	ROOF DOWNSPOUT
R6	TPO ROOF ASSEMBLY; SEE 02/4.1
R7	COORDINATE WITH MEP FOR RISER FOR WALKING PADS OVER PIPING

200 HENRY CLAY AVENUE
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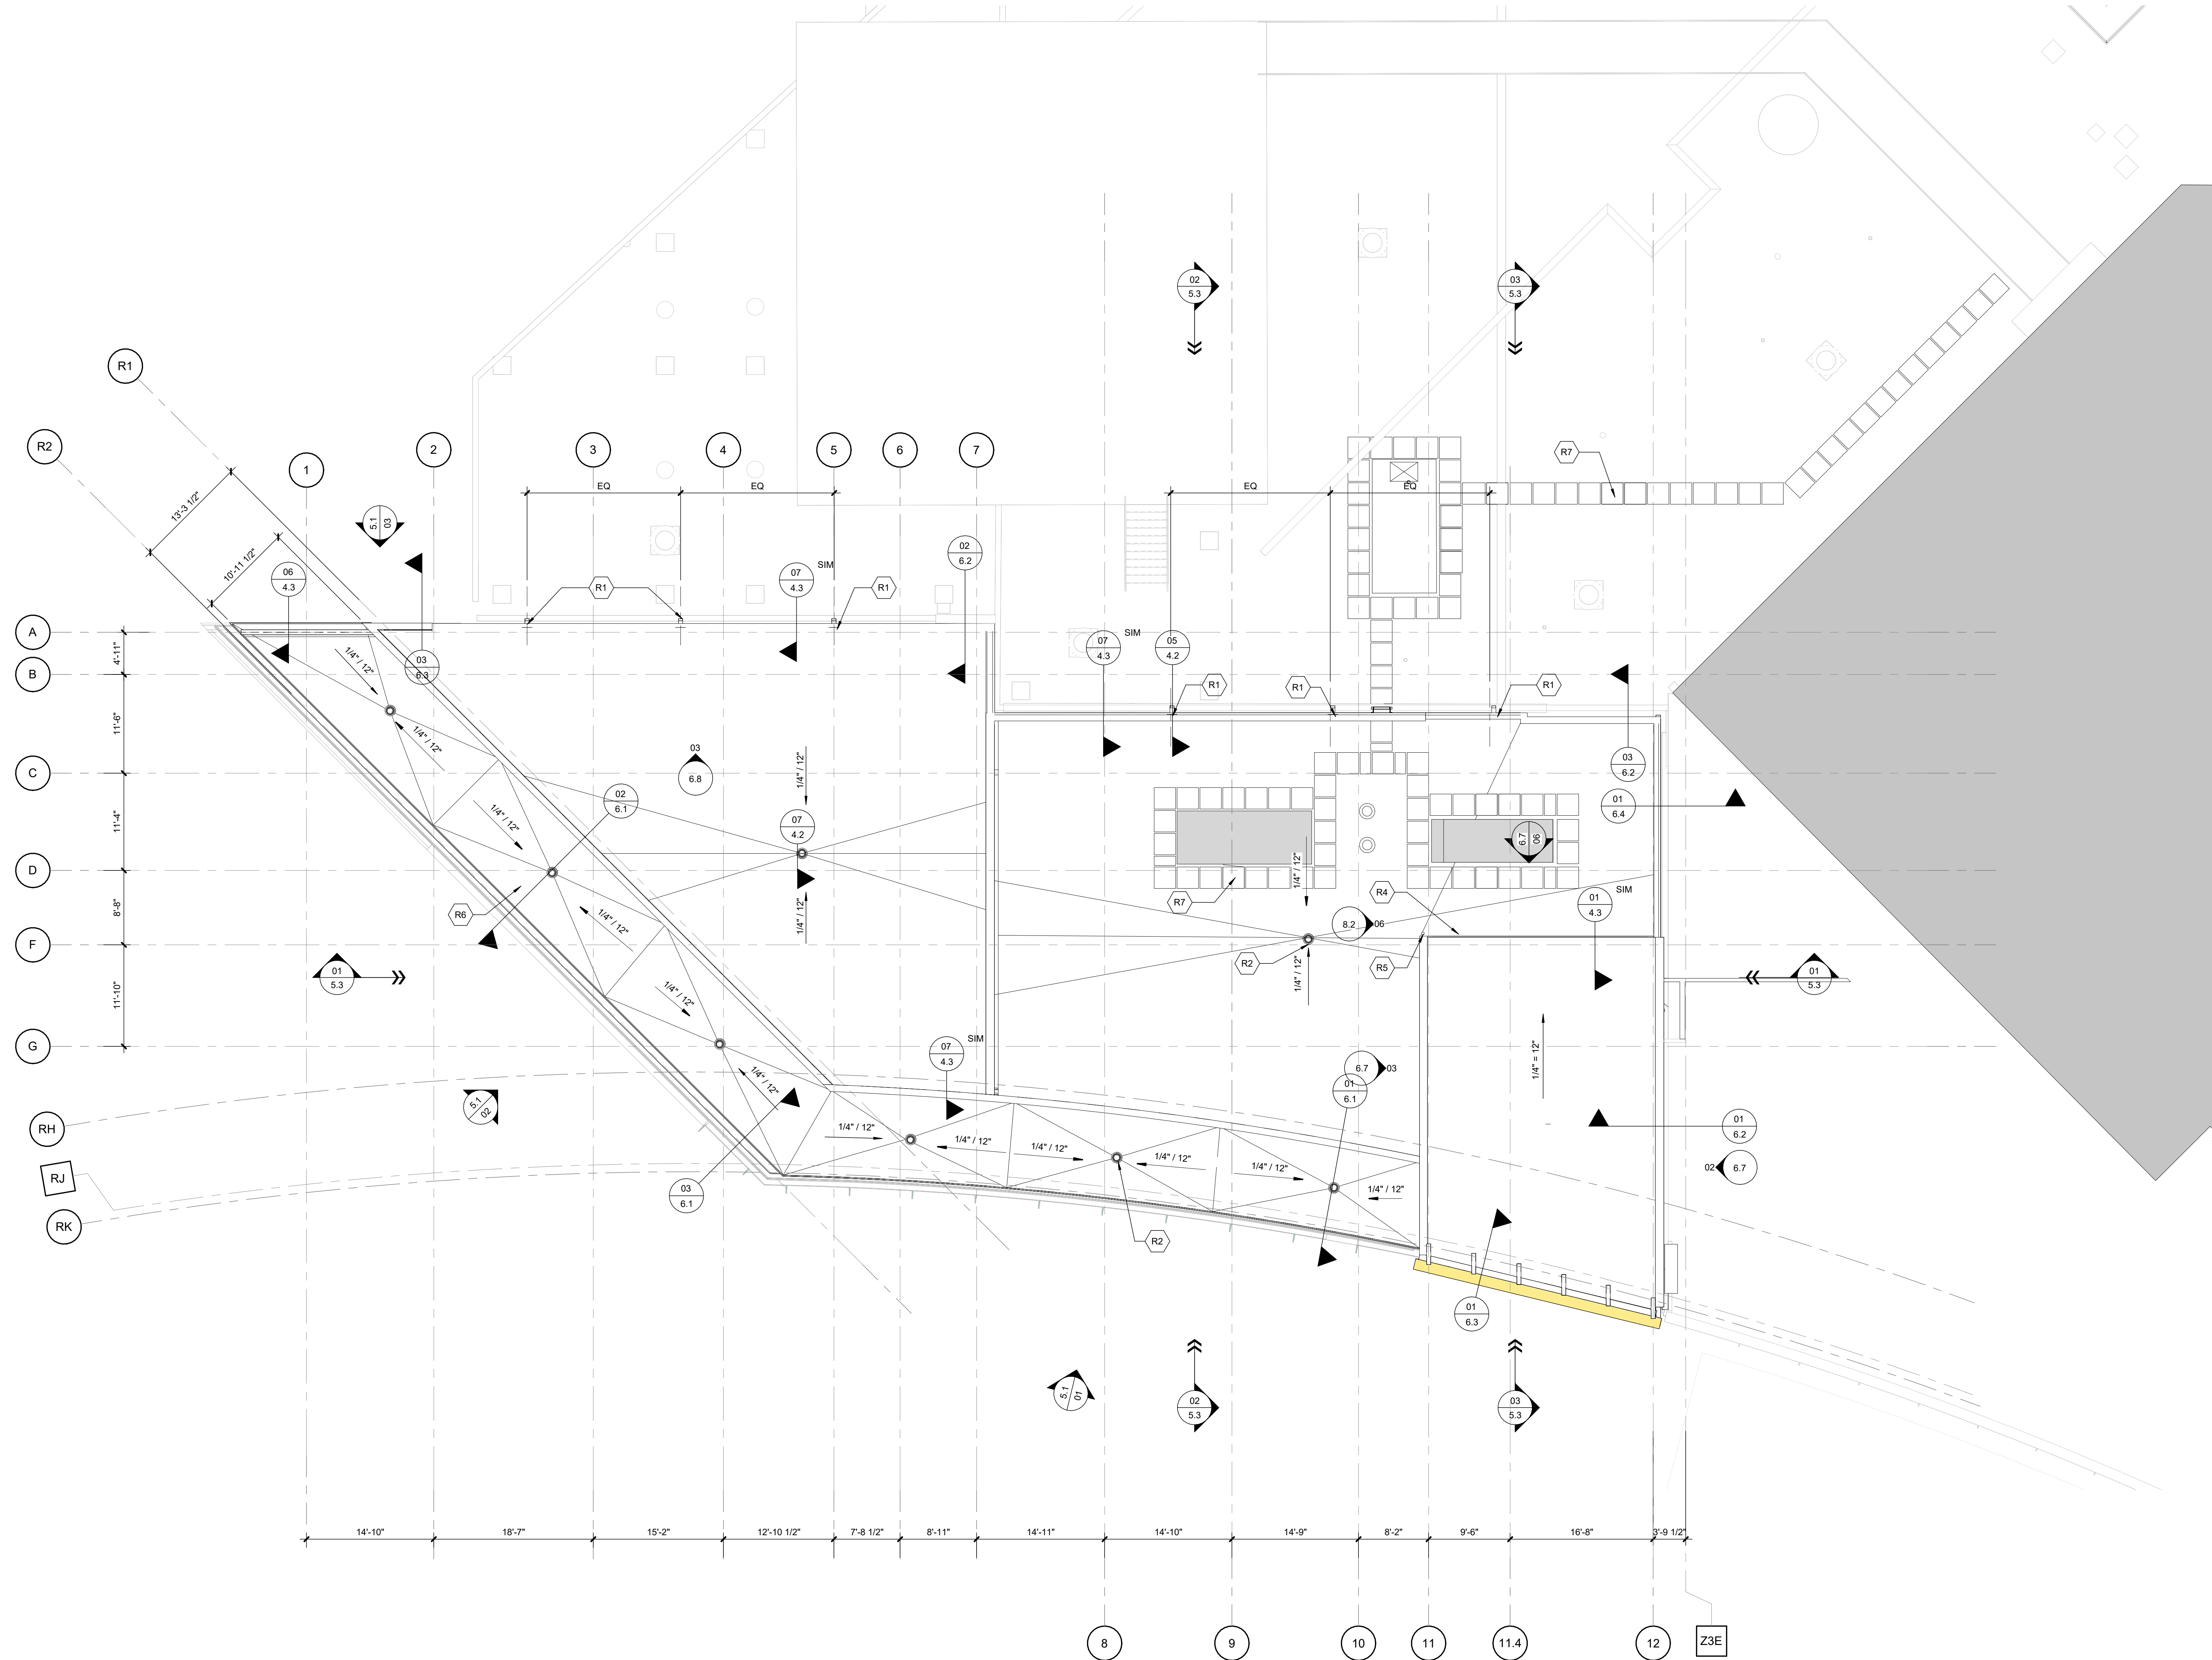
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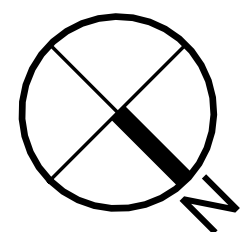
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ROOF PLAN



01 ROOF PLAN




03 NORTH ELEVATION.

02 SOUTH ELEVATION


01 NORTHWEST ELEVATION1

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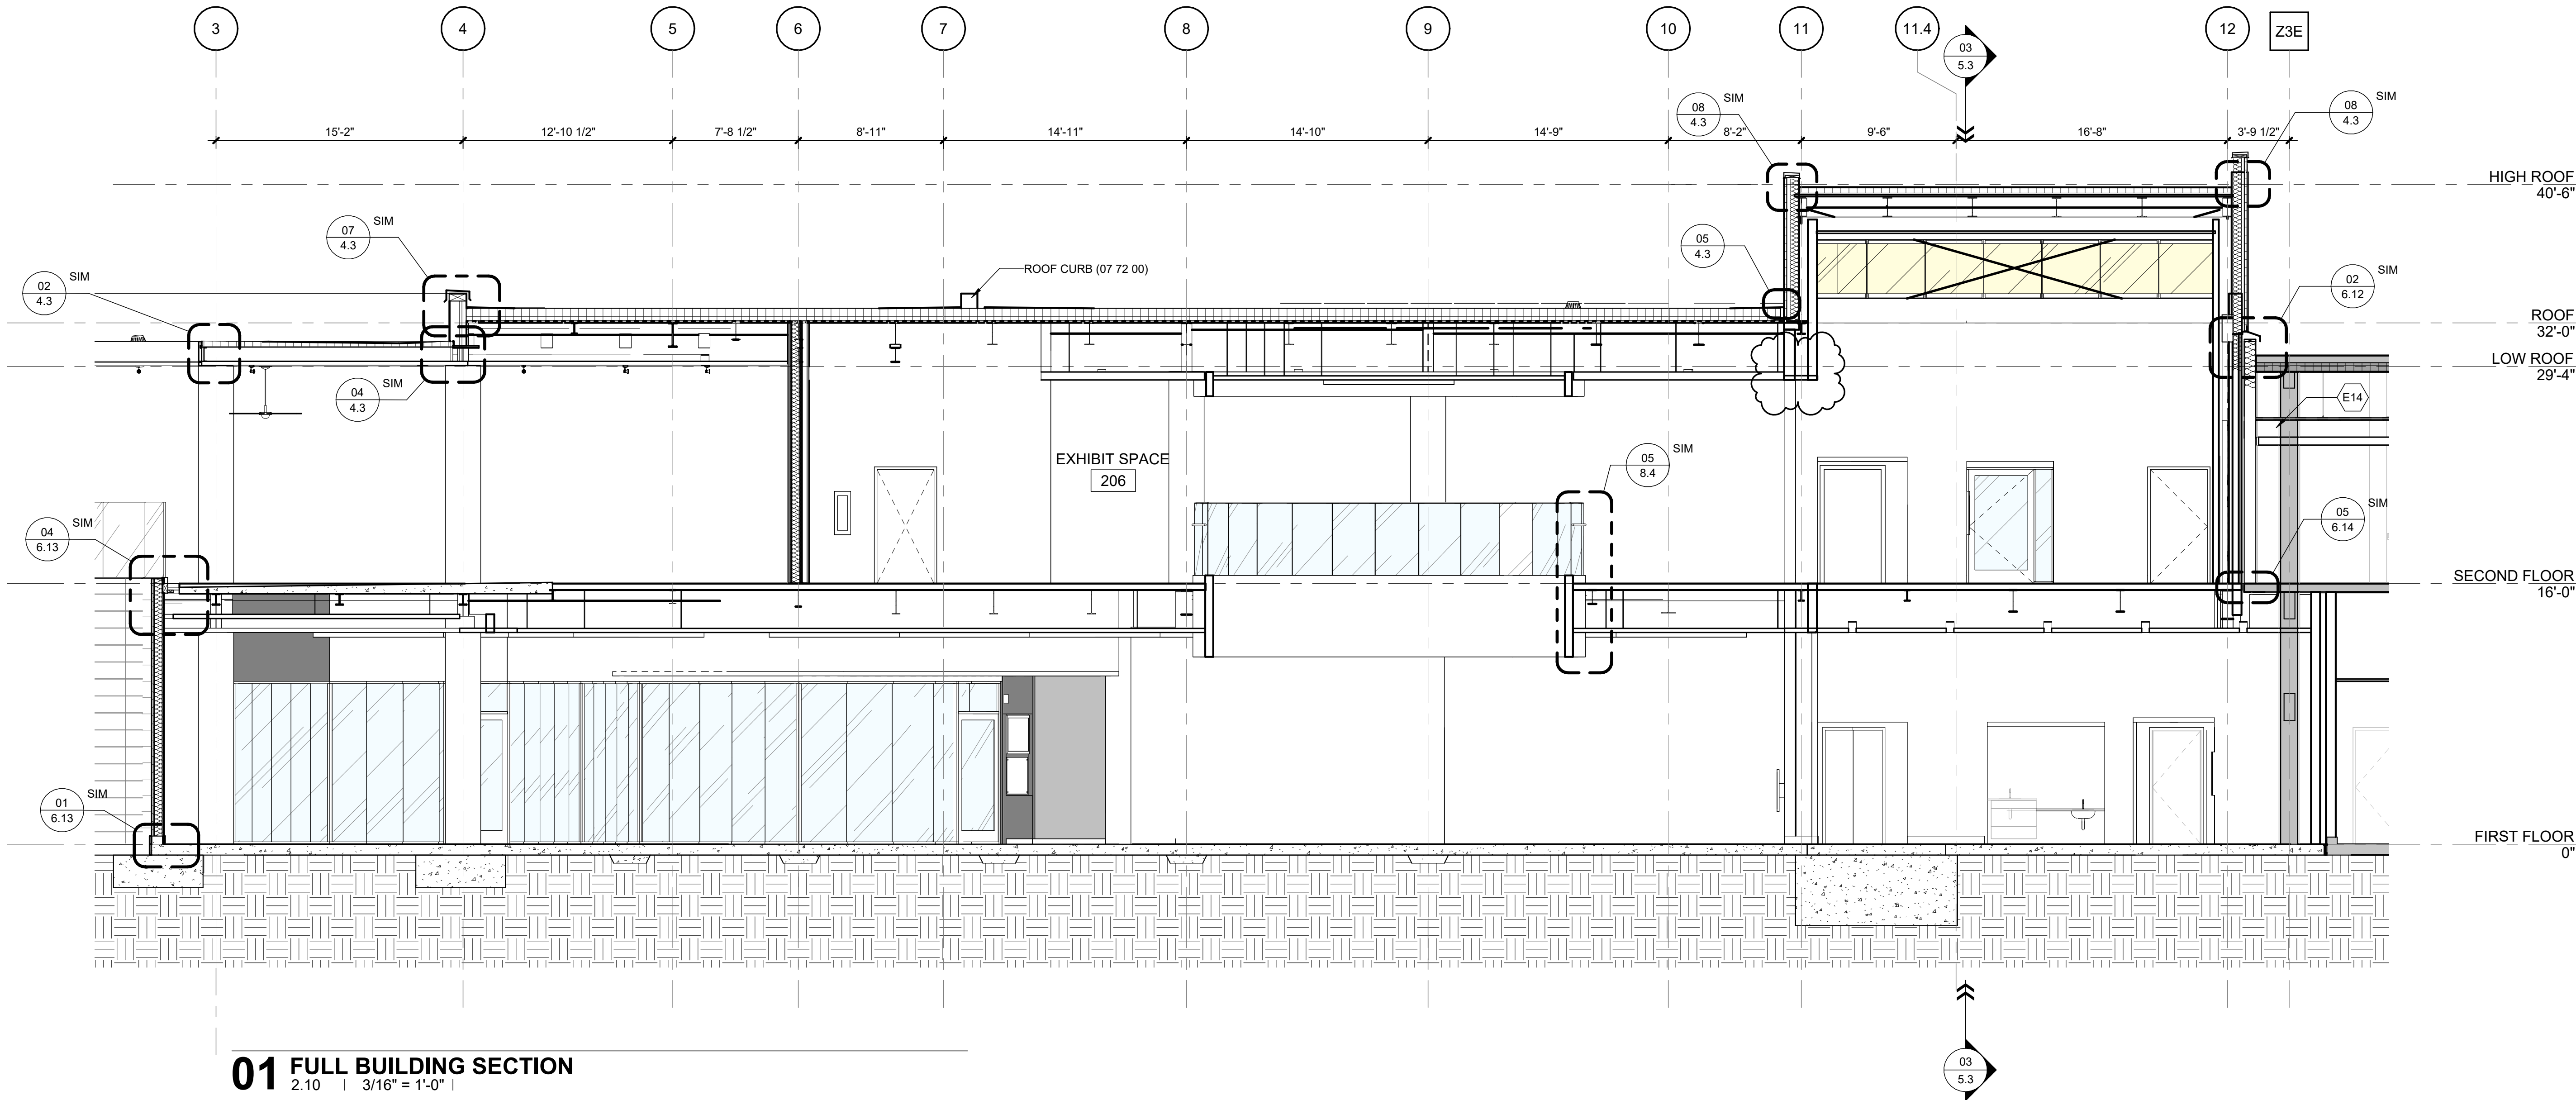
Autodesk Docs://22003_Walkers Imaginarium/22003_ARCH_R24.rvt

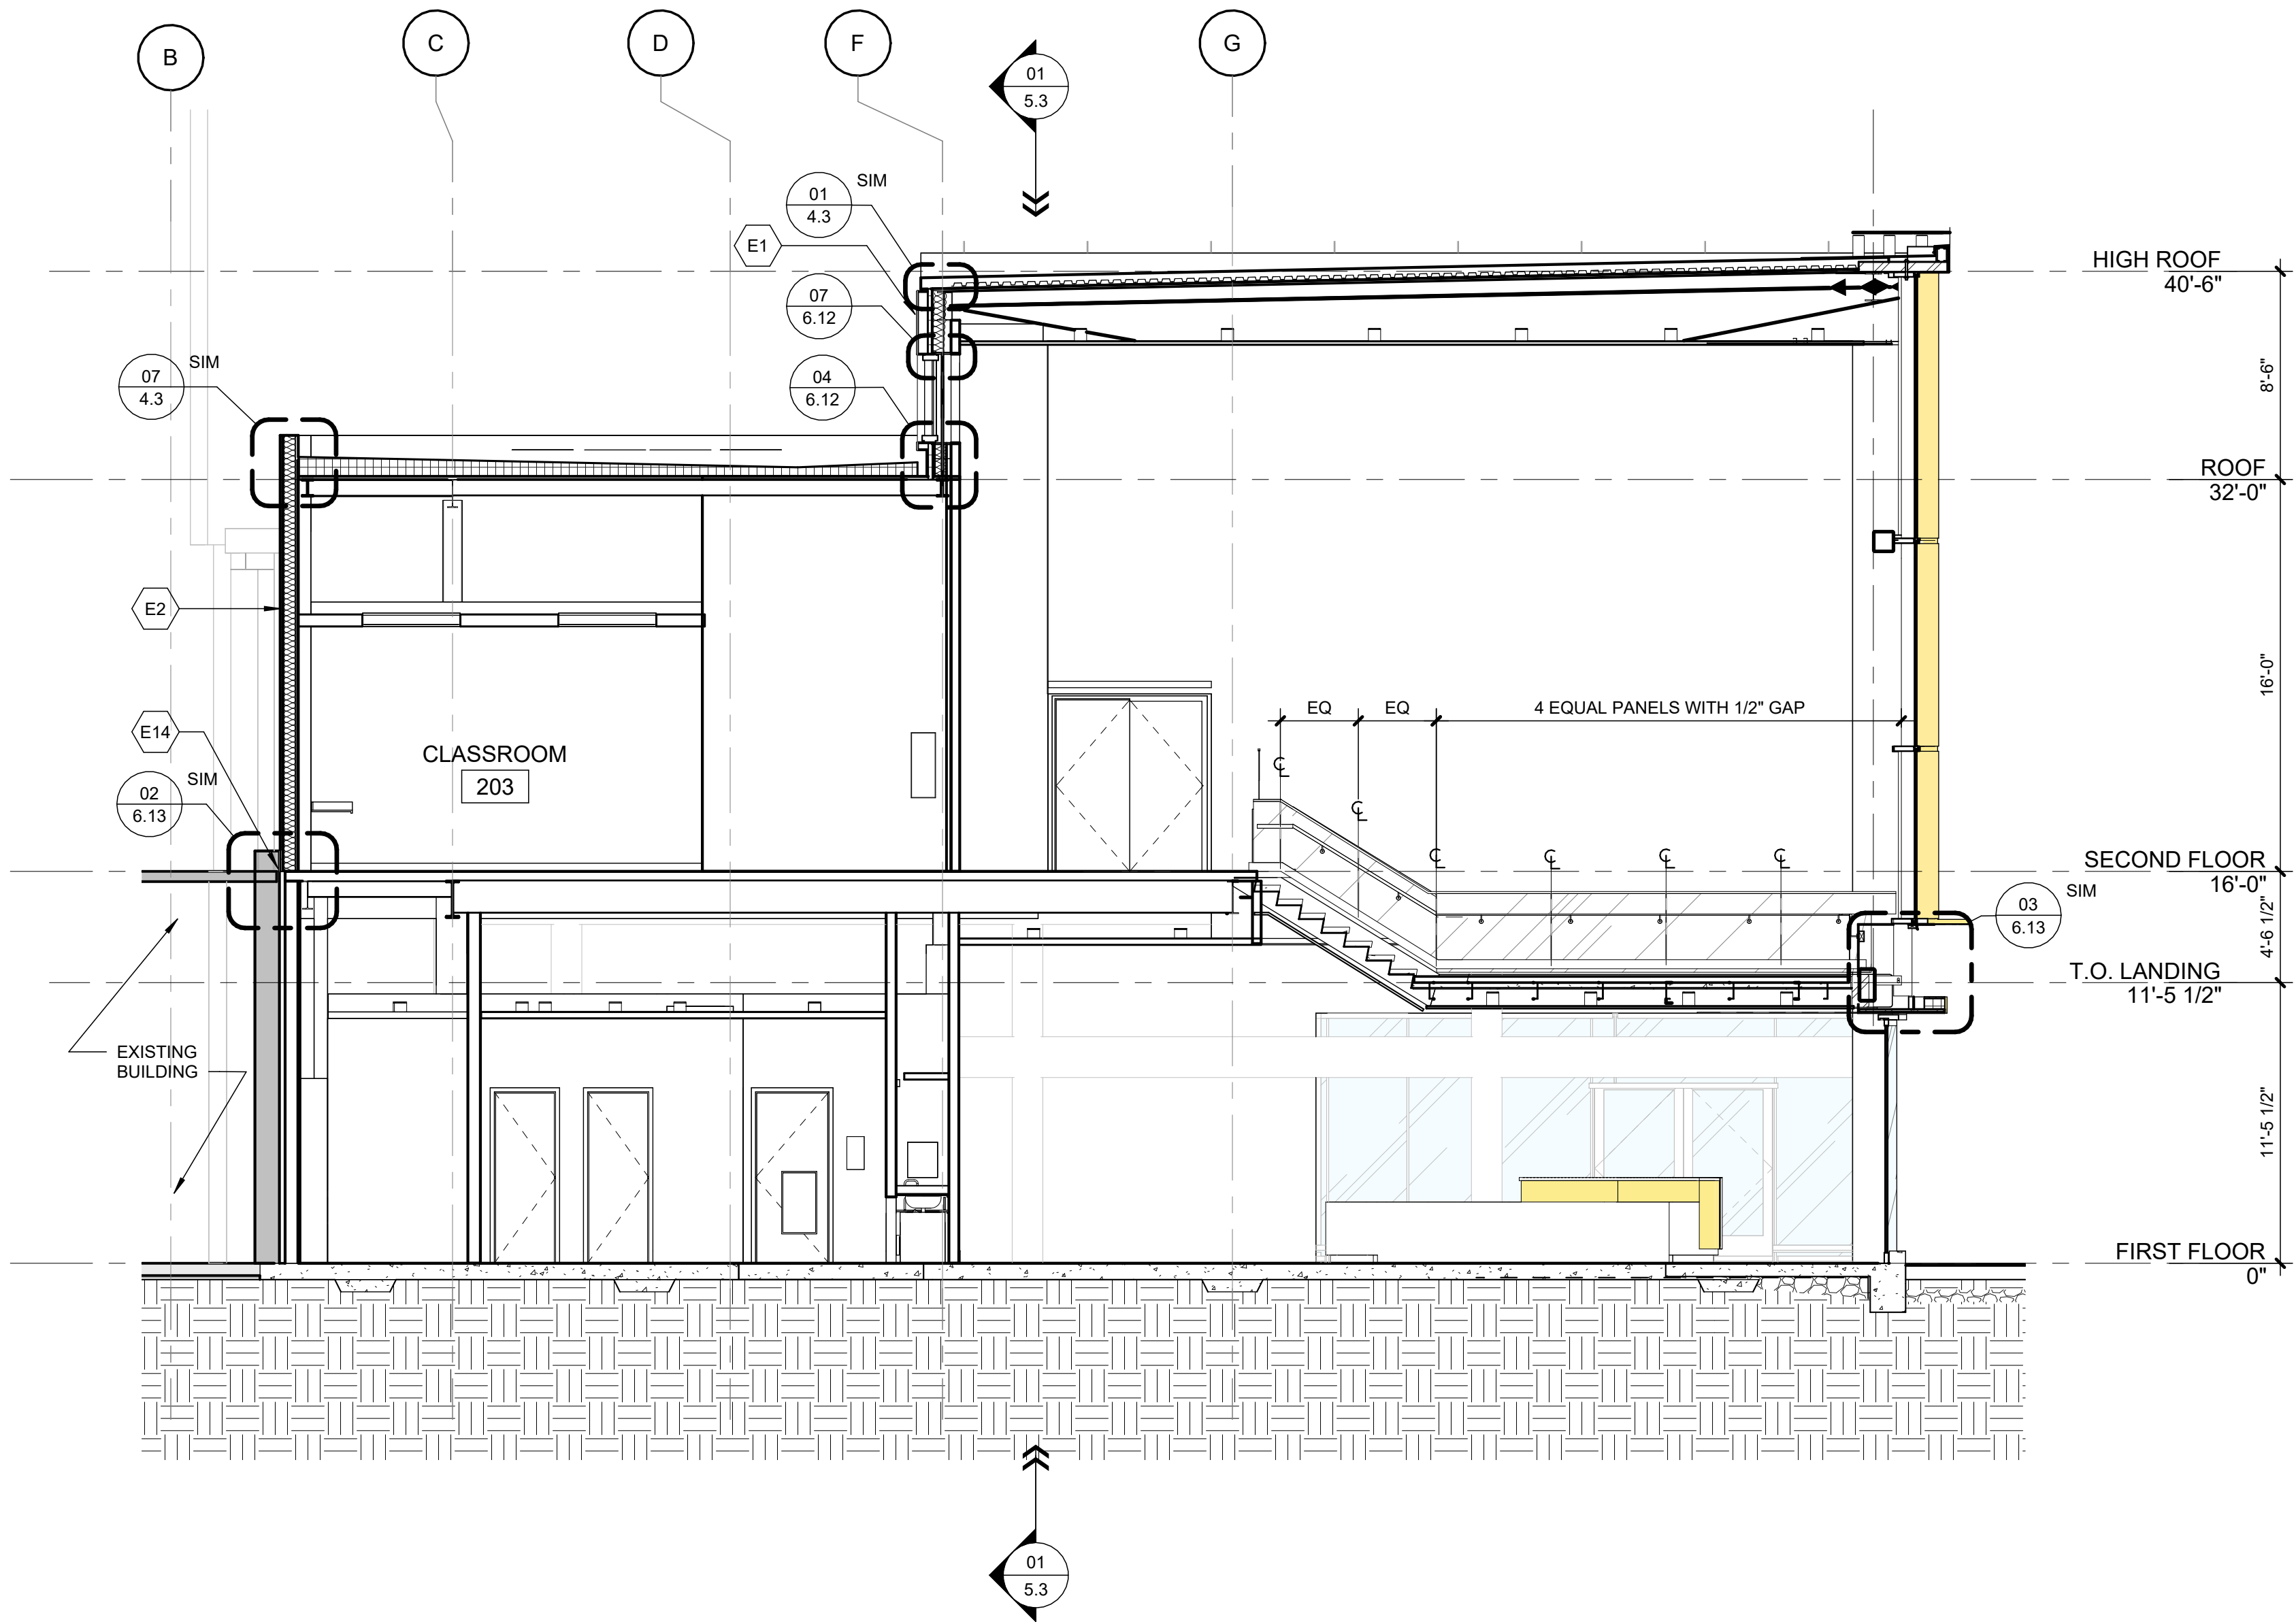

03 TRANSVERSE SECTION - ENTRY
2.10 | 3/16" = 1'-0" |

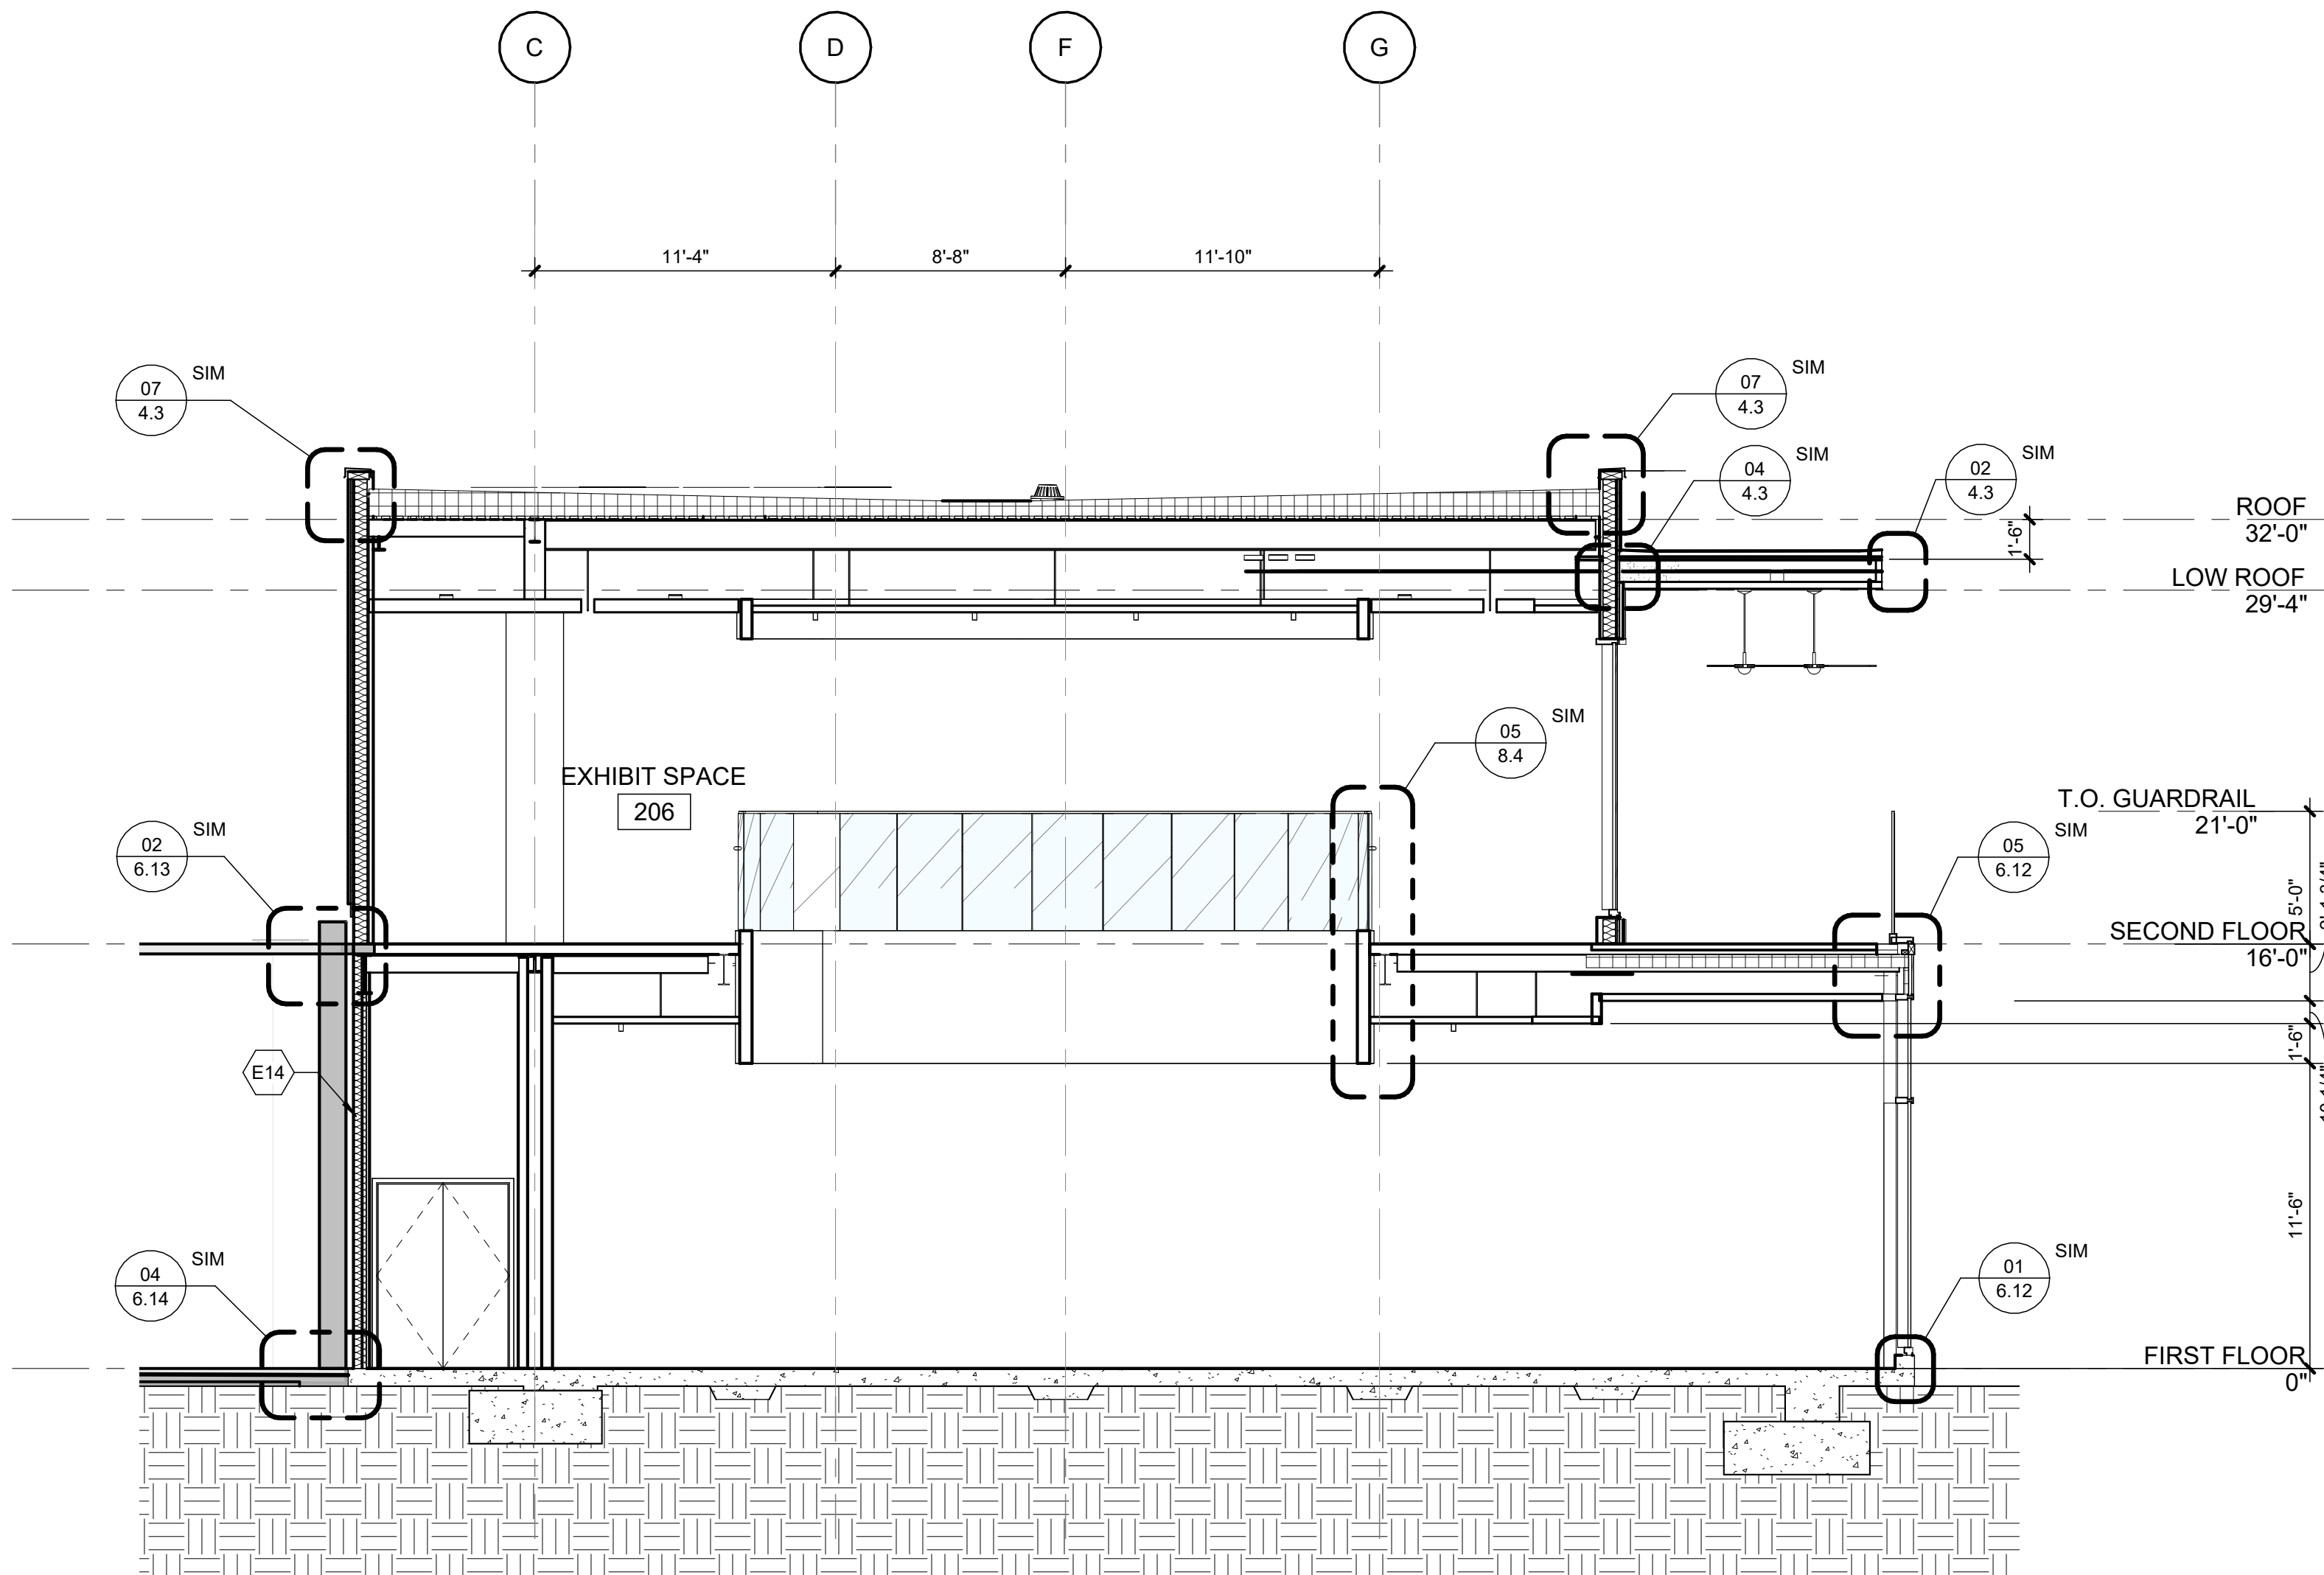

02 TRANSVERSE SECTION - EXHIBIT
2.10 | 3/16" = 1'-0" |



01 FULL BUILDING SECTION
2.10 | 3/16" = 1'-0" |

CLARIFICATION OF REFERENCE DESIGNATIONS	
E1	METAL PANEL WALL SEE 02/3.2
E2	EXTERIOR PLASTER WALL SEE 02/3.2
E14	EXPANSION JOINT

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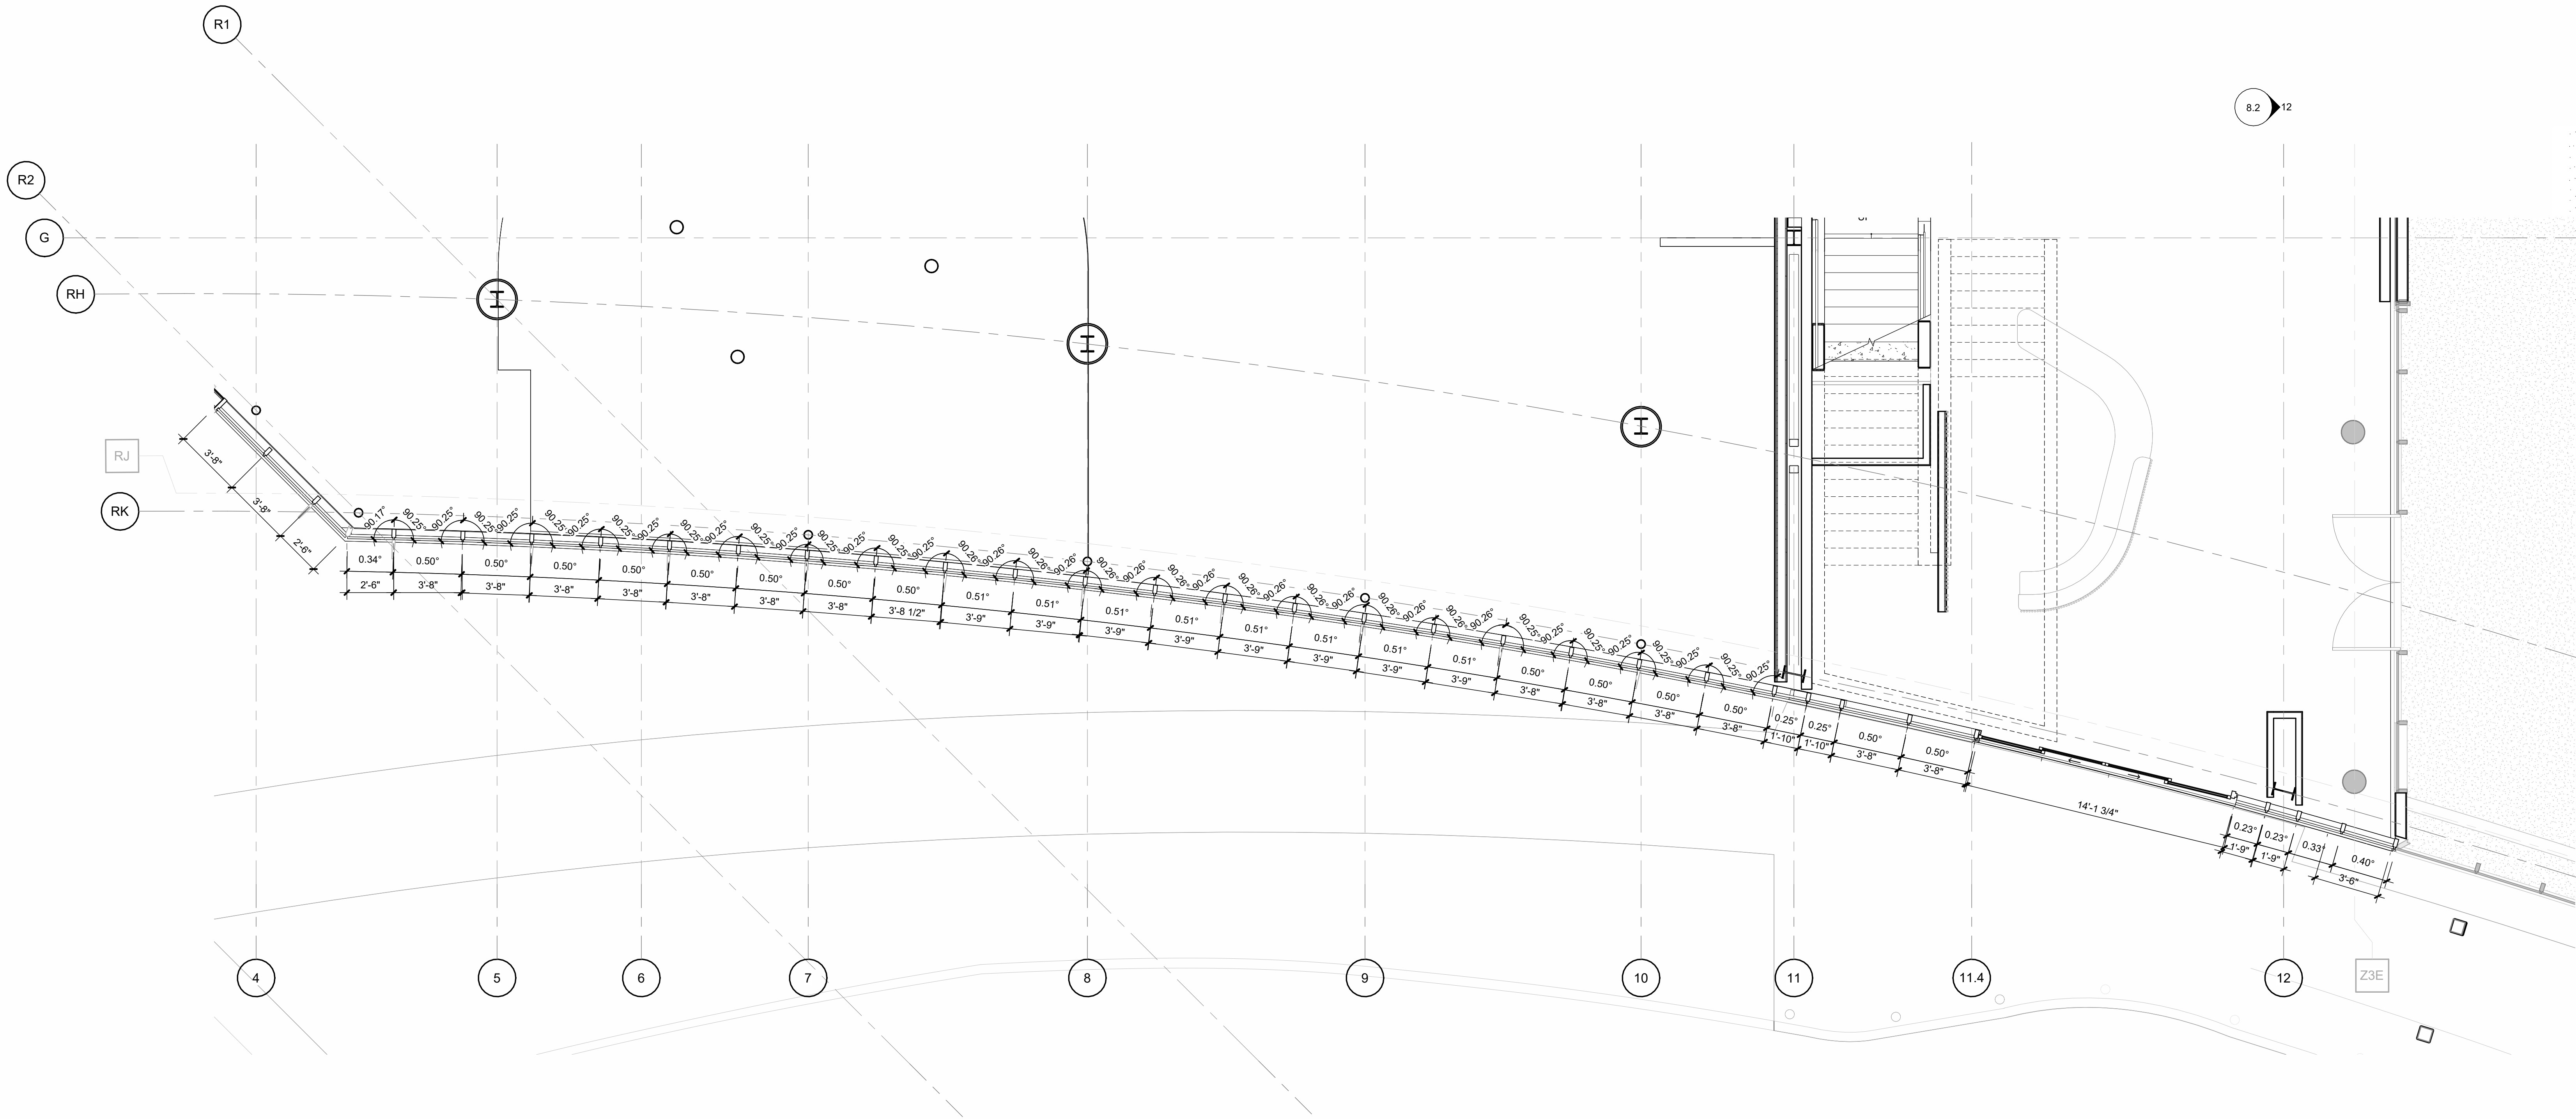
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CROSS SECTIONS




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02 FIRST FLOOR PLAN - CURTAIN WALL DIMENSIONS

1.21 | 1/4" = 1'-0" |



01 ENLARGED ELEVATION - NORTHWEST ELEVATION

5.1 | 3/8" = 1'-0" |
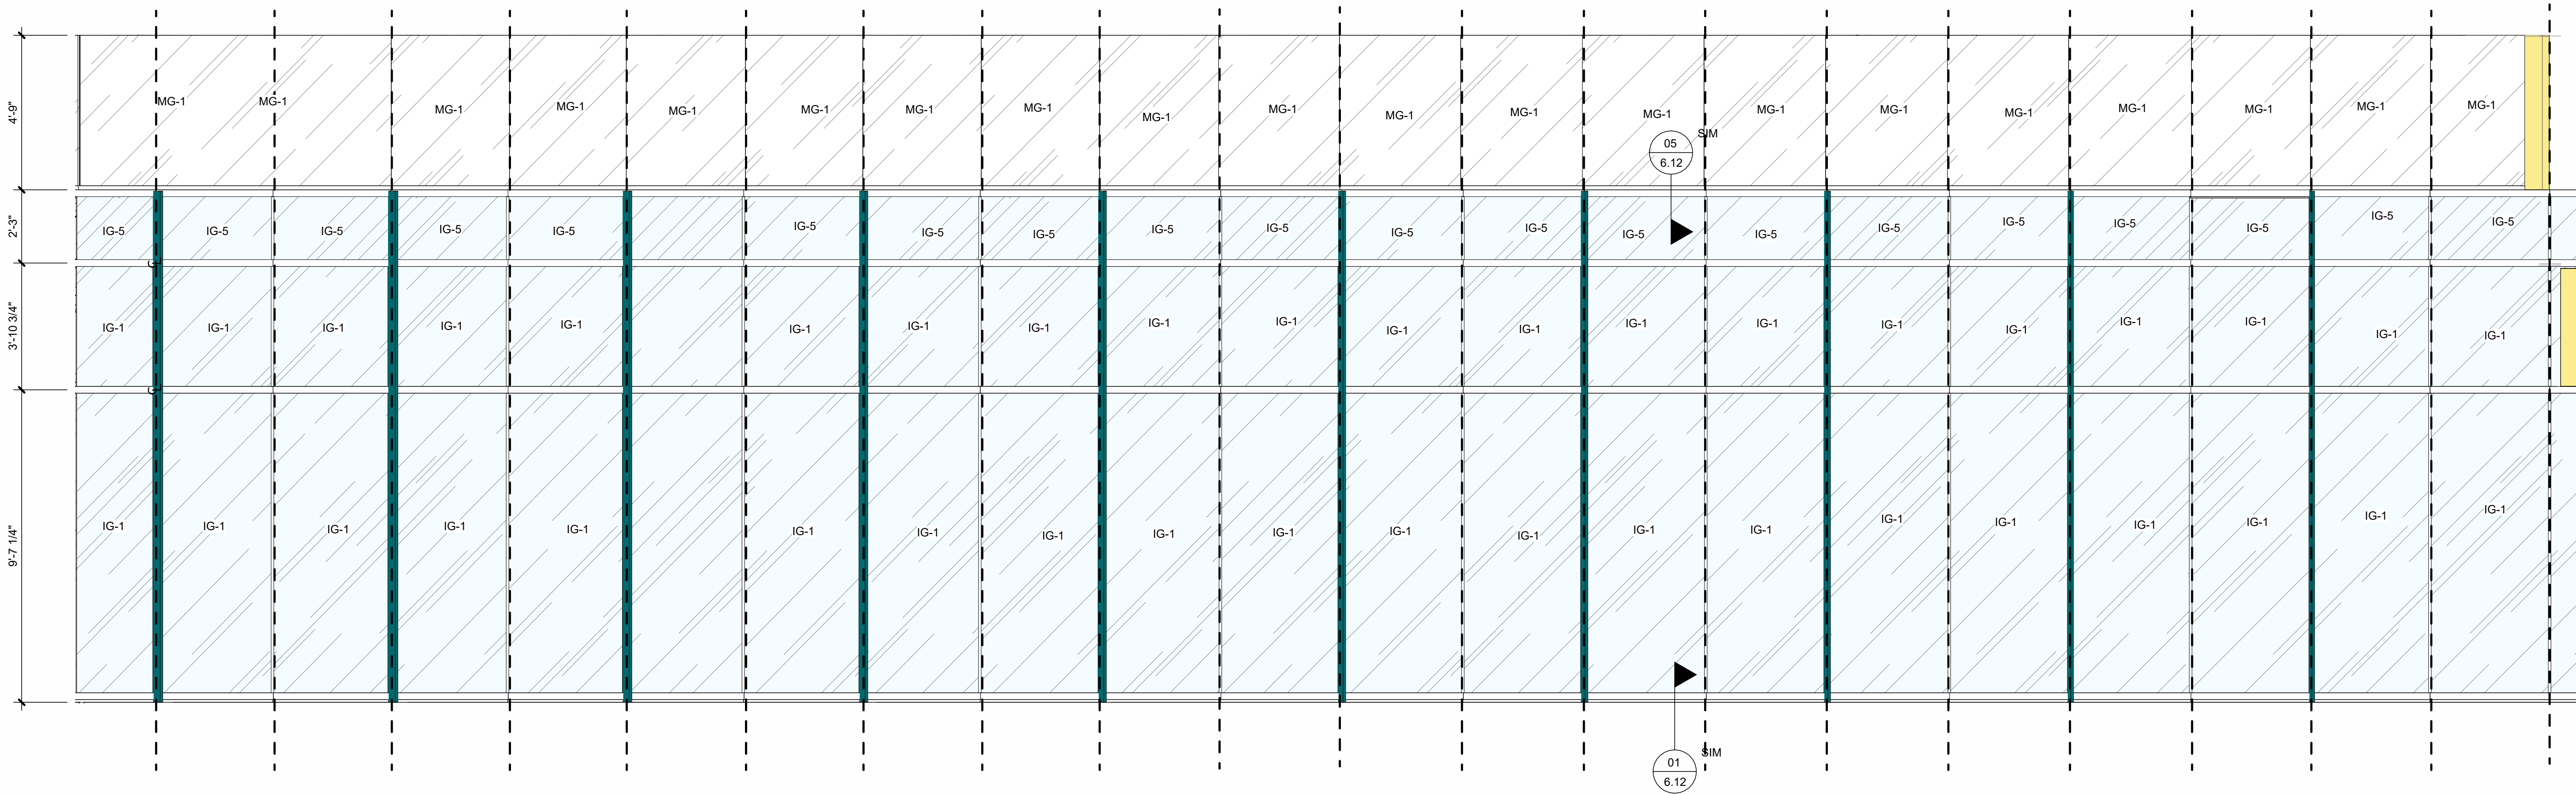
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365 CANAL STREET, SUITE 3150
NEW ORLEANS, LOUISIANA 70130

REFERENCE DESIGNATIONS FOR GLASS TYPES (08 81 00)

NOTE: UNLESS OTHERWISE INDICATED
ALL GLASS SHALL BE IG-1 INSULATING GLASS

IG-1 CLEAR INSULATING LAMINATED GLASS
IG-5 SPANDREL
IG-1 CLEAR LAMINATED GLASS
MG-1 UNCOATED CLEAR ANNEALED FLOAT-GLASS

CURTAIN WALL TYPES

TYPE 1: 2 1/2" x 5 1/4" VERTICAL MULLIONS, 2 1/2" x 5 1/4" HORIZONTAL MULLIONS w/ 2 1/2" x 3/4" MULLION CAP EXTENSIONS

TYPE 2: 2 1/2" x 5 1/4" VERTICAL MULLIONS w/ 12" MULLION EXTENSIONS ON EVERY OTHER VERTICAL MULLION (TO EXTEND FROM FIRST FLOOR TO SECOND FLOOR), 2 1/2" x 5 1/4" HORIZONTAL MULLIONS w/ 2 1/2" x 3/4" MULLION CAP EXTENSIONS

TYPE 3: 2 1/2" x 10 1/2" VERTICAL MULLIONS w/ 12" MULLION EXTENSIONS, 2 1/2" x 5 1/4" HORIZONTAL MULLIONS w/ 12" MULLION EXTENSIONS

EXTERIOR STOREFRONT TYPES

TYPE 1: 2 1/2" x 5 1/4" VERTICAL MULLIONS, 2 1/2" x 5 1/4" HORIZONTAL MULLIONS w/ 2 1/2" x 3/4" MULLION CAP EXTENSIONS

WALKER'S IMAGINARIUM

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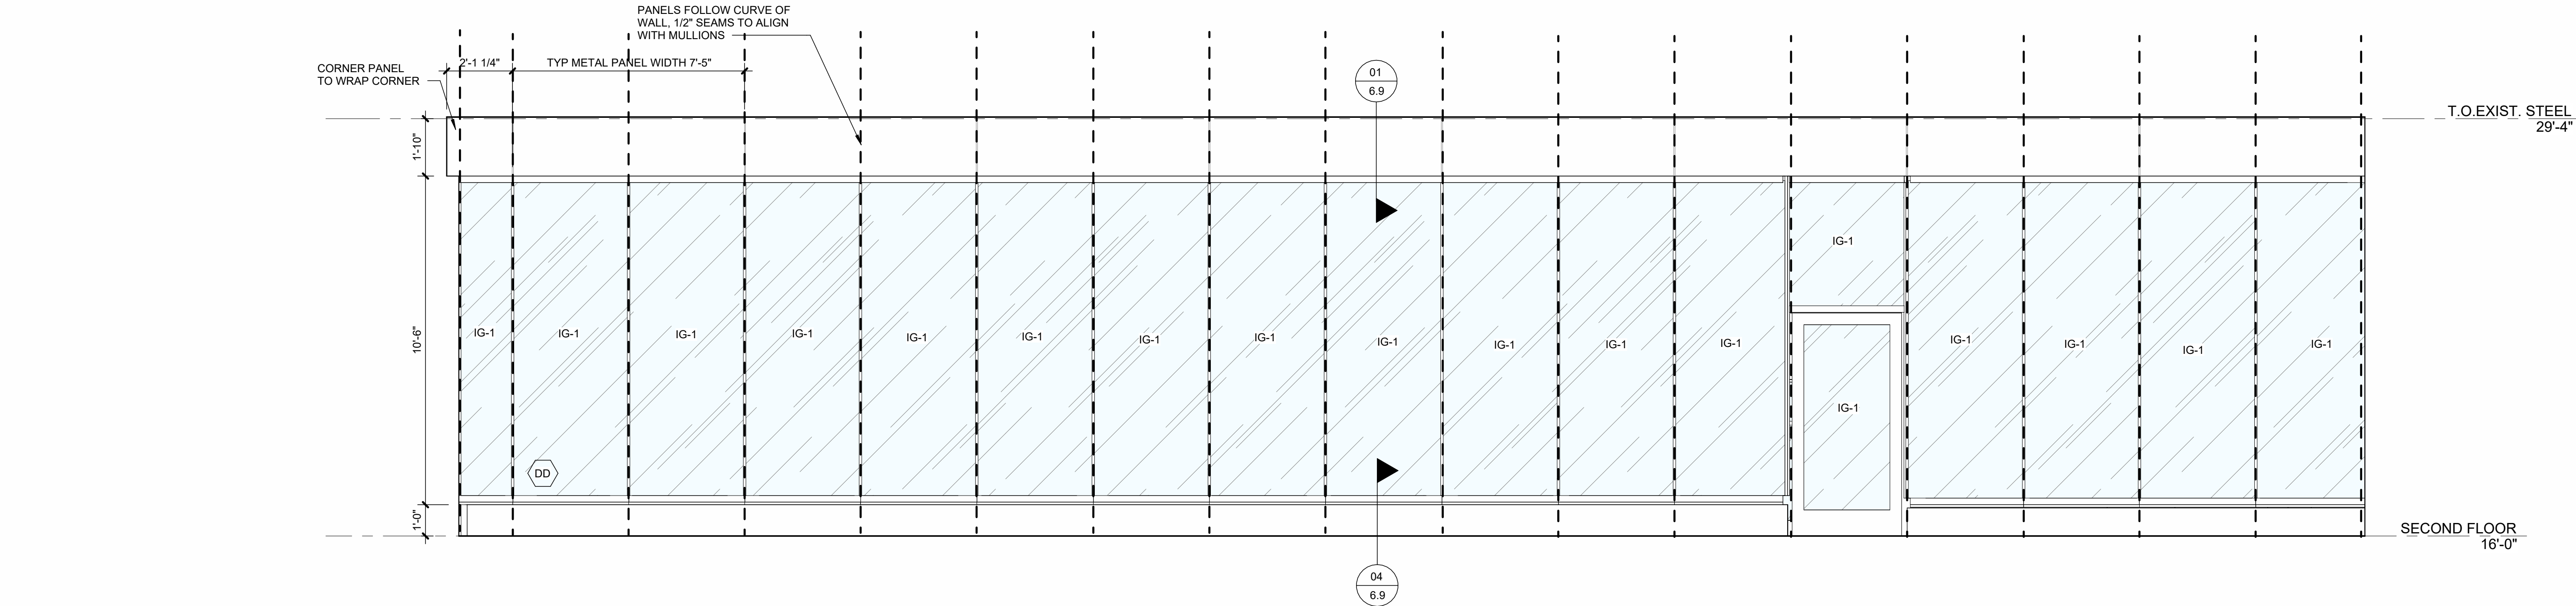
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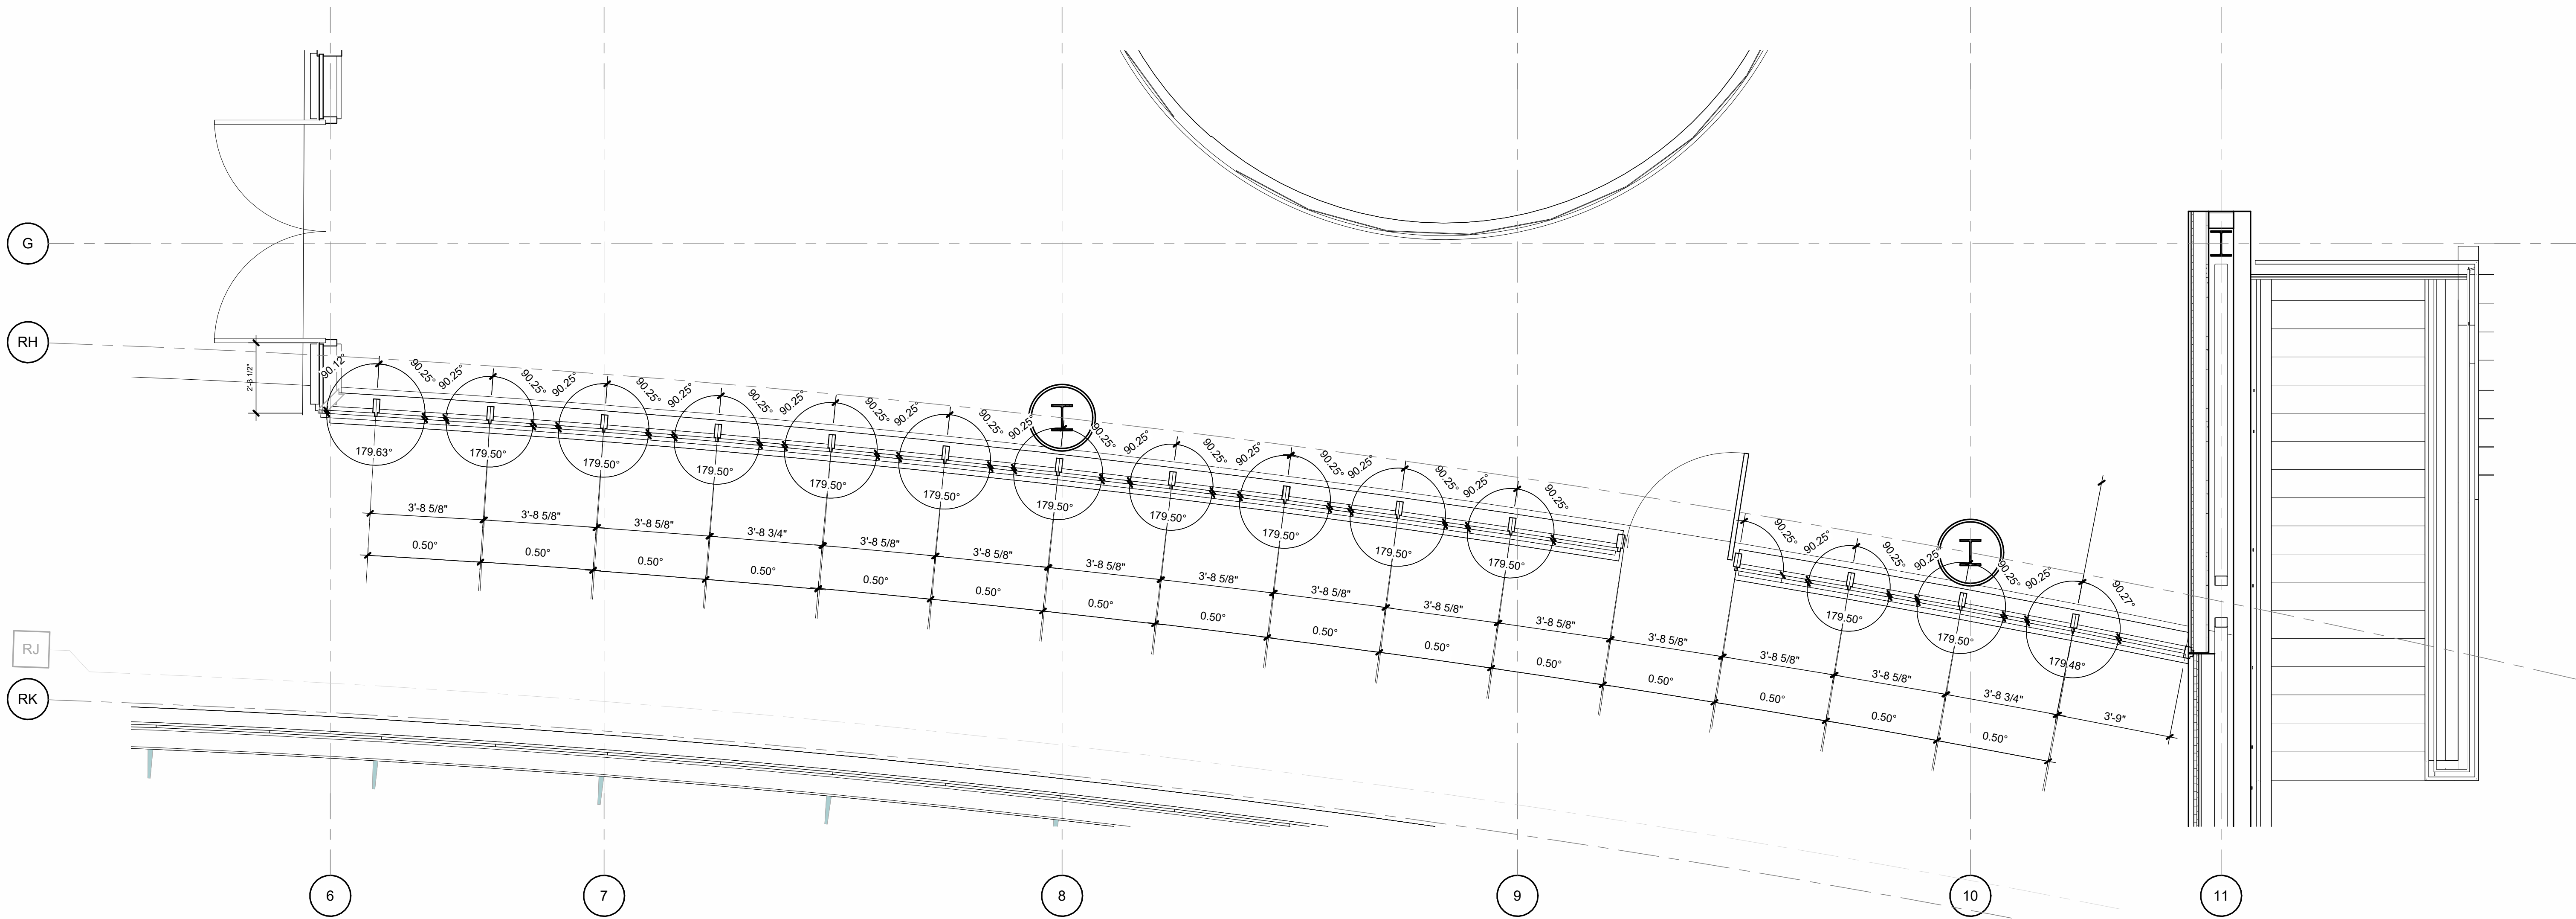
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EXTERIOR CURTAIN WALL



02 ENLARGED ELEVATION - PORCH STOREFRONT
3/8" = 1'-0"



01 SECOND FLOOR STOREFRONT DIMENSION PLAN
1.21 3/8" = 1'-0"

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365 CANAL STREET, SUITE 3150
NEW ORLEANS, LOUISIANA 70130

REFERENCE DESIGNATIONS FOR
GLASS TYPES (08 81 00)

NOTE: UNLESS OTHERWISE INDICATED
ALL GLASS SHALL BE IG-1 INSULATING LAMINATED GLASS

IG-1 CLEAR INSULATING LAMINATED GLASS
IG-5 SPANDREL
MG-1 UNCOATED CLEAR ANNEALED FLOAT-GLASS

CURTAIN WALL TYPES

TYPE 1: 2 1/2" x 5 1/4" VERTICAL MULLIONS, 2 1/2" x 5 1/4" HORIZONTAL MULLIONS w/ 2 1/2" x 3/4" MULLION CAP EXTENSIONS

TYPE 2: 2 1/2" x 5 1/4" VERTICAL MULLIONS w/ 12" MULLION EXTENSIONS ON EVERY OTHER VERTICAL MULLION (TO EXTEND FROM FIRST FLOOR TO SECOND FLOOR), 2 1/2" x 5 1/4" HORIZONTAL MULLIONS w/ 2 1/2" x 3/4" MULLION CAP EXTENSIONS

TYPE 3: 2 1/2" x 10 1/2" VERTICAL MULLIONS w/ 12" MULLION EXTENSIONS, 2 1/2" x 5 1/4" HORIZONTAL MULLIONS w/ 12" MULLION EXTENSIONS

EXTERIOR STOREFRONT TYPES

TYPE 1: 2 1/2" x 5 1/4" VERTICAL MULLIONS, 2 1/2" x 5 1/4" HORIZONTAL MULLIONS w/ 2 1/2" x 3/4" MULLION CAP EXTENSIONS

DD (08 41 13) STOREFRONT WALL TYPE 1

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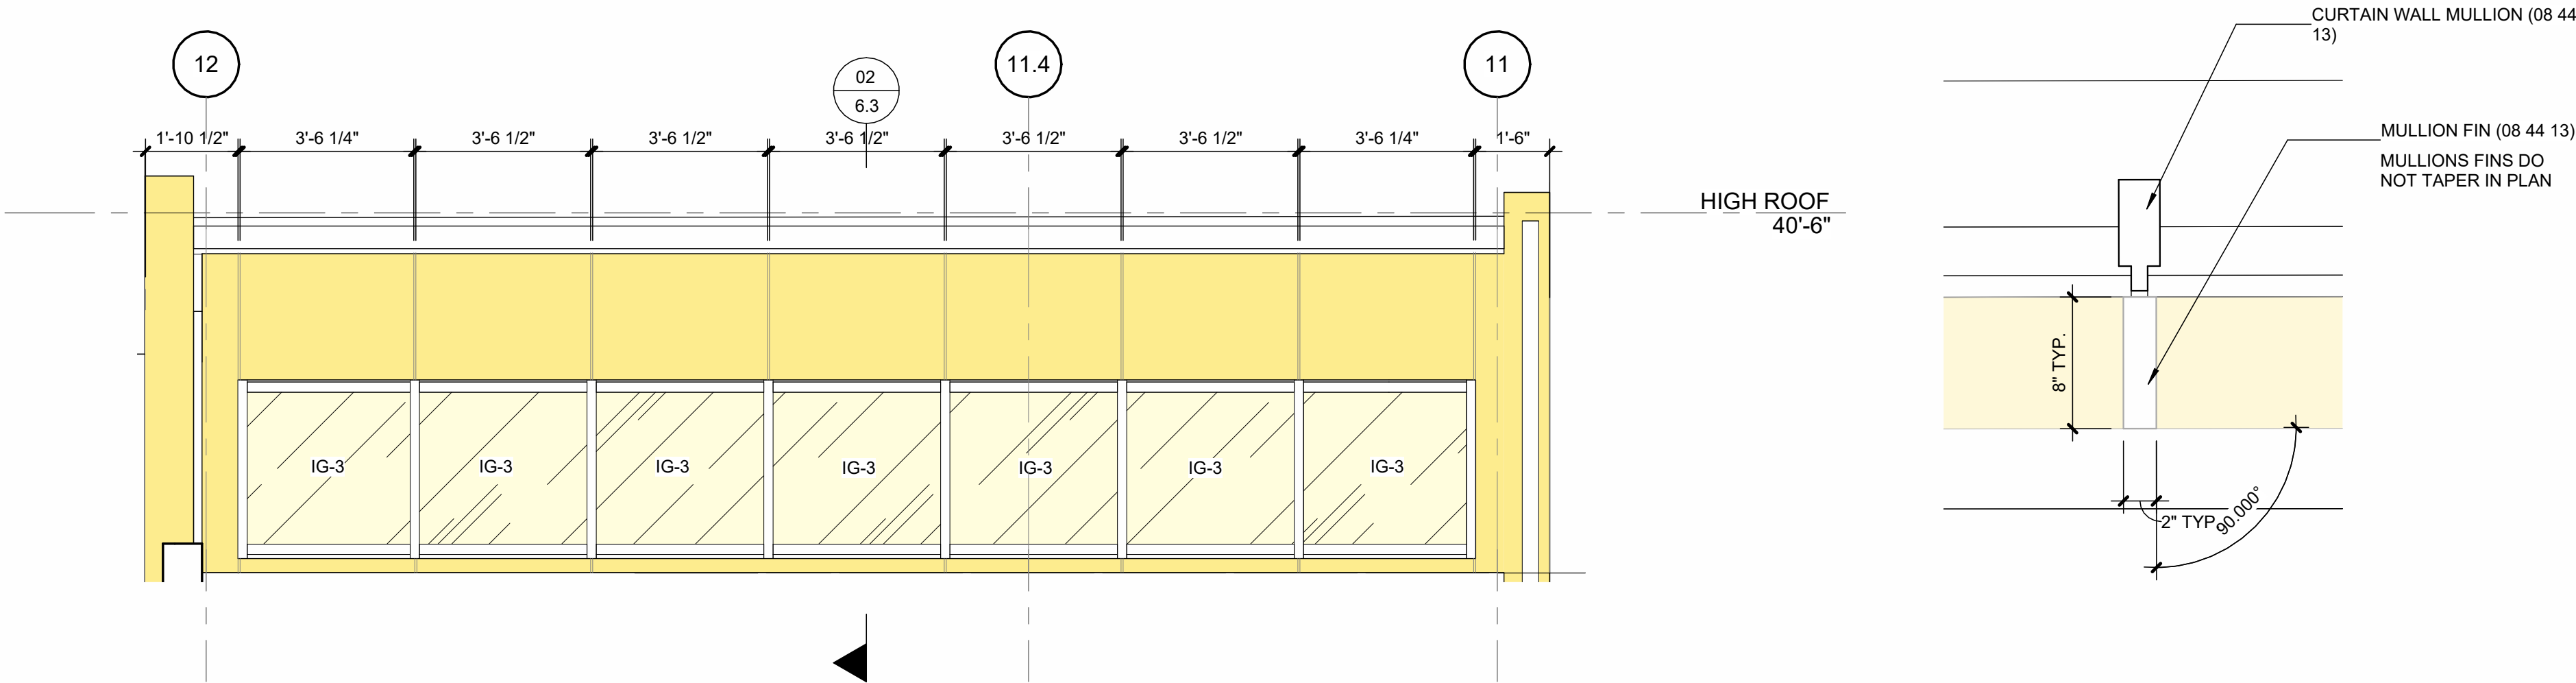
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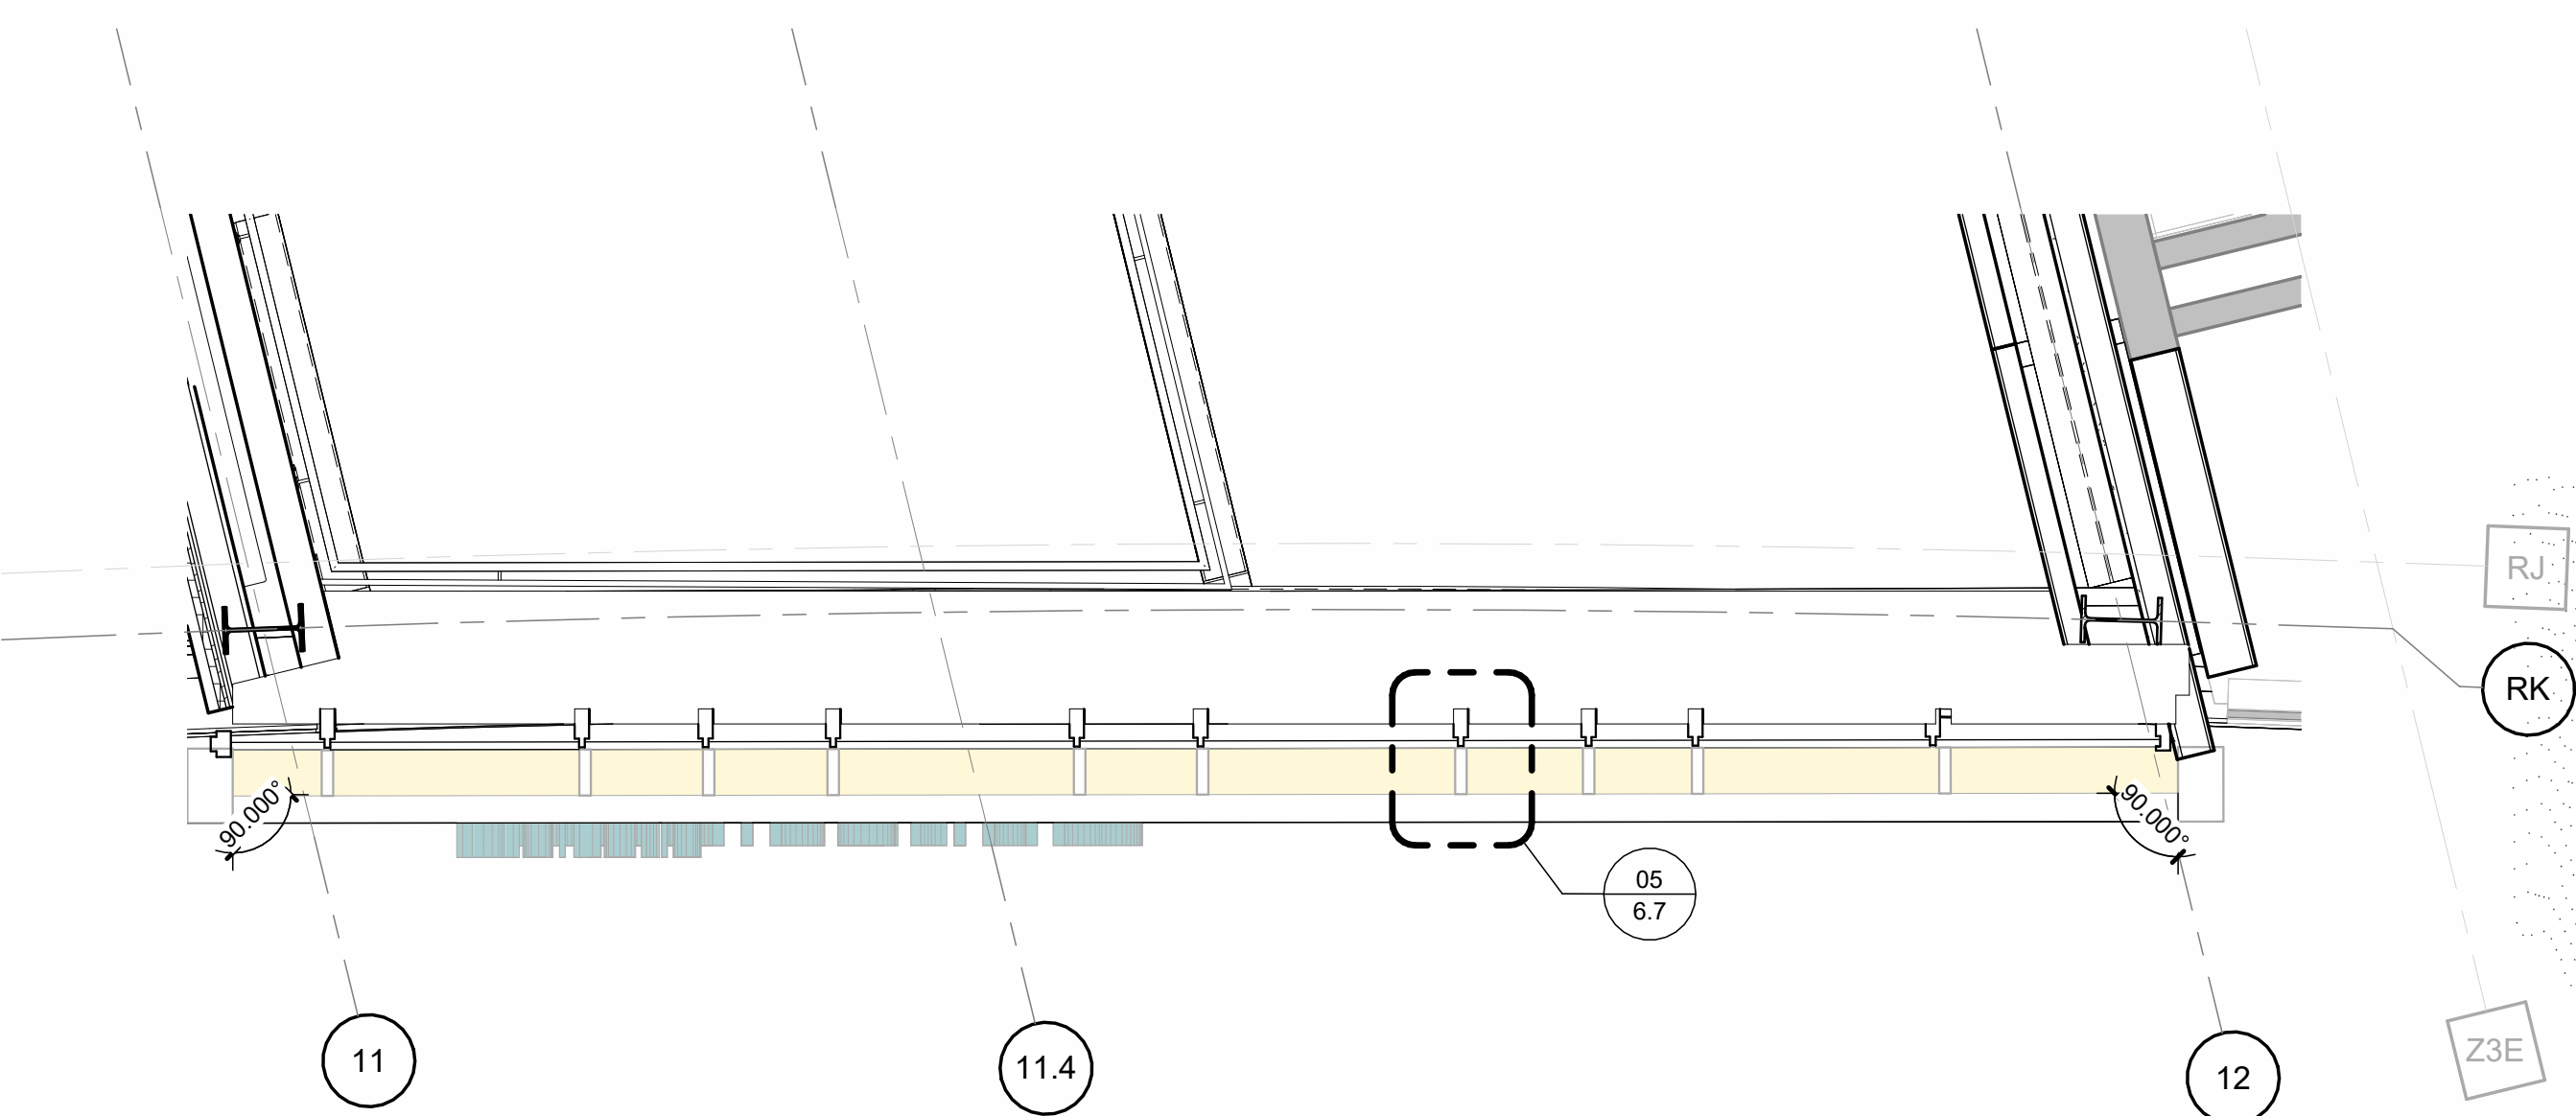
REVISIONS

EXTERIOR STOREFRONT




06 CLERESTORY ELEVATION
4.1 | 3/8" = 1'-0" |


05 ENTRY MULLION FIN, TYP.
6.7 | 1 1/2" = 1'-0" |




04 ENLARGED SECOND FLOOR PLAN AT ENTRY
2.20 | 3/8" = 1'-0" |

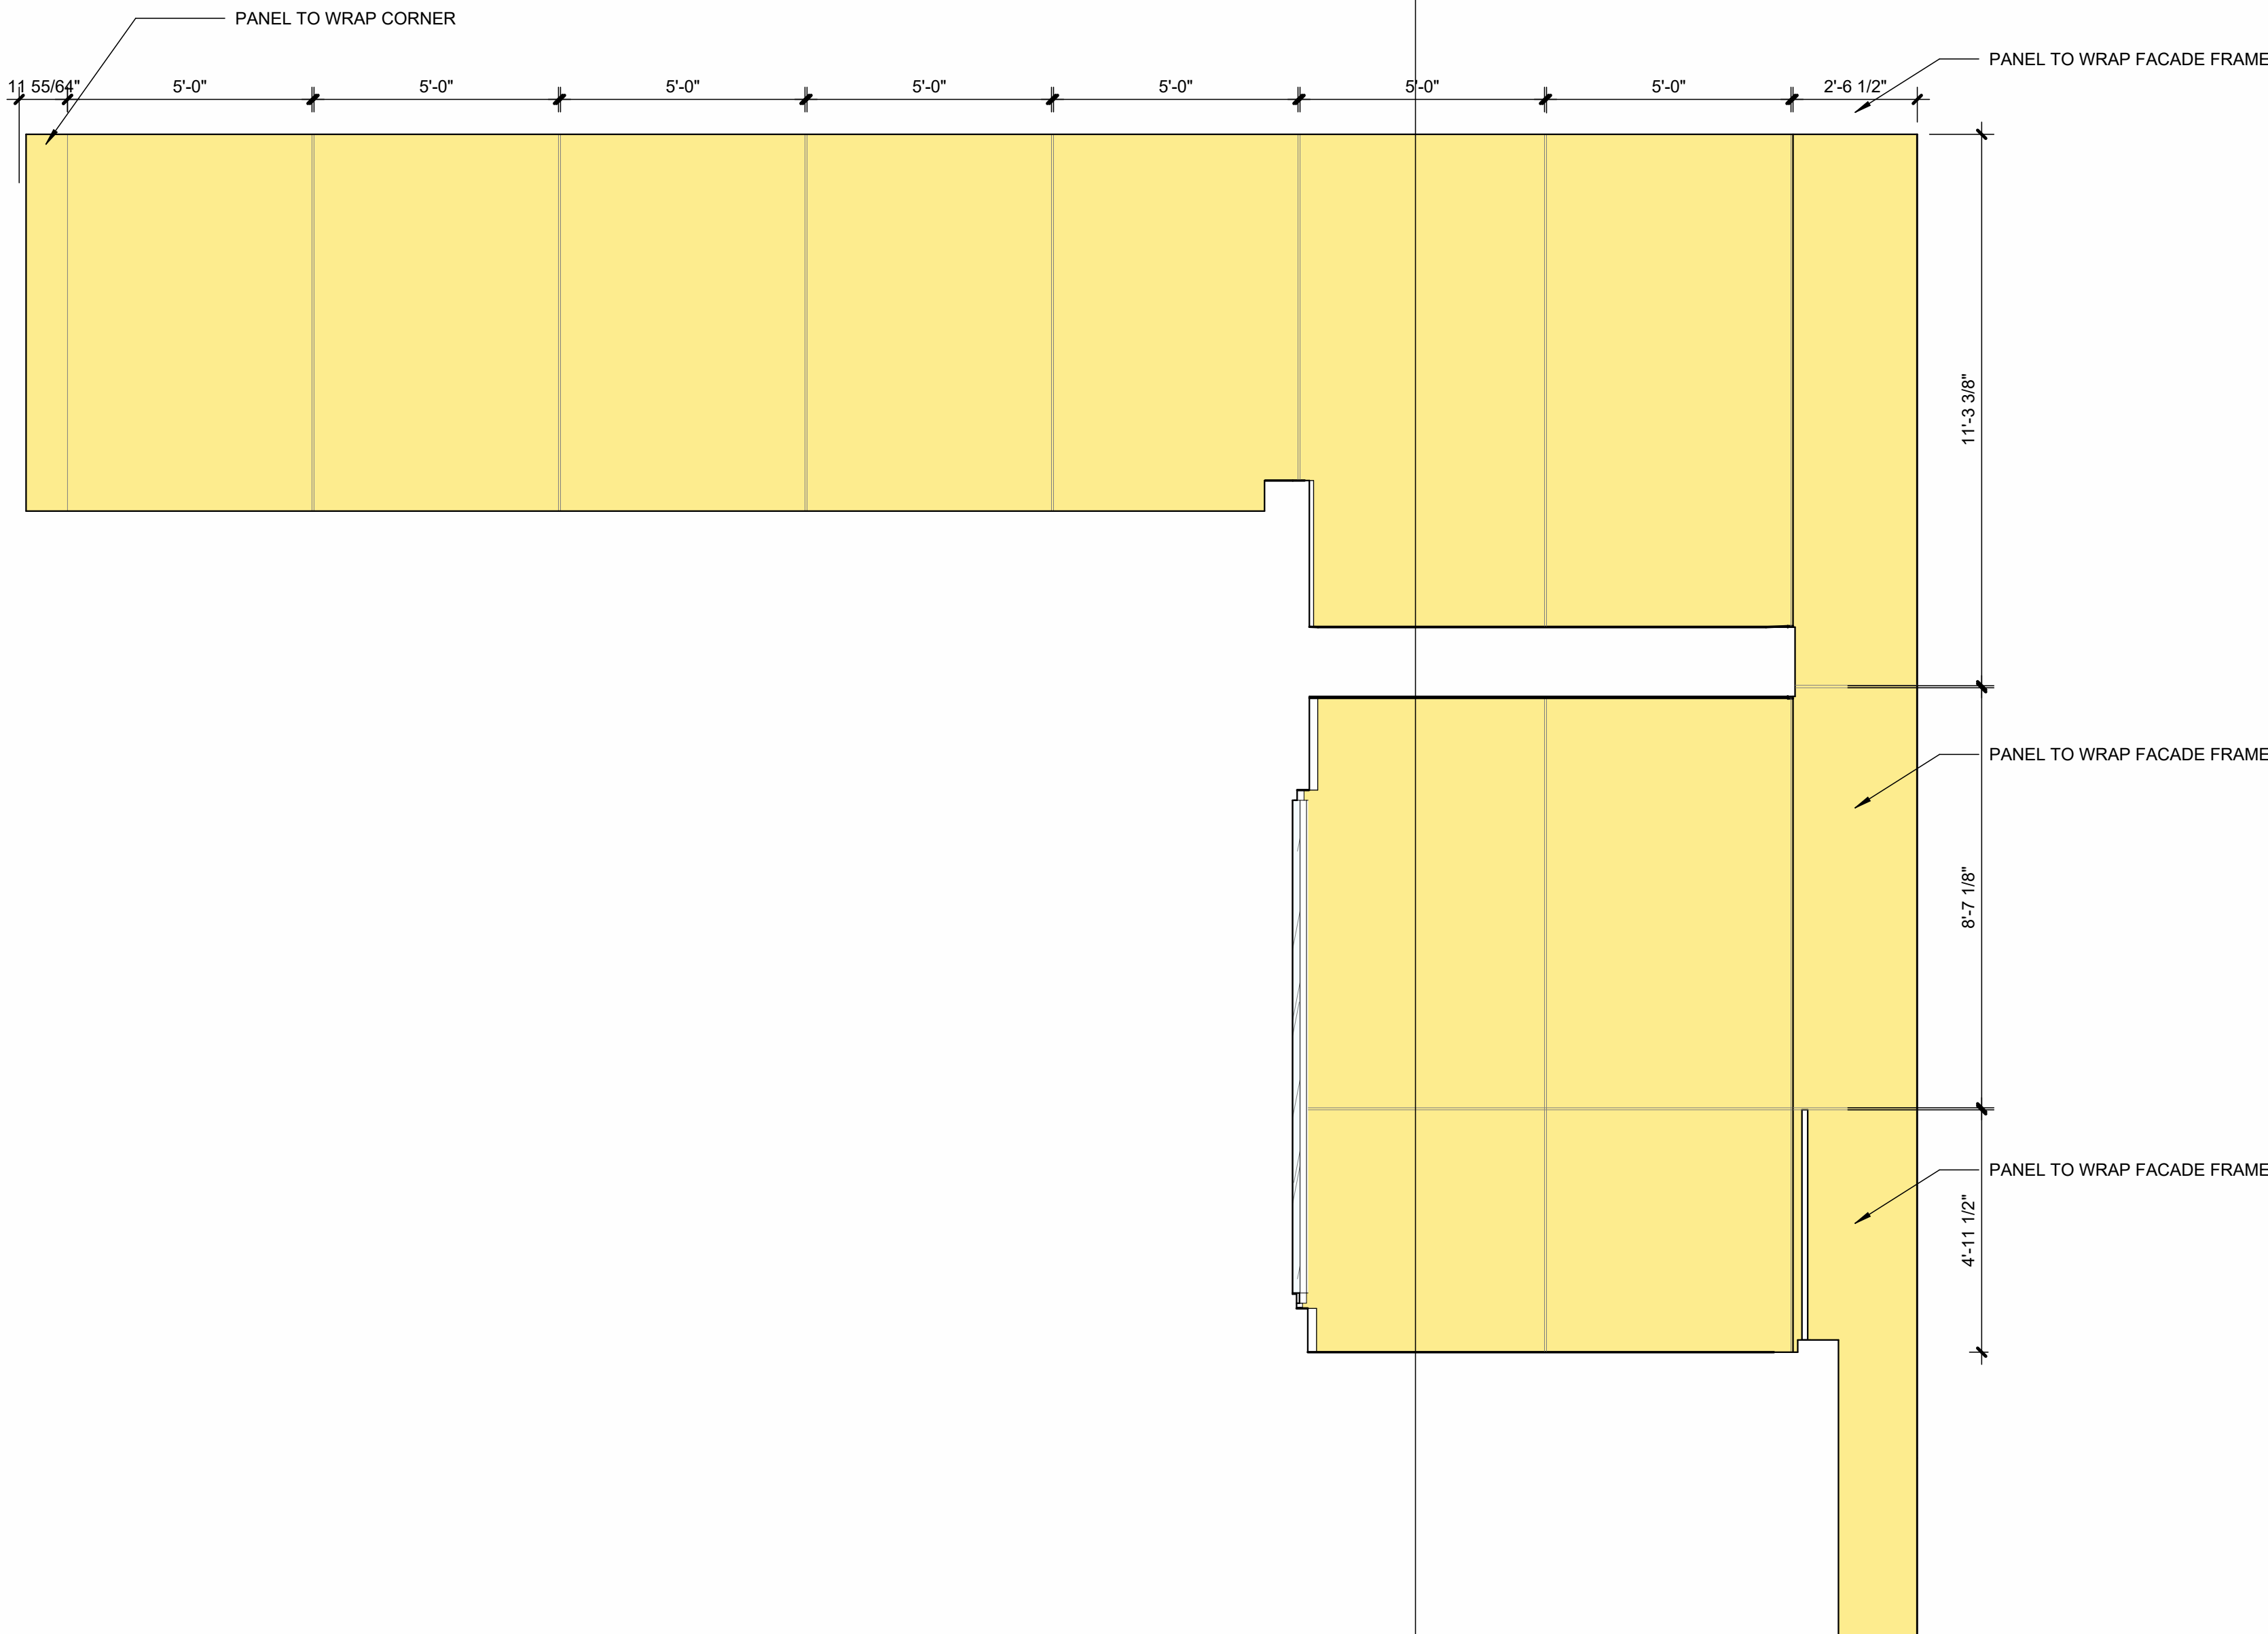

03 ENTRY VOLUME WEST ELEVATION FOR PANEL PLACEMENT
2.20 | 3/8" = 1'-0" |

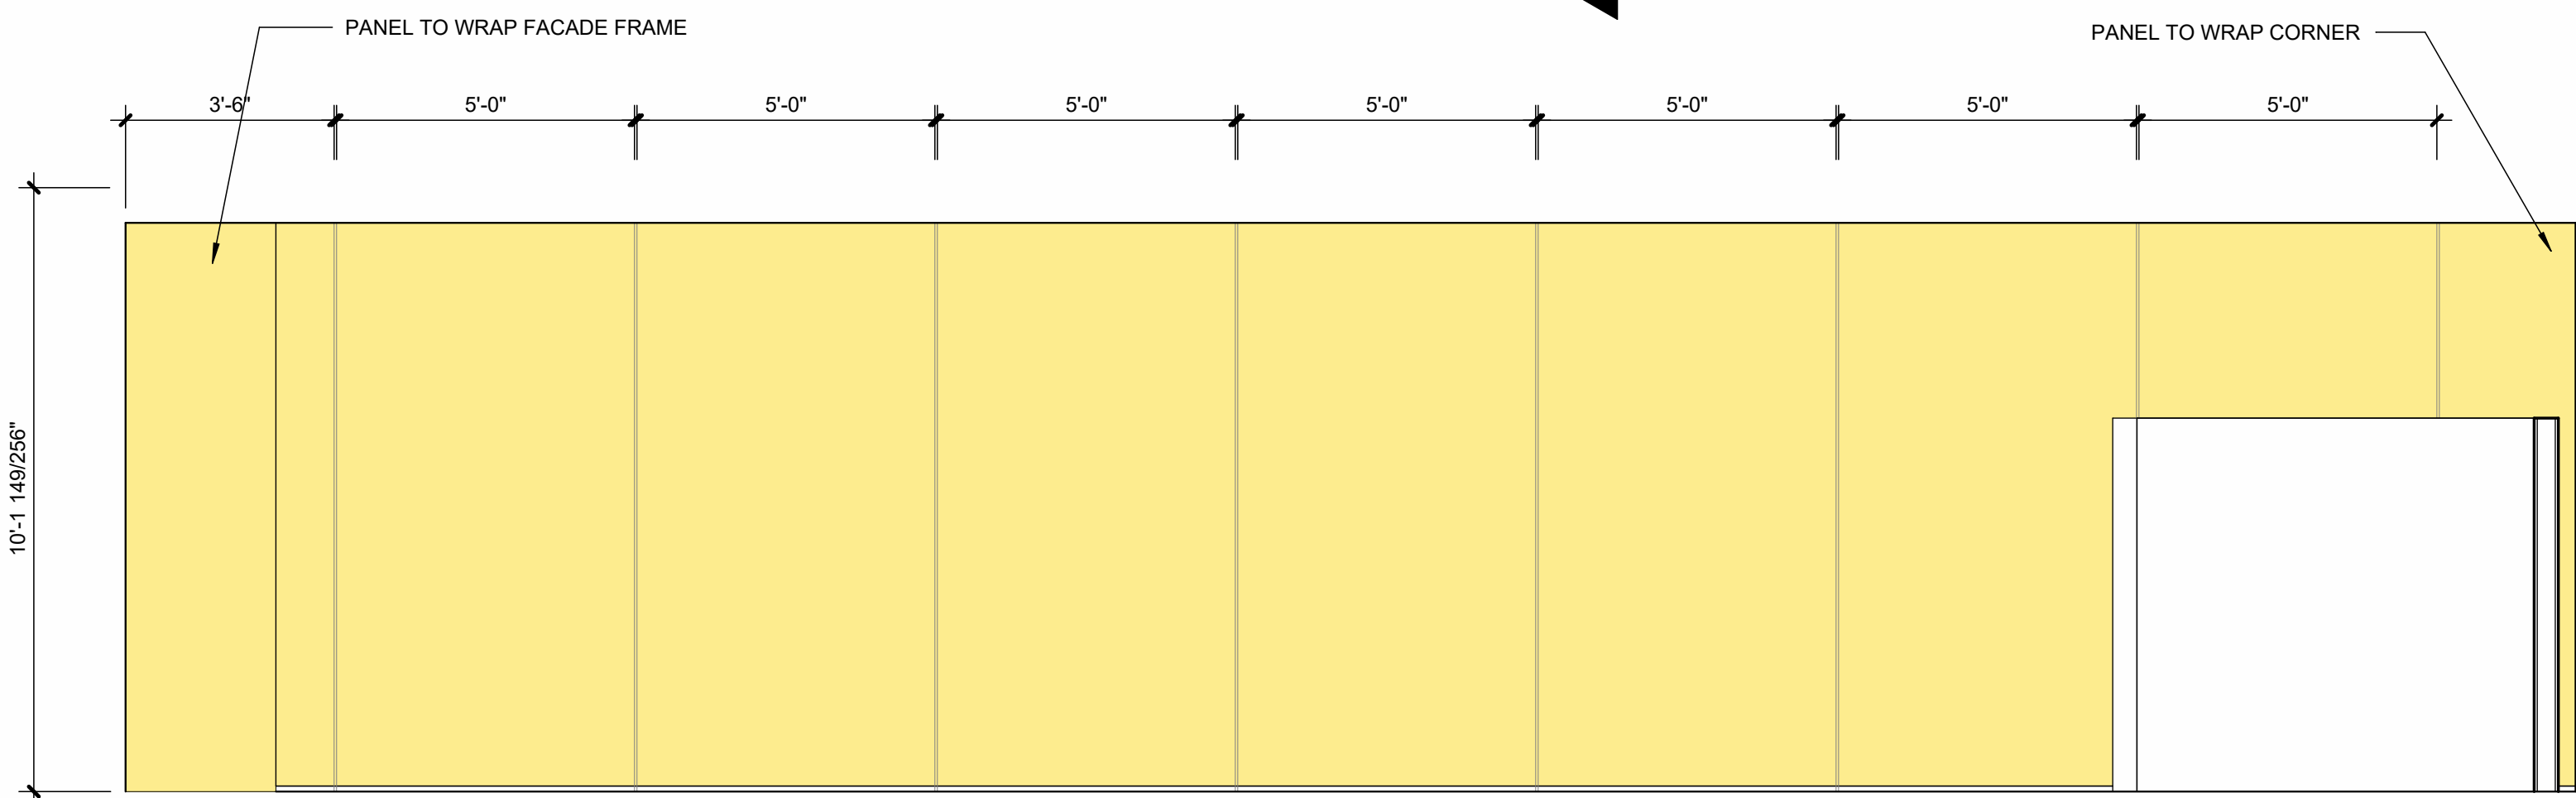

02 ENTRY VOLUME EAST ELEVATION FOR PANEL PLACEMENT
4.1 | 3/8" = 1'-0" |

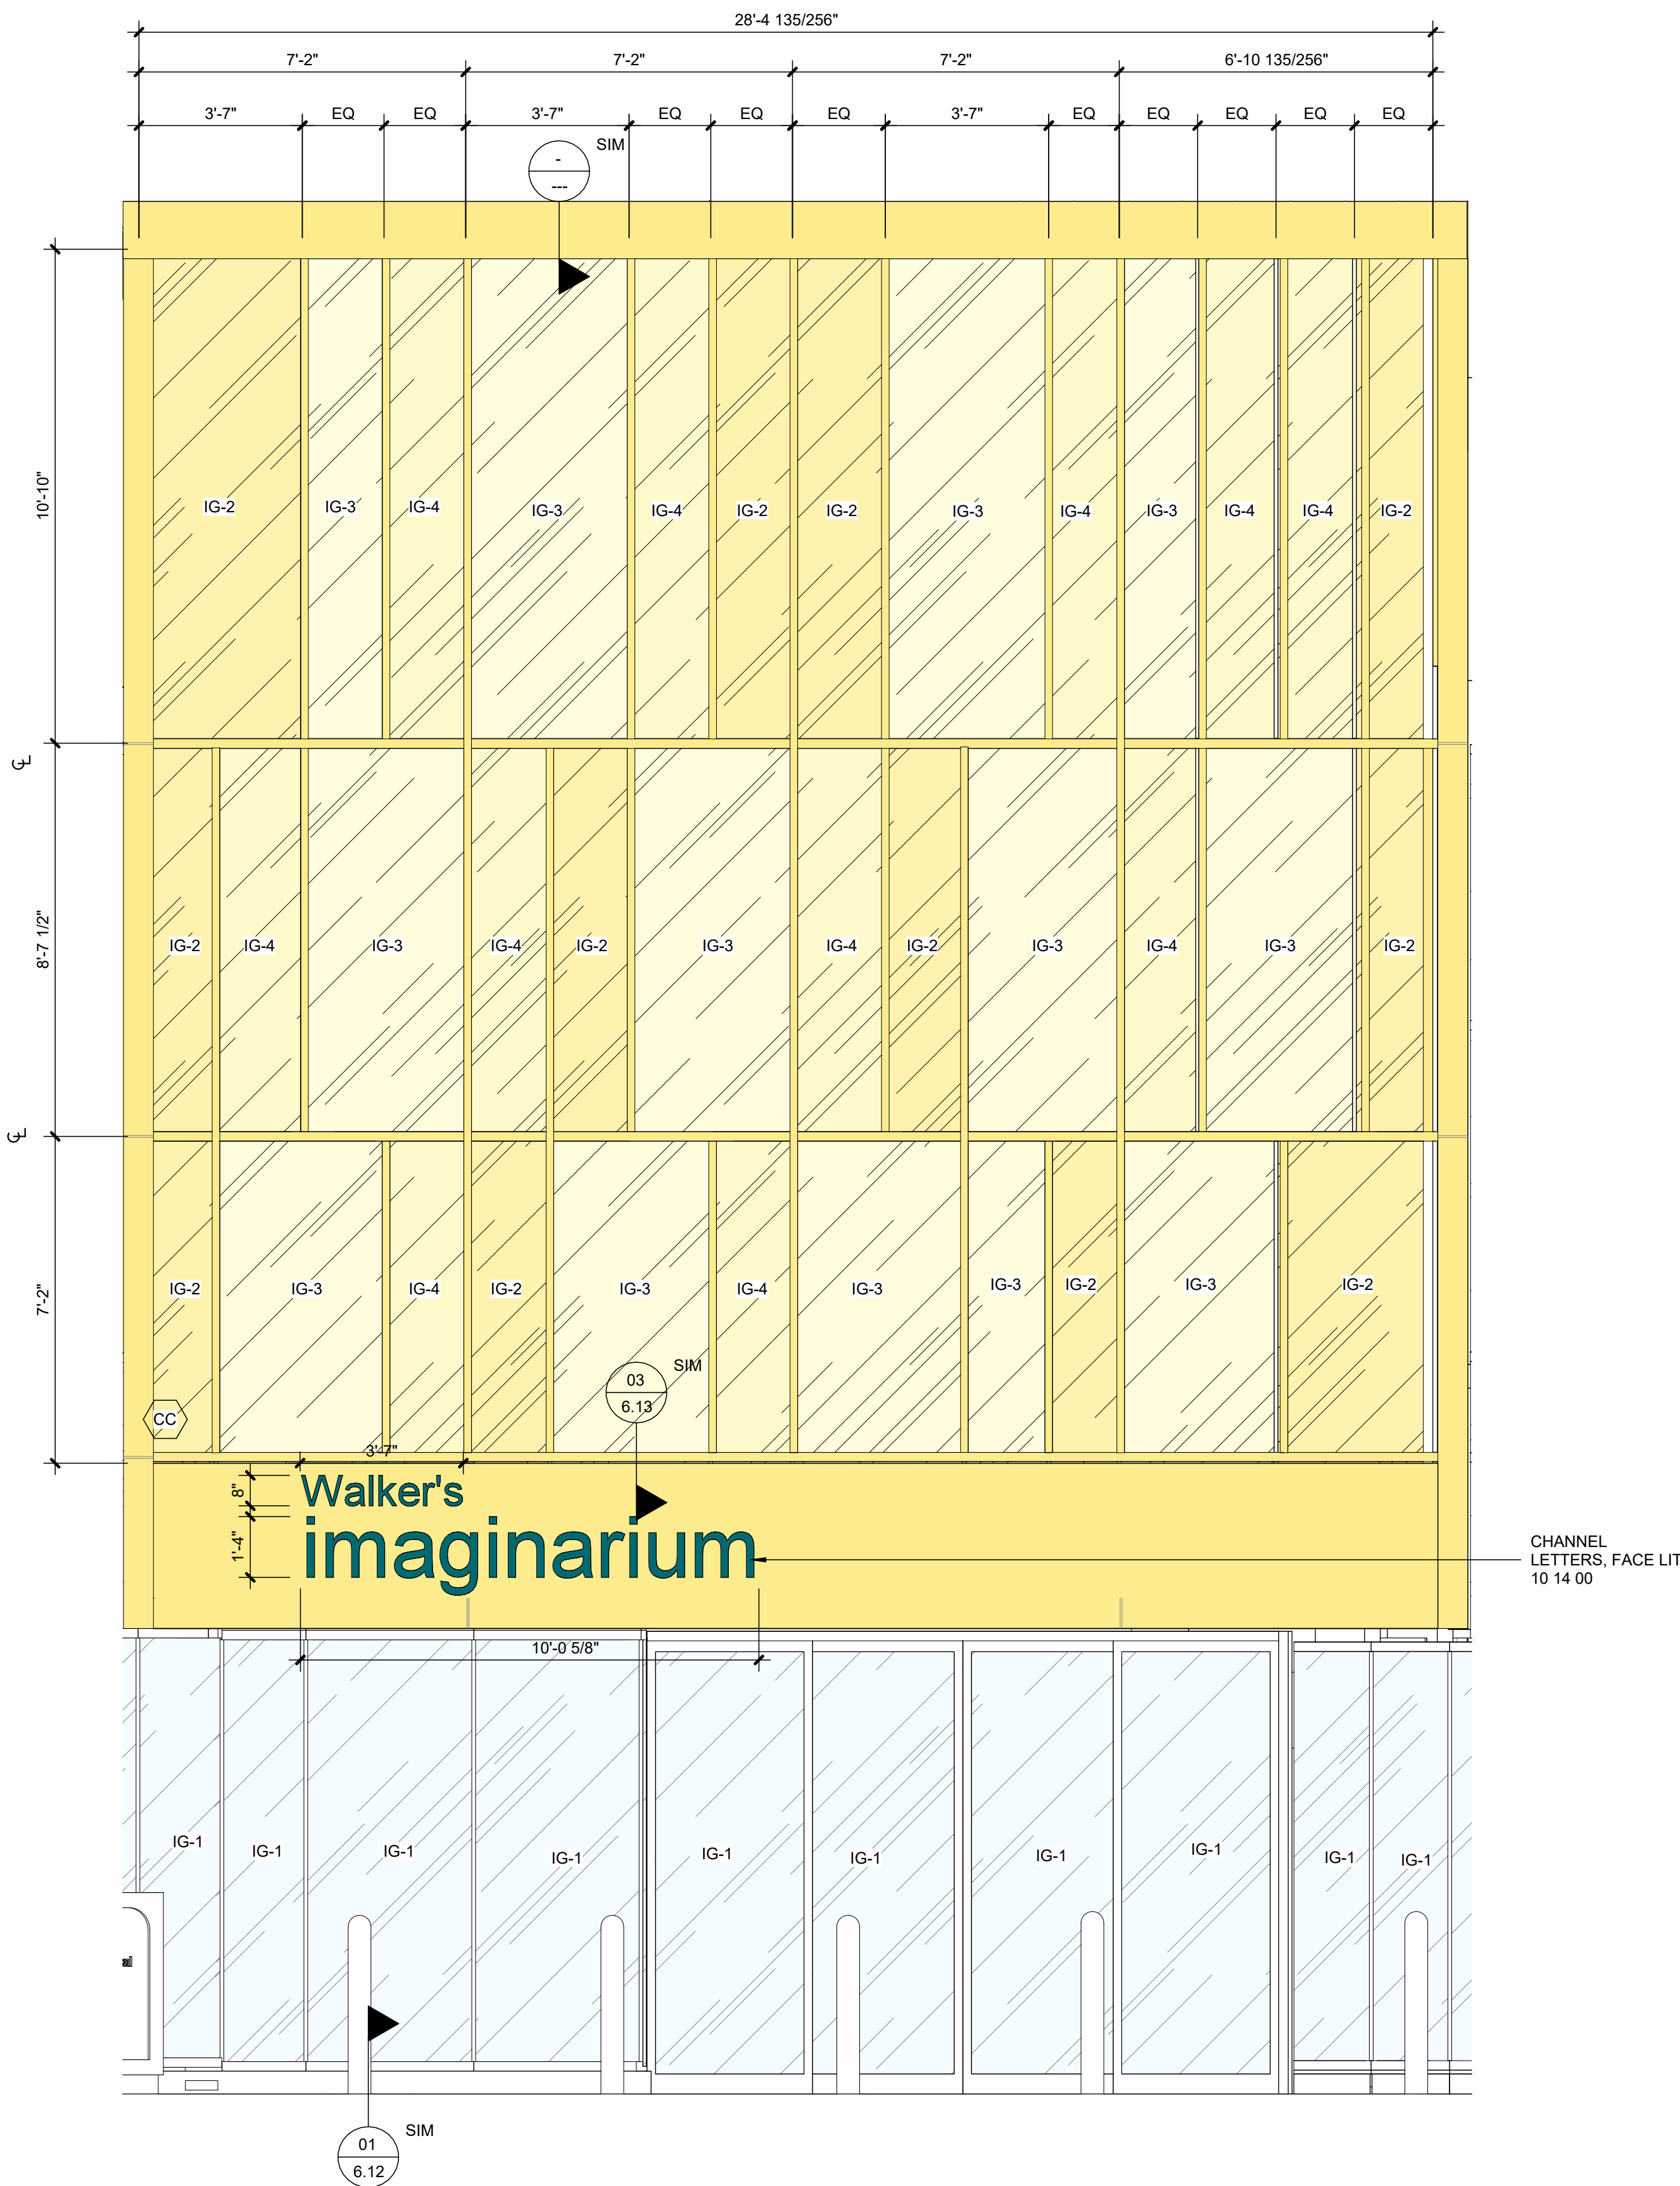

01 ENLARGED ELEVATIONS - ENTRY ELEVATION
5.1 | 3/8" = 1'-0" |

ESKEW+DUMEZ+RIPPLE

365 CANAL STREET, SUITE 3150
NEW ORLEANS, LOUISIANA 70130

REFERENCE DESIGNATIONS FOR GLASS TYPES (08 81 00)

NOTE: UNLESS OTHERWISE INDICATED
ALL GLASS SHALL BE IG-1 INSULATING GLASS

IG-1	CLEAR INSULATING LAMINATED GLASS
IG-2	CLEAR INSULATING LAMINATED WITH APPLIED FILM - COLOR 1
IG-3	CLEAR INSULATING LAMINATED WITH APPLIED FILM - COLOR 2
IG-4	CLEAR INSULATING LAMINATED WITH APPLIED FILM - COLOR 3
IG-5	SPANDREL
IG-1	CLEAR LAMINATED GLASS
MG-1	UNCOATED CLEAR ANNEALED FLOAT-GLASS

CURTAIN WALL TYPES

TYPE 1: 2 1/2" x 5 1/4" VERTICAL MULLIONS, 2 1/2" x 5 1/4" HORIZONTAL MULLIONS w/ 2 1/2" x 3/4" MULLION CAP EXTENSIONS

TYPE 2: 2 1/2" x 5 1/4" VERTICAL MULLIONS w/ 12" MULLION EXTENSIONS ON EVERY OTHER VERTICAL MULLION (TO EXTEND FROM FIRST FLOOR TO SECOND FLOOR), 2 1/2" x 5 1/4" HORIZONTAL MULLIONS w/ 2 1/2" x 3/4" MULLION CAP EXTENSIONS

TYPE 3: 2 1/2" x 10 1/2" VERTICAL MULLIONS w/ 12" MULLION EXTENSIONS, 2 1/2" x 5 1/4" HORIZONTAL MULLIONS w/ 12" MULLION EXTENSIONS

EXTERIOR STOREFRONT TYPES

TYPE 1: 2 1/2" x 5 1/4" VERTICAL MULLIONS, 2 1/2" x 5 1/4" HORIZONTAL MULLIONS w/ 2 1/2" x 3/4" MULLION CAP EXTENSIONS

CC (08 44 13) CURTAIN WALL TYPE 3

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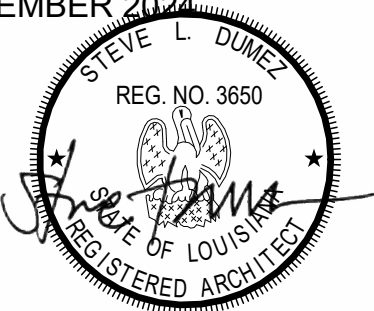
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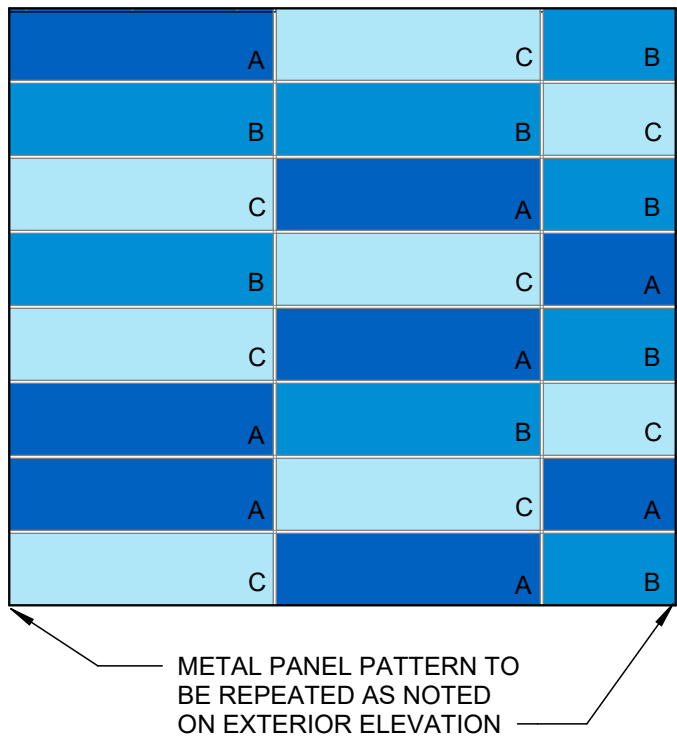
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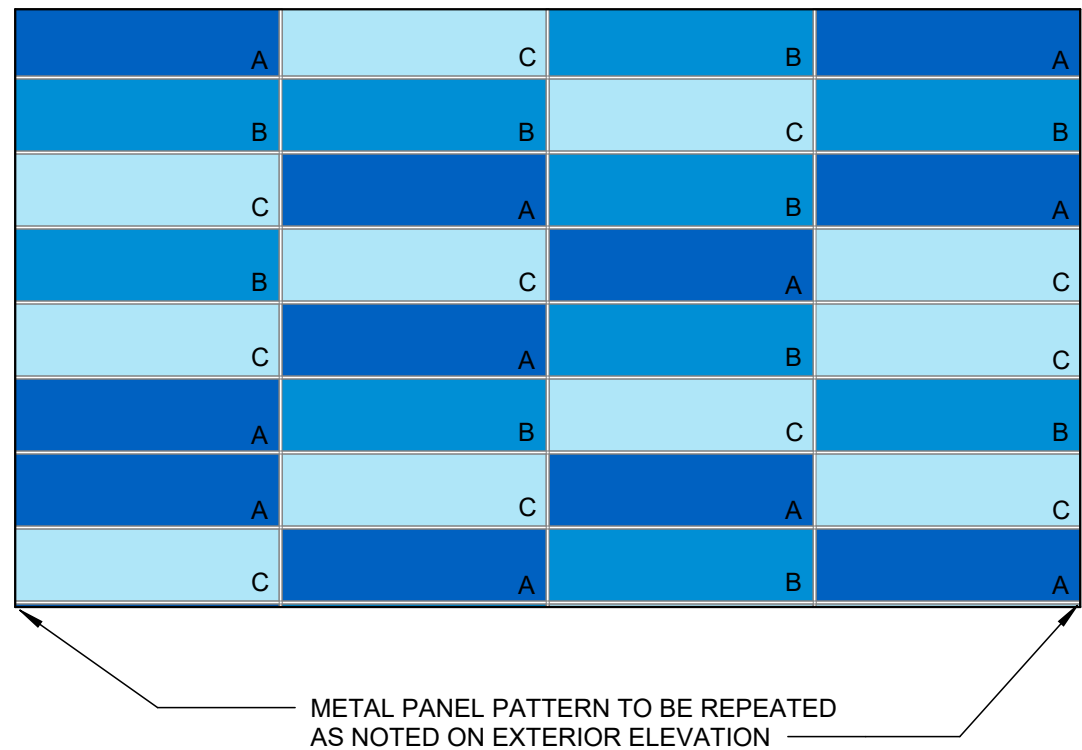
REVISIONS

EXTERIOR CURTAIN WALL






07 NORTH WALL METAL PANEL, TYP.




06 SOUTH WALL METAL PANEL, TYP.

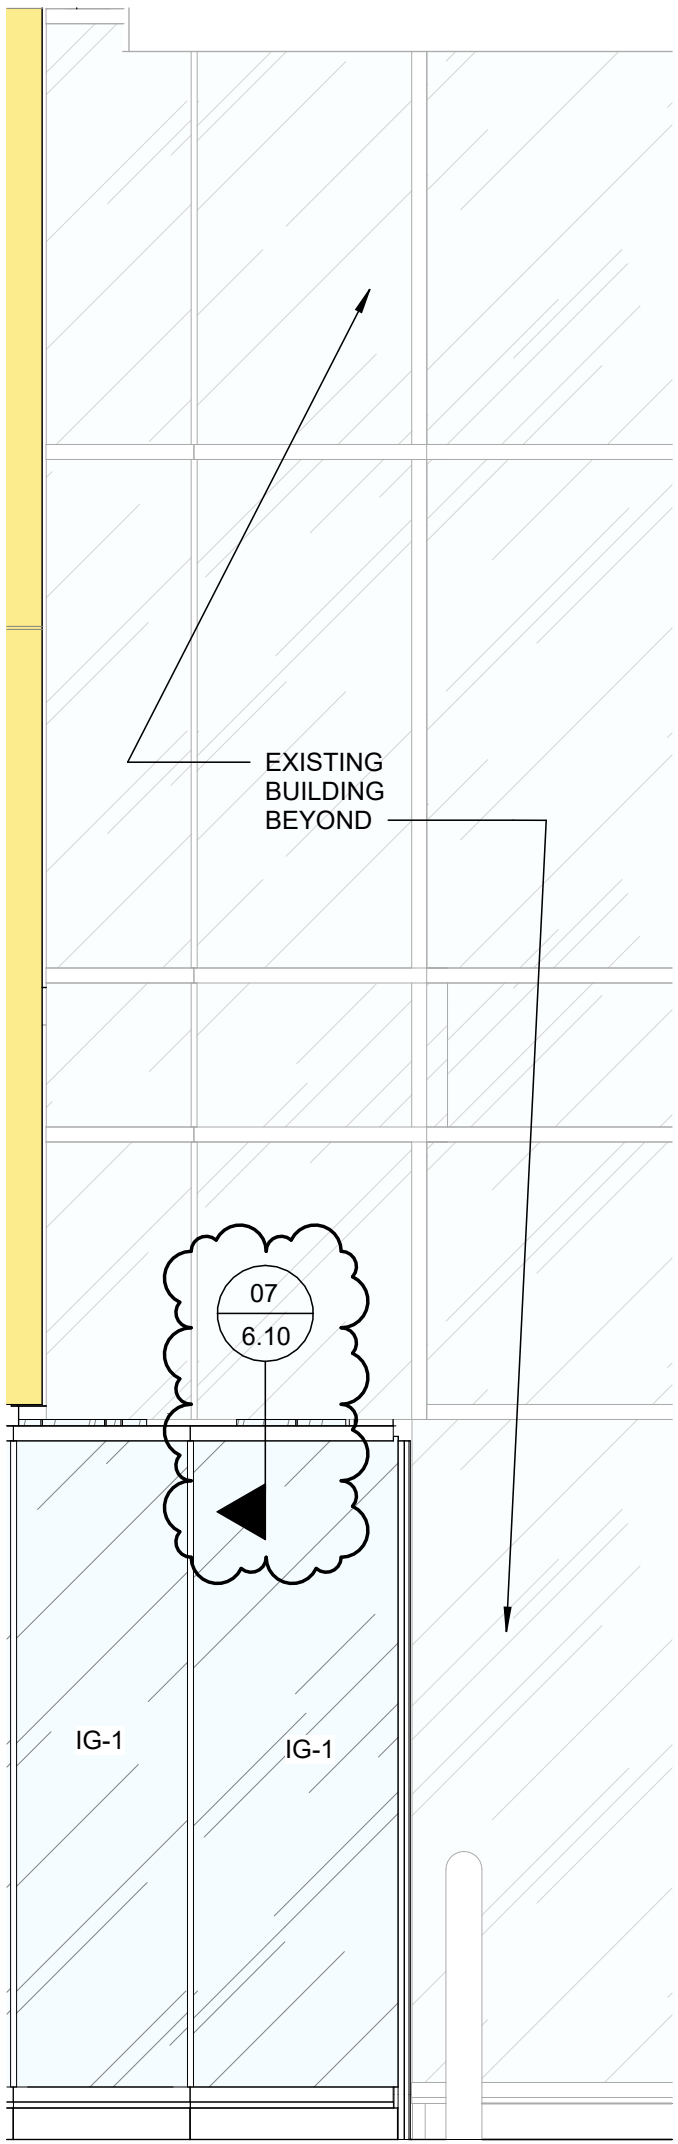


*SEE 4/6.4 FOR DIMENSION PLAN


02 NORTHWEST ELEVATION AT ENTRANCE

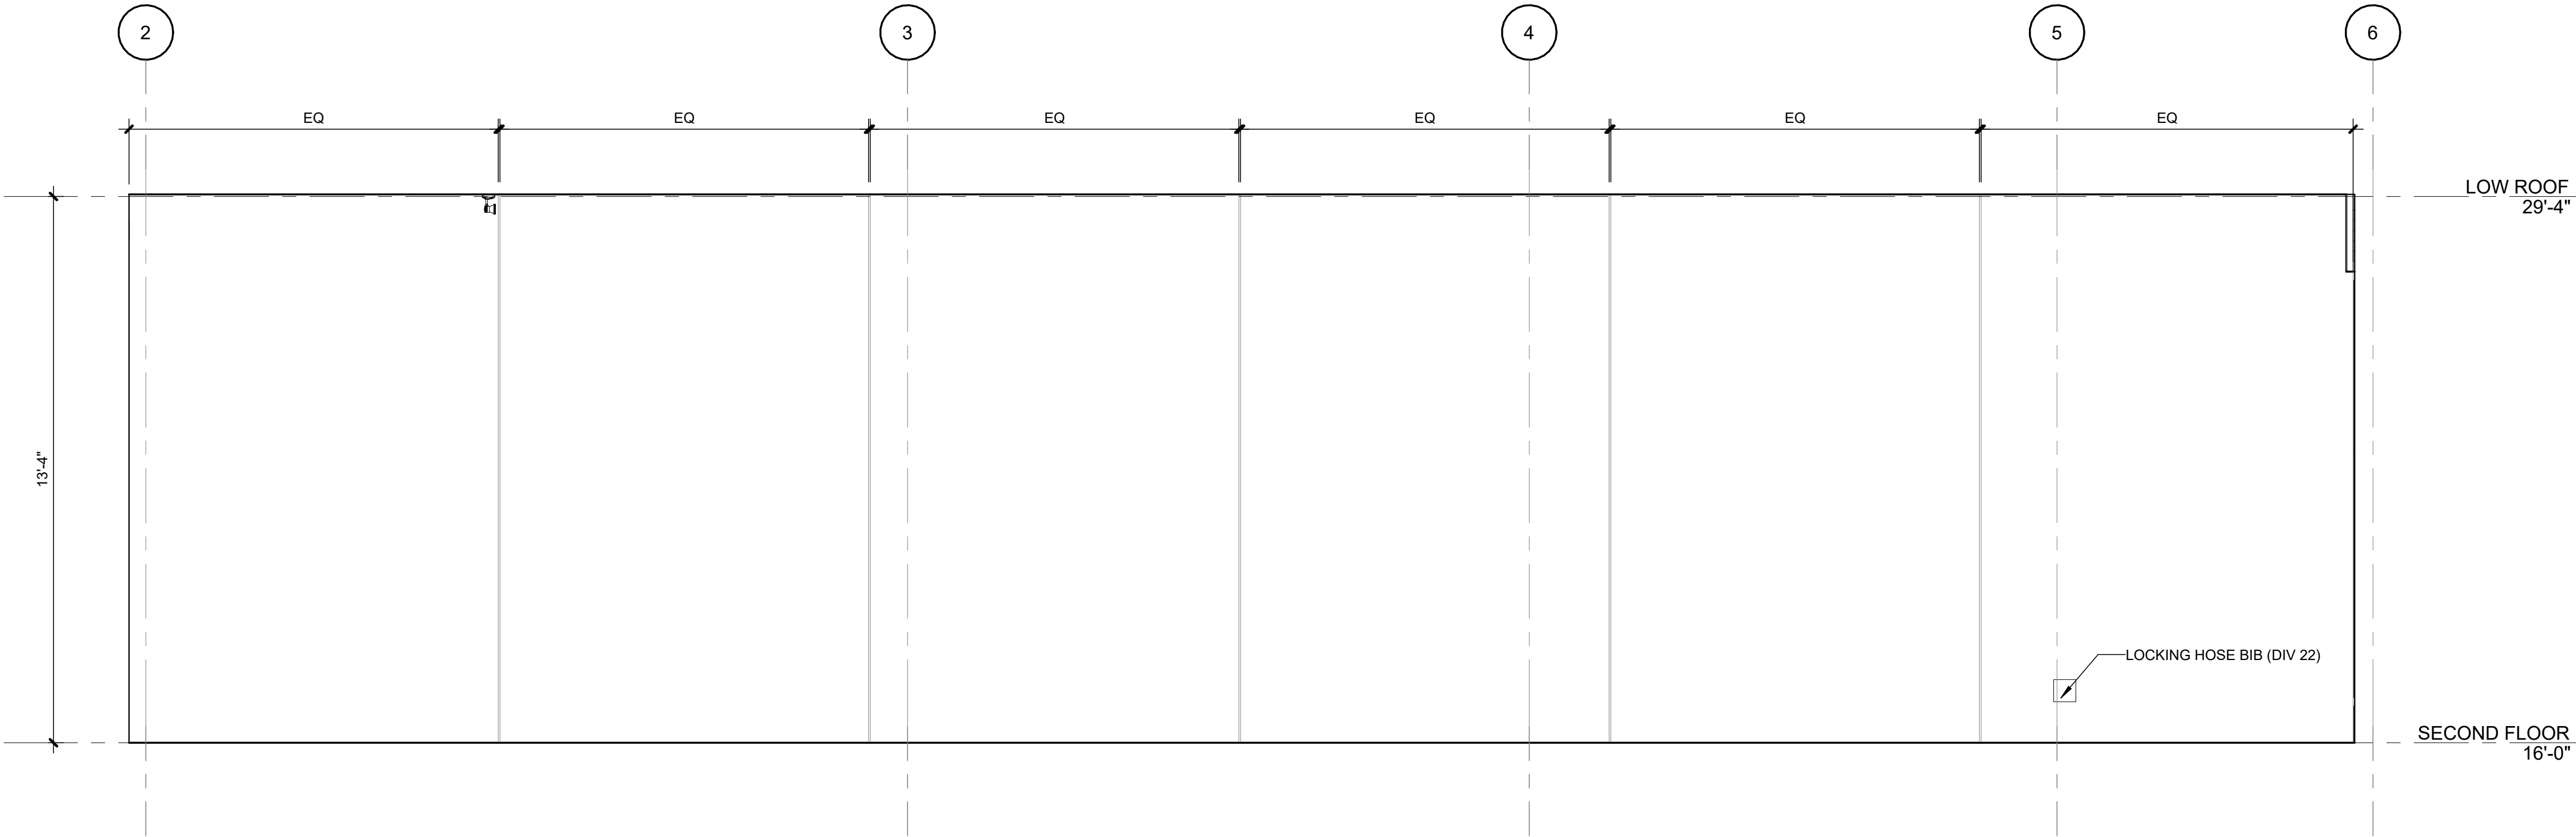

03 ENLARGED ELEVATION - MINIGOLF PLASTER WALL

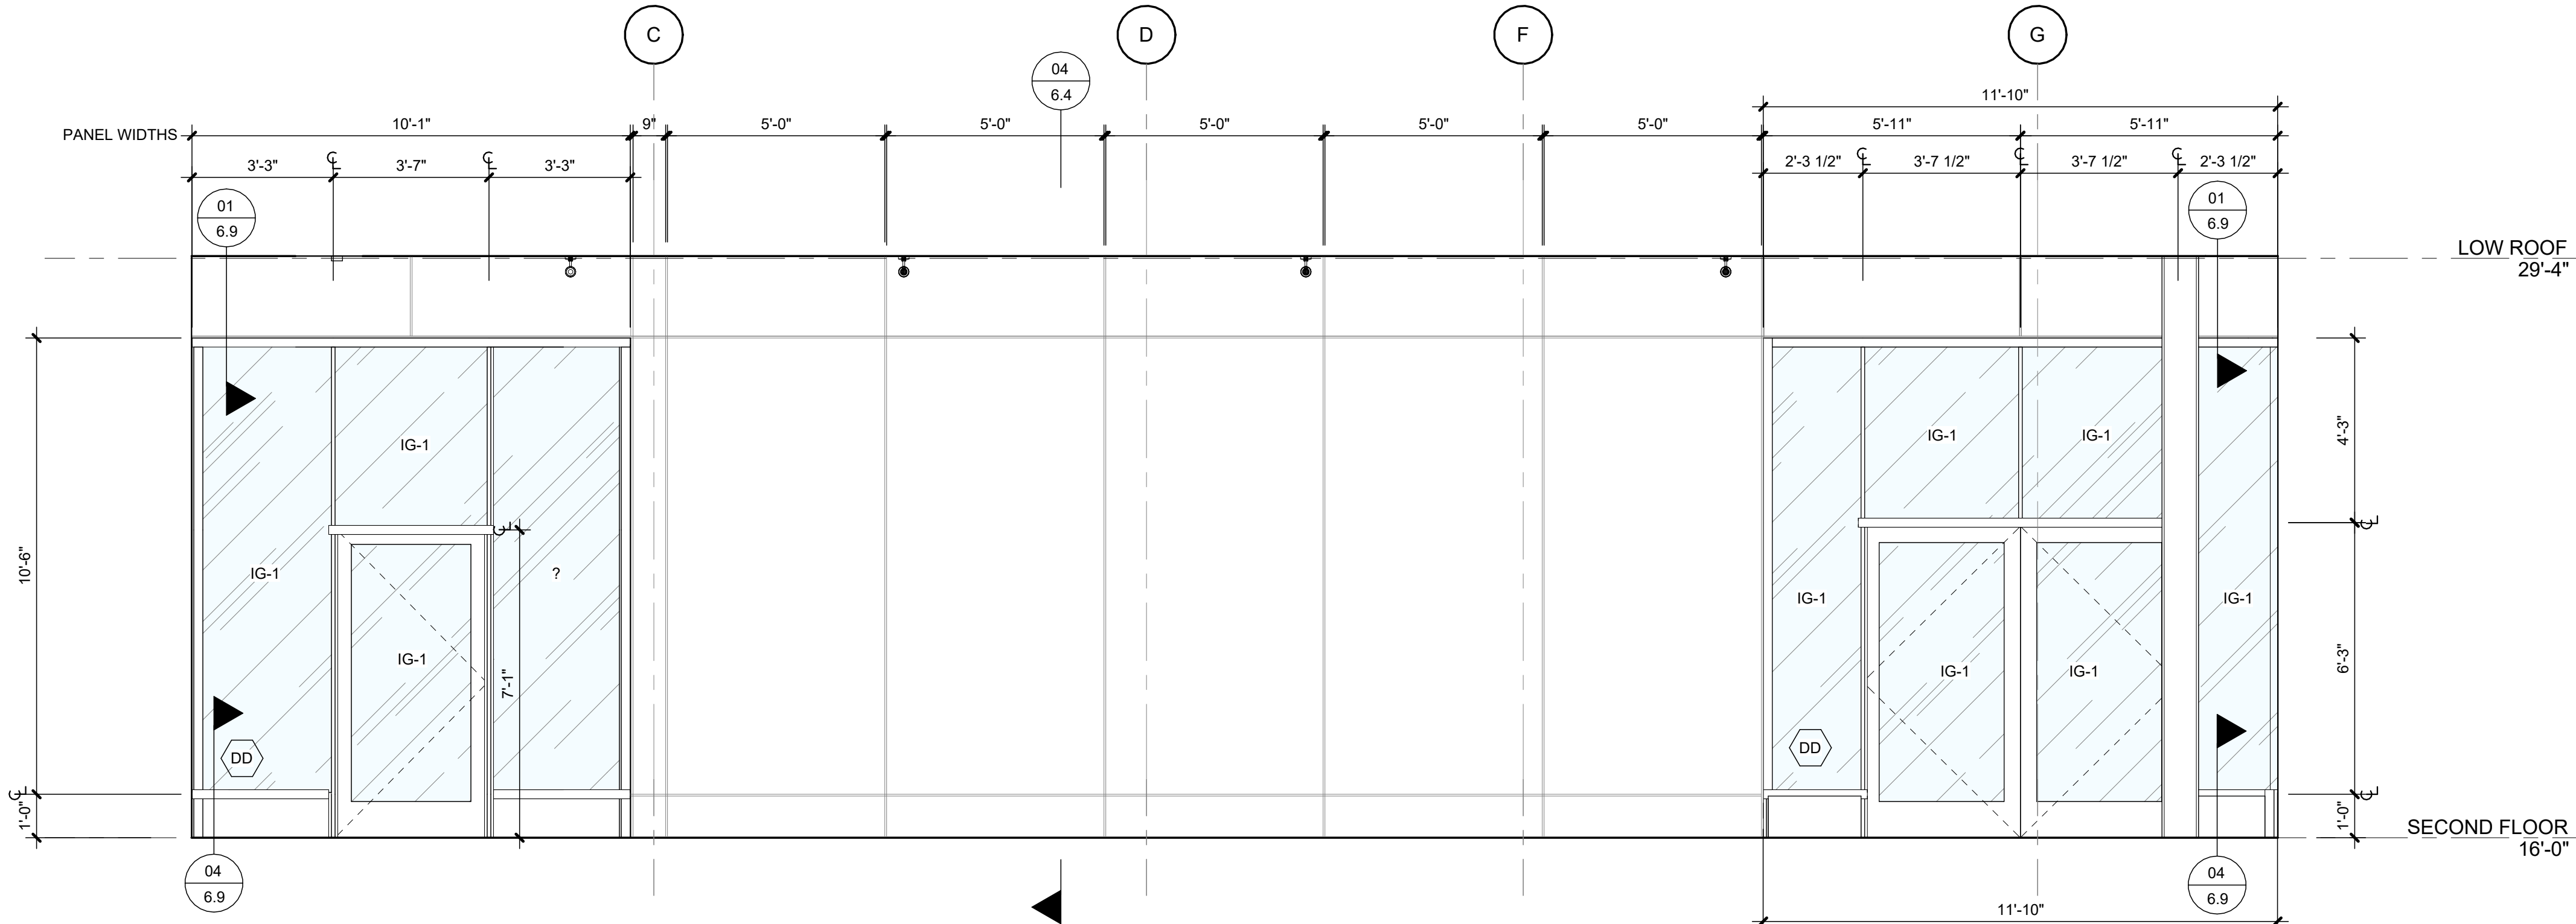

01 ENLARGED ELEVATION - MINI GOLF STOREFRONT

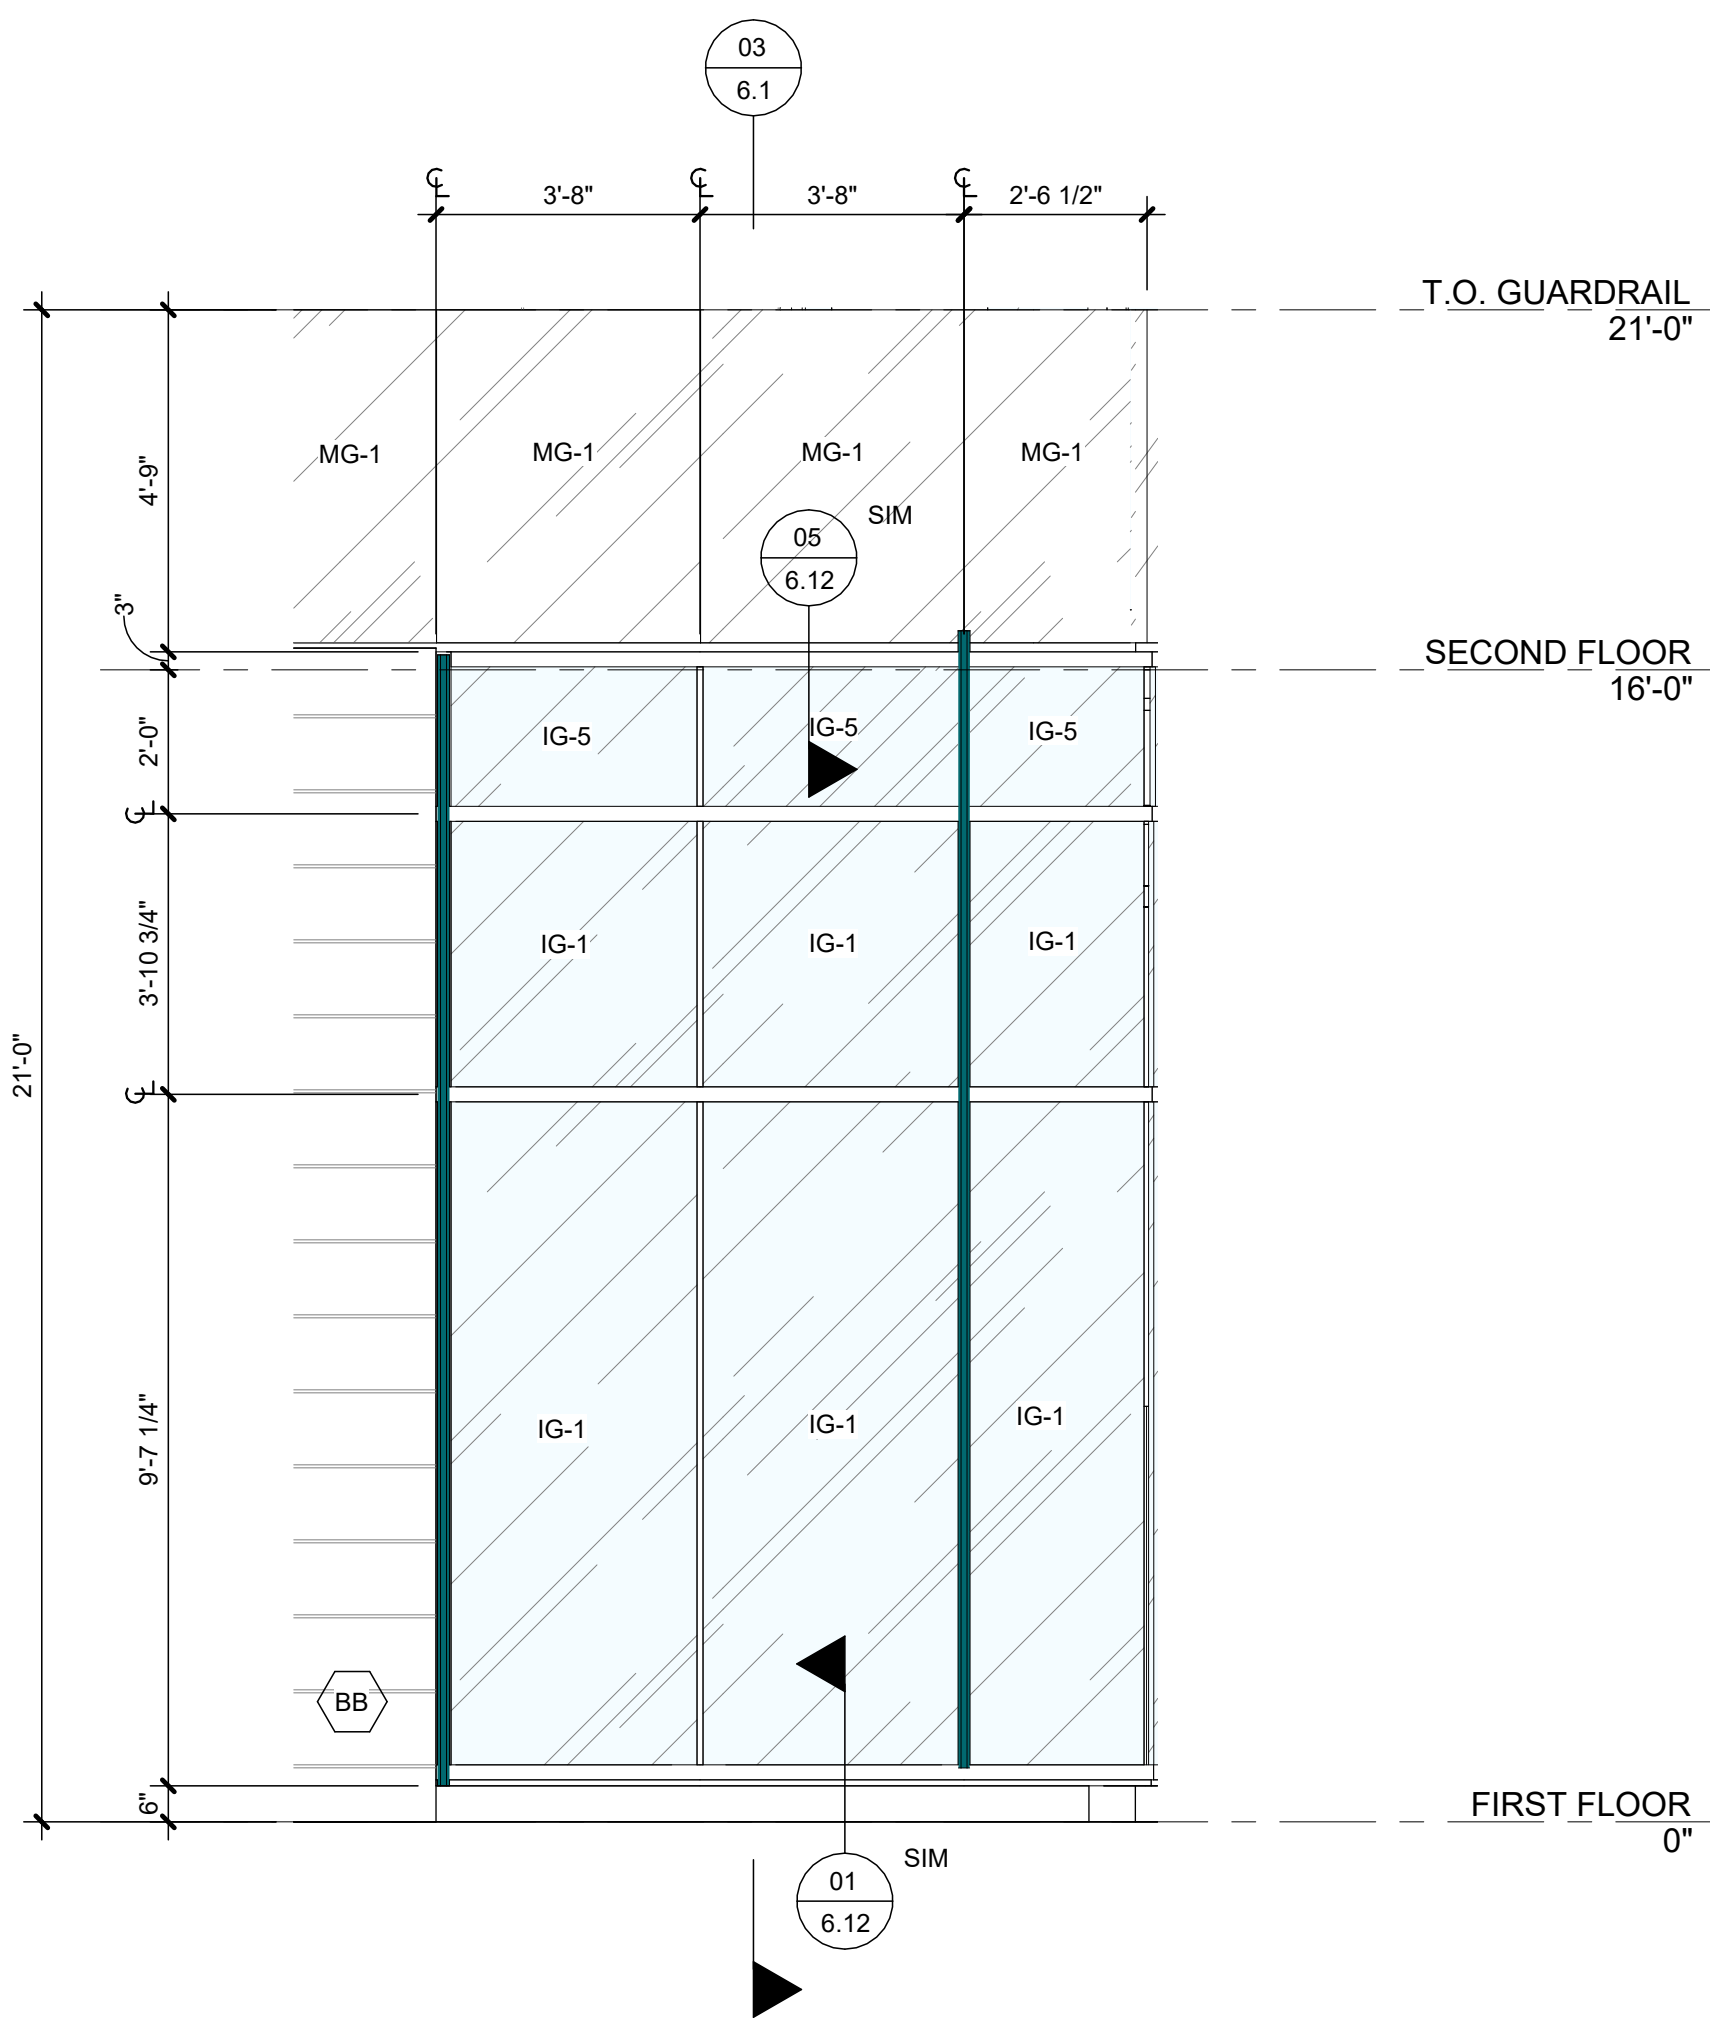

04 ENLARGED ELEVATION - SOUTH CURTAIN WALL

METAL PANEL FINISHES

REFER TO FINISH SCHEDULE FOR METAL PANEL FINISH

TYPE A < MTL-1 >

TYPE B < MTL-2 >

TYPE C < MTL-3 >

WALKER'S IMAGINARIUM

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NEW ORLEANS, LA 70118

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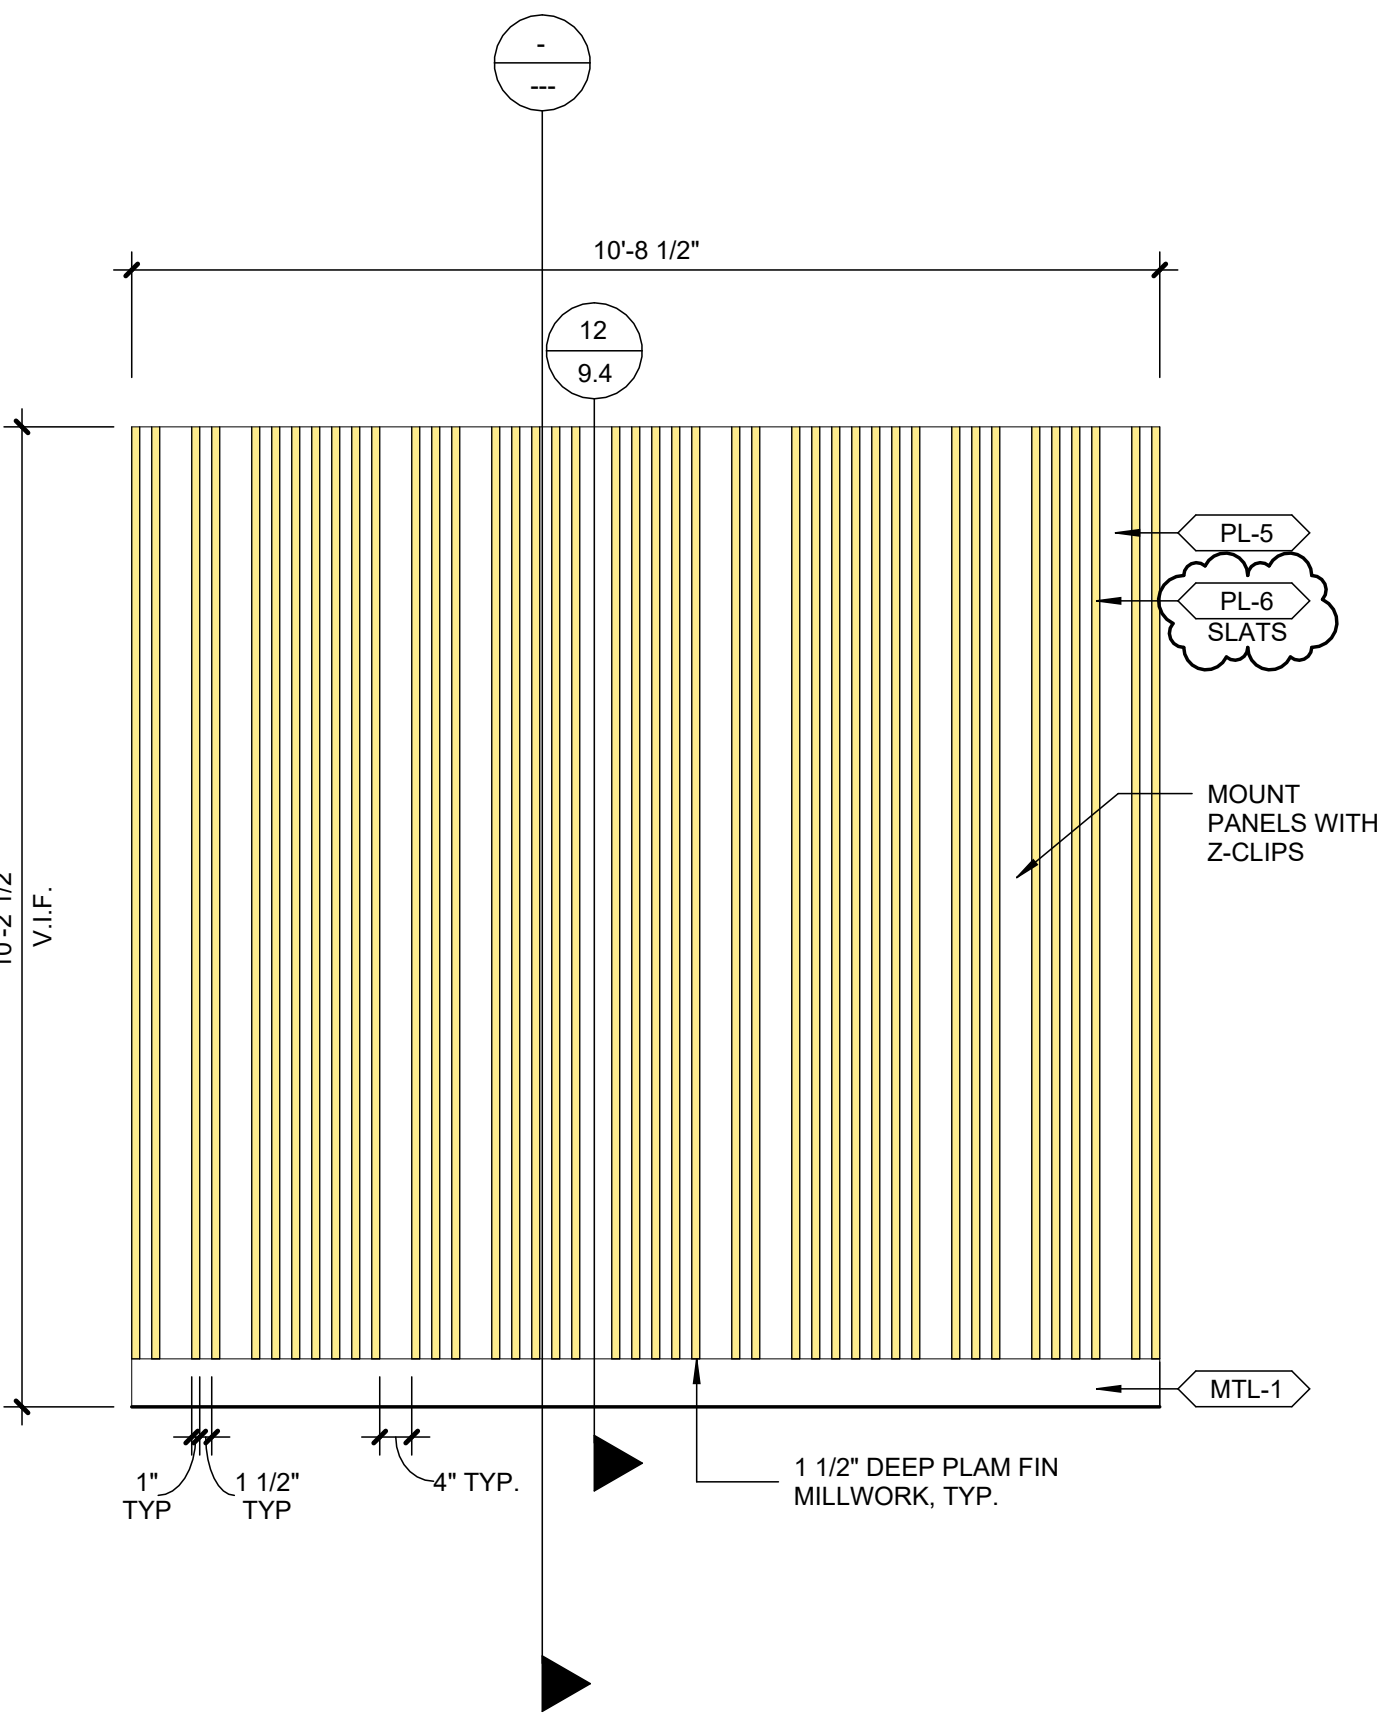
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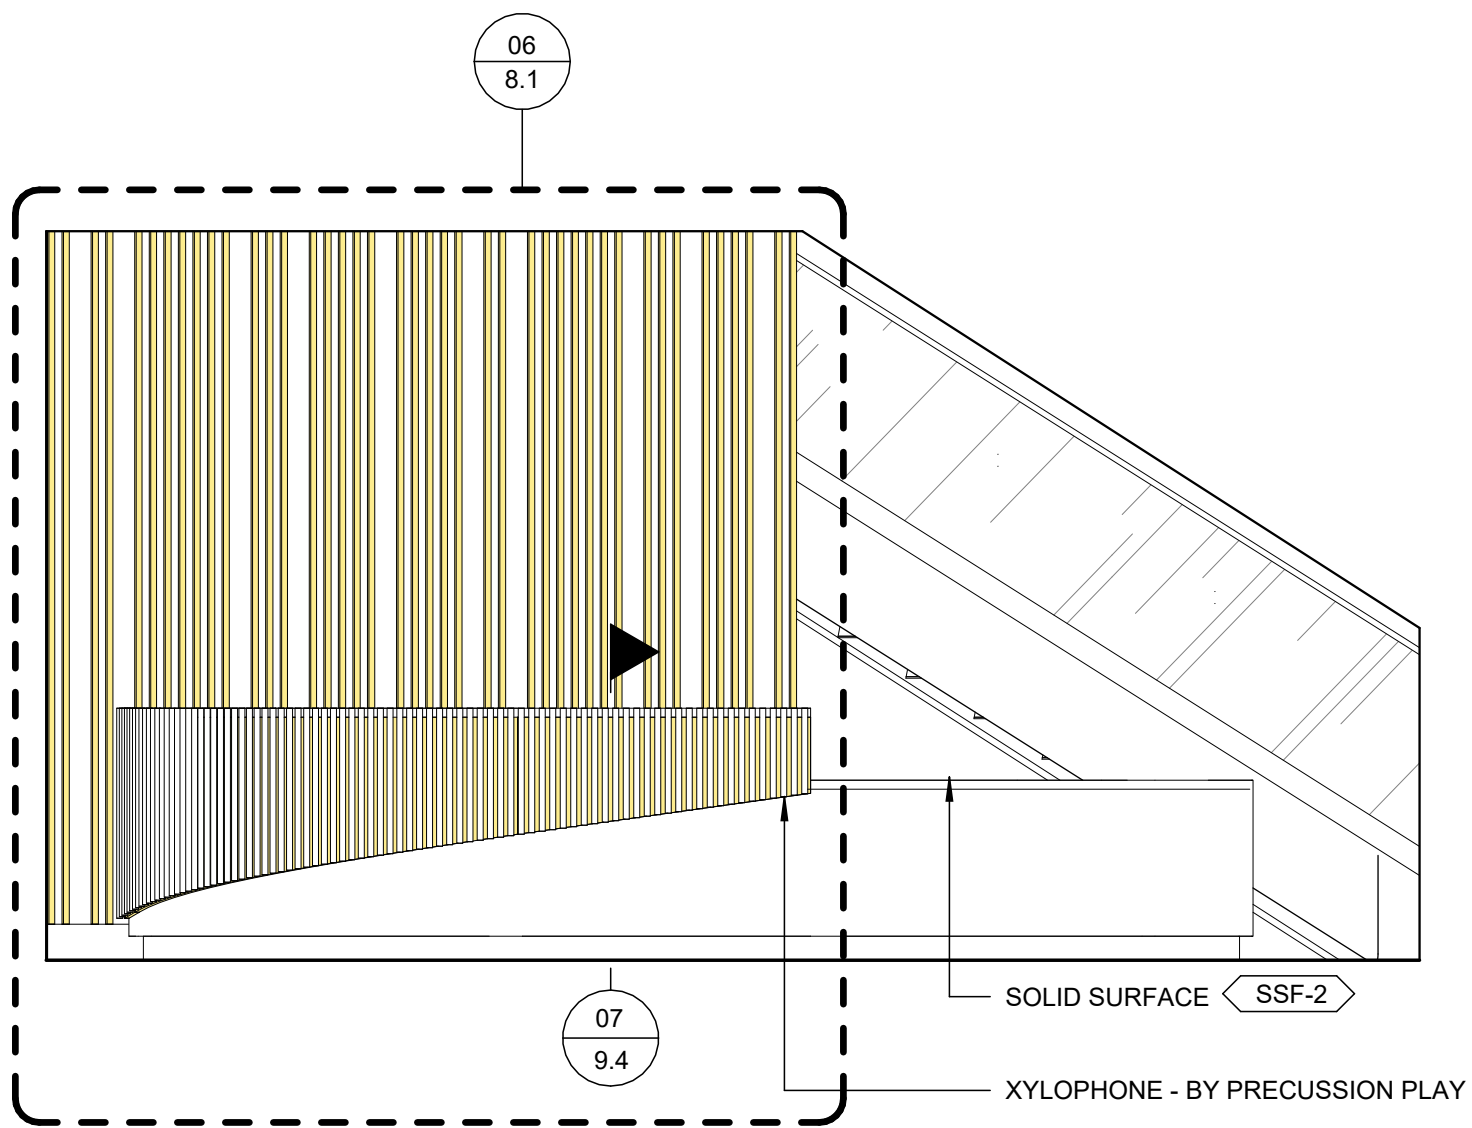
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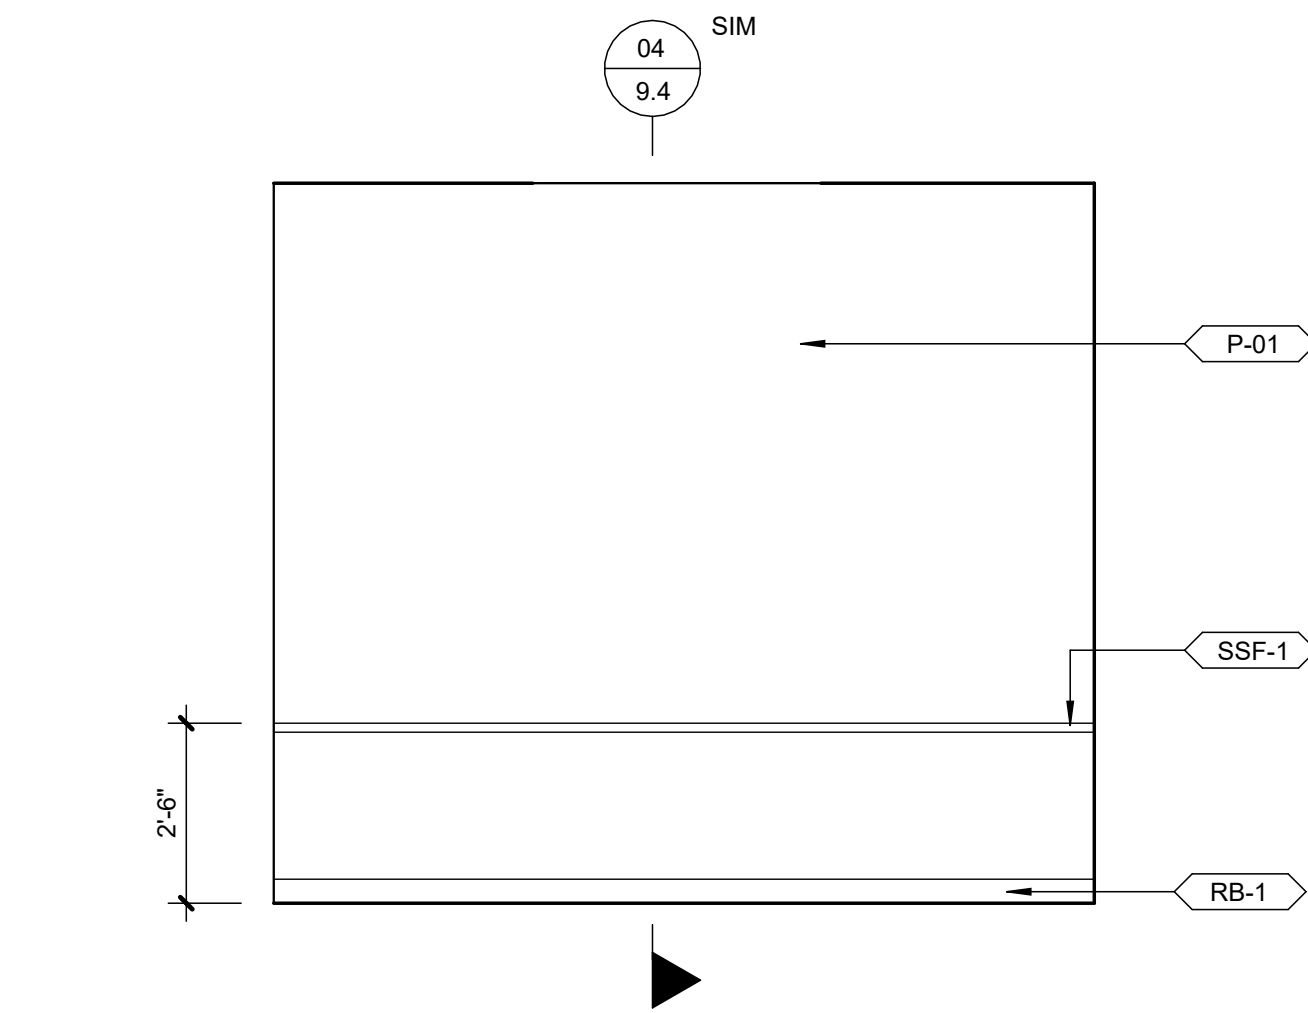
EXTERIOR CURTAIN WALL AND STOREFRONT




06 ENLARGED ELEVATION AT RECEPTION WALL
2.11 | 1/2" = 1'-0" |




05 NORTH-WEST ELEVATION
2.11 | 3/8" = 1'-0" | AT RECEPTION DESK





04 NORTH ELEVATION
2.10 | 3/8" = 1'-0" | AT REAR OFFICE

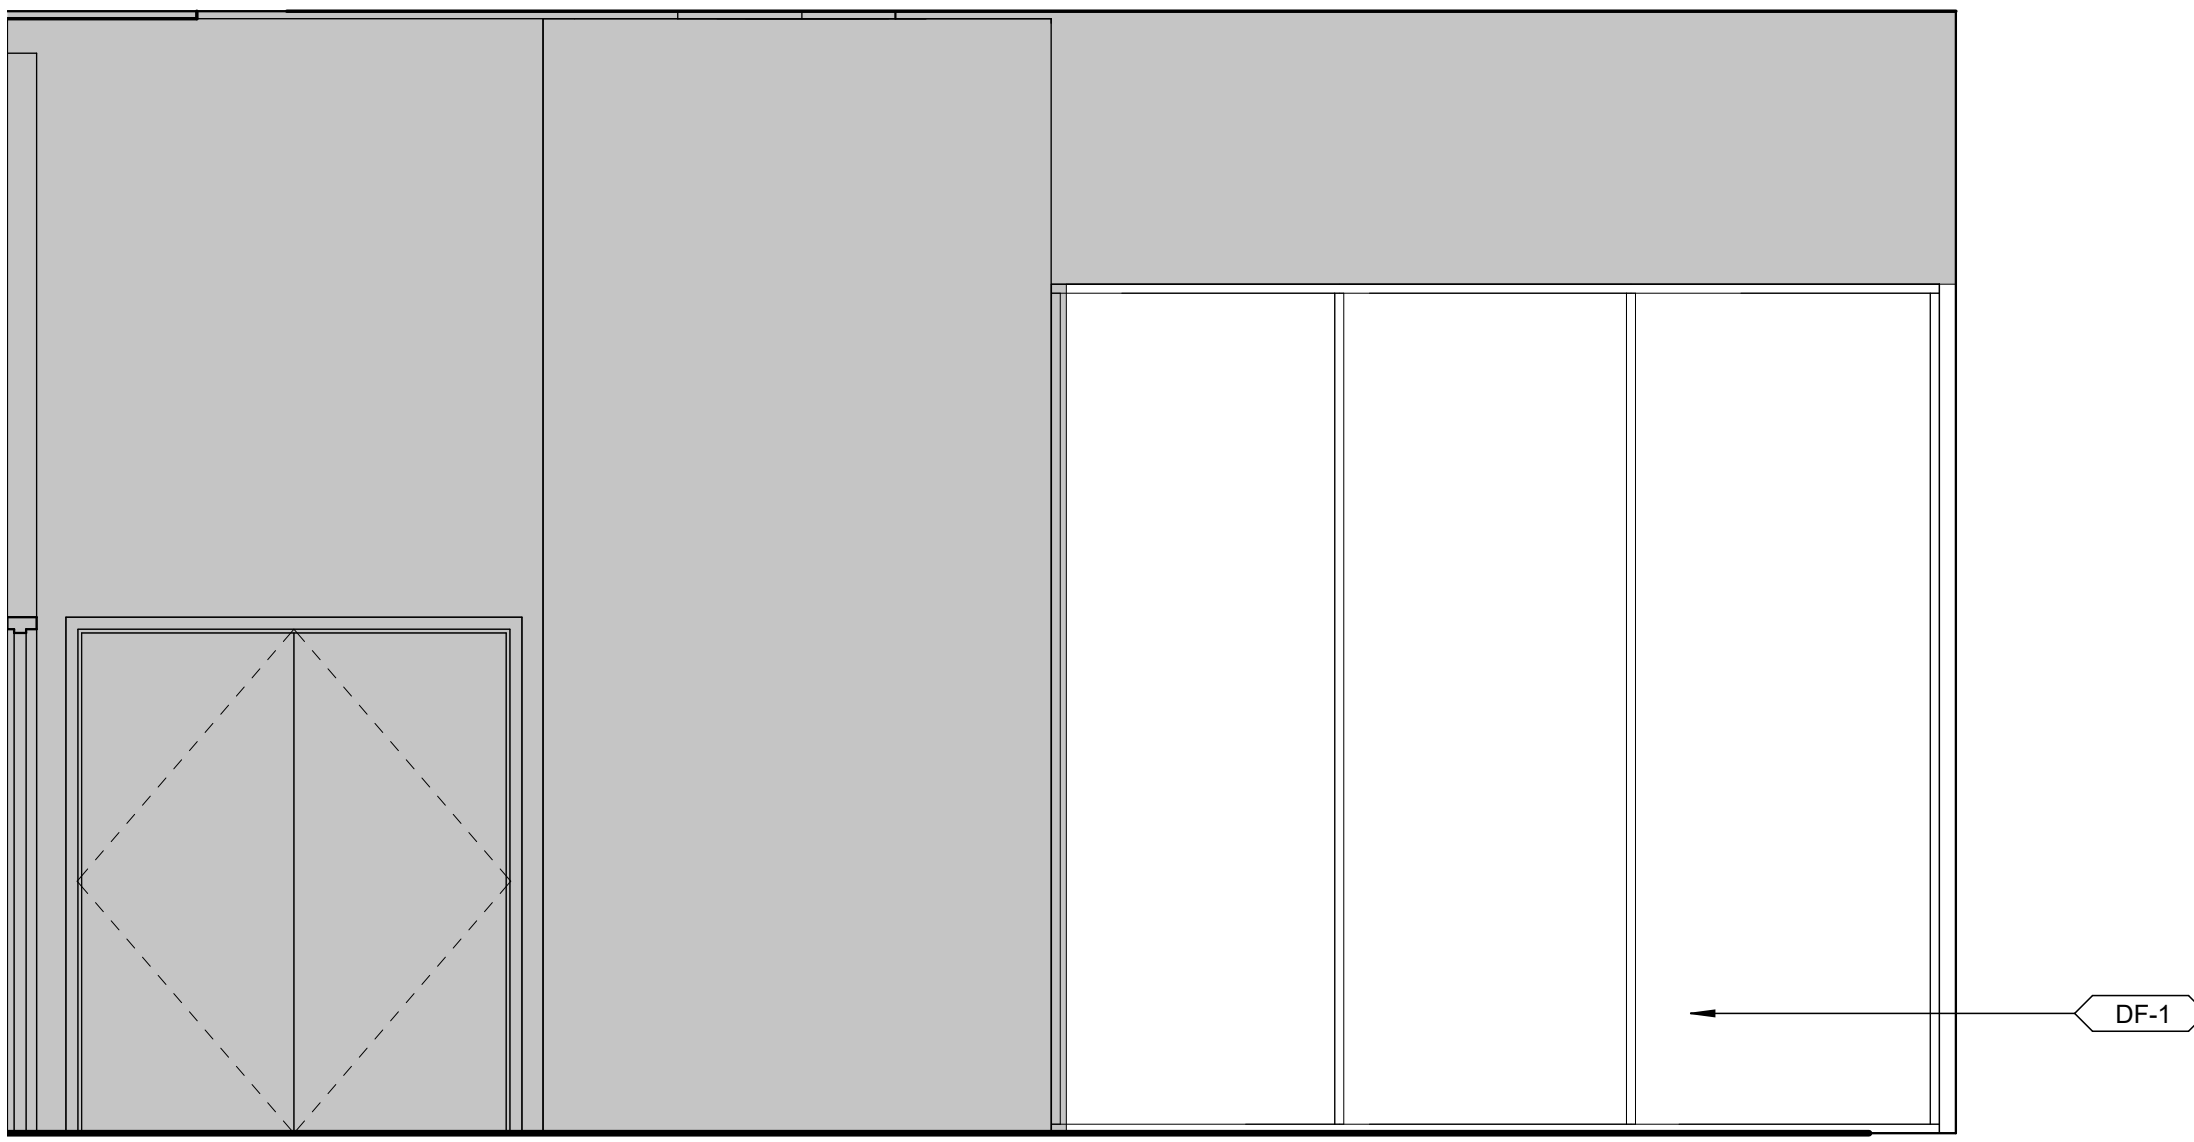

03 SOUTH ELEVATION
2.10 | 3/8" = 1'-0" | AT CHAPEL WINDOW

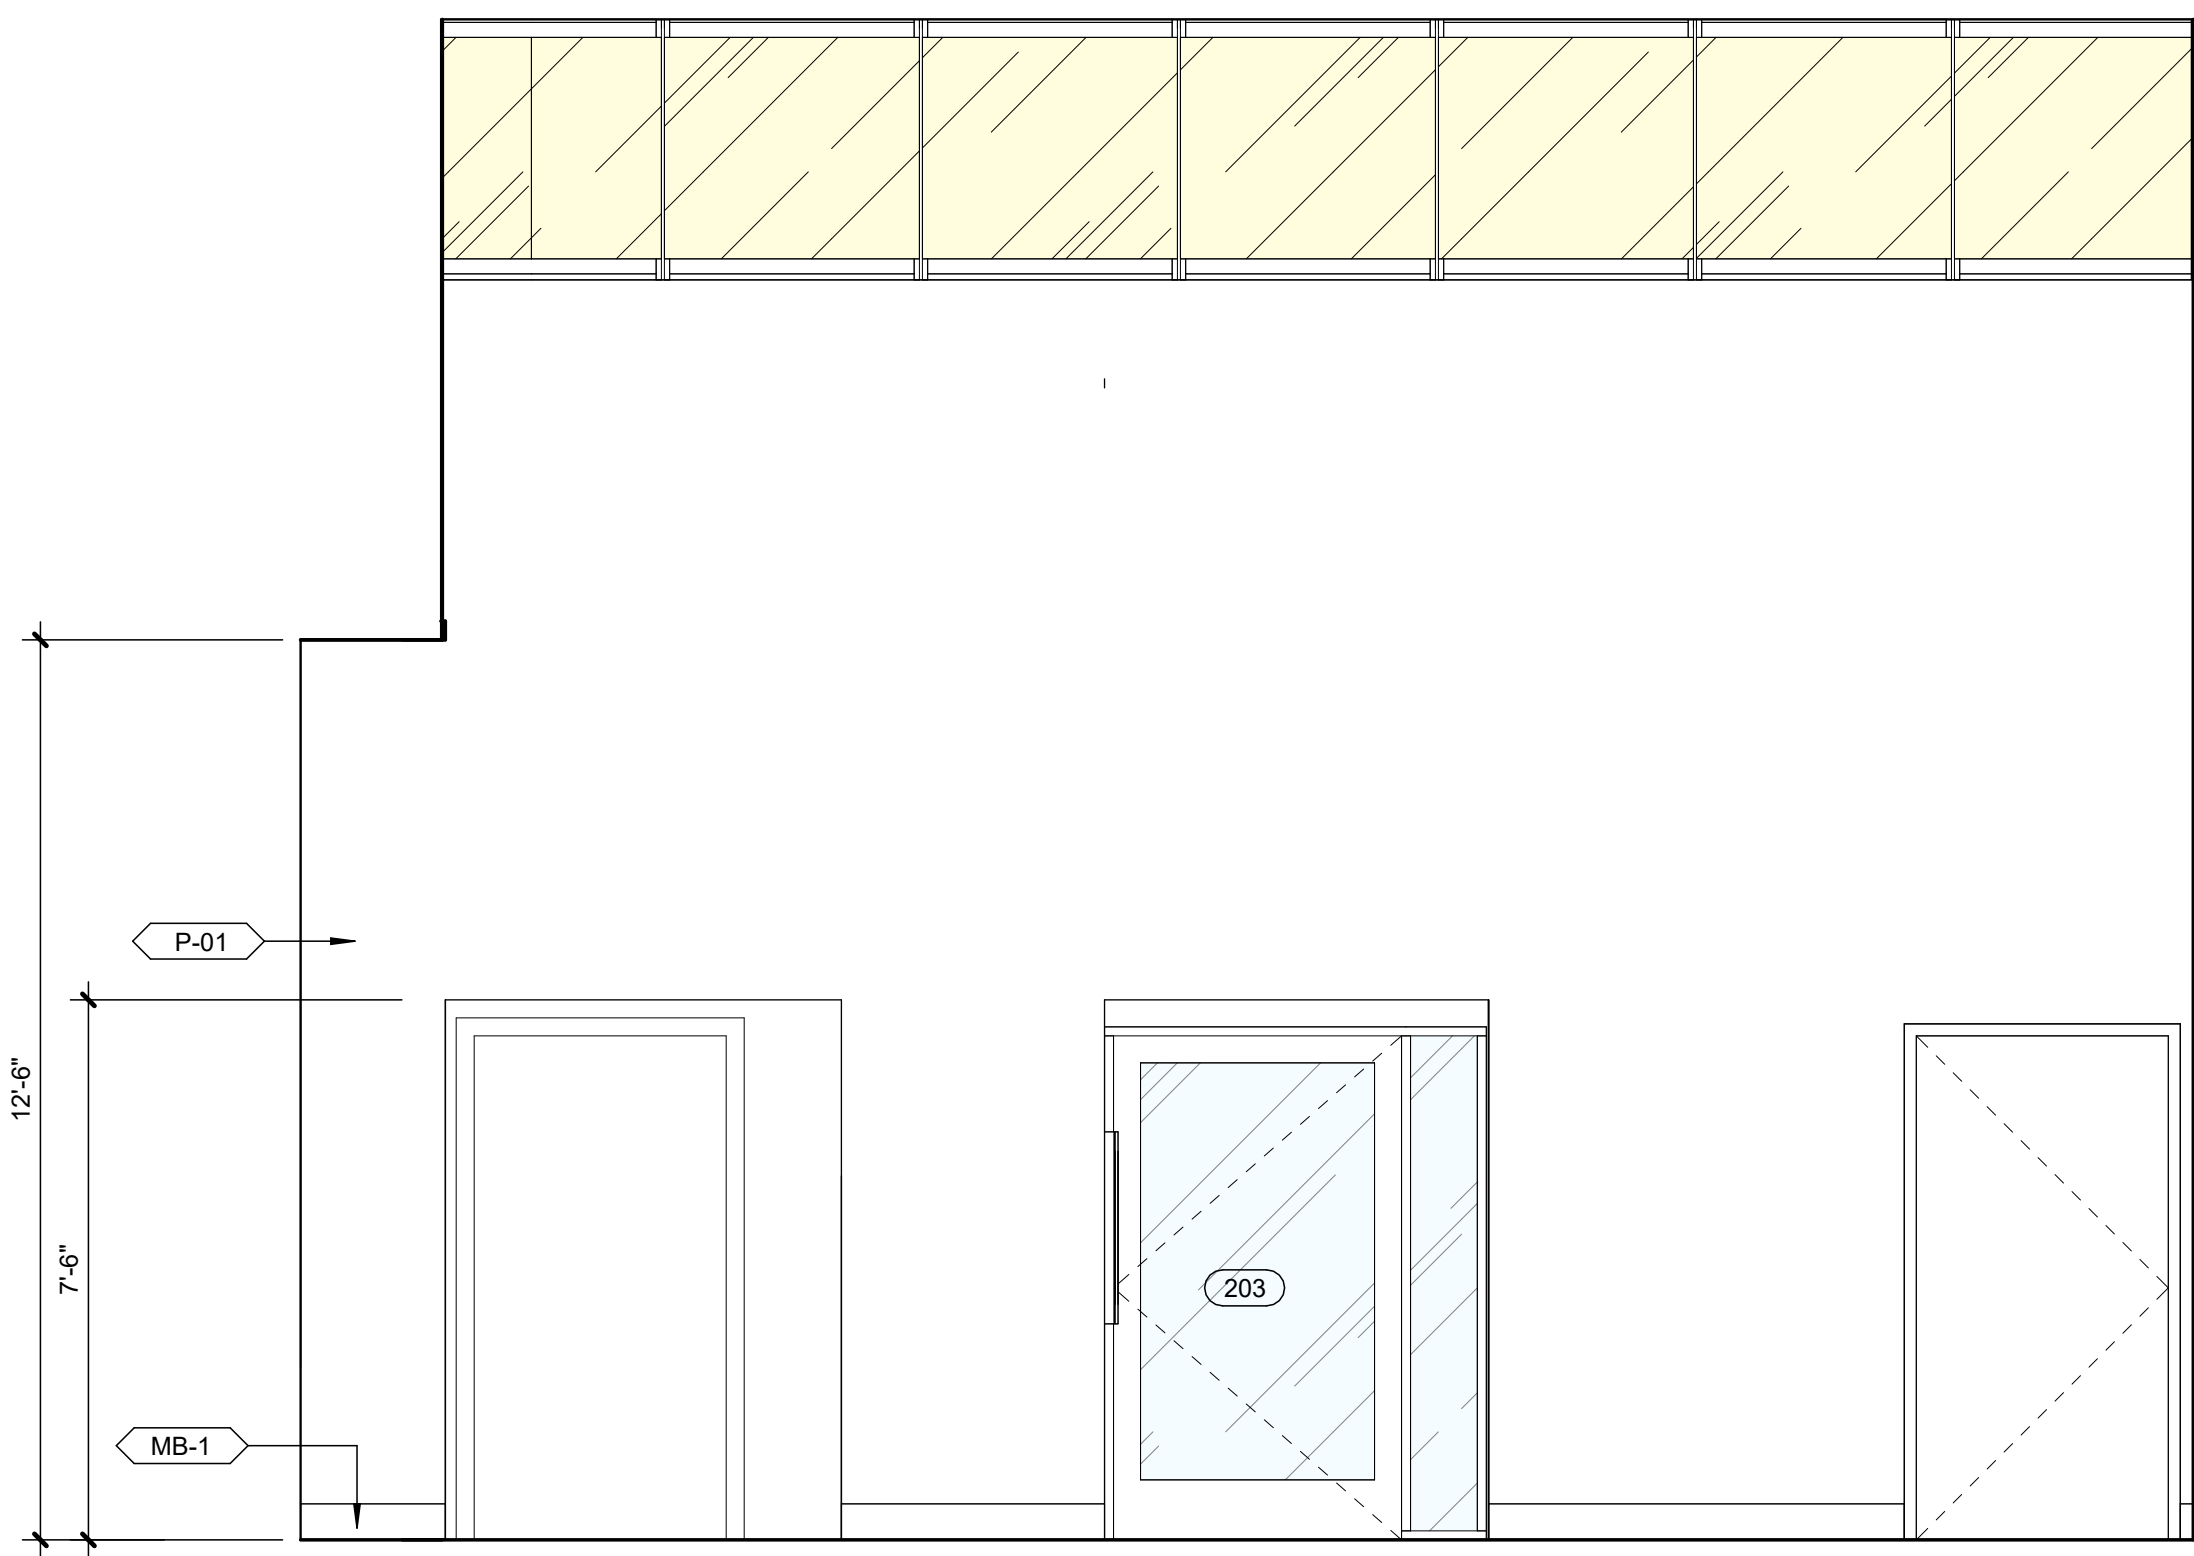

02 NORTH ELEVATION
2.11 | 3/8" = 1'-0" | AT ENTRY

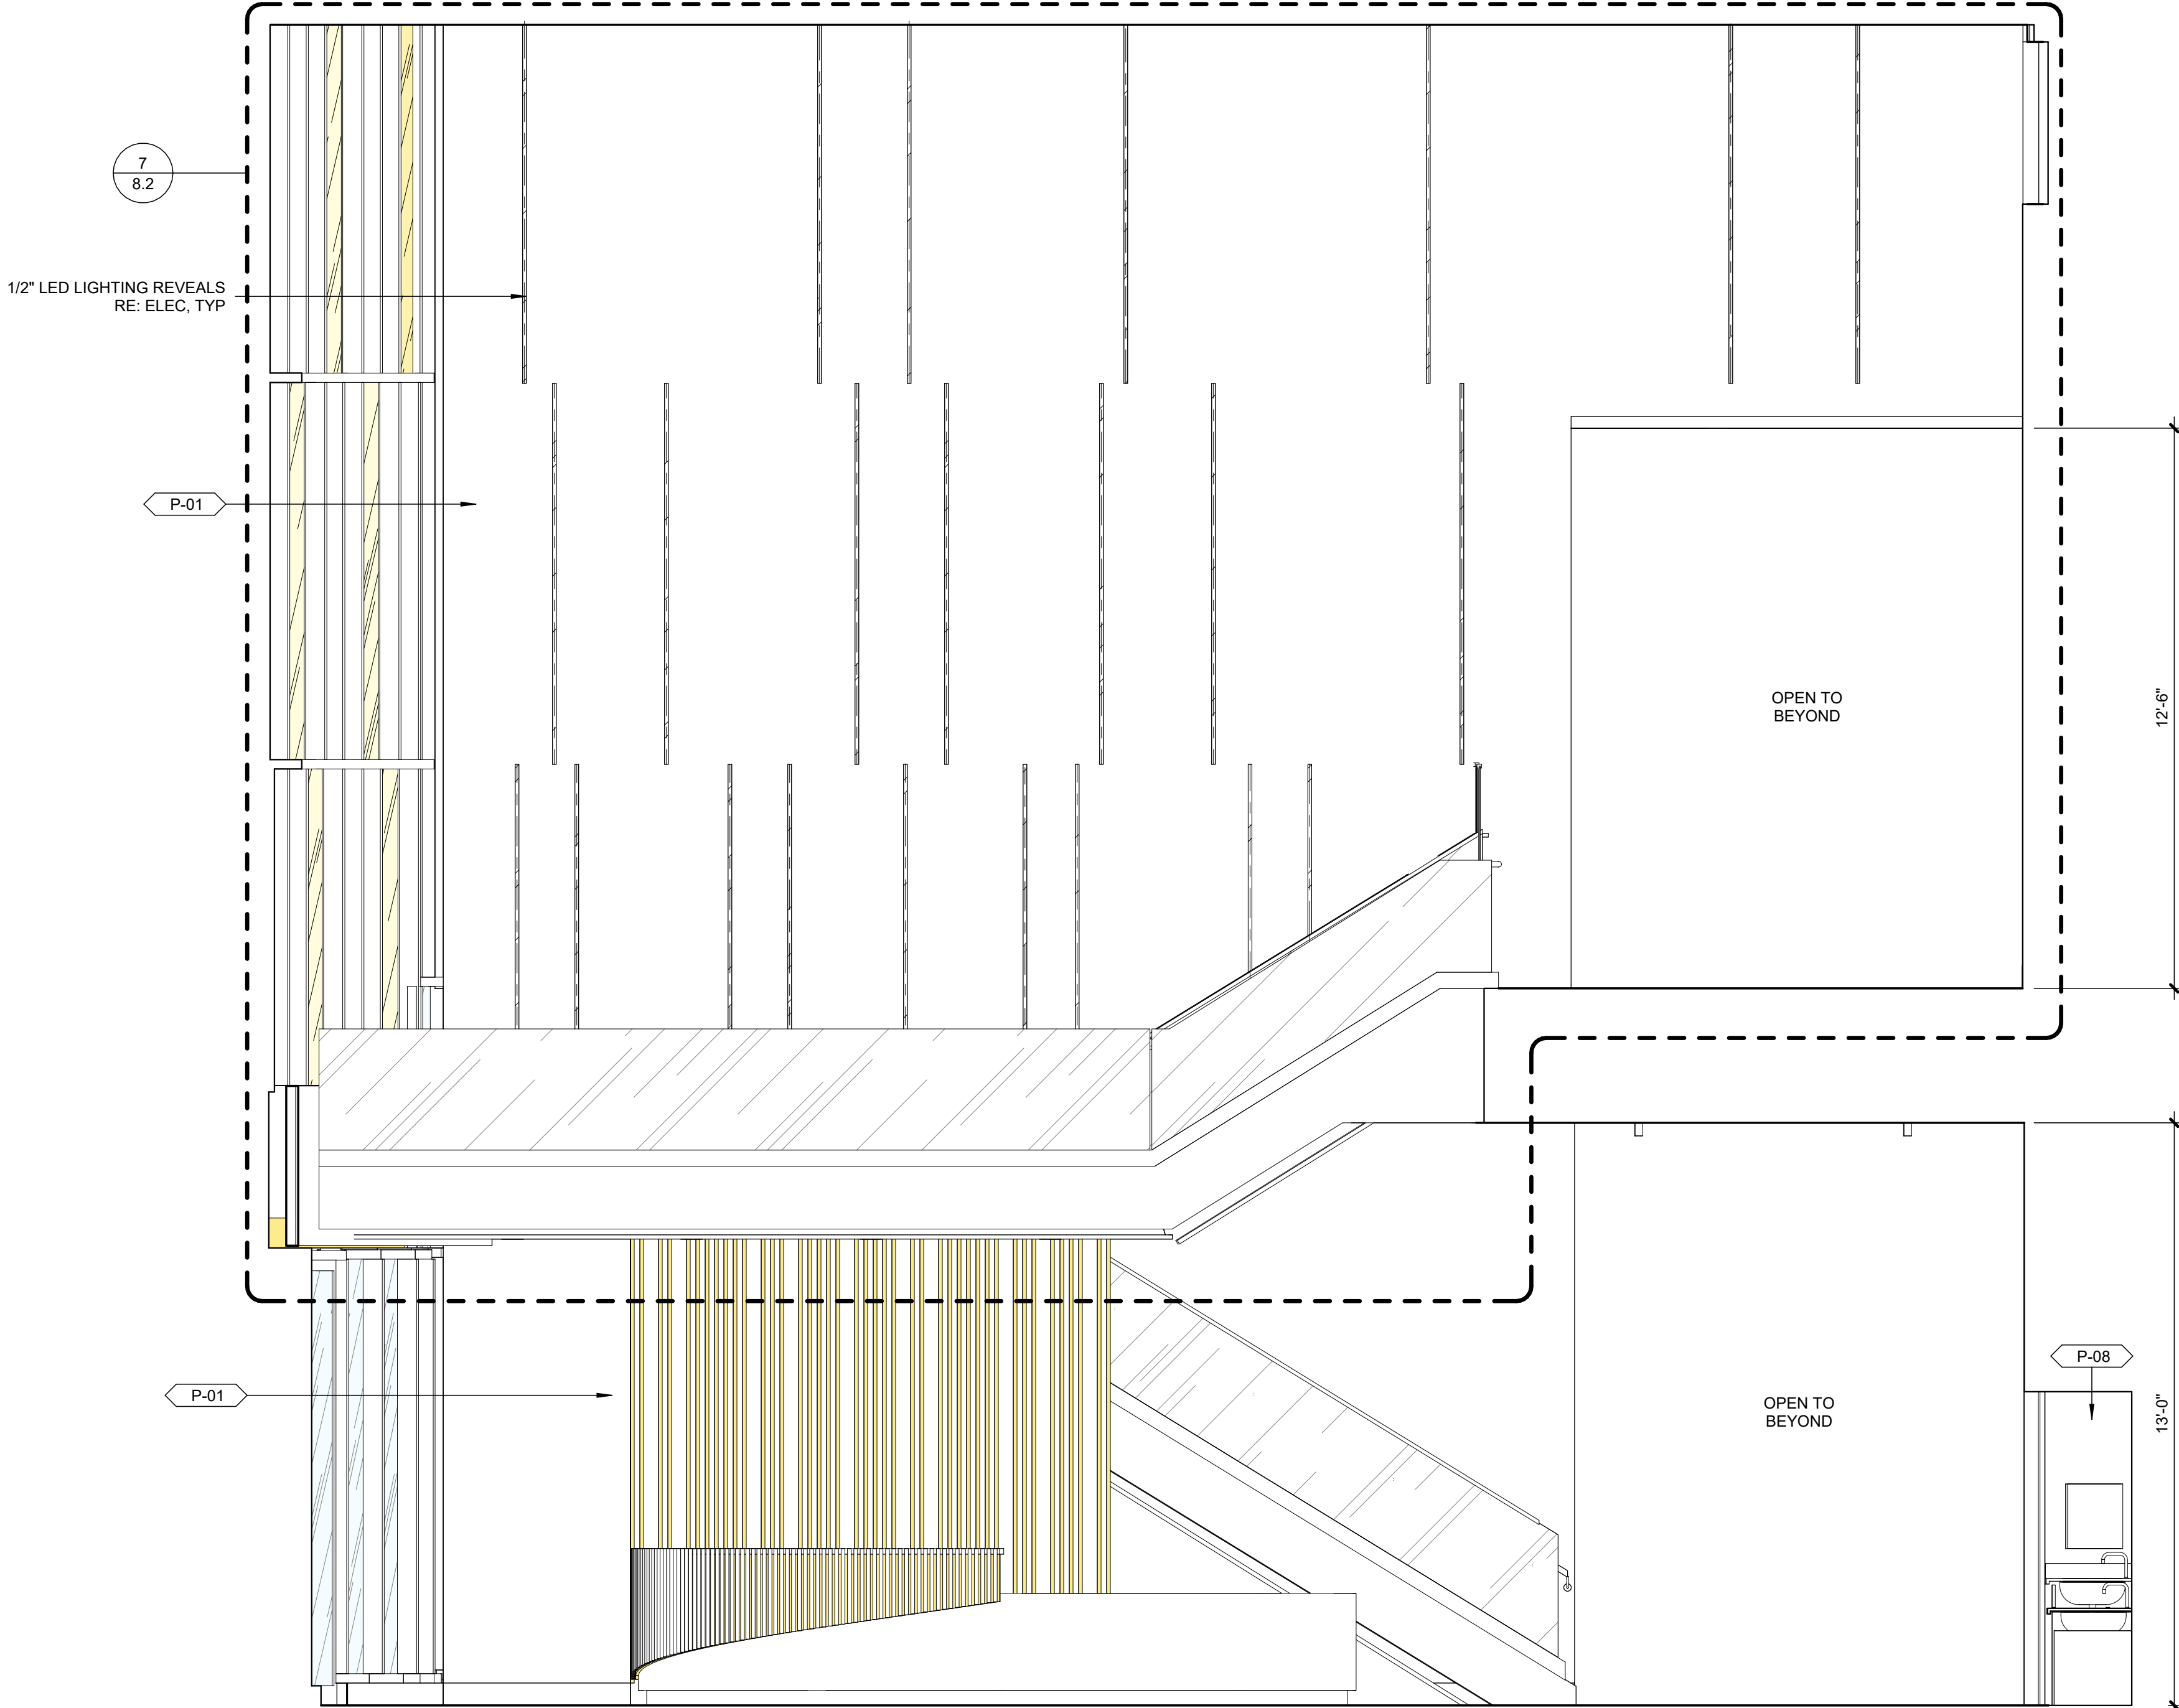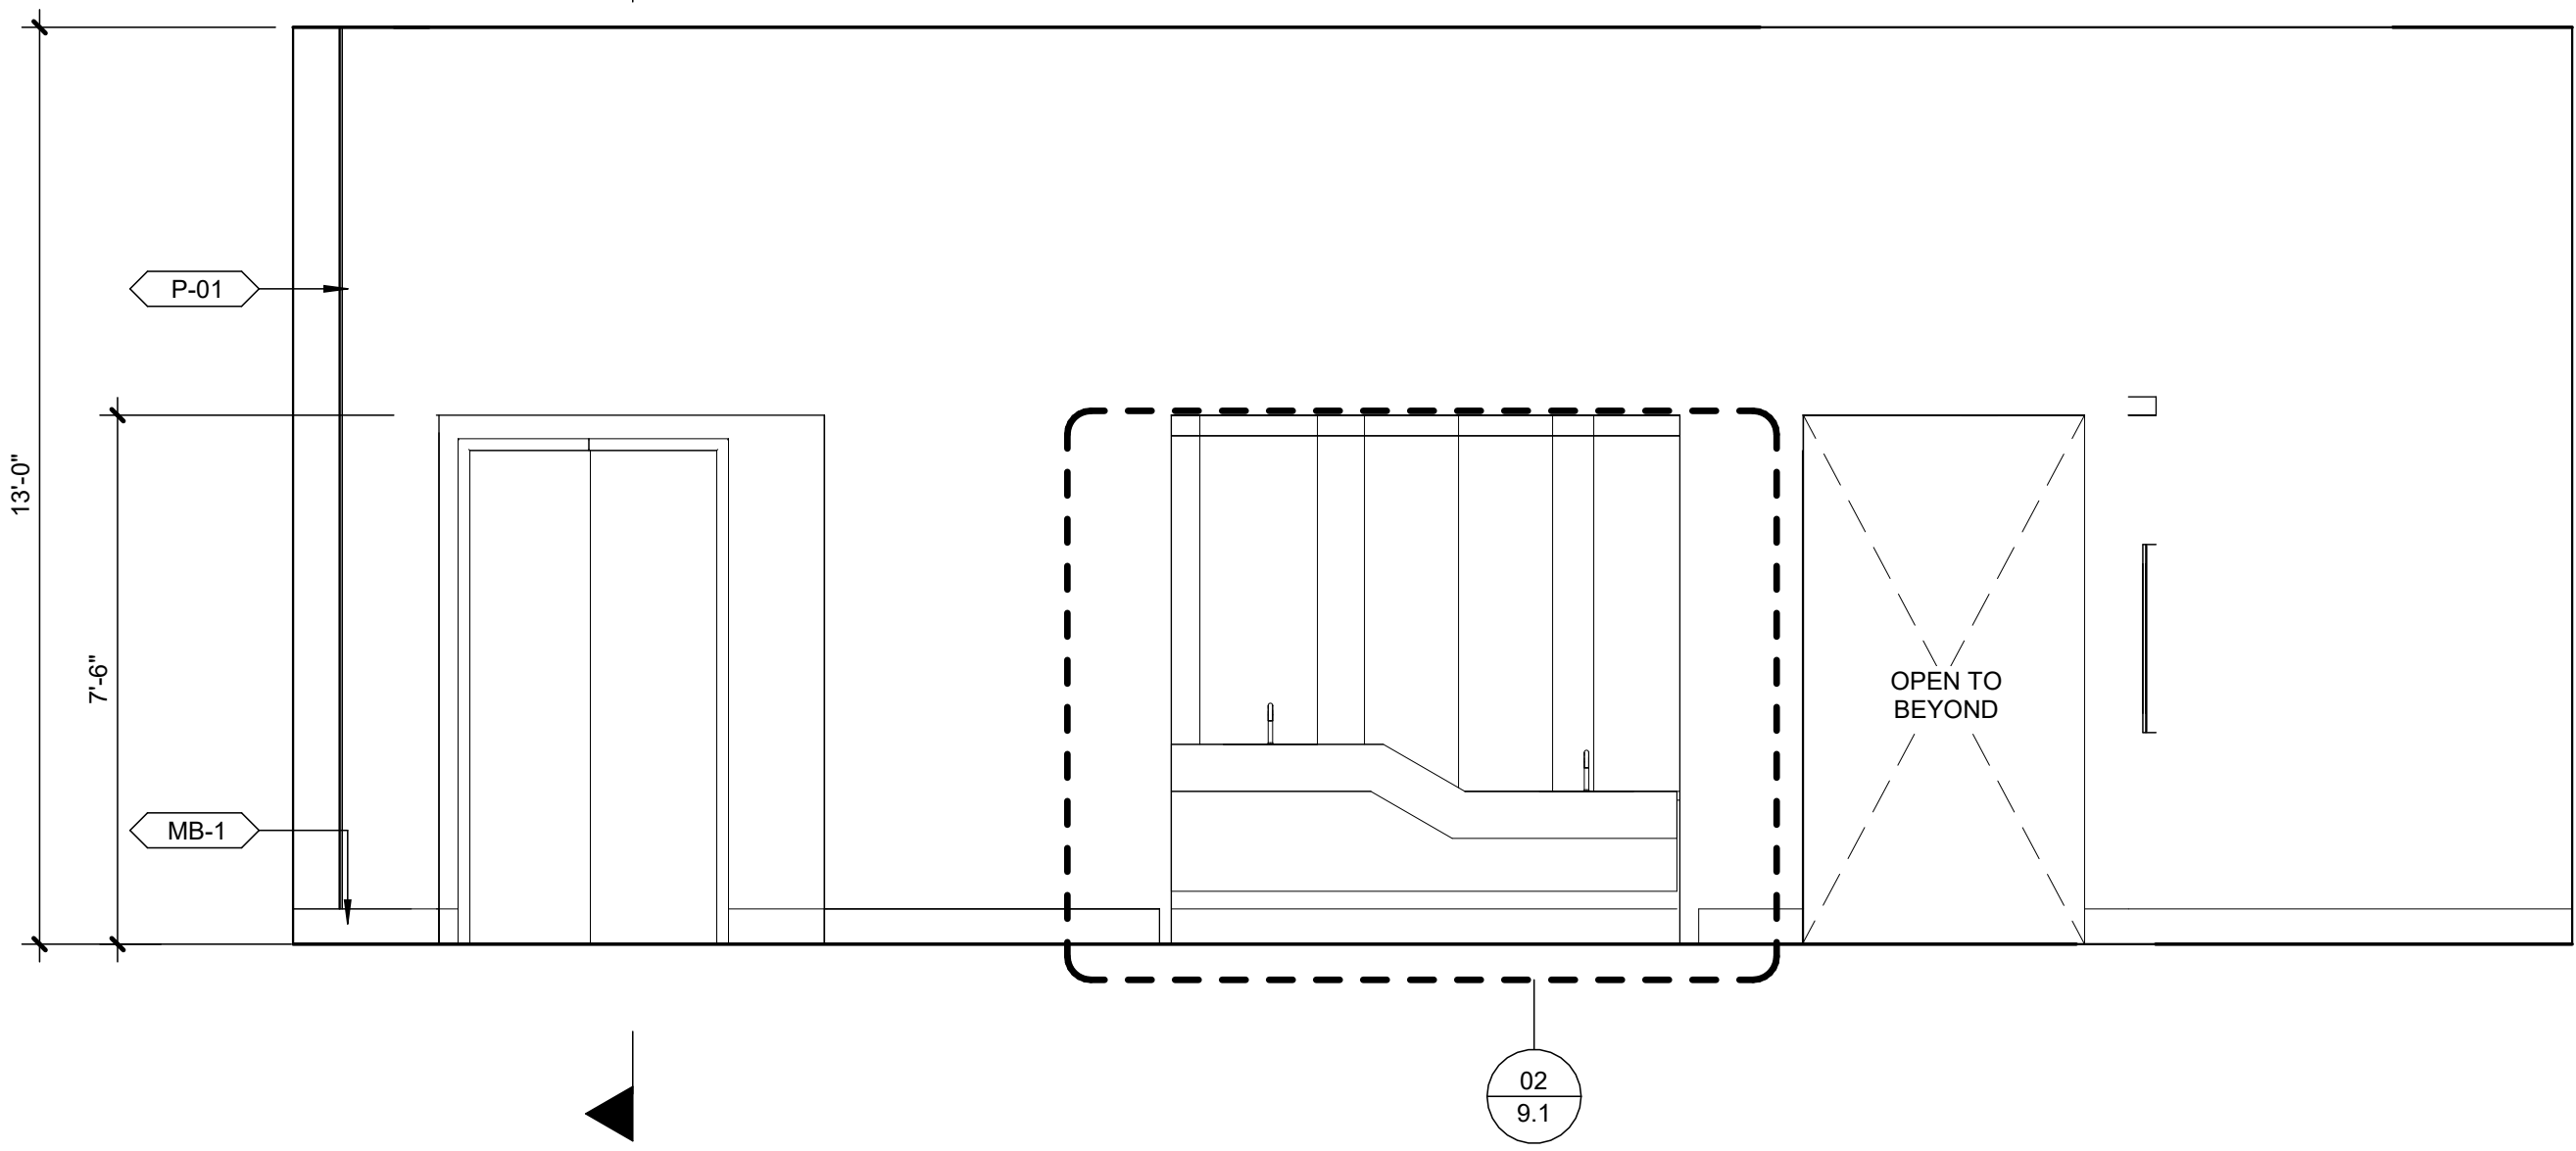

01 WEST ELEVATION
2.11 | 3/8" = 1'-0" | AT ENTRY

REFERENCE DESIGNATIONS FOR FINISH TYPES		
ACP-1	ACOUSTICAL CEILING PANEL	09 51 00
ACP-2	ACOUSTICAL CEILING PANEL	09 54 26
ACP-3	ACOUSTICAL CEILING PANEL	09 51 00
ACP-4	ACOUSTICAL CEILING PANEL	09 51 00
ACP-5	ACOUSTICAL CEILING PANEL	09 51 00
ACP-6	ACOUSTICAL CEILING PANEL	09 51 00
AP-1	ACRYLIC PANEL	09 30 00
AP-2	ACRYLIC PANEL	09 30 00
AP-3	ACRYLIC PANEL	09 30 00
CG-1	CORNER GUARD	10 26 00
CPT-1	CARPET TILE	09 68 13
DF-1	DECORATIVE FILM	08 87 00
FAB-1	UPHOLESTERY	08 87 00
MB-1	METAL BASE	05 70 00
MB-2	METAL BASE	05 70 00
MTL-1	METAL	07 42 13
MTL-2	METAL	07 42 13
MTL-3	METAL	07 42 13
P-01	PAINT	09 91 00
P-02	PAINT	09 91 00
P-04	PAINT	09 91 00
P-05	PAINT	09 91 00
P-06	PAINT	09 91 00
P-07	PAINT	09 91 00
P-08	PAINT	09 91 00
P-09	PAINT	09 91 00
P-10	PAINT	09 91 00
P-14	PAINT	09 91 00
P-15	PAINT	09 91 00
P-18	PAINT	09 91 00
P-19	PAINT	09 91 00
PL-1	PLASTIC LAMINATE	06 40 00
PL-2	PLASTIC LAMINATE	06 40 00
PL-3	PLASTIC LAMINATE	06 40 00
PL-4	PLASTIC LAMINATE	06 40 00
PL-5	PLASTIC LAMINATE	06 40 00
PL-6	PLASTIC LAMINATE	06 40 00
PL-7	PLASTIC LAMINATE	06 40 00
PL-8	PLASTIC LAMINATE	06 40 00
RB-1	RESILIENT BASE	09 65 13
RB-2	RESILIENT BASE	09 65 13
RF-01	RESILIENT FLOORING	09 65 00
RF-02	RESILIENT FLOORING	09 65 00
RF-03	RESILIENT FLOORING	09 65 00
RF-04	RESILIENT FLOORING	09 65 00
RF-06	RESILIENT FLOORING	09 65 00
RF-07	RESILIENT FLOORING	09 65 00
RF-08	RESILIENT FLOORING	09 65 00
RF-09	RESILIENT FLOORING	09 65 00
RF-10	RESILIENT FLOORING	09 65 00
RF-11	RESILIENT FLOORING	09 65 00
RF-12	RESILIENT FLOORING	09 65 00
RF-14	RESILIENT FLOORING	09 65 00
RF-15	RESILIENT FLOORING	09 65 00
RF-16	RESILIENT FLOORING	09 65 00
SC-1	SEALED CONCRETE	03 35 11
SF-1	SPECIAL FINISH	09 51 26
SSF-1	SOLID SURFACE	12 36 61
SSF-2	SOLID SURFACE	12 36 61
TZT-1	TERRAZZO TILE	09 66 16
WC-1	WALL COVERING	09 72 00
WOM-1	SURFACE LAID ENTRANCE MAT	12 48 16

WALKER'S IMAGINARIUM

200 HENRY CLAY AVENUE
NEW ORLEANS, LA 70118

EDR PROJECT NO. | 22003

PROJECT ISSUE DATE | 02 DECEMBER 2024


Conformed Set

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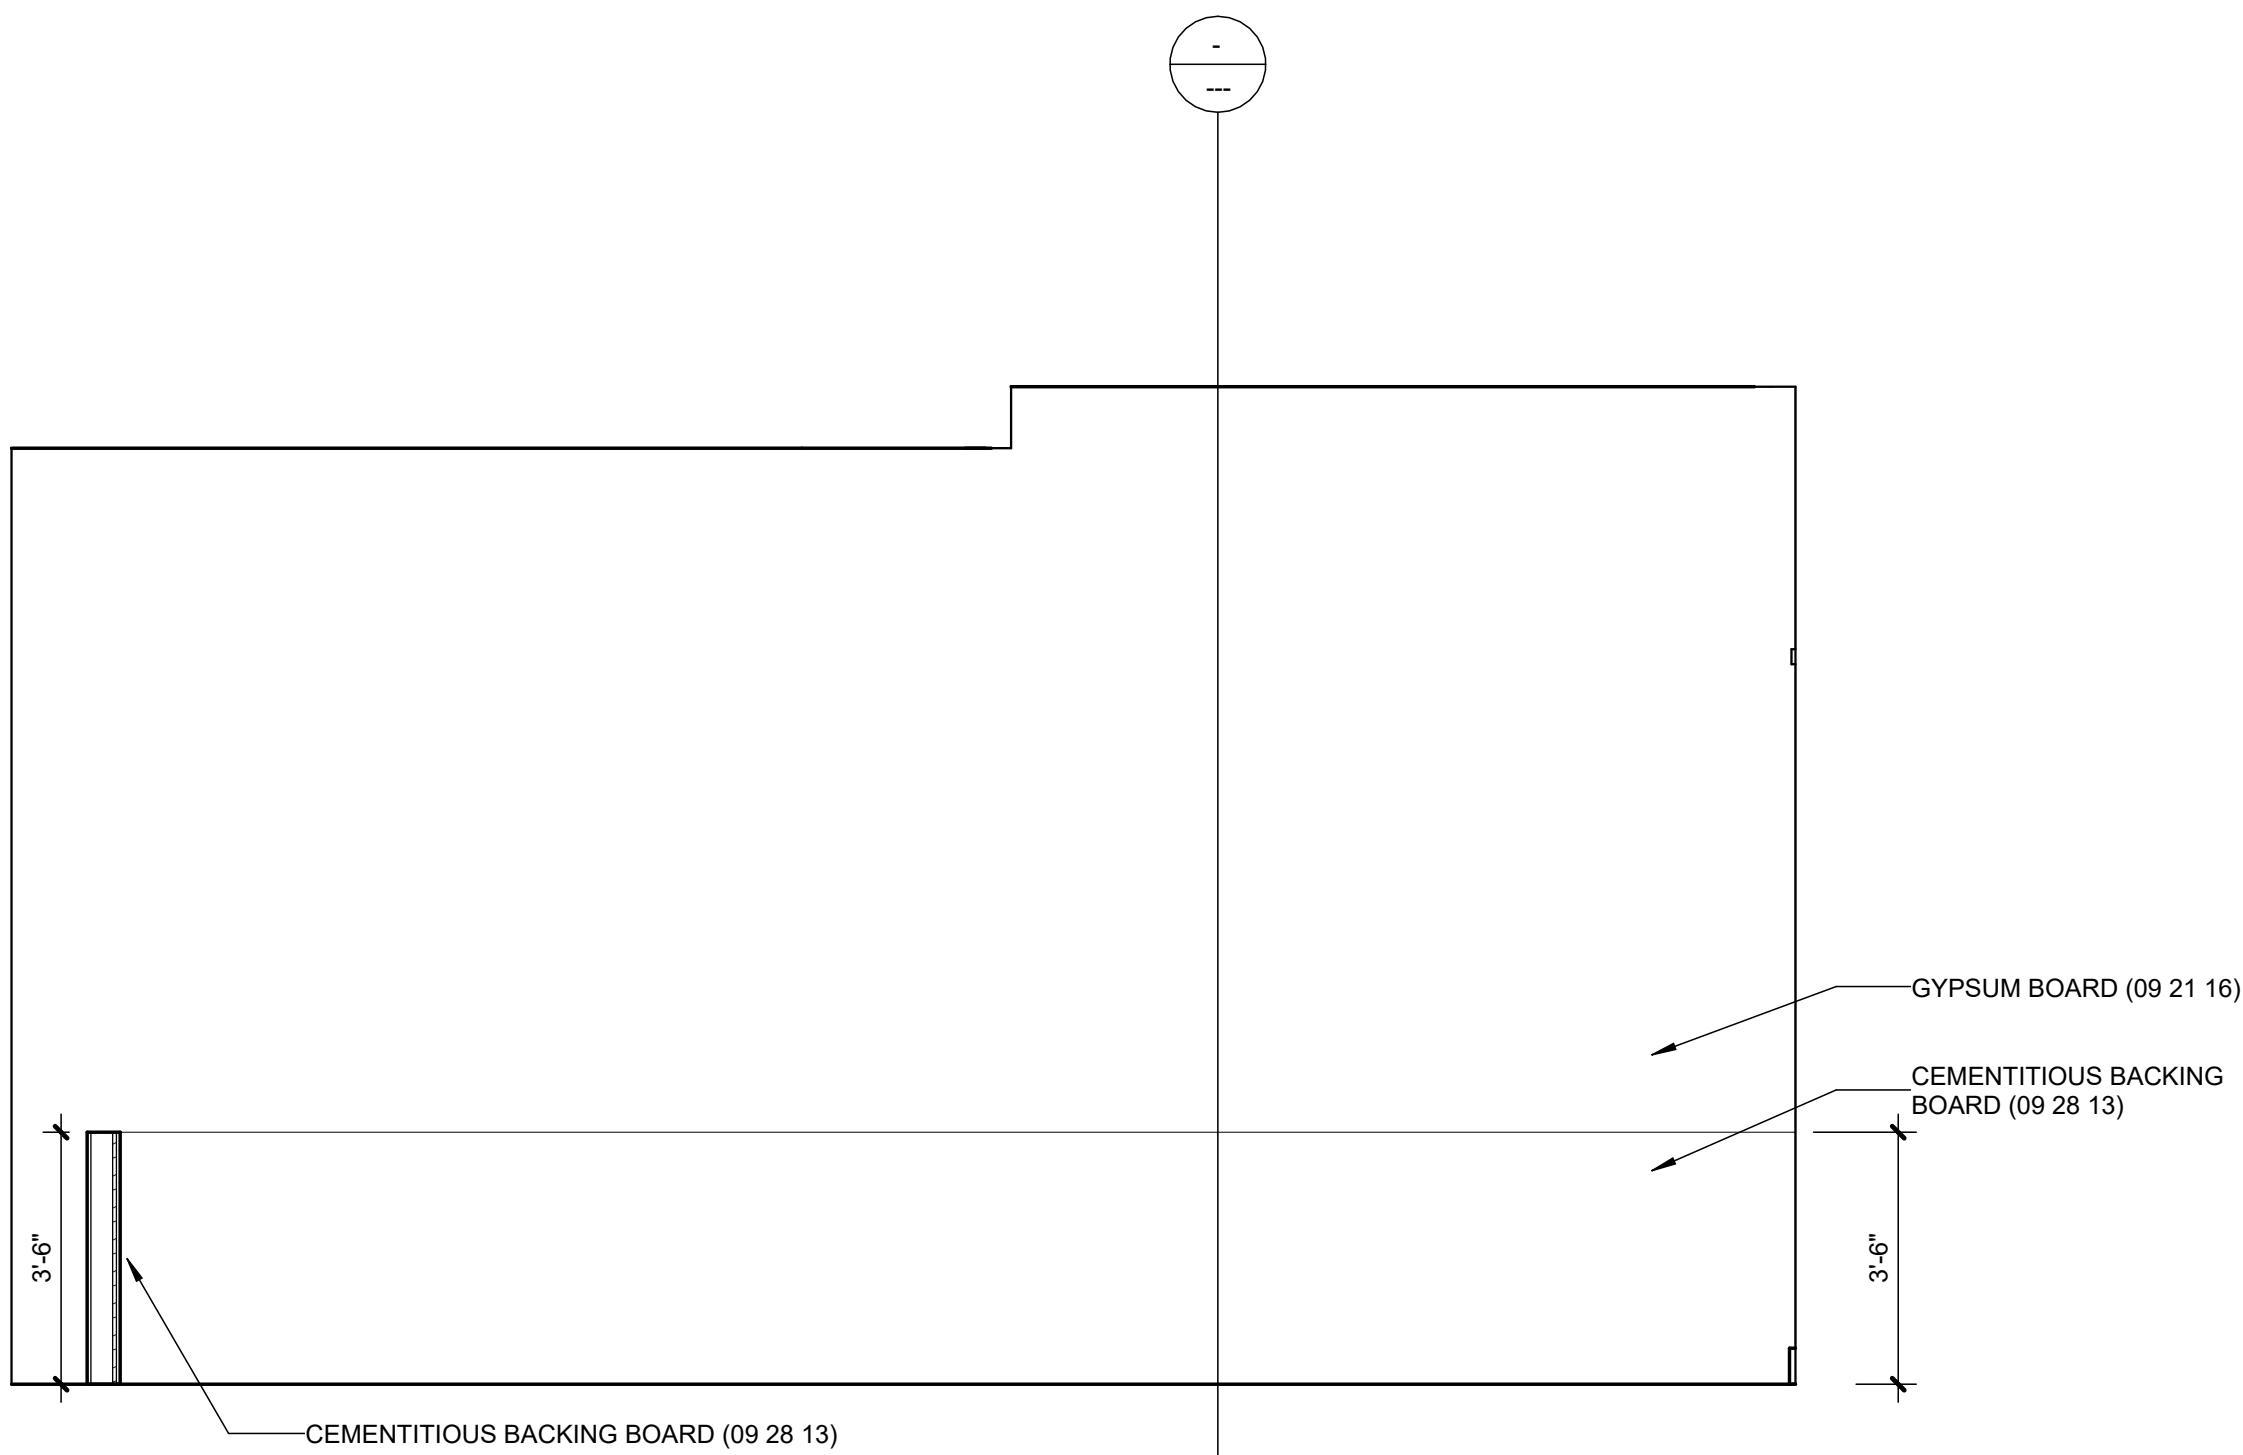
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REVISIONS	
20 DEC 2024	ADDENDUM 002
27 DEC 2024	ADDENDUM 004
06 JAN 2025	ADDENDUM 005


INTERIOR ELEVATIONS




11 CORRIDOR 200 ELEVATION
2.20 | 3/8" = 1'-0" |

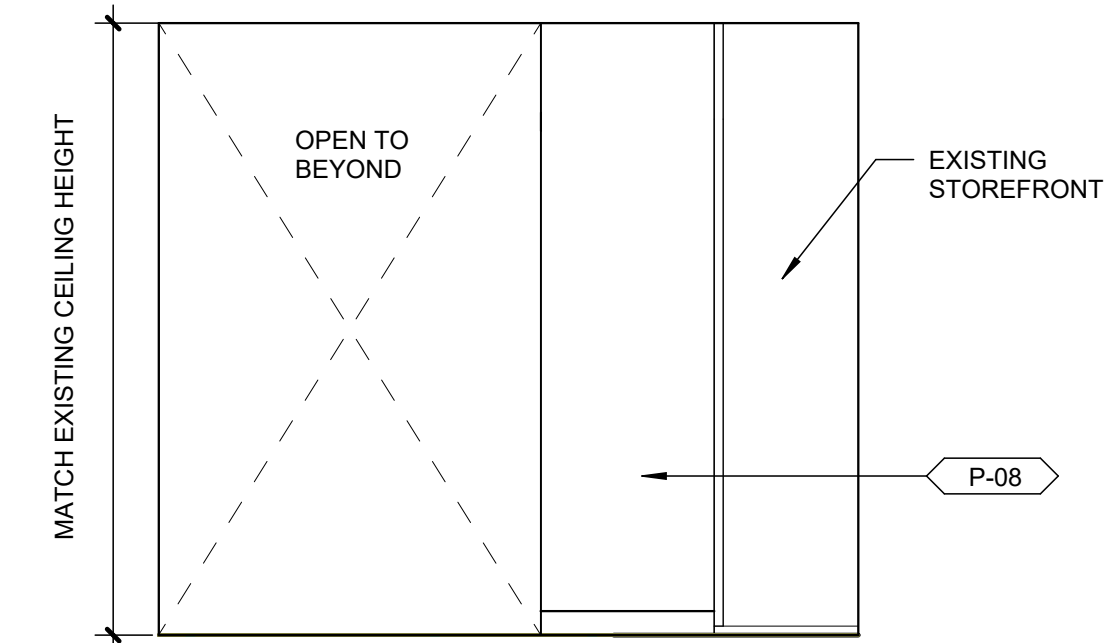


8 ELEVATION AT KITCHEN EXHIBIT
2.10 | 3/8" = 1'-0" |

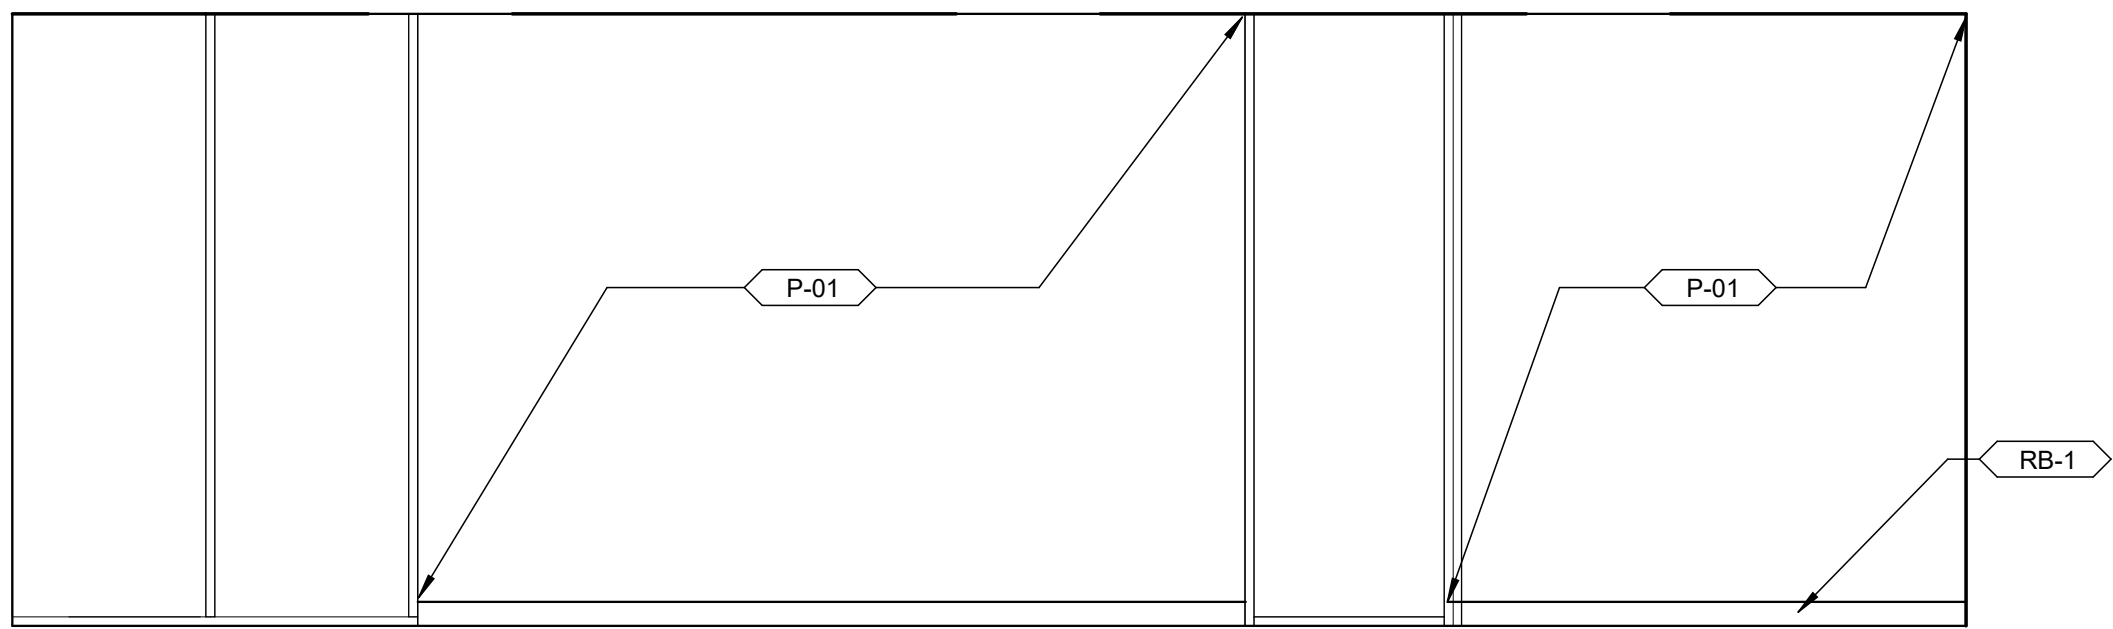


9 CORRIDOR 200 SOUTH ELEVATION
2.20 | 3/8" = 1'-0" |

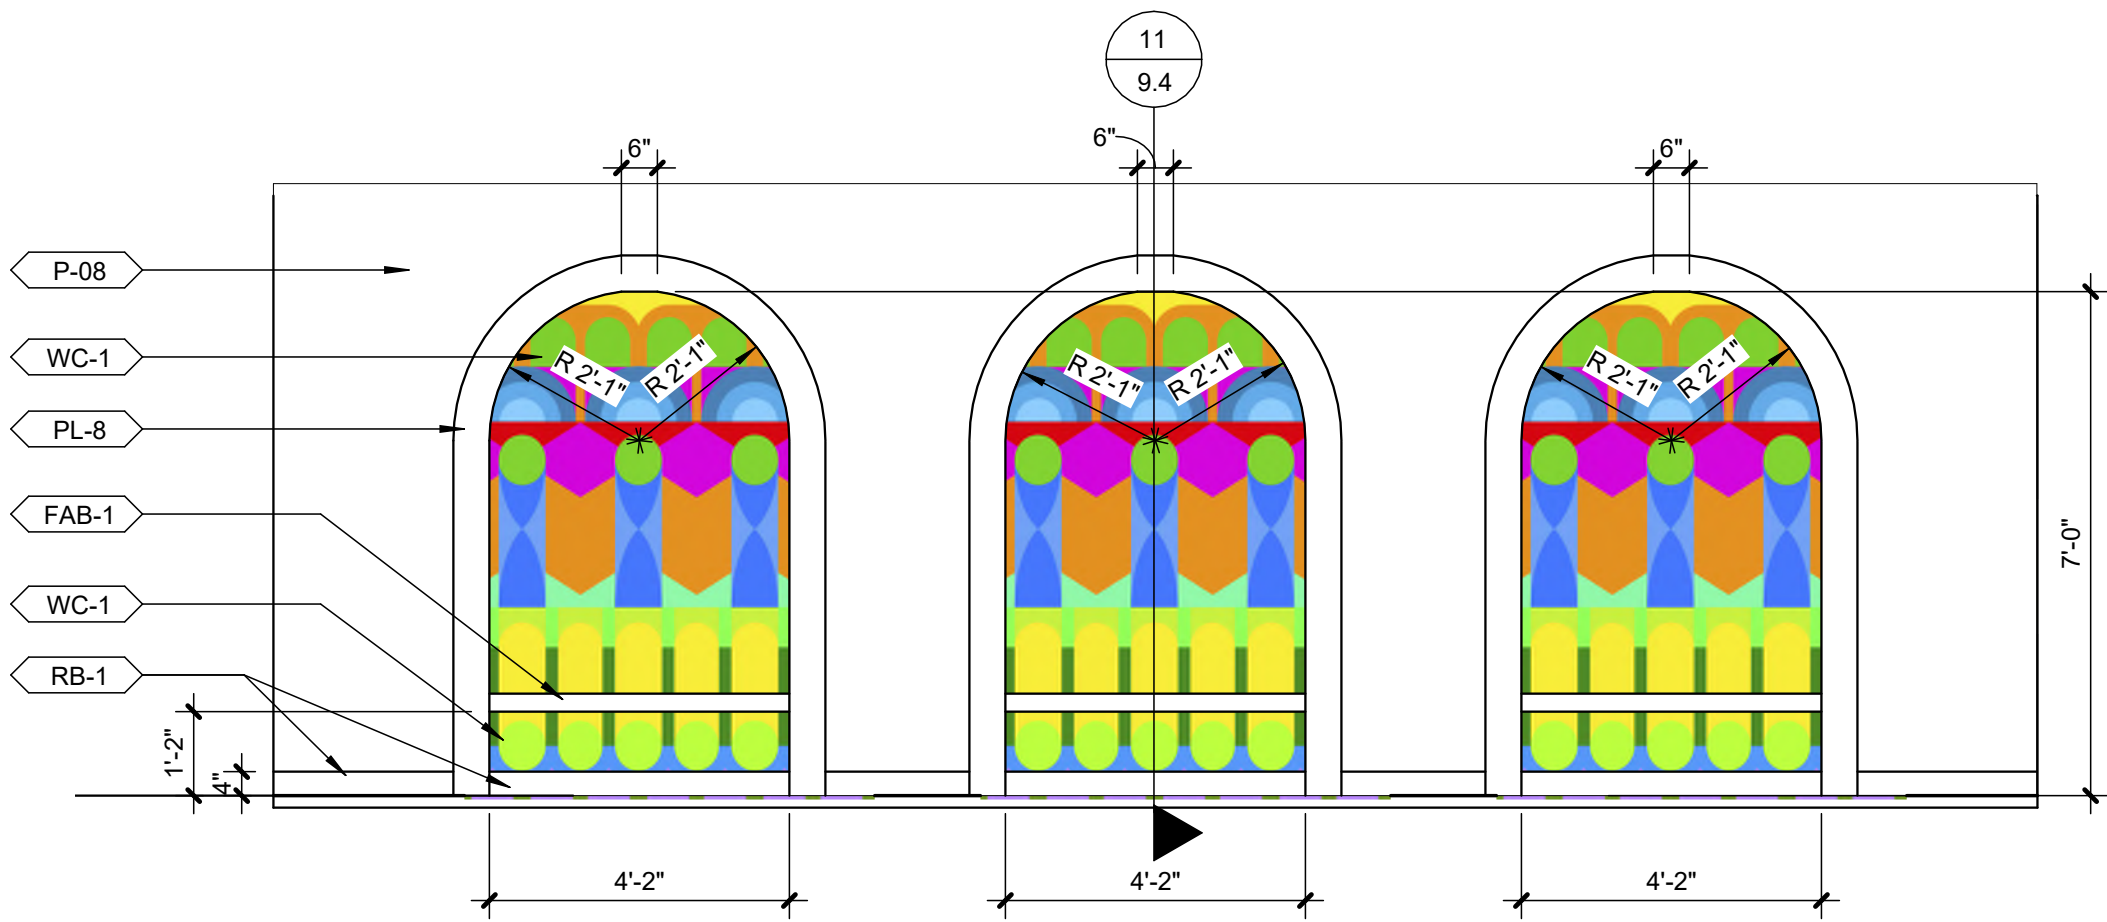


10 CORRIDOR 200 NORTH ELEVATION
2.20 | 3/8" = 1'-0" |

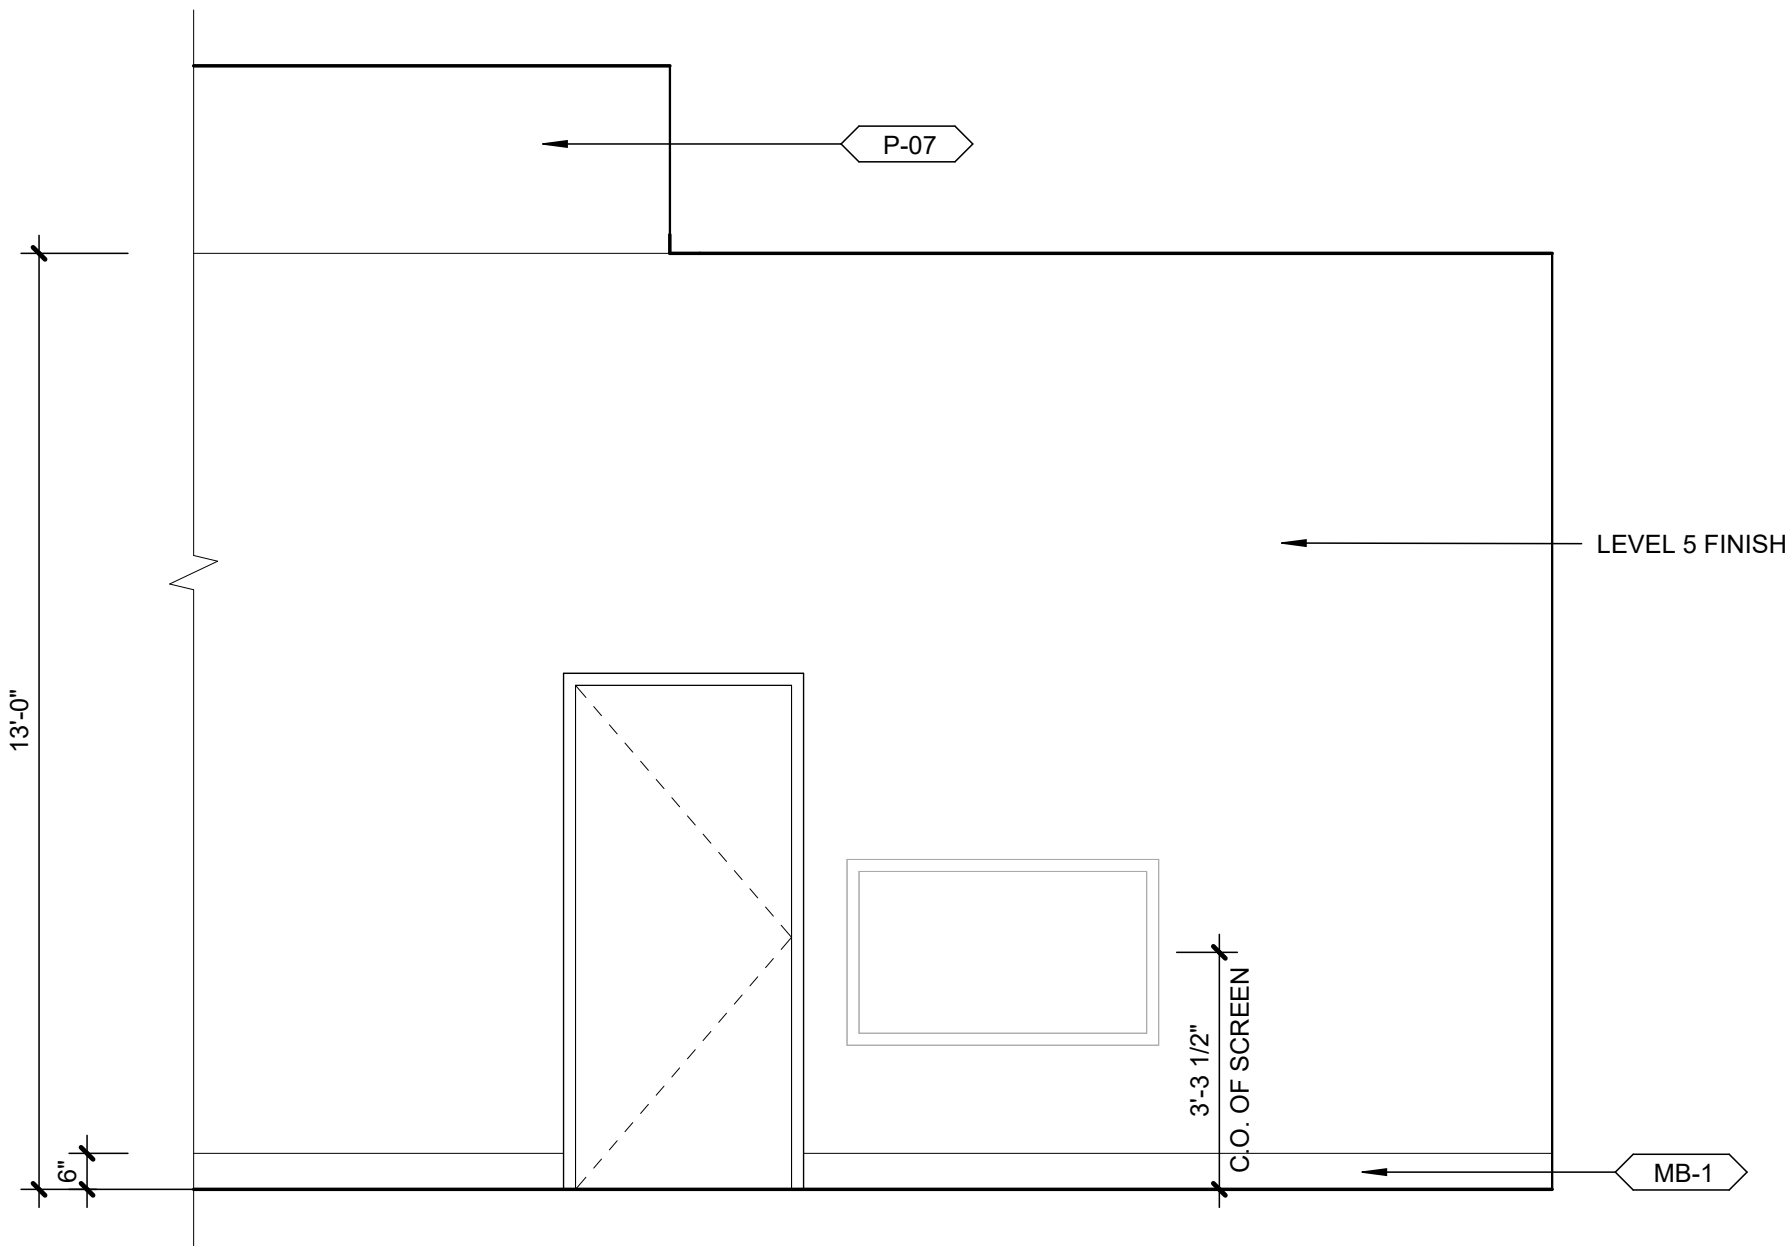


06 EAST ELEVATION
2.10 | 3/8" = 1'-0" | AT STAGE

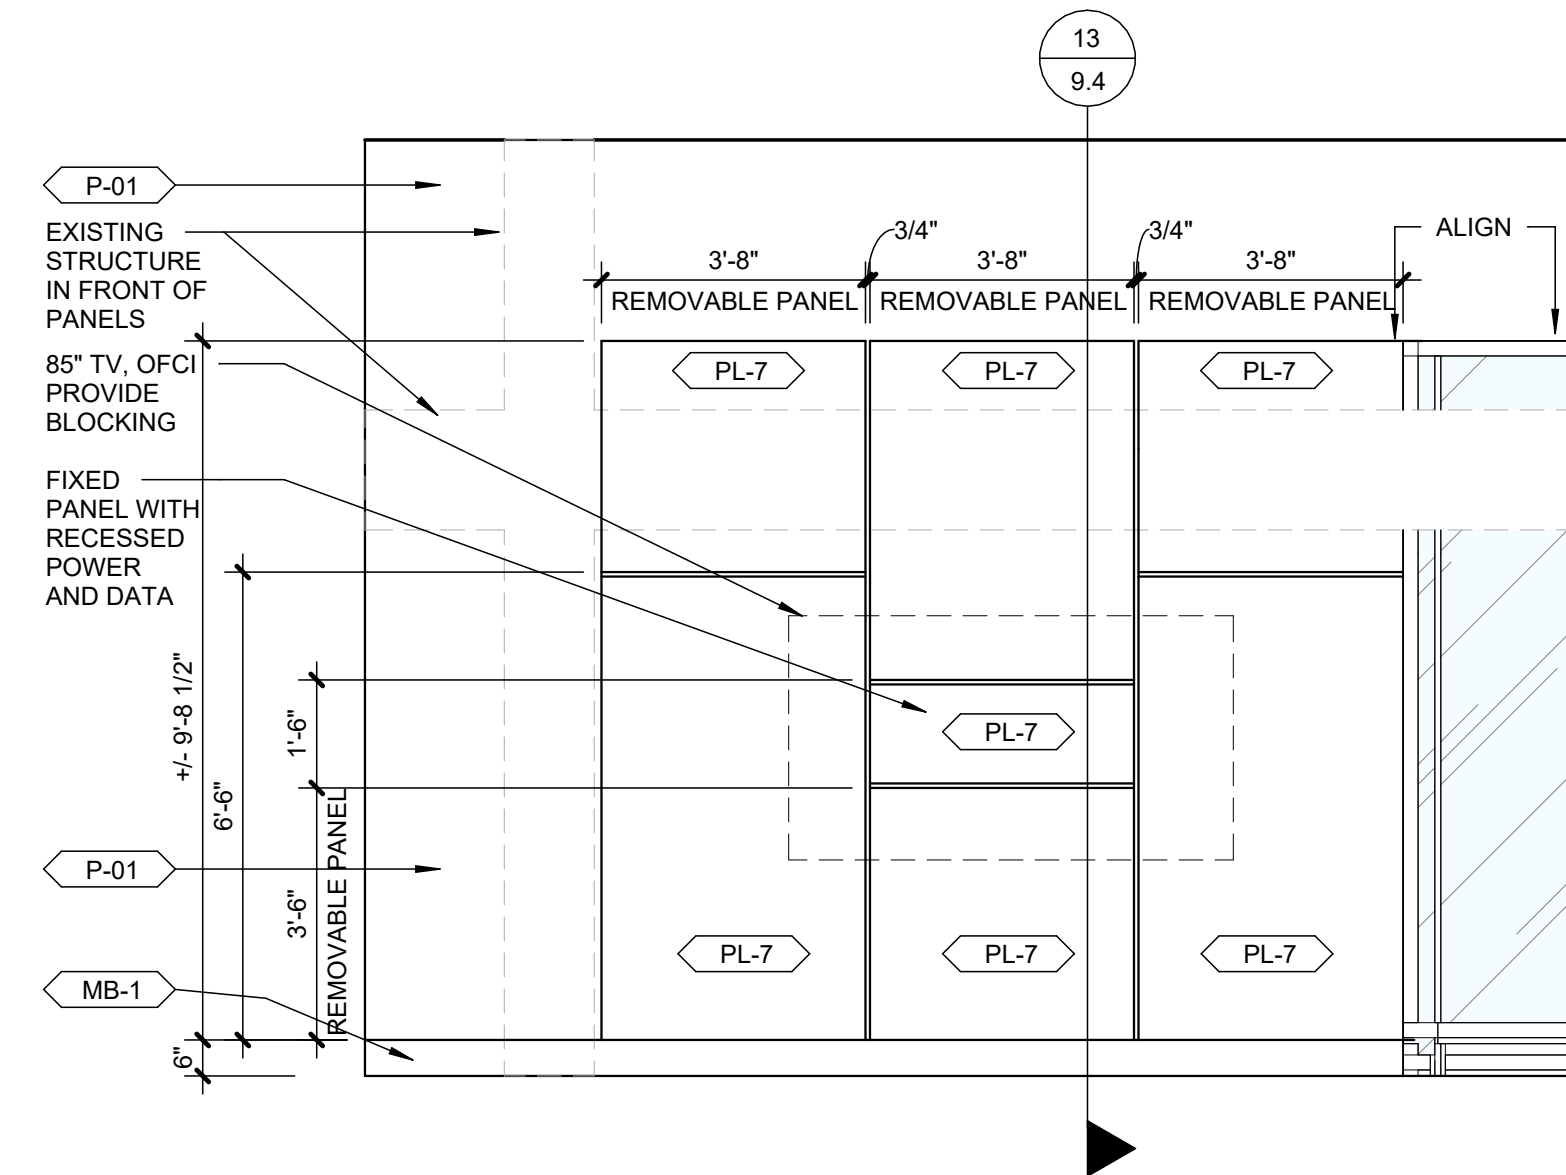


12 ACCESS PANELS FOR DONOR WALL ELEV
2.10 | 3/8" = 1'-0" |

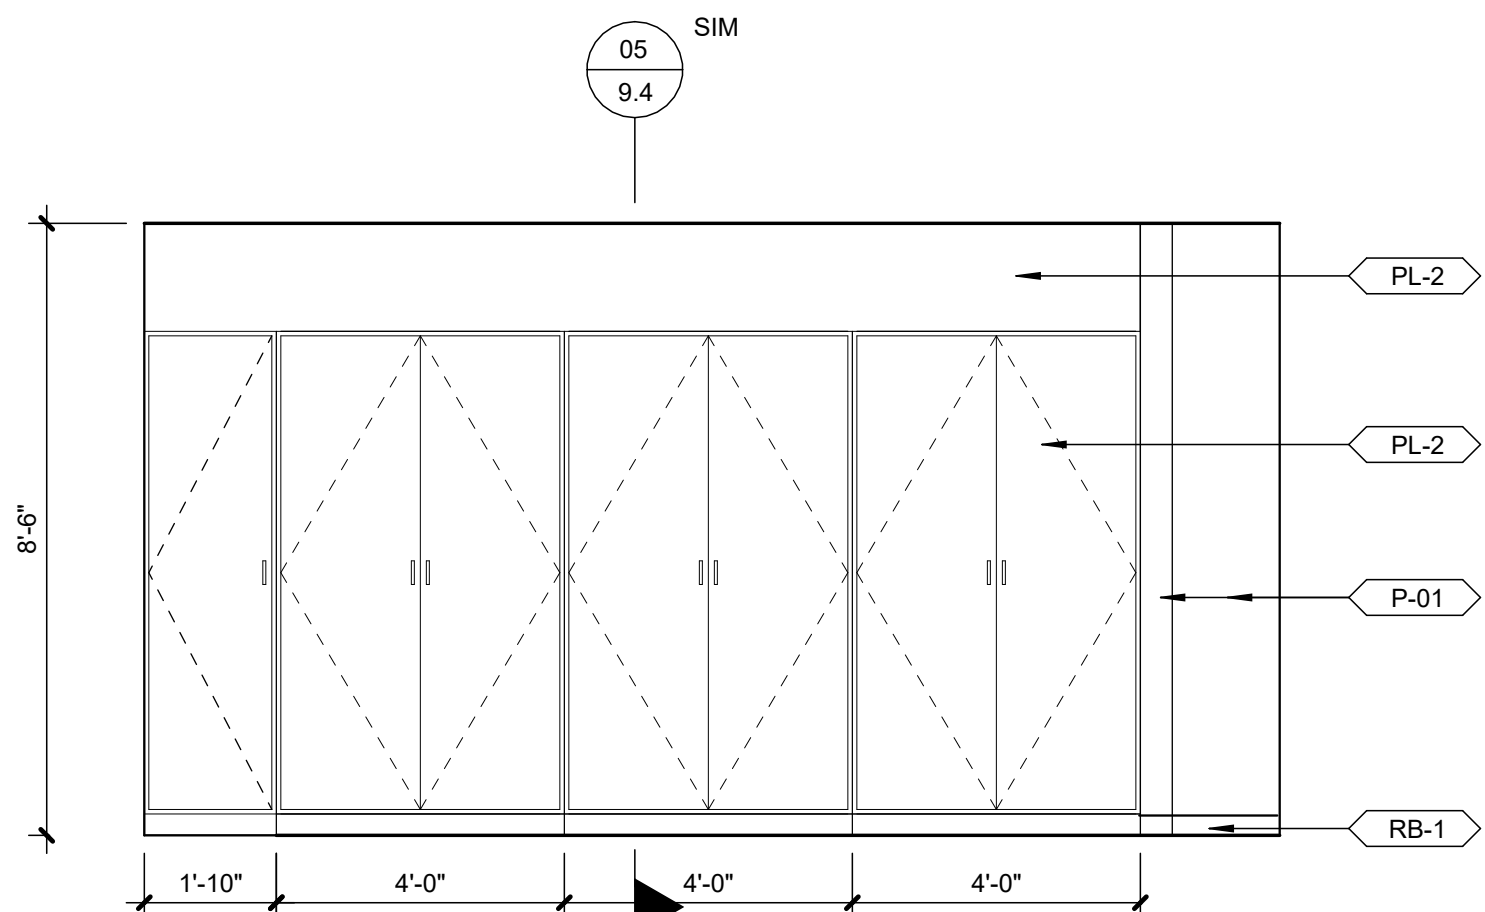


03 SOUTHEAST ELEVATION
2.21 | 3/8" = 1'-0" | AT TEEN ROOM

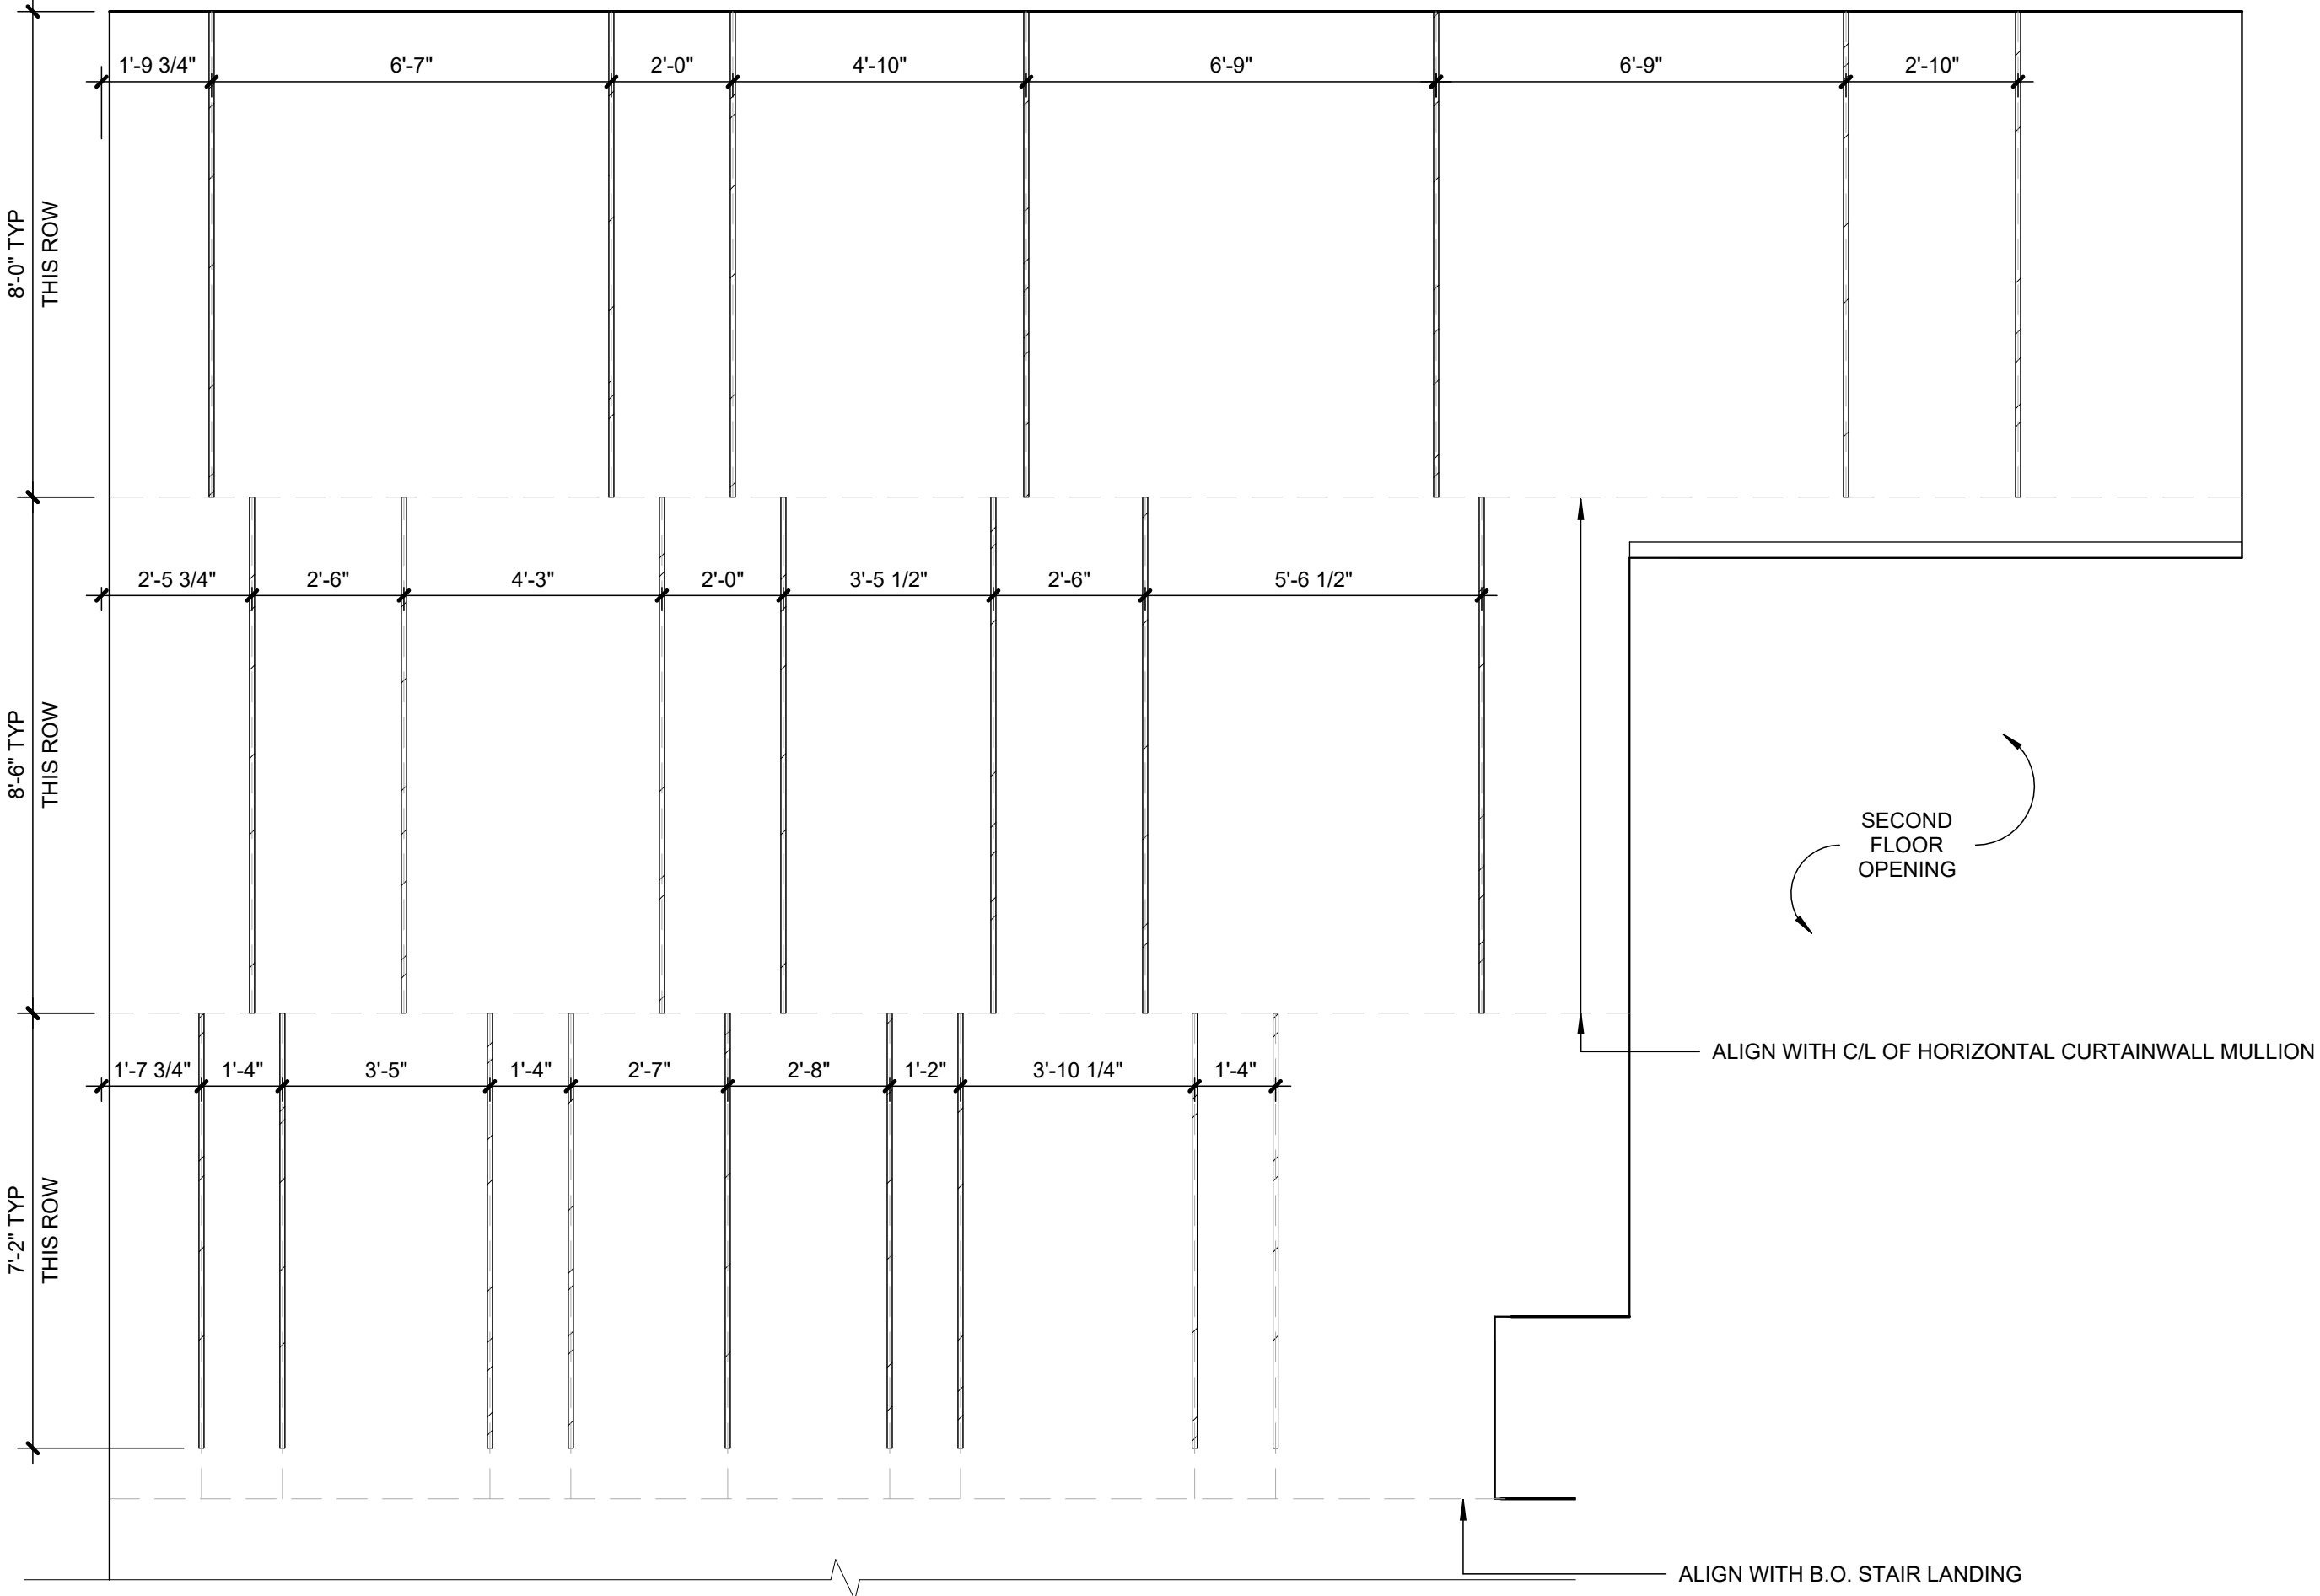


7 WEST ELEVATION ENTRY LIGHTING DATUMS
8.1 | 3/8" = 1'-0" | AT ENTRY

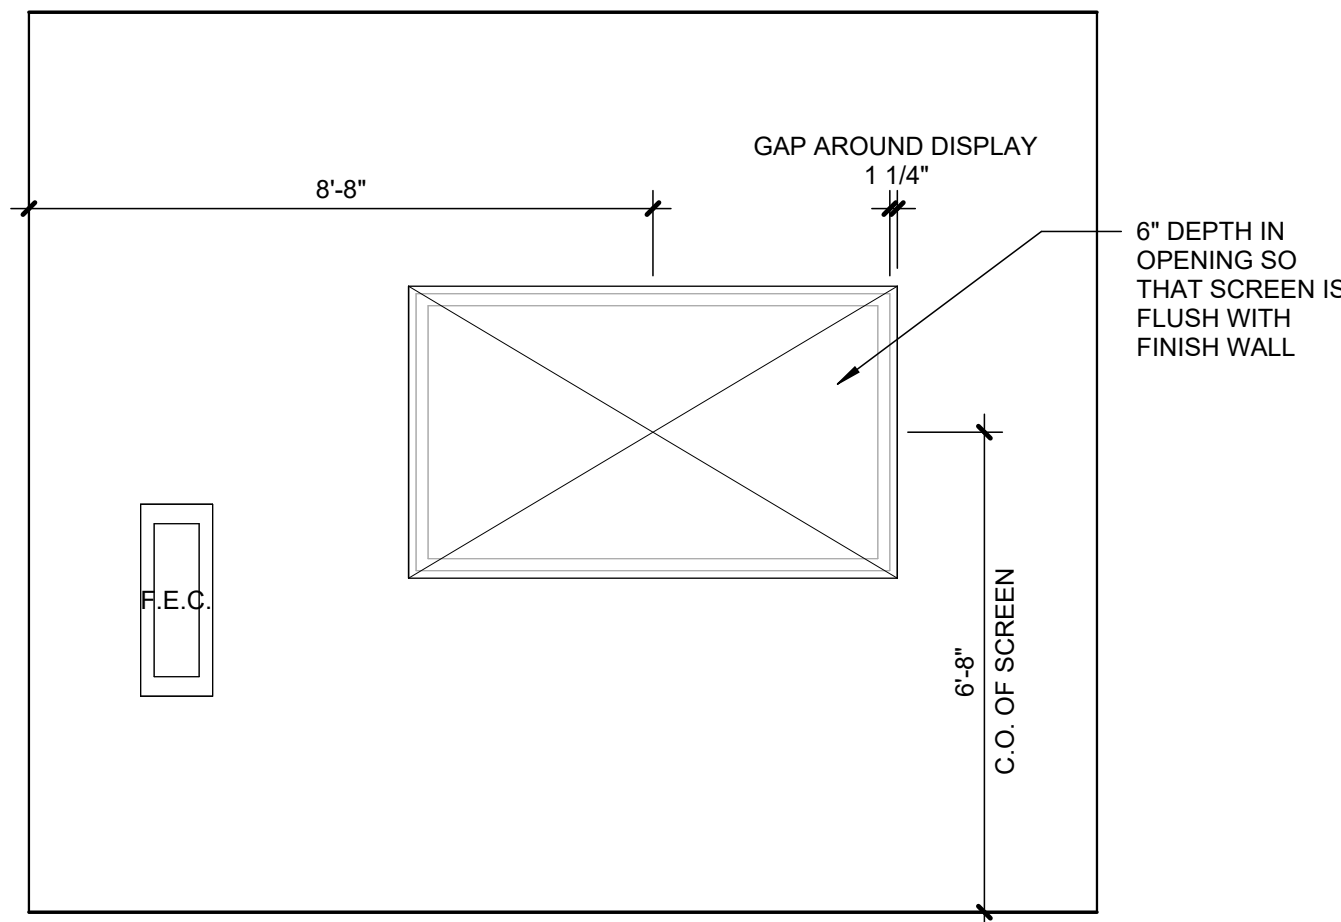

04 NORTH ELEVATION
2.20 | 3/8" = 1'-0" | AT SPORTS CELEBRATION WALL

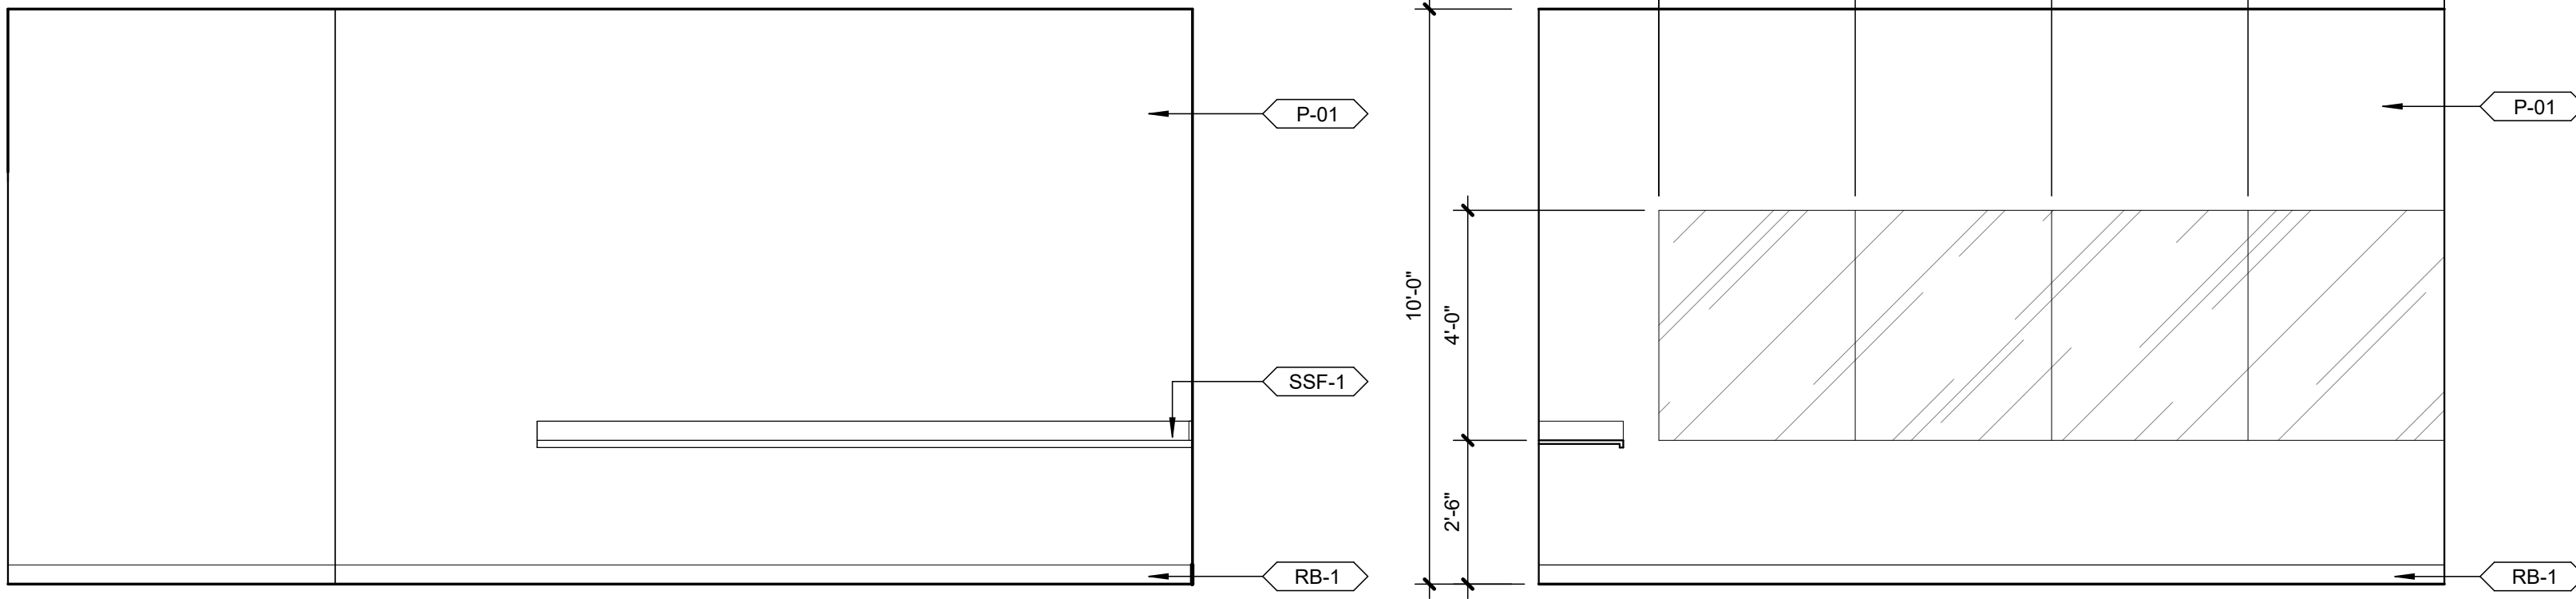

02 NORTH ELEVATION
2.21 | 3/8" = 1'-0" | AT CLASSROOM

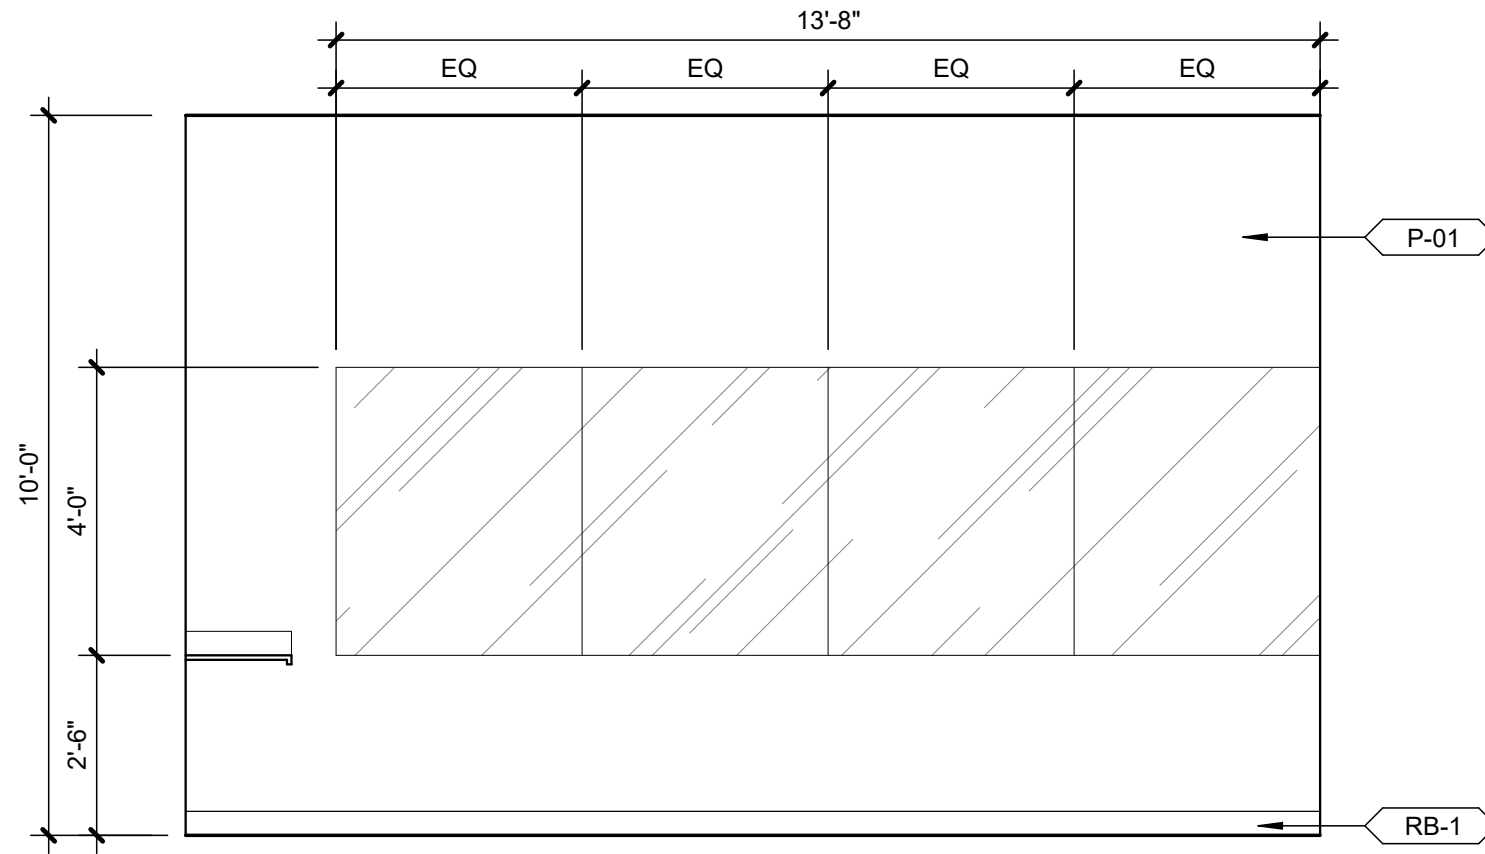

01 EAST ELEVATION
2.21 | 3/8" = 1'-0" | AT CLASSROOM

REFERENCE DESIGNATIONS FOR FINISH TYPES		
ACP-1	ACOUSTICAL CEILING PANEL	09 51 00
ACP-2	ACOUSTICAL CEILING PANEL	09 54 26
ACP-3	ACOUSTICAL CEILING PANEL	09 51 00
ACP-4	ACOUSTICAL CEILING PANEL	09 51 00
ACP-5	ACOUSTICAL CEILING PANEL	09 51 00
ACP-6	ACOUSTICAL CEILING PANEL	09 51 00
AP-1	ACRYLIC PANEL	09 30 00
AP-2	ACRYLIC PANEL	09 30 00
AP-3	ACRYLIC PANEL	09 30 00
CG-1	CORNER GUARD	10 26 00
CPT-1	CARPET TILE	09 68 13
DF-1	DECORATIVE FILM	08 87 00
FAB-1	UPHSTERY	08 87 00
MB-1	METAL BASE	05 70 00
MB-2	METAL BASE	05 70 00
MTL-1	METAL	07 42 13
MTL-2	METAL	07 42 13
MTL-3	METAL	07 42 13
P-01	PAINT	09 91 00
P-02	PAINT	09 91 00
P-04	PAINT	09 91 00
P-05	PAINT	09 91 00
P-06	PAINT	09 91 00
P-07	PAINT	09 91 00
P-08	PAINT	09 91 00
P-09	PAINT	09 91 00
P-10	PAINT	09 91 00
P-14	PAINT	09 91 00
P-15	PAINT	09 91 00
P-18	PAINT	09 91 00
P-19	PAINT	09 91 00
PL-1	PLASTIC LAMINATE	06 40 00
PL-2	PLASTIC LAMINATE	06 40 00
PL-3	PLASTIC LAMINATE	06 40 00
PL-4	PLASTIC LAMINATE	06 40 00
PL-5	PLASTIC LAMINATE	06 40 00
PL-6	PLASTIC LAMINATE	06 40 00
PL-7	PLASTIC LAMINATE	06 40 00
PL-8	PLASTIC LAMINATE	06 40 00
RB-1	RESILIENT BASE	09 65 13
RB-2	RESILIENT BASE	09 65 13
RF-01	RESILIENT FLOORING	09 65 00
RF-02	RESILIENT FLOORING	09 65 00
RF-03	RESILIENT FLOORING	09 65 00
RF-04	RESILIENT FLOORING	09 65 00
RF-06	RESILIENT FLOORING	09 65 00
RF-07	RESILIENT FLOORING	09 65 00
RF-08	RESILIENT FLOORING	09 65 00
RF-09	RESILIENT FLOORING	09 65 00
RF-10	RESILIENT FLOORING	09 65 00
RF-11	RESILIENT FLOORING	09 65 00
RF-12	RESILIENT FLOORING	09 65 00
RF-14	RESILIENT FLOORING	09 65 00
RF-15	RESILIENT FLOORING	09 65 00
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TZT-1	TERRAZZO TILE	09 66 16
WC-1	WALL COVERING	09 72 00
WOM-1	SURFACE LAID ENTRANCE MAT	12 48 16

WALKER'S IMAGINARIUM

200 HENRY CLAY AVENUE
NEW ORLEANS, LA 70118

EDR PROJECT NO. | 22003

PROJECT ISSUE DATE | 02 DECEMBER 2024


Conformed Set

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REVISIONS
20 DEC 2024 ADDENDUM 002
27 DEC 2024 ADDENDUM 004

INTERIOR ELEVATIONS



01 FIRST FLOOR
1.21 | 1/8" = 1'-0" |

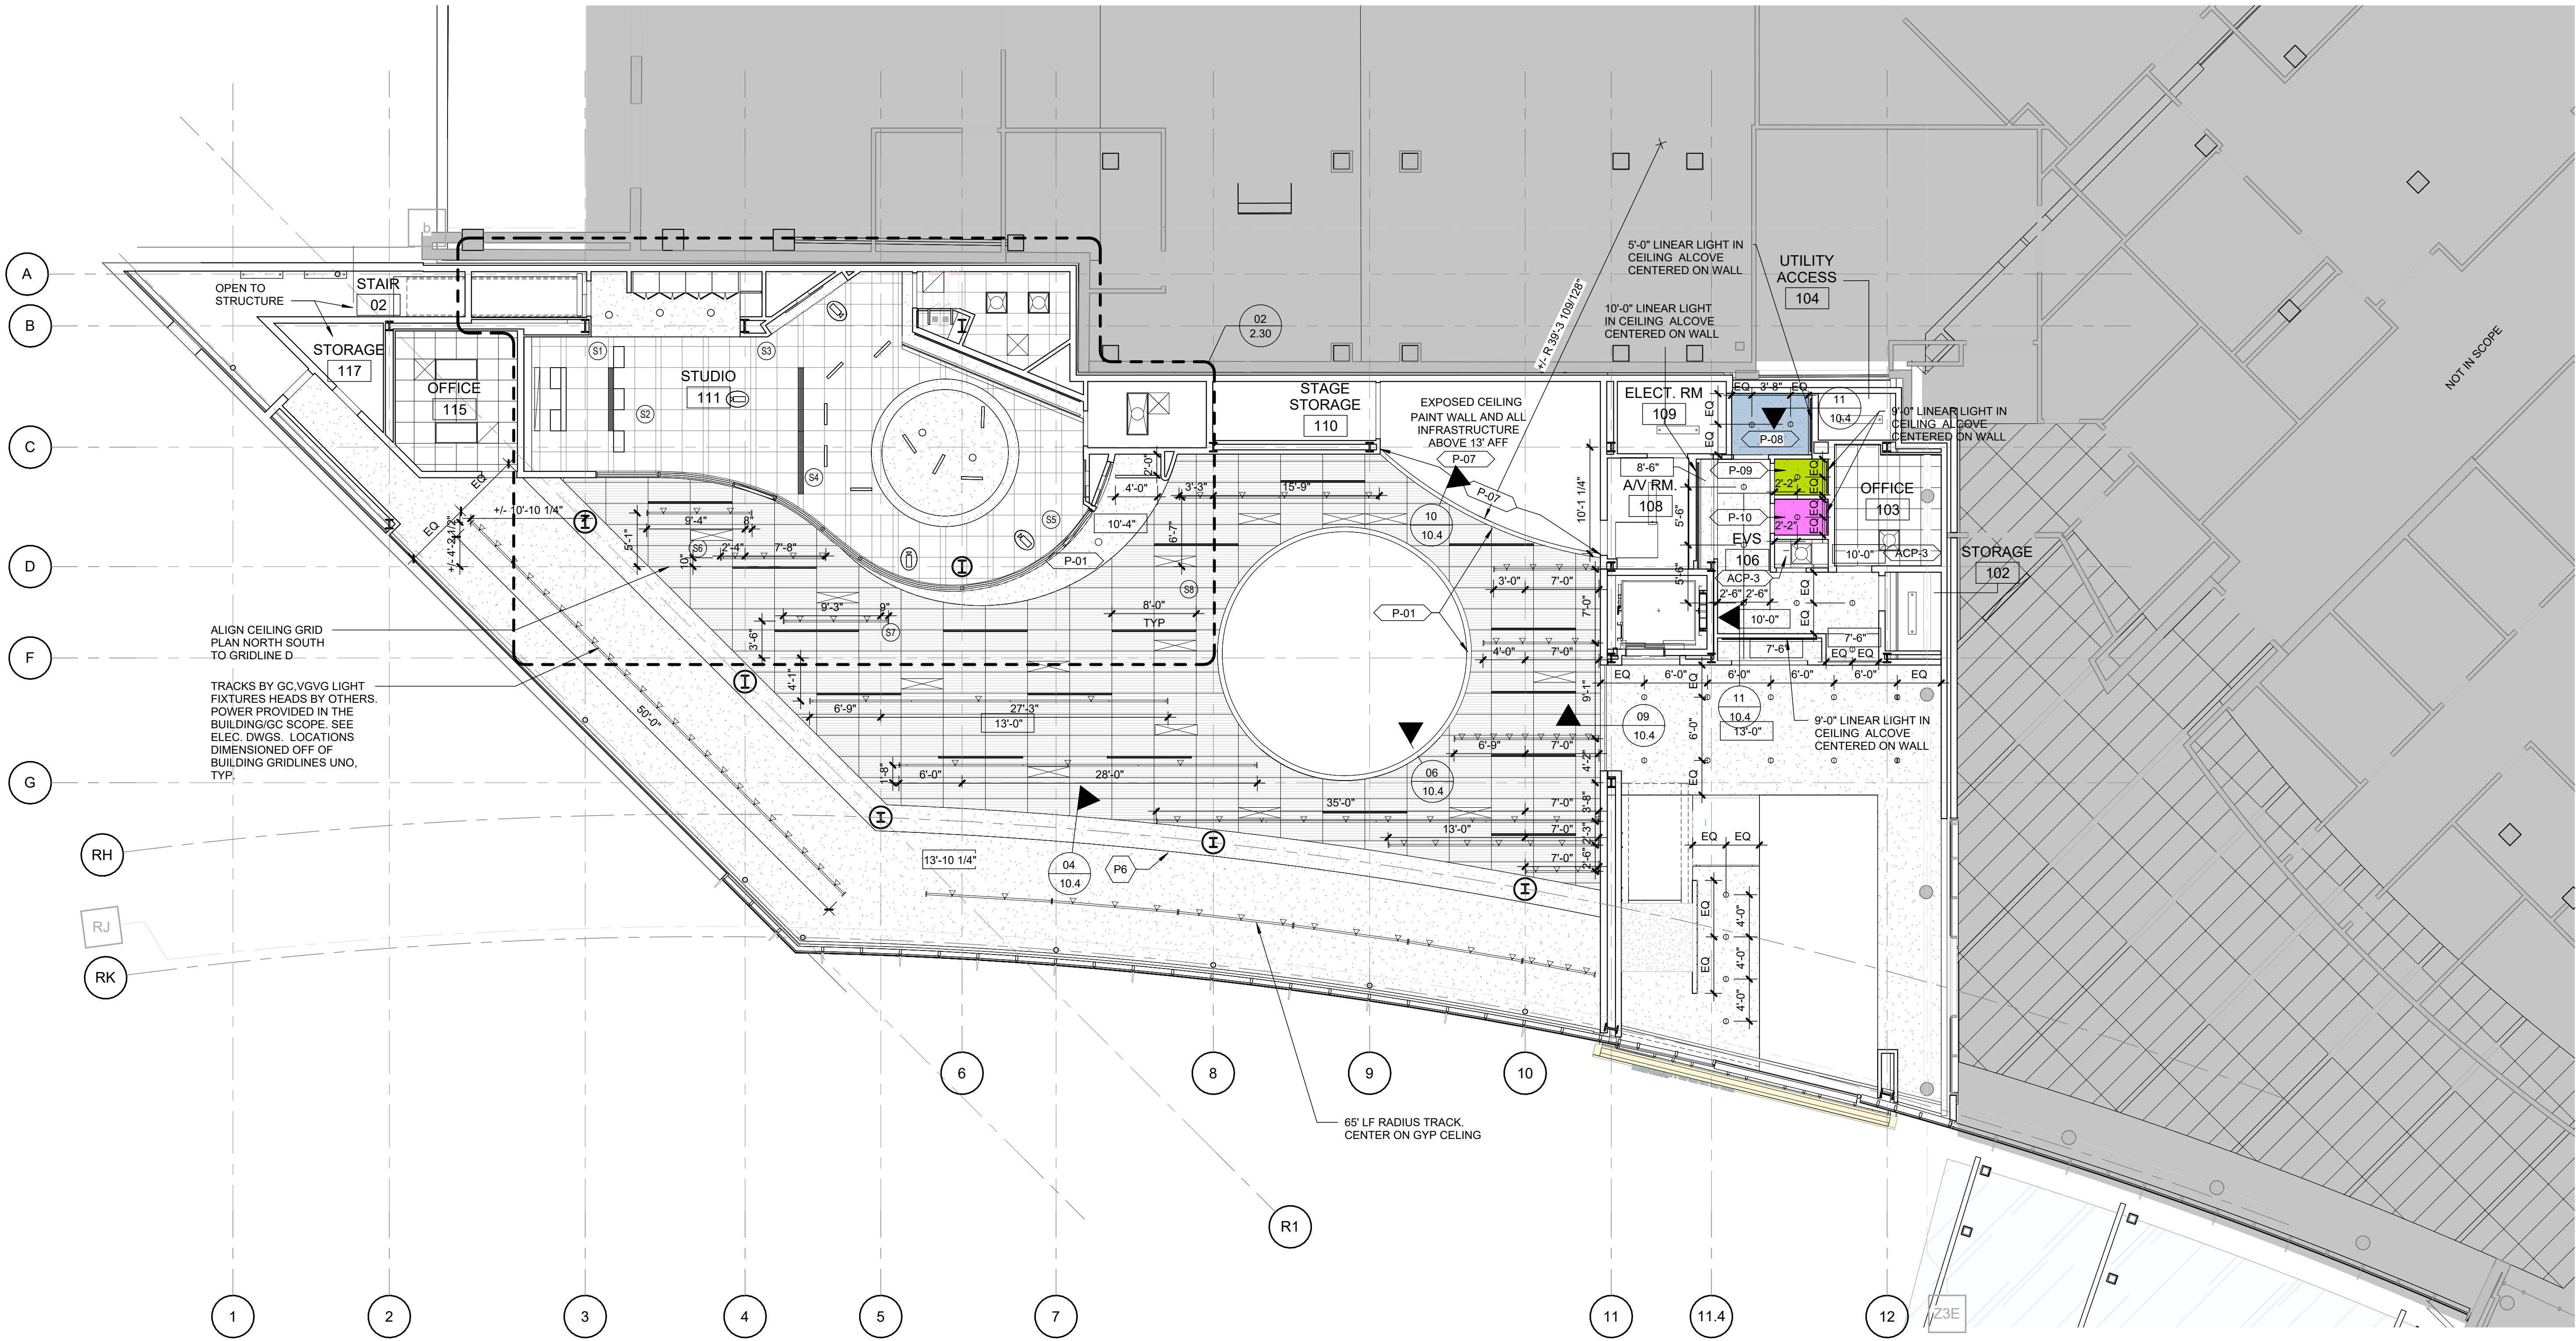CLARIFICATION OF SYMBOLS
REFLECTED CEILING PLAN

- CONTRACTOR SHALL VERIFY AND COORDINATE THE LOCATION OF ALL FIXTURES/ DEVICES INDICATED WITH THE MECHANICAL, ELECTRICAL, PLUMBING, SPRINKLER, ALARM AND SPECIAL DEVICES. NOTIFY ARCHITECT OF DISCREPANCIES/ CONFLICTS.
- THE LOCATION OF ALL DEVICES TO BE INSTALLED IN FLOORS, ON WALLS AND CEILINGS, ASSOCIATED WITH MECHANICAL, ELECTRICAL, FIRE PROTECTION, SECURITY, AND OTHER SUCH SYSTEMS INCLUDING ACCESS PANELS, NOT SPECIFICALLY INDICATED ON THE DRAWINGS BUT PART OF THE CONSTRUCTION CONTRACT, SHALL BE APPROVED BY THE ARCHITECT. FAILURE TO RECEIVE APPROVAL, SHALL BE CAUSE FOR REMOVAL AND RELOCATION AT NO COST TO THE OWNER.
- ALL SYMBOLS APPEARING IN THIS LISTING MAY NOT NECESSARILY BE SHOWN ON REFLECTED CEILING PLAN OR BE APPLICABLE TO THIS PROJECT.

- GYPSUM BOARD CEILING - P-08 UNO
- ACOUSTICAL CEILING TILE ACP-1
- ACOUSTICAL CEILING TILE ACP-2
- ACOUSTICAL CEILING TILE ACP-3
- ACOUSTICAL CEILING TILE ACP-4
- ACOUSTICAL CEILING TILE ACP-5
- METAL PANEL CEILING SYSTEM
- LINEAR LIGHTING FIXTURE
- LINEAR LIGHTING FIXTURE
- LINEAR WALL WASHER
- RECESSED LIGHTING FIXTURE
- PENDANT FIXTURE
- CEILING FAN
- 6" RECESSED DOWNLIGHT
- RETURN VENT
- SUPPLY VENT

- LIGHT FIXTURES NOTES:
- ASSUME RECESSED DOWNLIGHTS IN THE GYPSUM BOARD CEILINGS
 - ASSUME RECESSED 2X2 FIXTURES IN THE A.C.T. CEILING.
 - ASSUME EXHIBIT SPECIFIC LIGHTING IN THE EXHIBIT SPACES.
- RESTROOM NOTES:
- ASSUME RESTROOMS TO BE INDIVIDUAL SINGLE STALLS, WITH FULL HEIGHT STANDARD STUB WALLS, DOORS, LIGHTING AND HVAC, SPRINKLER FOR EACH INDIVIDUAL STALL.

CLARIFICATION OF REFERENCE DESIGNATIONS

- P6 CAMERA PROVIDED BY RYAN SEACREST FOUNDATION MOUNTED TO TRELIS. MOUNTING HEIGHT TO BE COORDINATED. REFER TO ELECTRICAL DRAWINGS TO PROVIDE LOW VOLTAGE AND VIDEO BACK TO SEACREST STUDIO SPACE

WALKER'S IMAGINARIUM

200 HENRY CLAY AVENUE
NEW ORLEANS, LA 70118
EDR PROJECT NO. | 22003

PROJECT ISSUE DATE | 02 DECEMBER 2024


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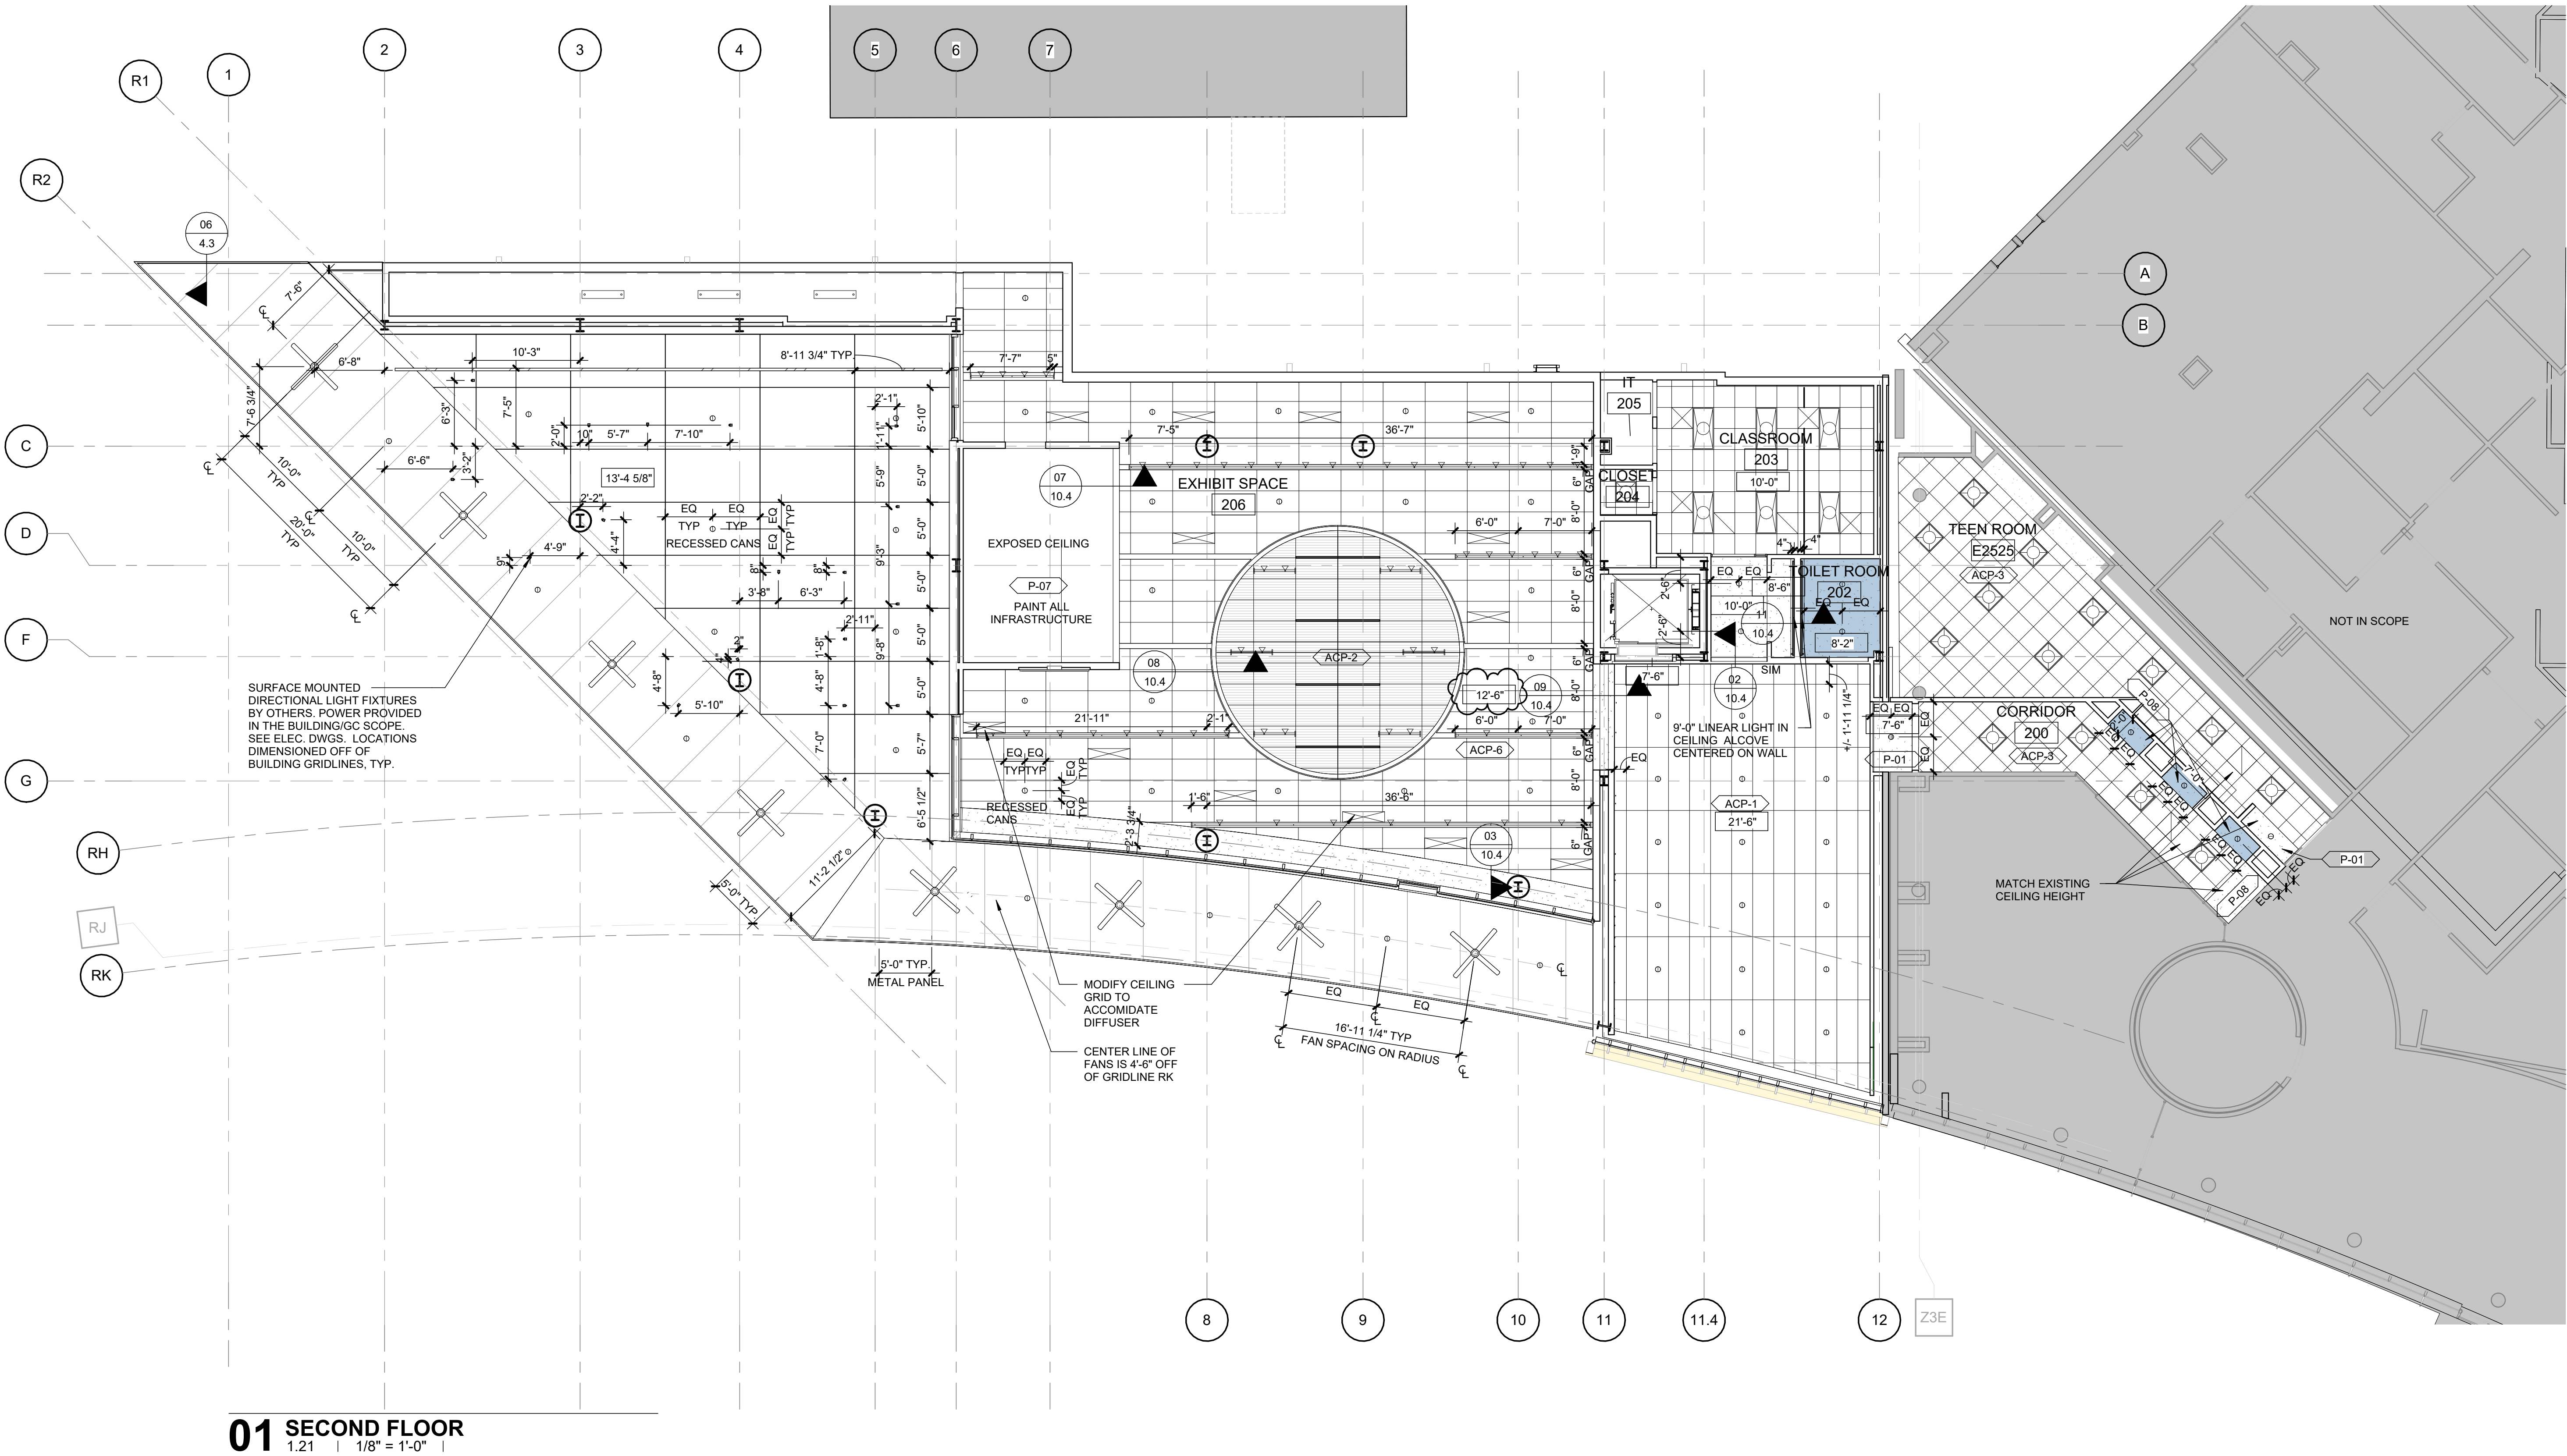
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REVISIONS
20 DEC 2024 ADDENDUM 002

FIRST FLOOR - REFLECTED CEILING PLAN





01 SECOND FLOOR
1.21 | 1/8" = 1'-0" |

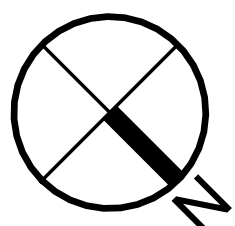- CLARIFICATION OF SYMBOLS**
REFLECTED CEILING PLAN
- CONTRACTOR SHALL VERIFY AND COORDINATE THE LOCATION OF ALL FIXTURES/ DEVICES INDICATED WITH THE MECHANICAL, ELECTRICAL, PLUMBING, SPRINKLER, ALARM AND SPECIAL DEVICES. NOTIFY ARCHITECT OF DISCREPANCIES/ CONFLICTS.
 - THE LOCATION OF ALL DEVICES TO BE INSTALLED IN FLOORS, ON WALLS AND CEILINGS, ASSOCIATED WITH MECHANICAL, ELECTRICAL, FIRE PROTECTION, SECURITY, AND OTHER SUCH SYSTEMS INCLUDING ACCESS PANELS, NOT SPECIFICALLY INDICATED ON THE DRAWINGS BUT PART OF THE CONSTRUCTION CONTRACT, SHALL BE APPROVED BY THE ARCHITECT. FAILURE TO RECEIVE APPROVAL, SHALL BE CAUSE FOR REMOVAL AND RELOCATION AT NO COST TO THE OWNER.
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- GYPSUM BOARD CEILING - P-08 UNO
- ACOUSTICAL CEILING TILE ACP-1
- ACOUSTICAL CEILING TILE ACP-2
- ACOUSTICAL CEILING TILE ACP-3
- ACOUSTICAL CEILING TILE ACP-4
- ACOUSTICAL CEILING TILE ACP-5
- METAL PANEL CEILING SYSTEM
- LINEAR LIGHTING FIXTURE
- LINEAR LIGHTING FIXTURE
- LINEAR WALL WASHER
- RECESSED LIGHTING FIXTURE
- PENDANT FIXTURE
- CEILING FAN
- 6" RECESSED DOWNLIGHT
- RETURN VENT
- SUPPLY VENT

- LIGHT FIXTURES NOTES:**
- ASSUME RECESSED DOWNLIGHTS IN THE GYPSUM BOARD CEILINGS
 - ASSUME RECESSED 2X2 FIXTURES IN THE A.C.T. CEILING.
 - ASSUME EXHIBIT SPECIFIC LIGHTING IN THE EXHIBIT SPACES.
- RESTROOM NOTES:**
- ASSUME RESTROOMS TO BE INDIVIDUAL SINGLE STALLS, WITH FULL HEIGHT STANDARD STUB WALLS, DOORS, LIGHTING AND HVAC, SPRINKLER FOR EACH INDIVIDUAL STALL.

WALKER'S IMAGINARIUM

200 HENRY CLAY AVENUE
NEW ORLEANS, LA 70118
EDR PROJECT NO. | 22003

PROJECT ISSUE DATE | 02 DECEMBER 2024


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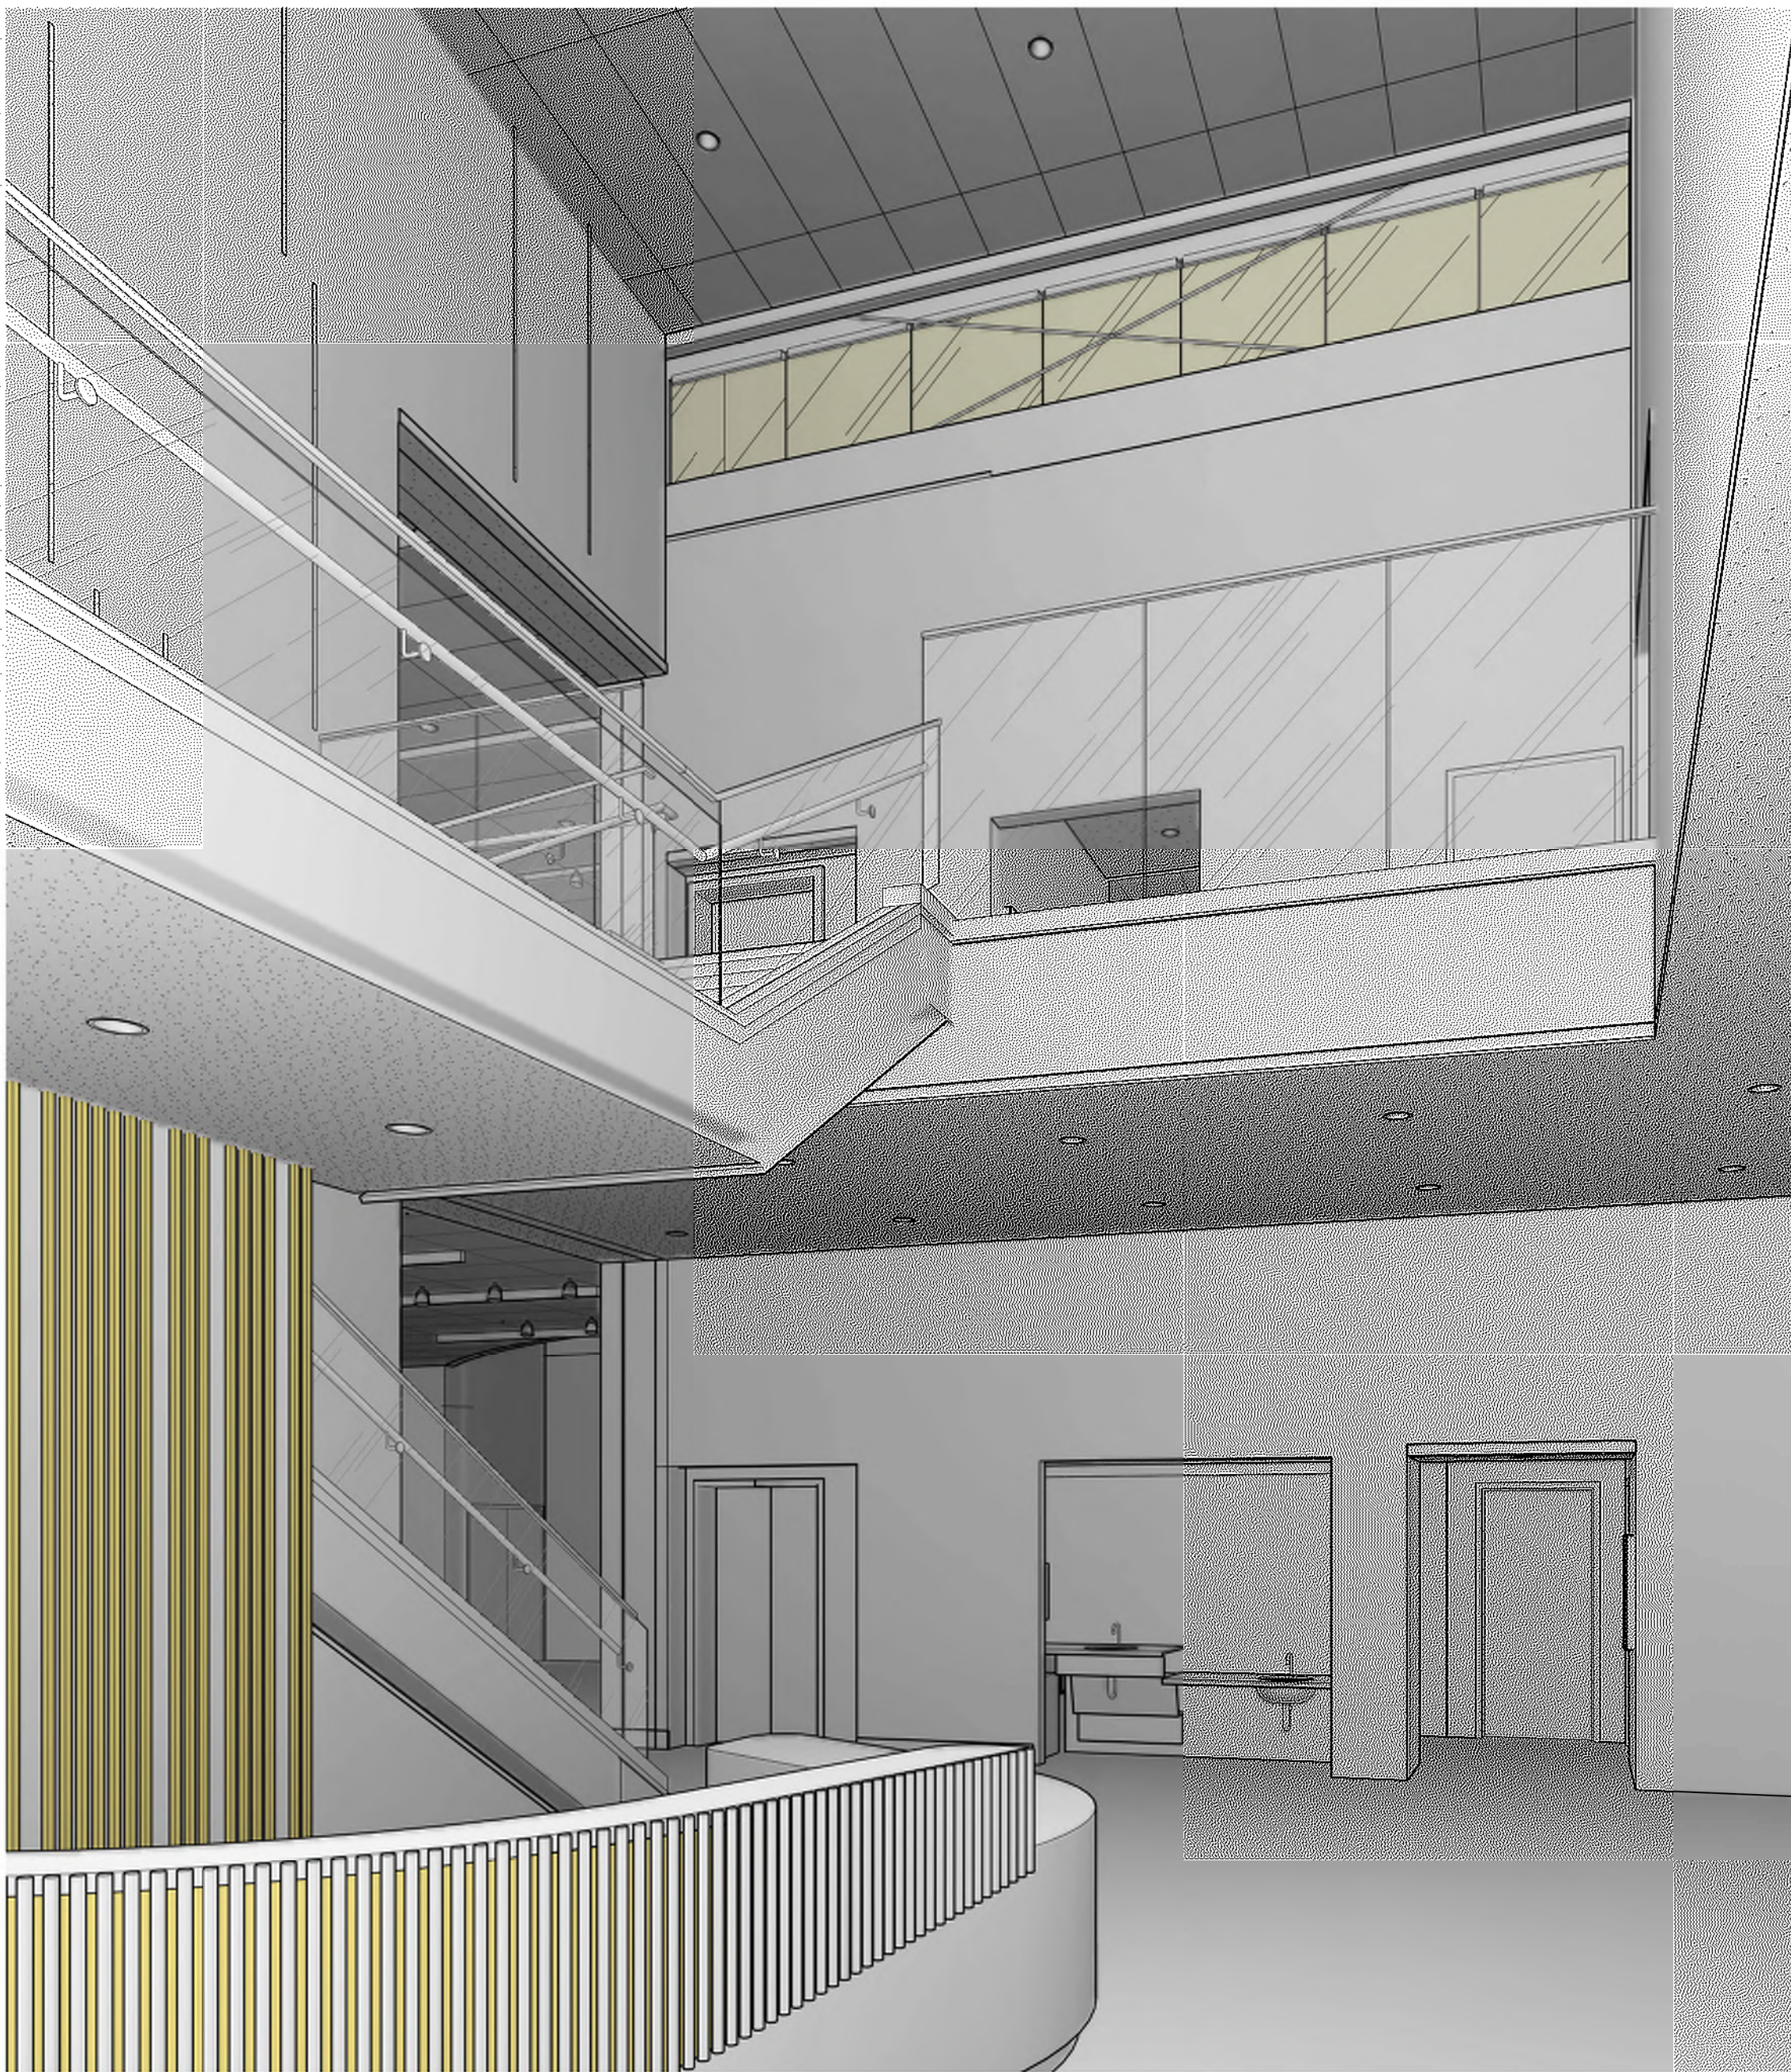
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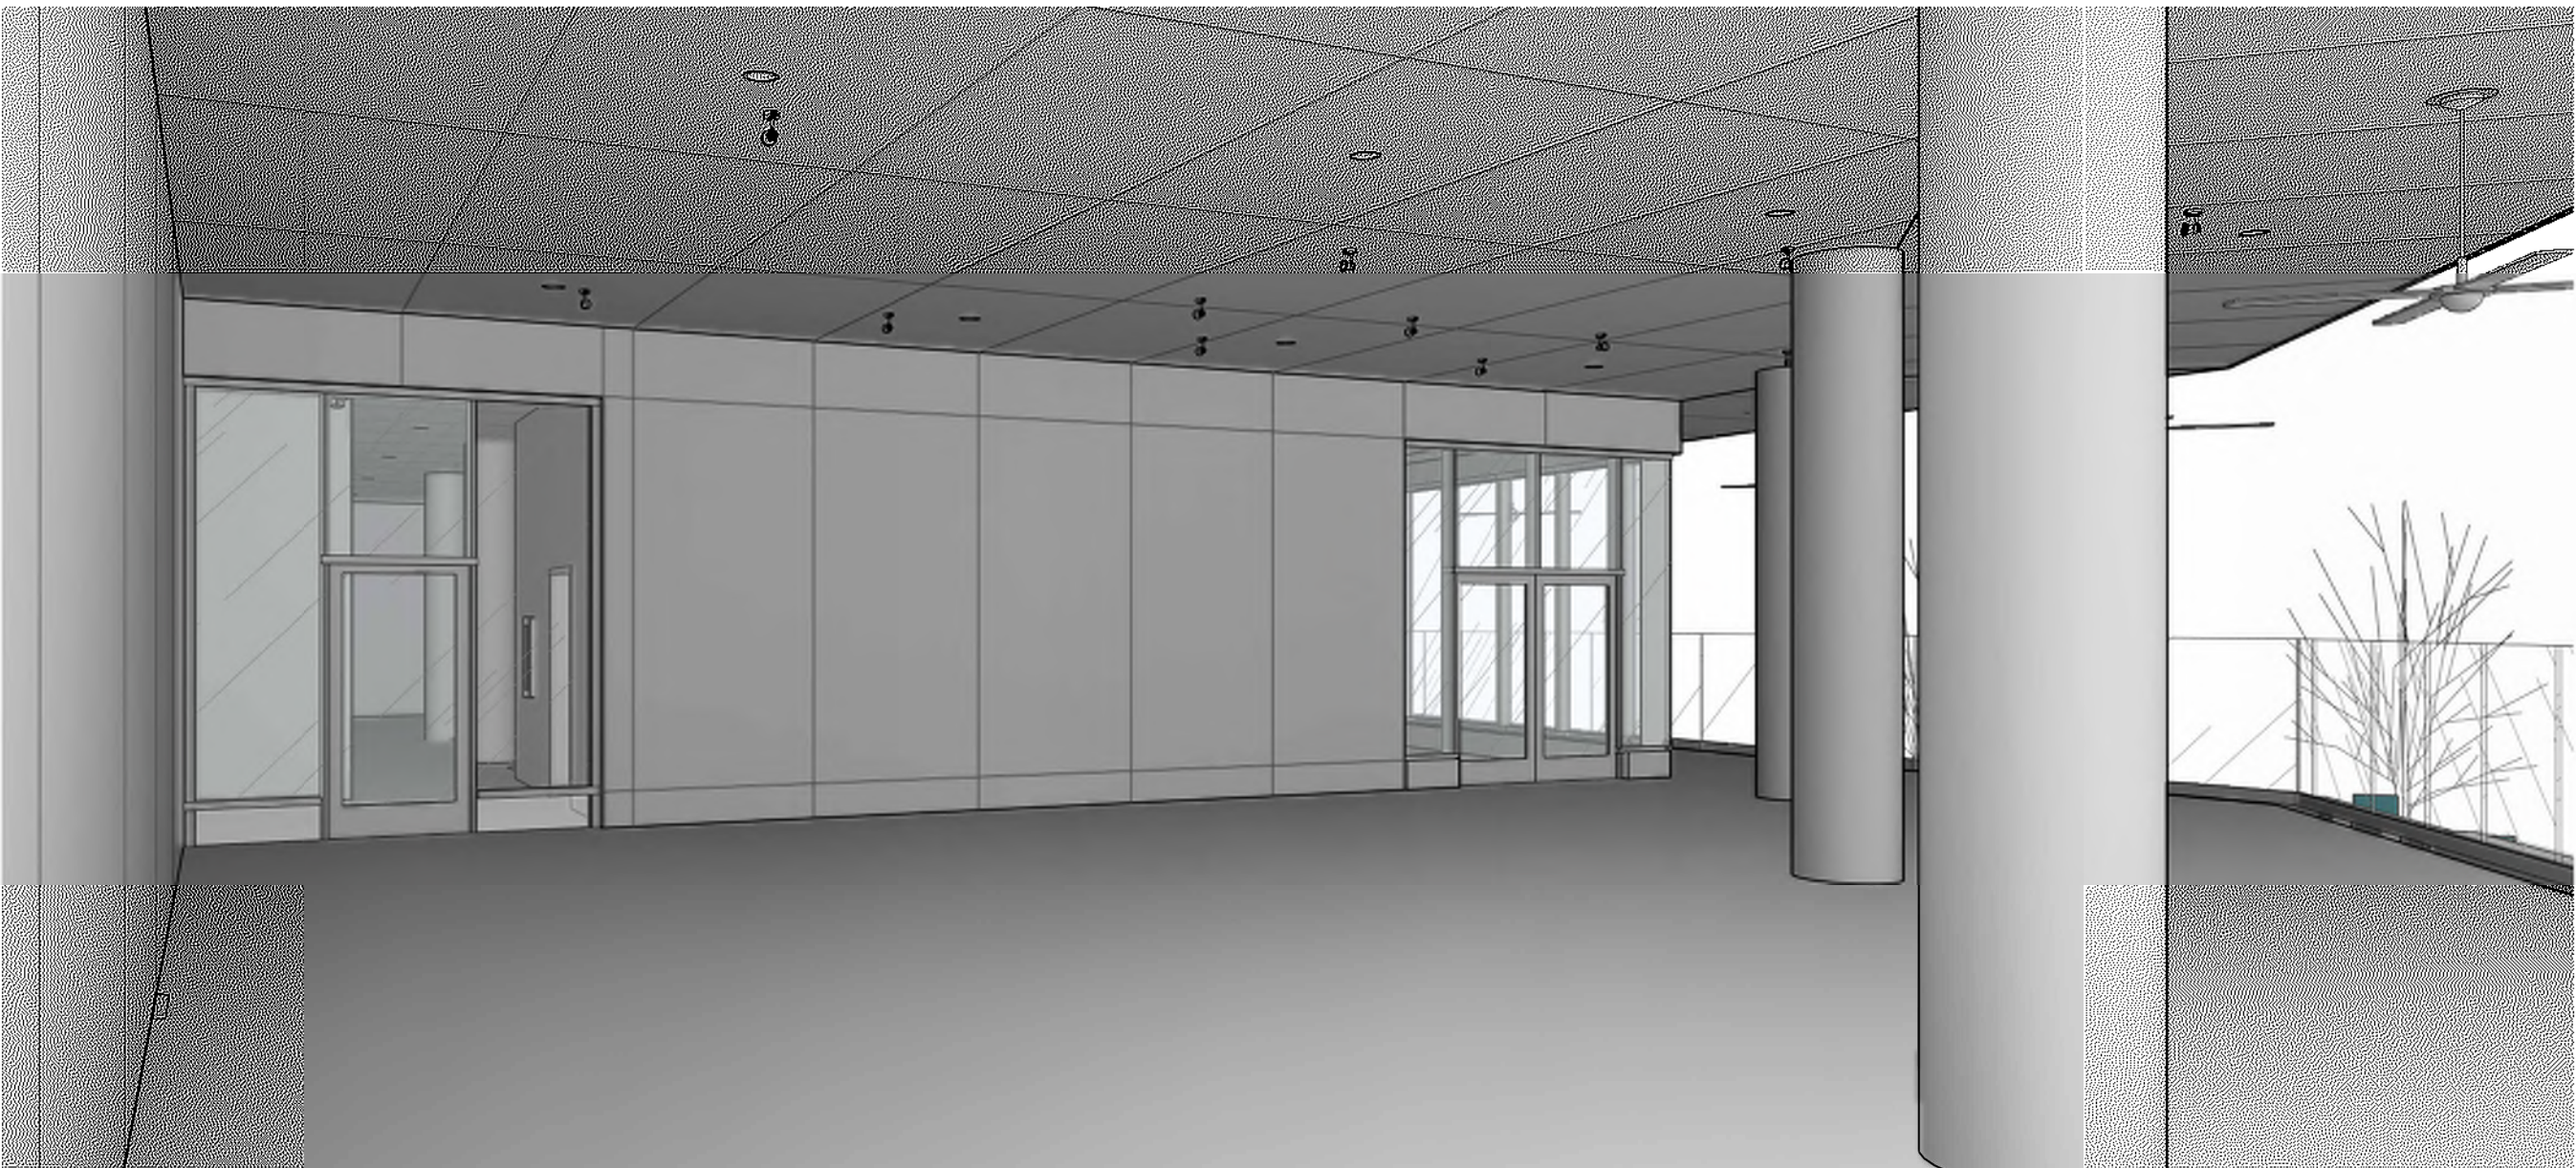
REVISIONS
20 DEC 2024 ADDENDUM 002
06 JAN 2025 ADDENDUM 005

SECOND FLOOR - REFLECTED
CEILING PLAN






5 VIEW FROM FIRST FLOOR ENTRANCE

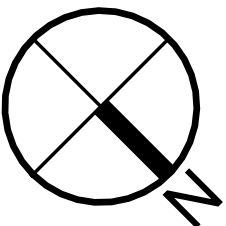


4 VIEW FROM MINI GOLF ON DECK



2 EXTERIOR VIEW 2

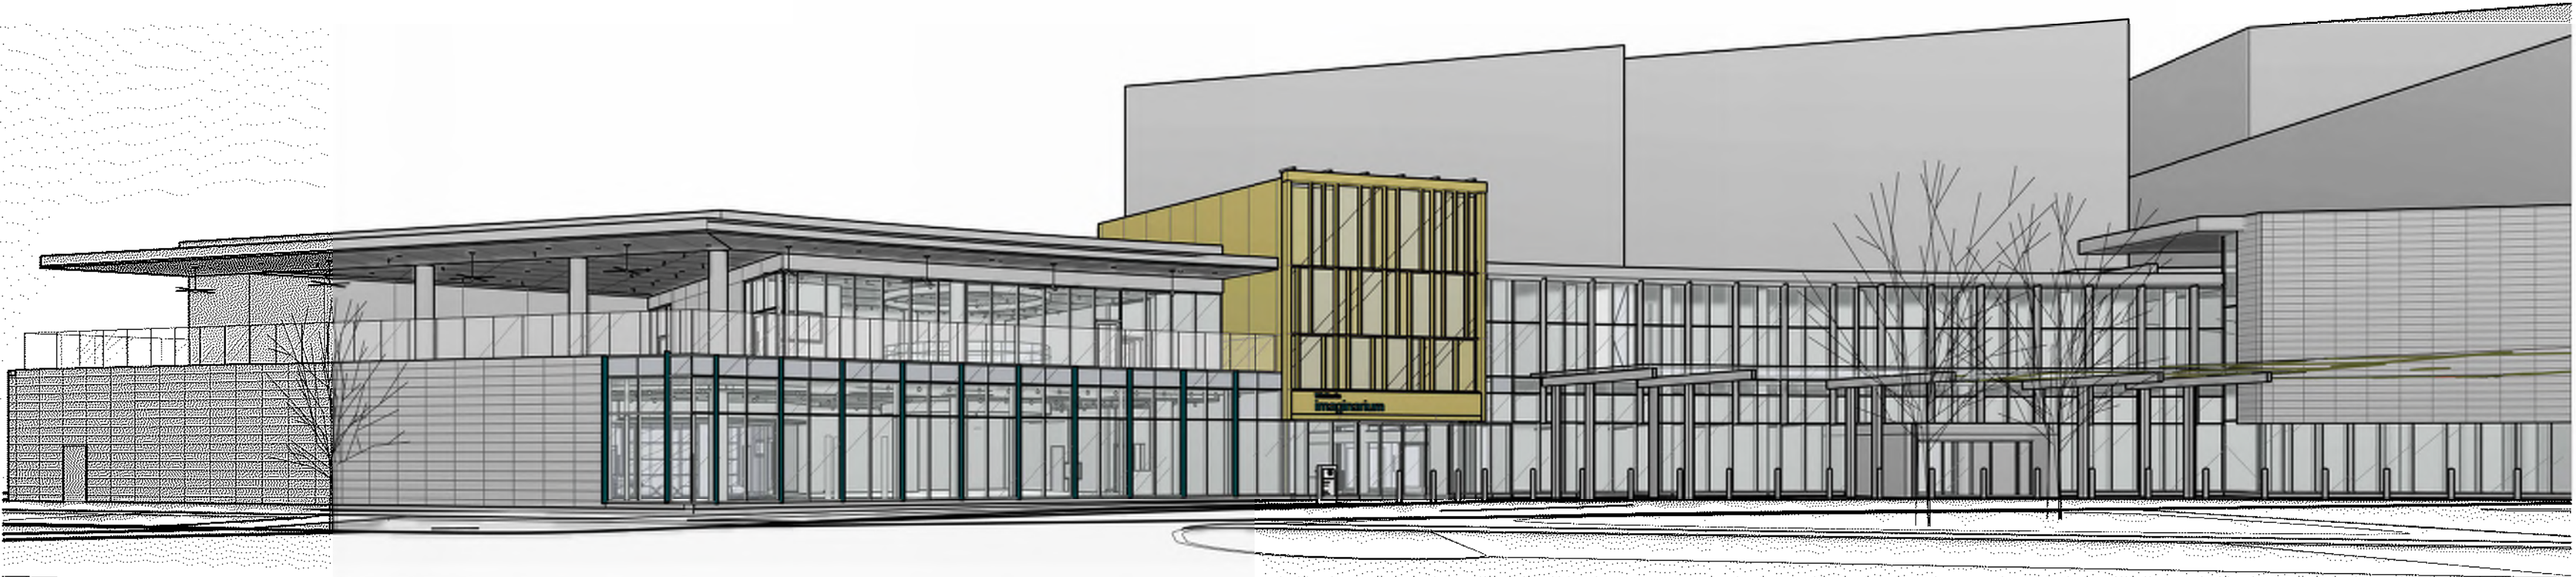

3 EXTERIOR VIEW 3

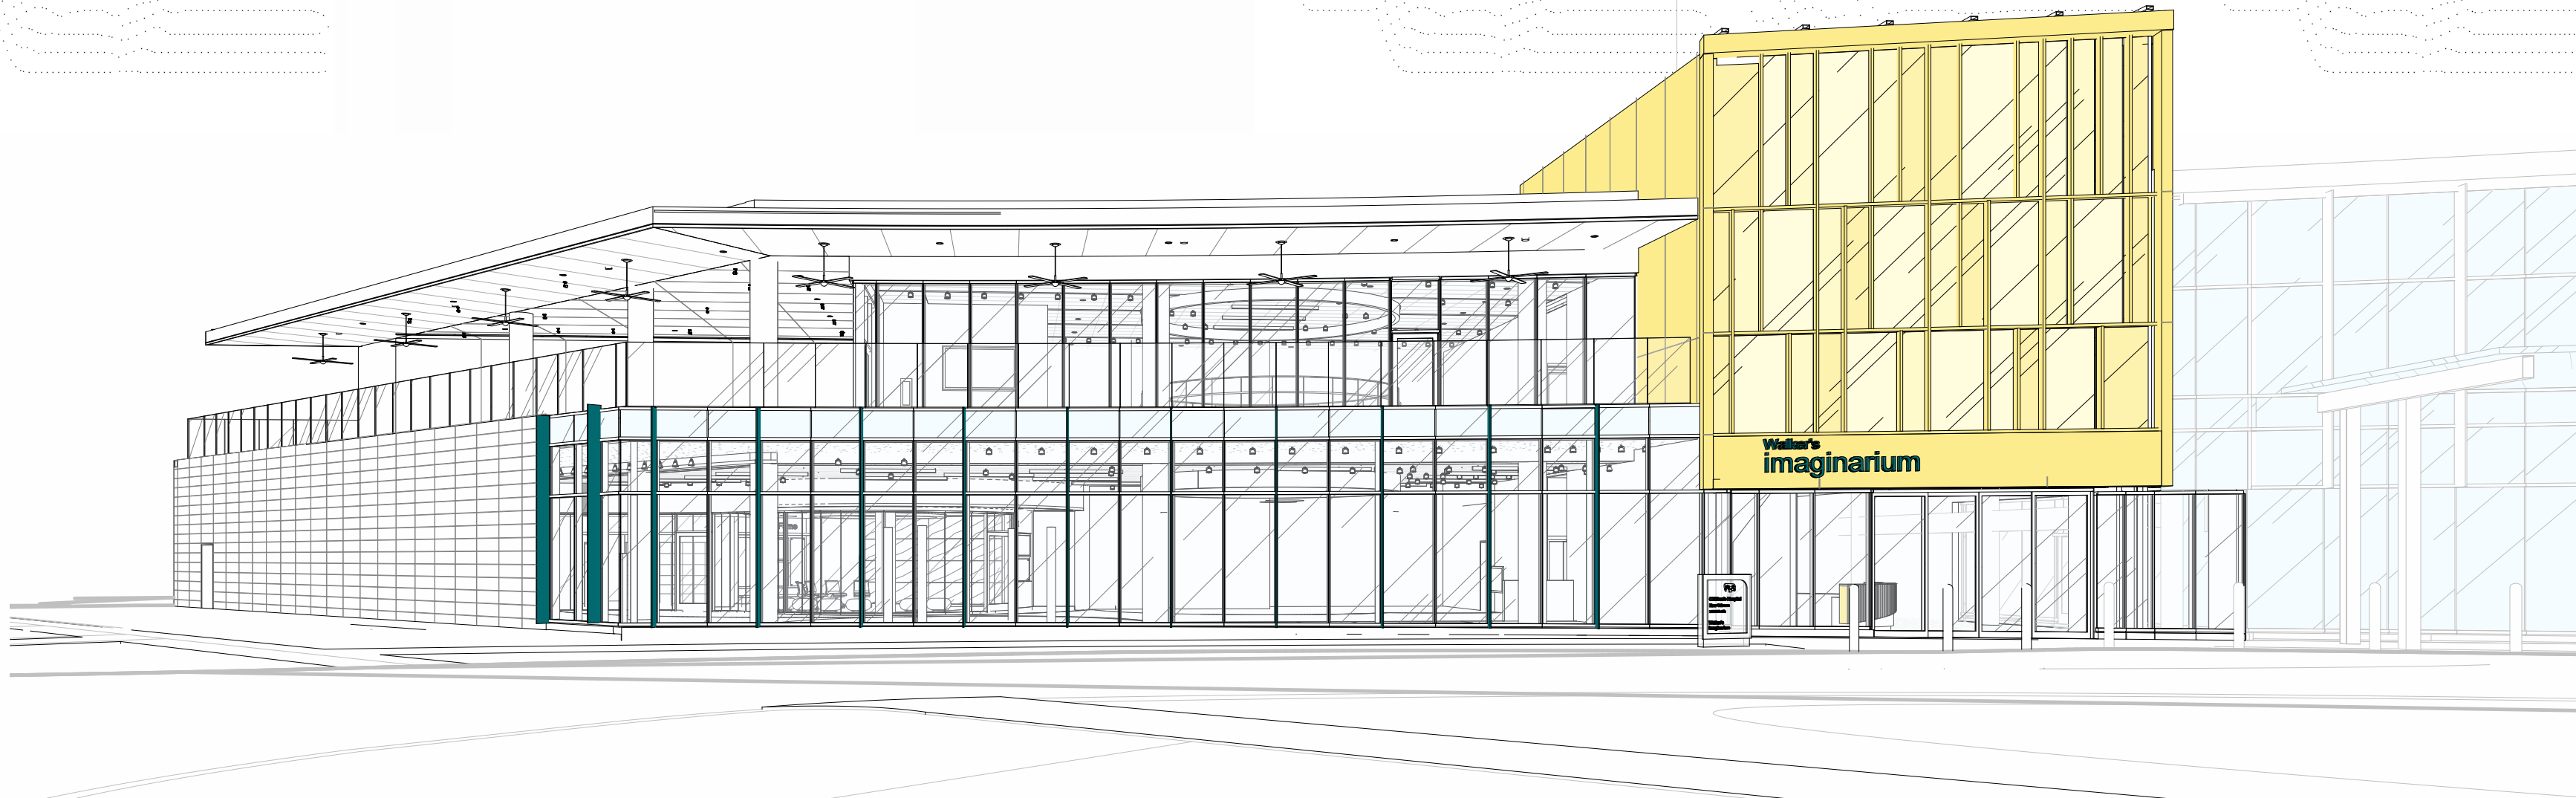

1 EXTERIOR VIEW 1

NOTE: The images included on this sheet are to convey the general design intent of the project and may not be totally accurate, therefore, should not be considered part of the contract documents

ESKEW+DUMEZ+RIPPLE

365 CANAL STREET, SUITE 3150
NEW ORLEANS, LOUISIANA 70130

WALKER'S IMAGINARIUM

200 HENRY CLAY AVENUE
NEW ORLEANS, LA 70118

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REVISIONS

PICTORAL VIEWS



02 VIEW FROM TCHOUPITOULAS ST
12" = 1'-0"



03 EXT. RENDER FROM ENTRY
12" = 1'-0"



01 EXT. RENDER FROM HENRY CLAY AVE
12" = 1'-0"

WALKER'S IMAGINARIUM

200 HENRY CLAY AVENUE
NEW ORLEANS, LA 70118
EDR PROJECT NO. | 22003

PROJECT ISSUE DATE | 02 DECEMBER 2024


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REVISIONS

PICTORAL VIEWS



1 FIRST FLOOR PLAN - LIGHTING

1/8" = 1'-0"

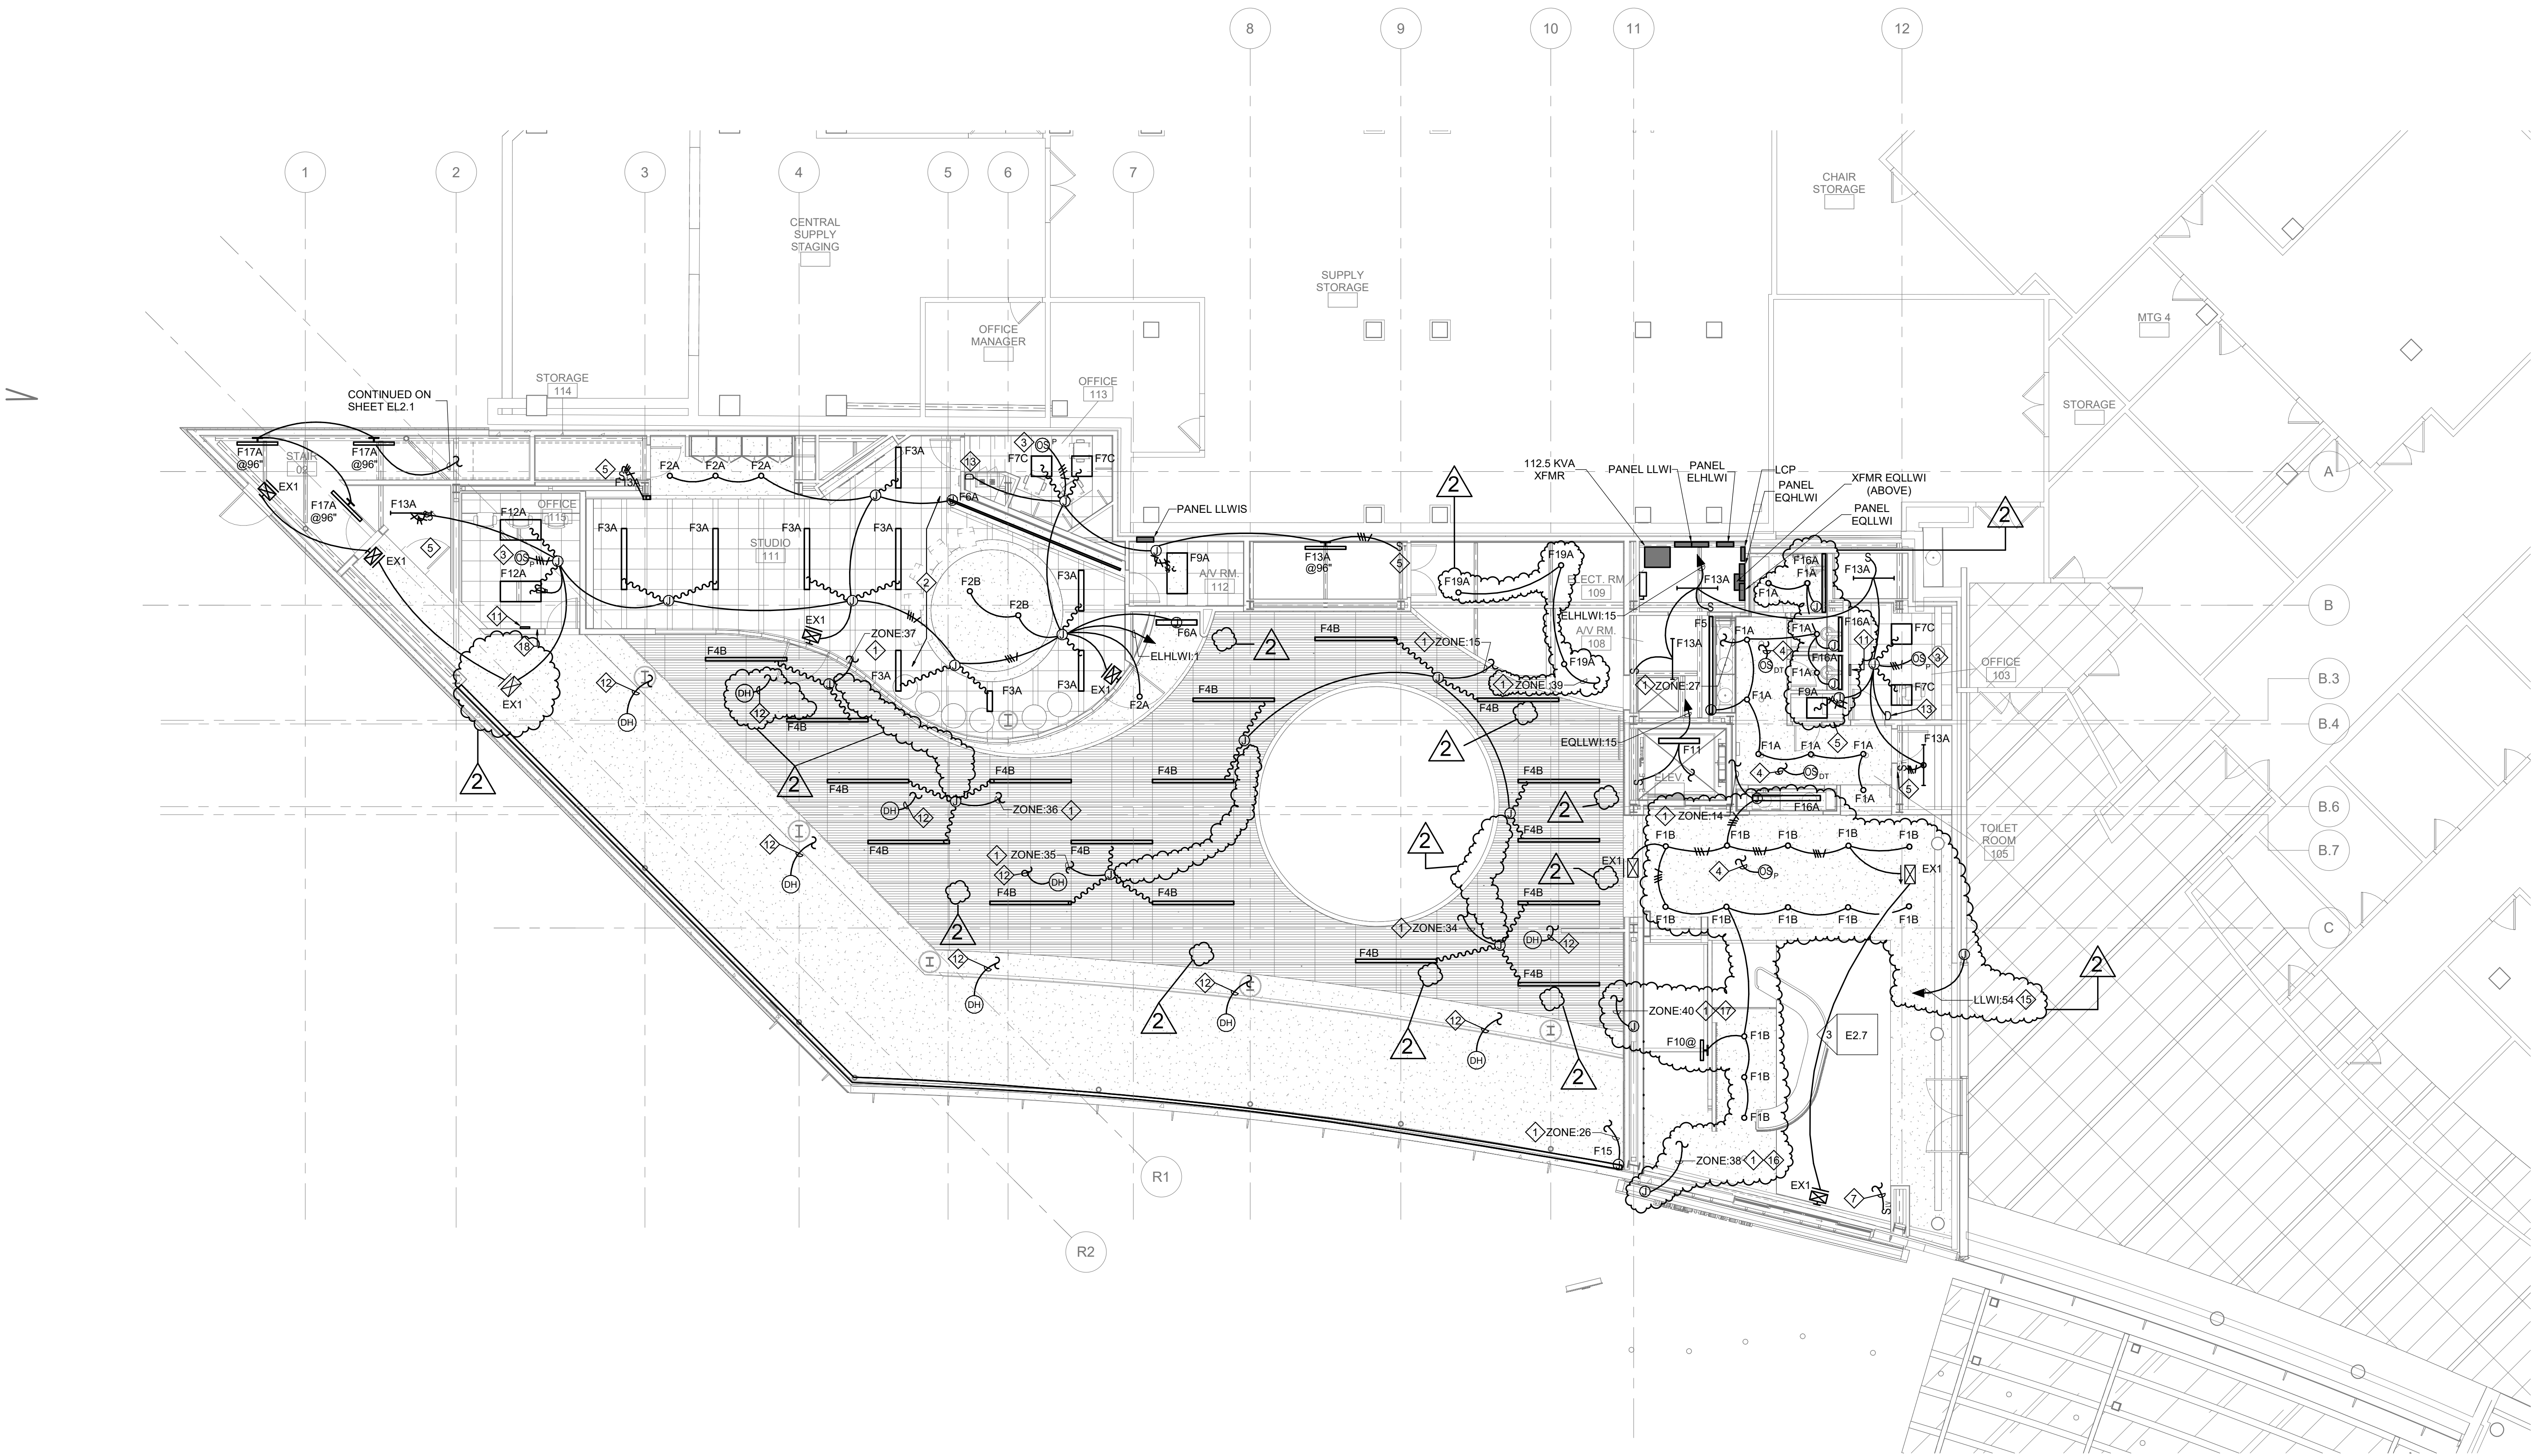EskewDumezRipple

NEW ORLEANS, LA | WASHINGTON, DC

IMC CONSULTING ENGINEERS INC.

2714 INDEPENDENCE STREET
METAIRIE, LOUISIANA 70006

GENERAL NOTES (LIGHTING)

- SEE LIGHTING CONTROL PANEL SCHEDULE ON SHEET E5.0 FOR ZONE CIRCUITING.
- REFER TO EXHIBIT CONSULTANT DRAWINGS AND TECHNICAL DOCUMENTS FOR ADDITIONAL LIGHTING REQUIREMENTS. INFORMATION IS NOT REPEATED ON THESE PLANS.
- REFER TO RYAN SEACREST FOUNDATION DRAWINGS AND TECHNICAL DOCUMENTS FOR ADDITIONAL LIGHTING REQUIREMENTS.

SPECIFIC NOTES (LIGHTING)

(NOT ALL NOTES MAY APPLY TO THIS SHEET)

- ROUTE ZONE THROUGH LIGHTING CONTROL PANEL. SEE LIGHTING CONTROL PANEL SCHEDULE FOR CIRCUIT.
- PROVIDE 277V CONNECTION TO LIGHTING FIXTURES SPECIFIED BY STUDIO LIGHTING CONSULTANT. ALL STUDIO LIGHTING CONTROLS BY STUDIO LIGHTING CONSULTANT.
- PROVIDE LINE VOLTAGE CEILING-MOUNTED PIR OCCUPANCY SENSOR WITH 0-10 VOLT LINEAR DIMMING. SWITCH SHALL REQUIRE A NEUTRAL CONNECTION.
- PROVIDE LOW-VOLTAGE DUAL-TECH OCCUPANCY SENSOR (PIR / ACOUSTIC) PROGRAMMED AS SPECIFIED ON PLAN. CONNECT TO LOCAL ROOM CONTROLLER WITH CAT 5 CABLE.
- PROVIDE LINE VOLTAGE DIGITAL TIMER SWITCH ADJUSTABLE FROM 1-12 HOURS. MINIMUM. SWITCH SHALL REQUIRE A NEUTRAL CONNECTION.
- PROVIDE LINE VOLTAGE COMBINATION WALL SWITCH / DUAL TECH (PIR / ACOUSTIC) OCCUPANCY SENSOR WITH 0-10 VOLT LINEAR DIMMING. SWITCH SHALL REQUIRE A NEUTRAL CONNECTION.
- PROVIDE 2-BUTTON LIGHTSYNC DIGITAL G3 SWITCH. BUTTON 1: TIMED OVERRIDE - ALL ON. SCENE 2: TIMED OVERRIDE - COURTESY LIGHTING ON. ROUTE DEVICE THROUGH LIGHTING CONTROL PANEL.
- CONNECT TO EXISTING LIGHTING CIRCUIT SERVING THIS AREA.
- CONNECT TO EXISTING NORMAL POWER CORRIDOR LIGHTING CIRCUIT AND CONTROLS.
- CONNECT TO EXISTING LIFE SAFETY CORRIDOR LIGHTING CIRCUIT AND CONTROLS.
- PROVIDE LIGHTSYNC DIGITAL TOUCH SCREEN 2. COORDINATE EXACT LOCATION WITH ARCHITECT PRIOR TO ROUGH-IN. ROUTE DEVICE THROUGH LIGHTING CONTROL PANEL.
- PROVIDE DIGITAL CEILING DAYLIGHT HARVESTING SENSOR. ROUTE DEVICE THROUGH LIGHTING CONTROL PANEL.
- PROVIDE LED-COMPATIBLE WALLBOX DIMMER COMPATIBLE WITH FIXTURE. WIRE PER MANUFACTURER'S INSTRUCTIONS.
- PROVIDE LOW VOLTAGE PHOTOCELL AND CONNECT TO LIGHTING CONTROL PANEL.
- PROVIDE 120 VOLT POWER FOR ILLUMINATED SPONSOR SIGNAGE.
- PROVIDE 277 VOLT POWER FOR EXTERIOR BUILDING SIGNAGE. COORDINATE EXACT LOCATION WITH ARCHITECT PRIOR TO ROUGH-IN.
- PROVIDE 277V POWER FOR MATCHSTICK LIGHTING IN LOBBY WALL. SEE DETAIL 3 (ELEVATION 1 - A) ON SHEET E.2.7.

WALKER'S IMAGINARIUM

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NEW ORLEANS, LA 70118

EDR PROJECT NO. | 22003

PROJECT ISSUE DATE | 2 DEC 2024

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REVISIONS	
2-09-24	ADDENDUM 001
2-20-24	ADDENDUM 002

FIRST FLOOR PLAN - LIGHTING

DRAWN BY | DN

EL2.0

GENERAL NOTES (LIGHTING)

- SEE LIGHTING CONTROL PANEL SCHEDULE ON SHEET E5.0 FOR ZONE CIRCUITING.
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- PROVIDE LINE VOLTAGE CEILING-MOUNTED PIR OCCUPANCY SENSOR WITH 0-10 VOLT LINEAR DIMMING. SWITCH SHALL REQUIRE A NEUTRAL CONNECTION.
- PROVIDE LOW-VOLTAGE DUAL-TECH OCCUPANCY SENSOR (PIR / ACOUSTIC), PROGRAMMED AS SPECIFIED ON PLAN. CONNECT TO LOCAL ROOM CONTROLLER WITH CAT 5 CABLE.
- PROVIDE LINE VOLTAGE DIGITAL TIMER SWITCH ADJUSTABLE FROM 1-12 HOURS. MINIMUM. SWITCH SHALL REQUIRE A NEUTRAL CONNECTION.
- PROVIDE LINE VOLTAGE COMBINATION WALL SWITCH / DUAL TECH (PIR / ACOUSTIC) OCCUPANCY SENSOR WITH 0-10 VOLT LINEAR DIMMING. SWITCH SHALL REQUIRE A NEUTRAL CONNECTION.
- PROVIDE 2-BUTTON LIGHTSYNC DIGITAL G3 SWITCH. BUTTON 1: TIMED OVERRIDE - ALL ON. SCENE 2: TIMED OVERRIDE - COURTESY LIGHTING ON. ROUTE DEVICE THROUGH LIGHTING CONTROL PANEL.
- CONNECT TO EXISTING LIGHTING CIRCUIT SERVING THIS AREA.
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- PROVIDE DIGITAL CEILING DAYLIGHT HARVESTING SENSOR. ROUTE DEVICE THROUGH LIGHTING CONTROL PANEL.
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- PROVIDE 120 VOLT POWER FOR ILLUMINATED SPONSOR SIGNAGE.
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- PROVIDE 277V POWER FOR MATCHSTICK LIGHTING IN LOBBY WALL. SEE DETAIL 3 (ELEVATION 1 - A) ON SHEET E.2.7.

WALKER'S IMAGINARIUM

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NEW ORLEANS, LA 70118

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REVISIONS

- | | |
|---------|--------------|
| 2-09-24 | ADDENDUM 001 |
| 2-20-24 | ADDENDUM 002 |


SECOND FLOOR PLAN - LIGHTING


DRAWN BY | DN

EL2.1


1 SECOND FLOOR PLAN - LIGHTING

1/8" = 1'-0"

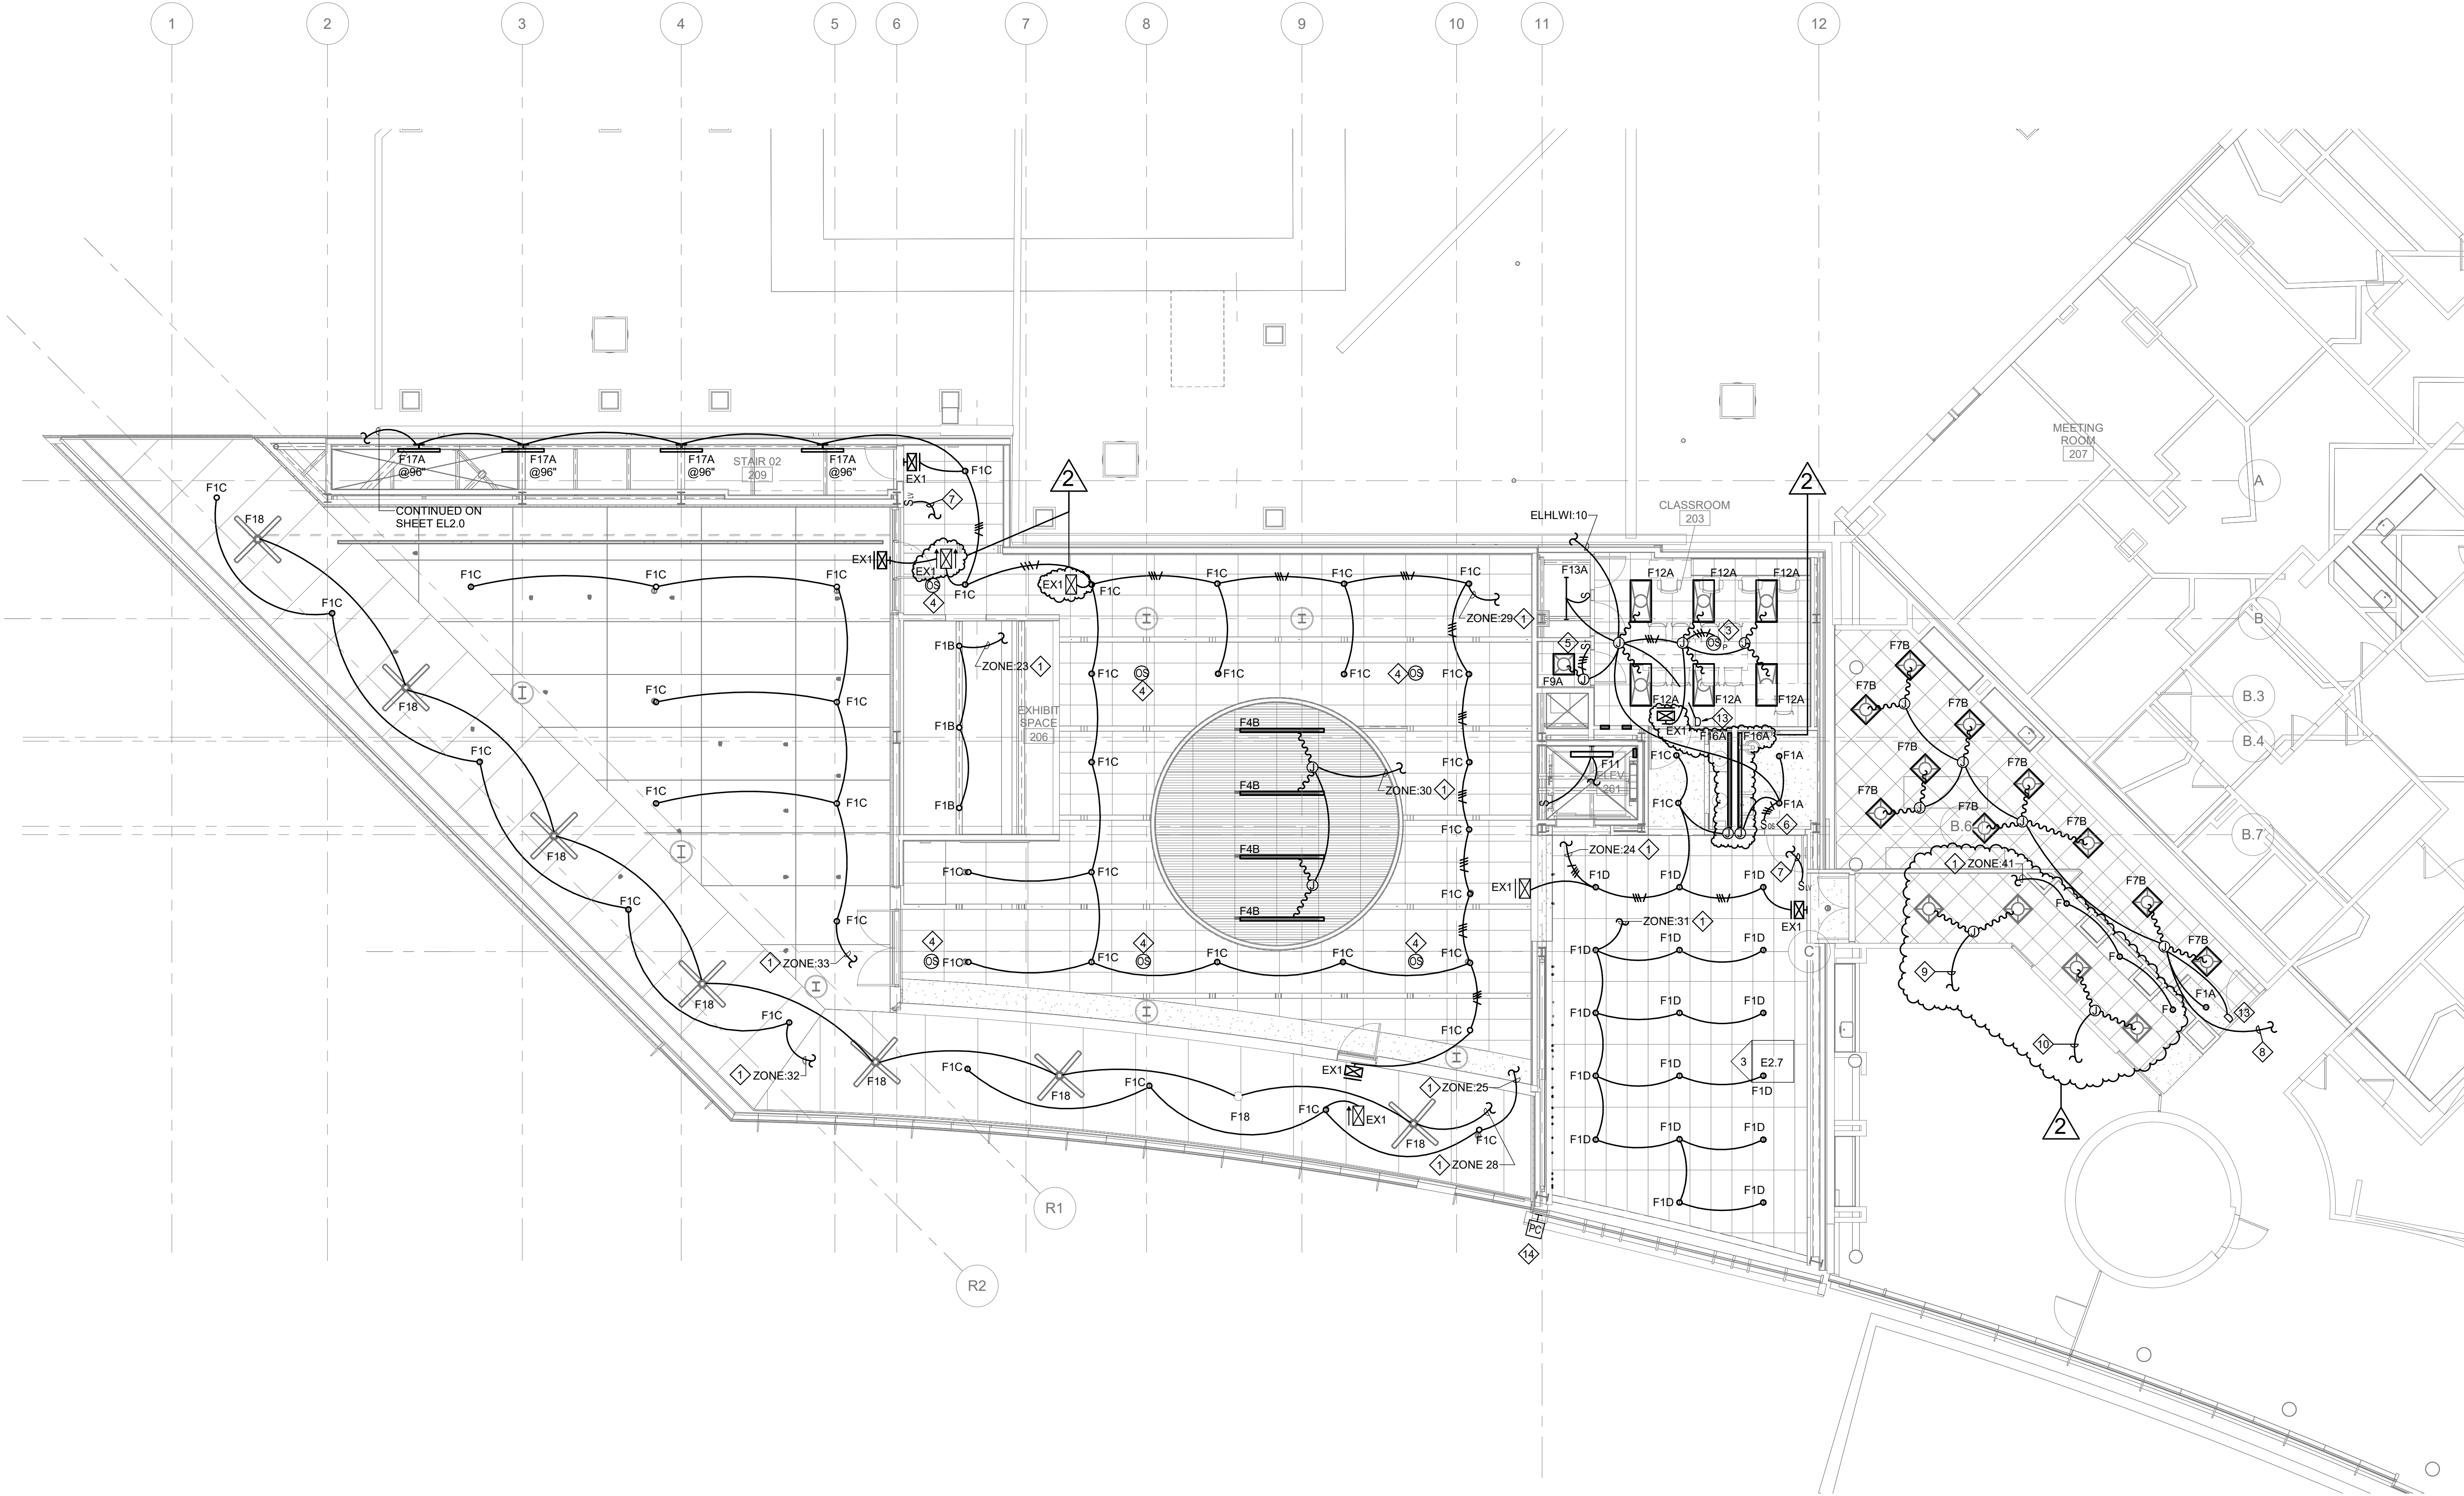


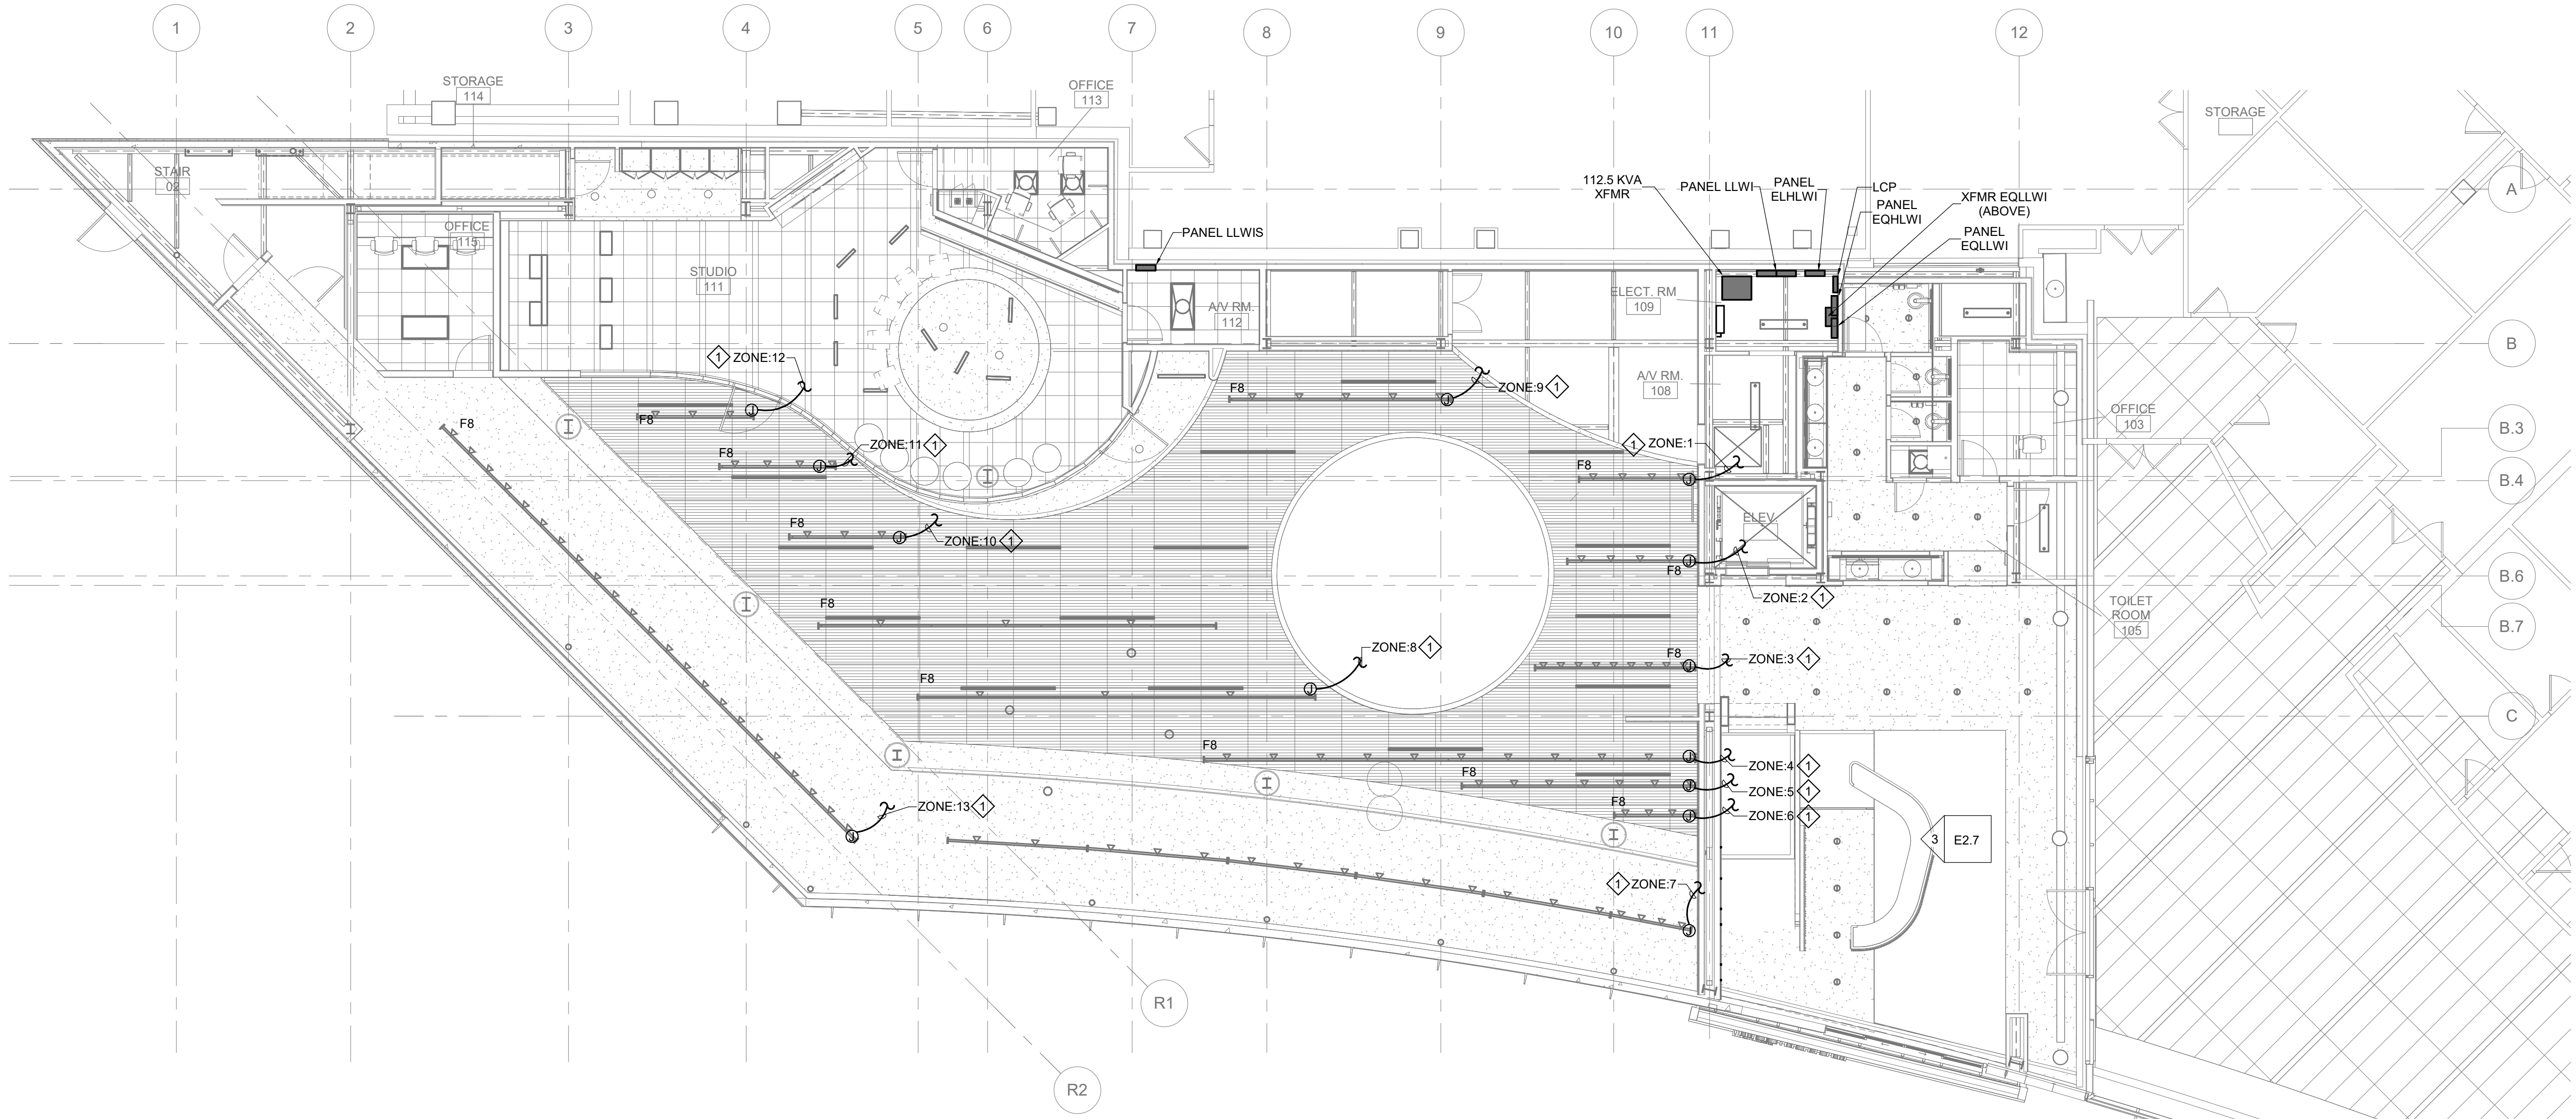


1 FIRST FLOOR PLAN - TRACK LIGHTING
1/8" = 1'-0"

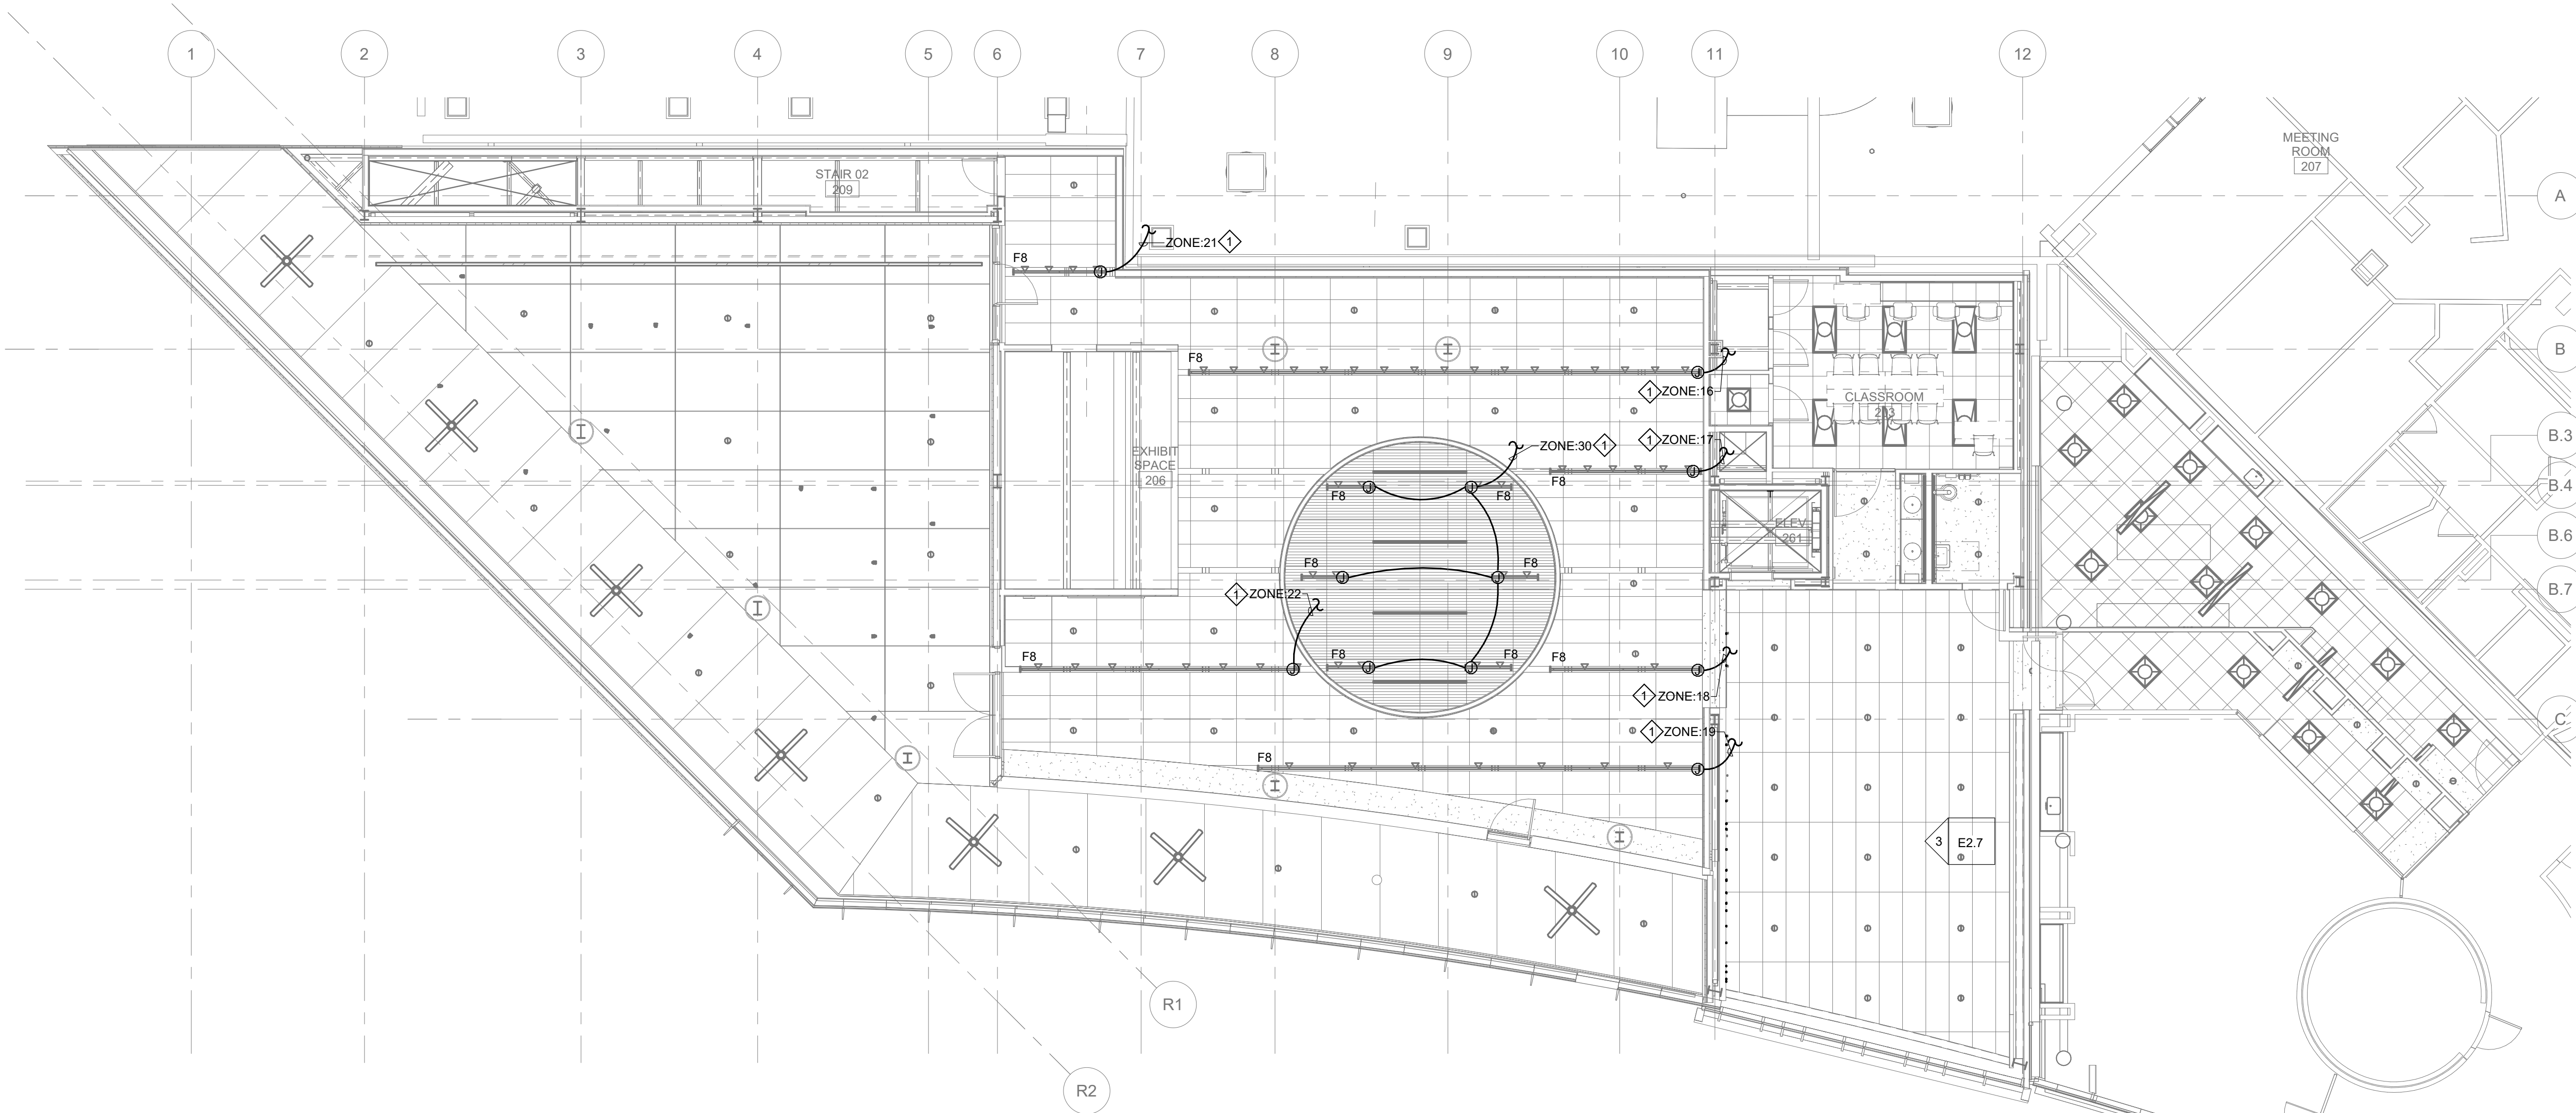

2 SECOND FLOOR PLAN - TRACK LIGHTING
1/8" = 1'-0"

SEE SHEET EL 2.1
FOR SPECIFIC NOTES

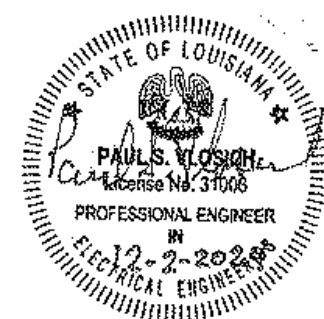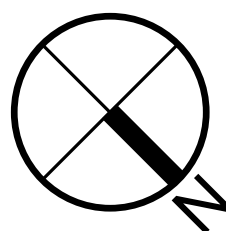

WALKER'S IMAGINARIUM

200 HENRY CLAY AVENUE
NEW ORLEANS, LA 70118

EDR PROJECT NO. | 22003

PROJECT ISSUE DATE | 2 DEC 2024

100% CD

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A Professional Corporation

The intent of the Contract Documents is to include all items necessary for proper execution and completion of the work by Contractor. The Contract Documents are complementary, and what is required by one shall be as binding as if required by all; performance by the Contractor shall be required only to the extent consistent with the Contract Documents and reasonably inferable from them as being necessary to produce the indicated results.

REVISIONS	
2-09-24	ADDENDUM 001
2-20-24	ADDENDUM 002

**FIRST & SECOND FLOOR PLAN -
TRACK LIGHTING**

DRAWN BY | DN

EL2.2