
















**METROSTUDIO** 


Magazine & Jefferson **EXISTING CONDITIONS** 

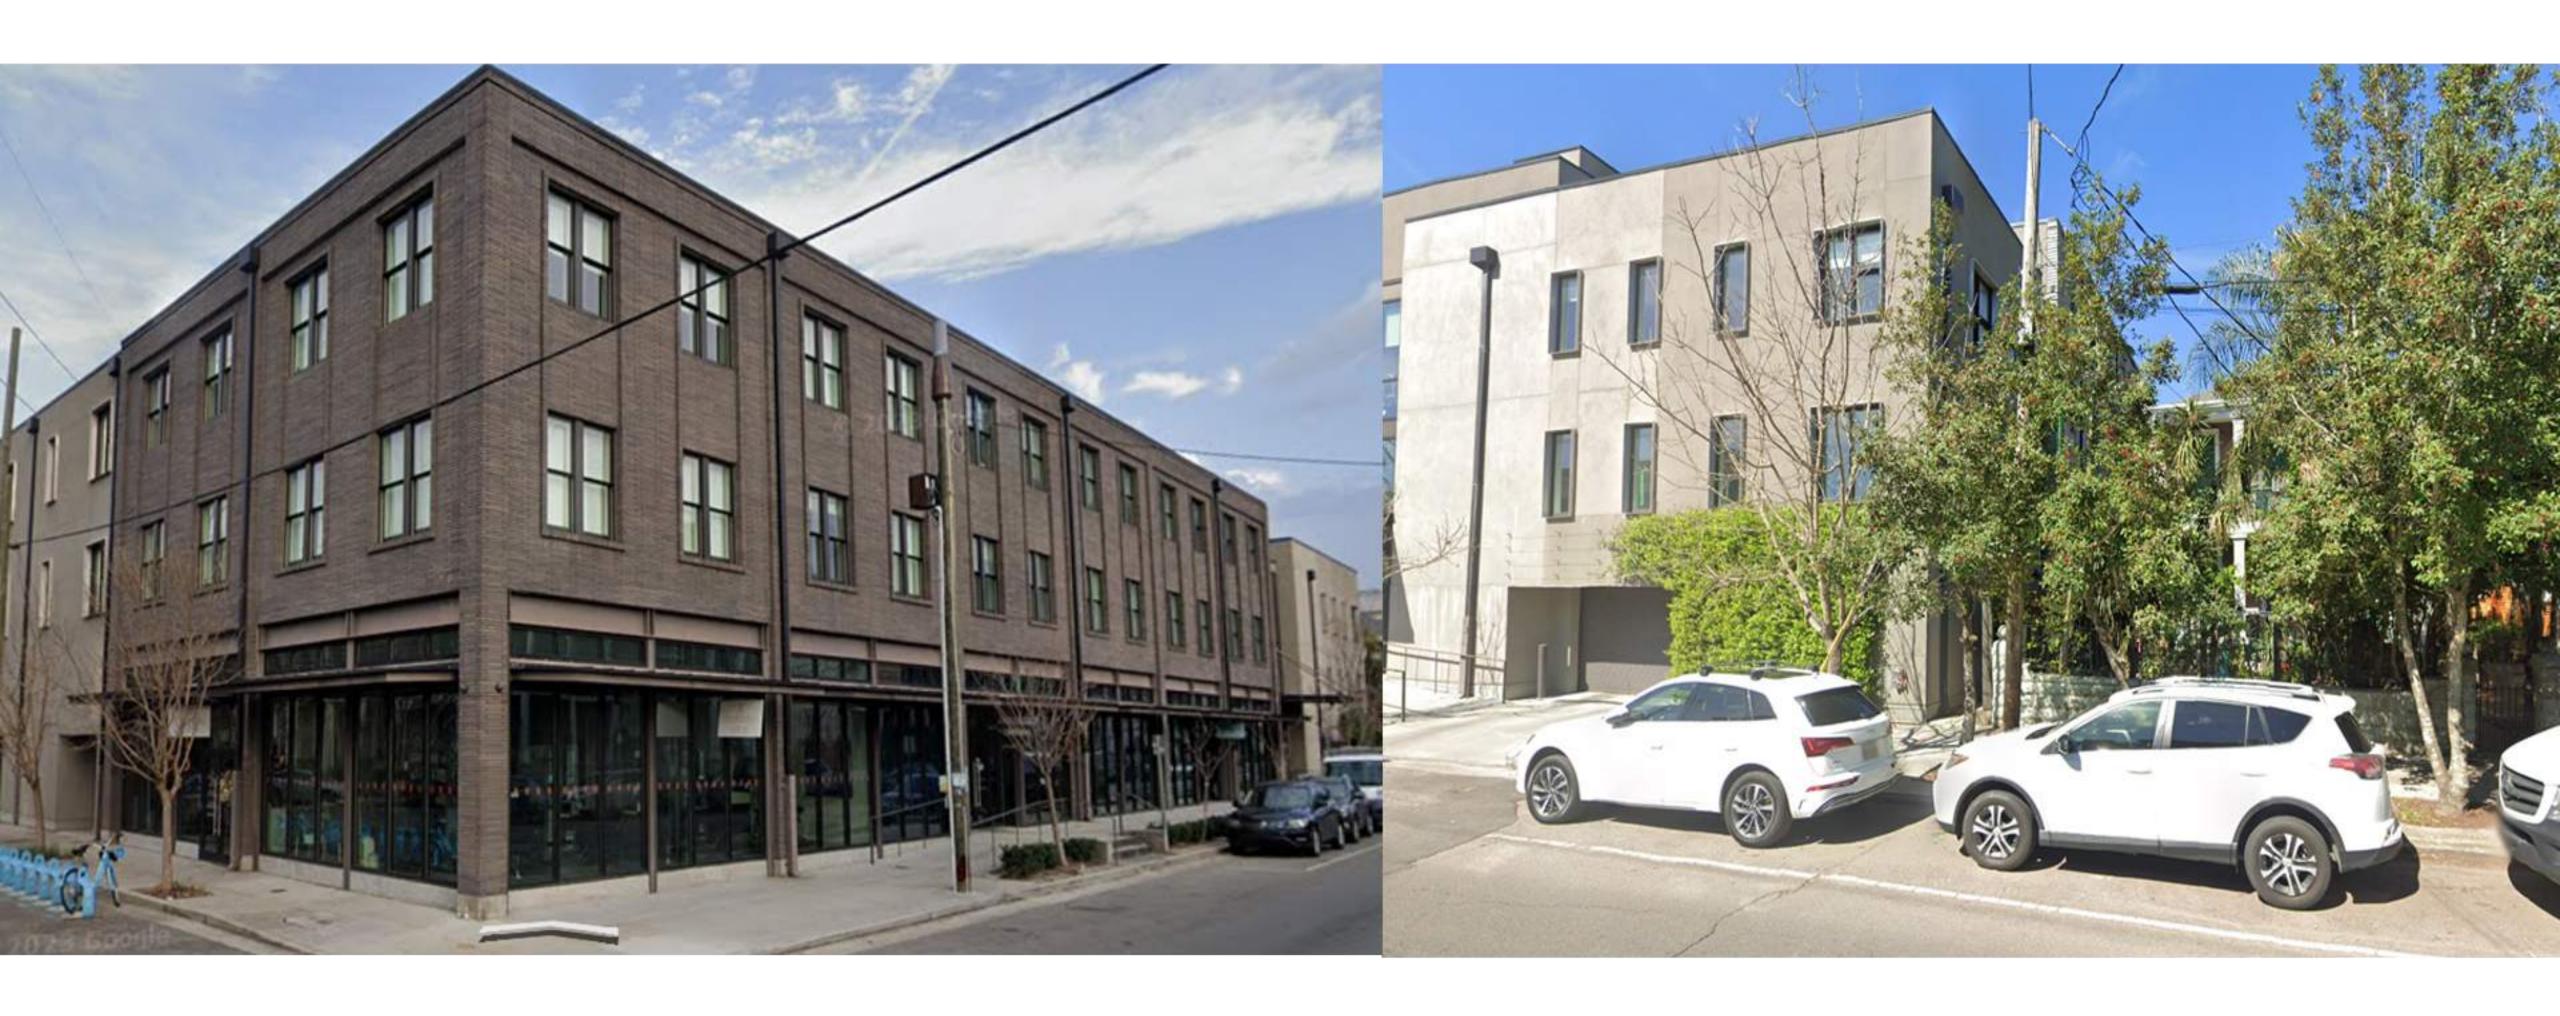







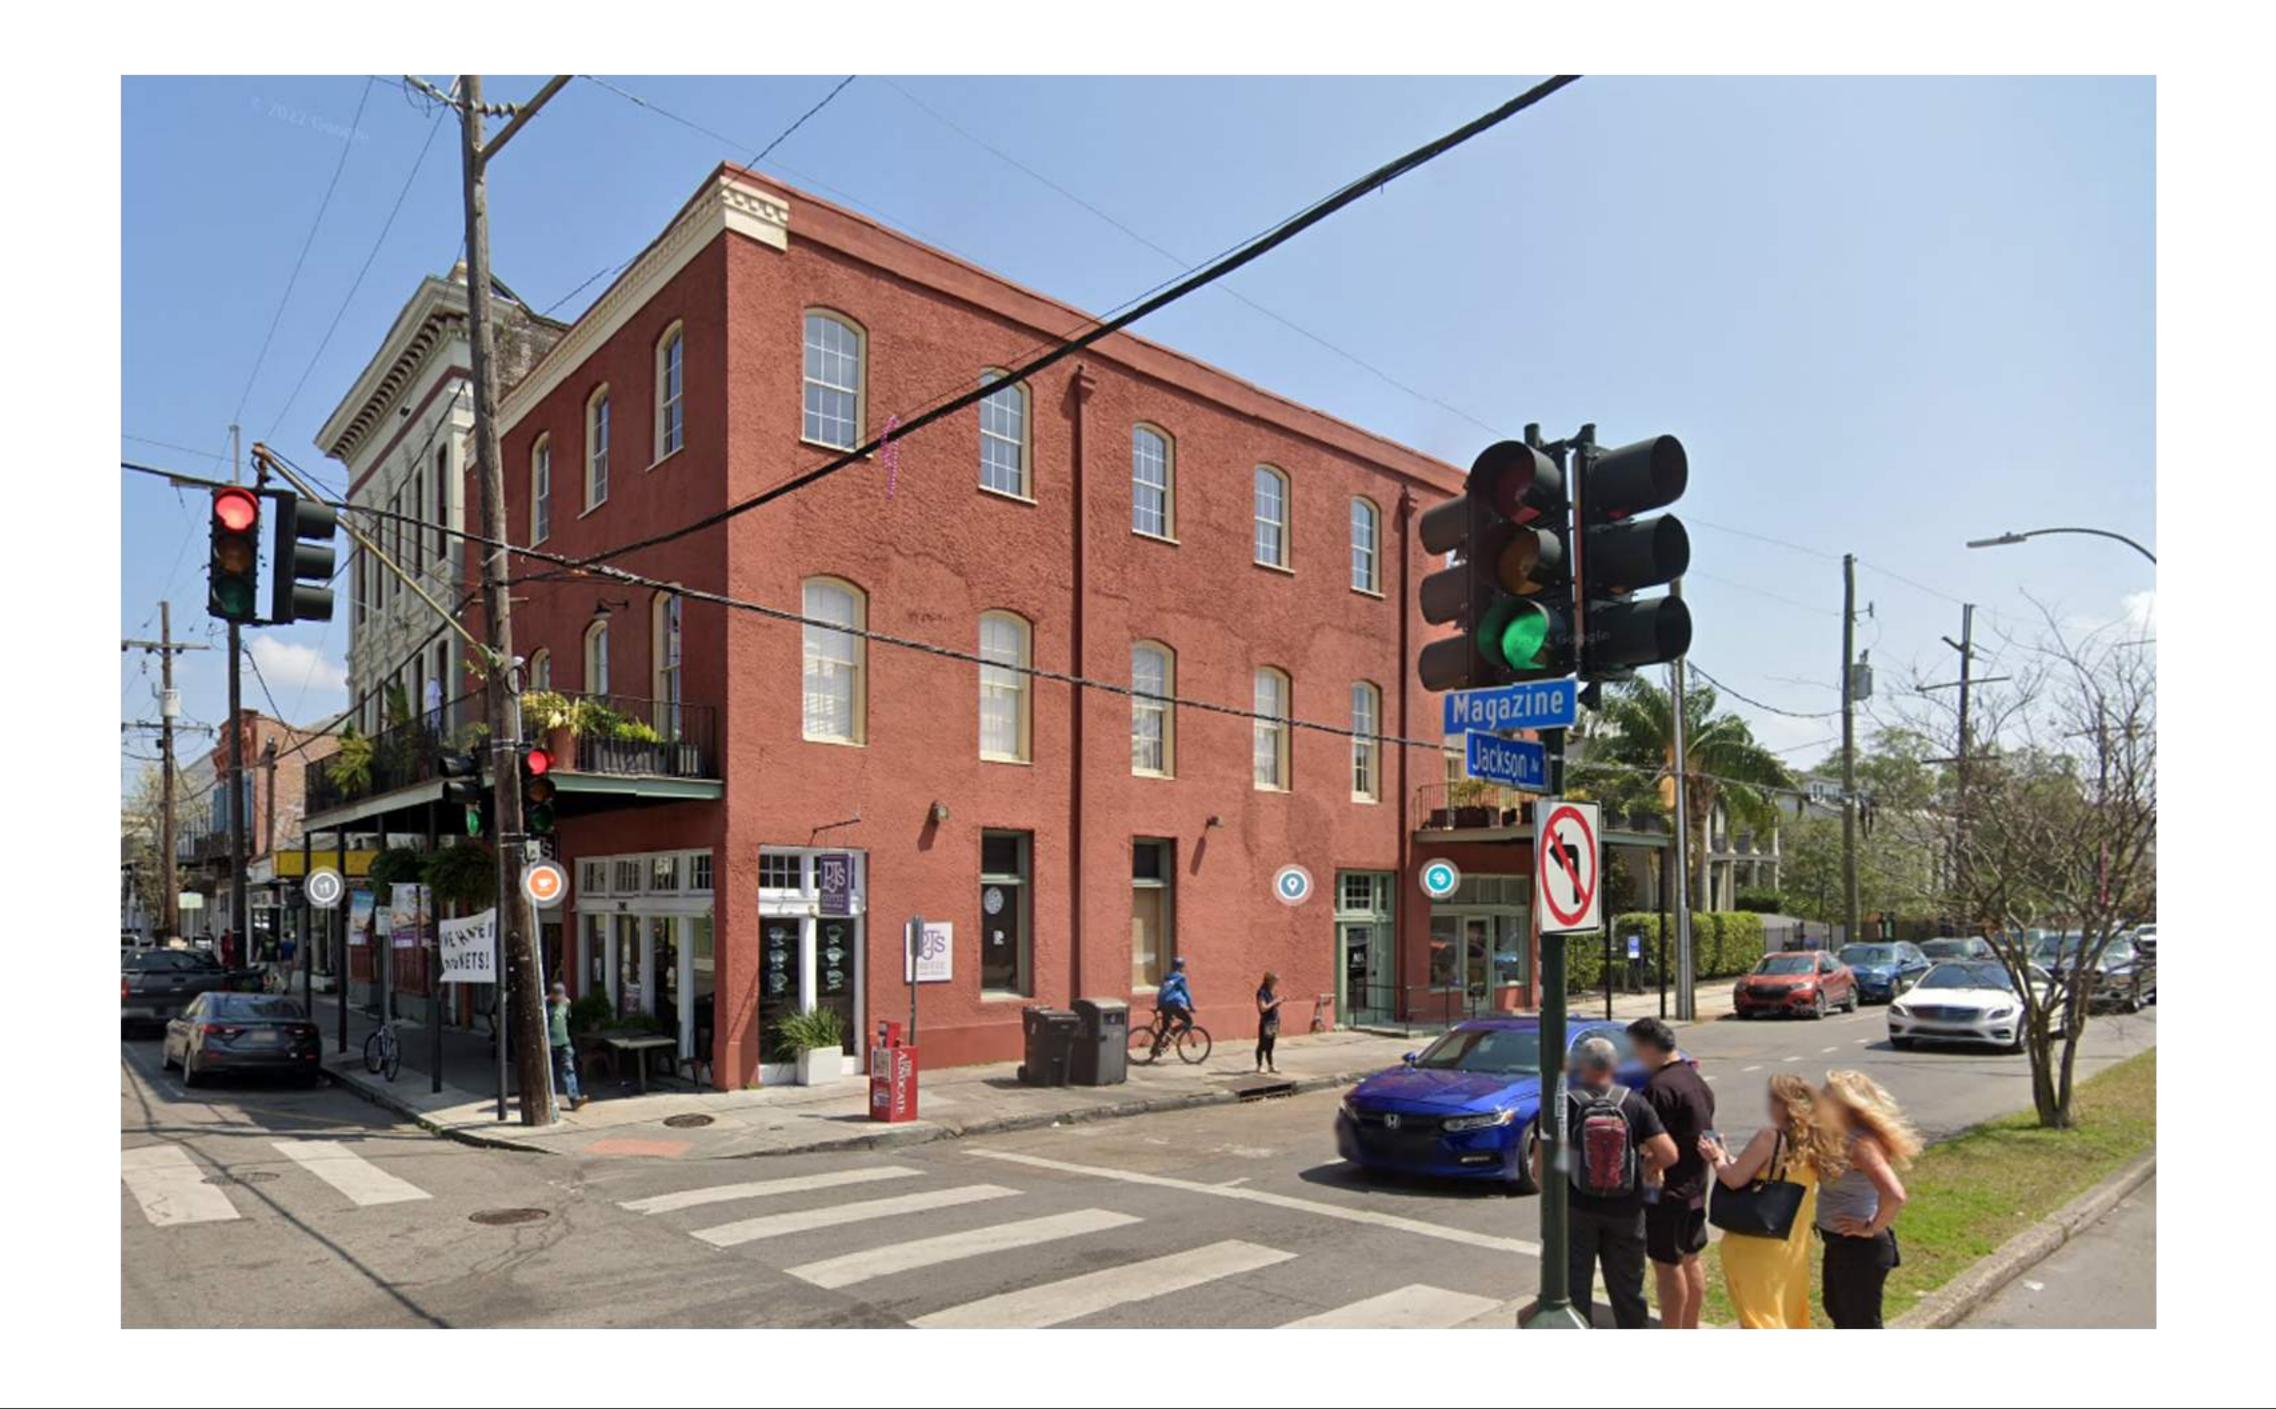













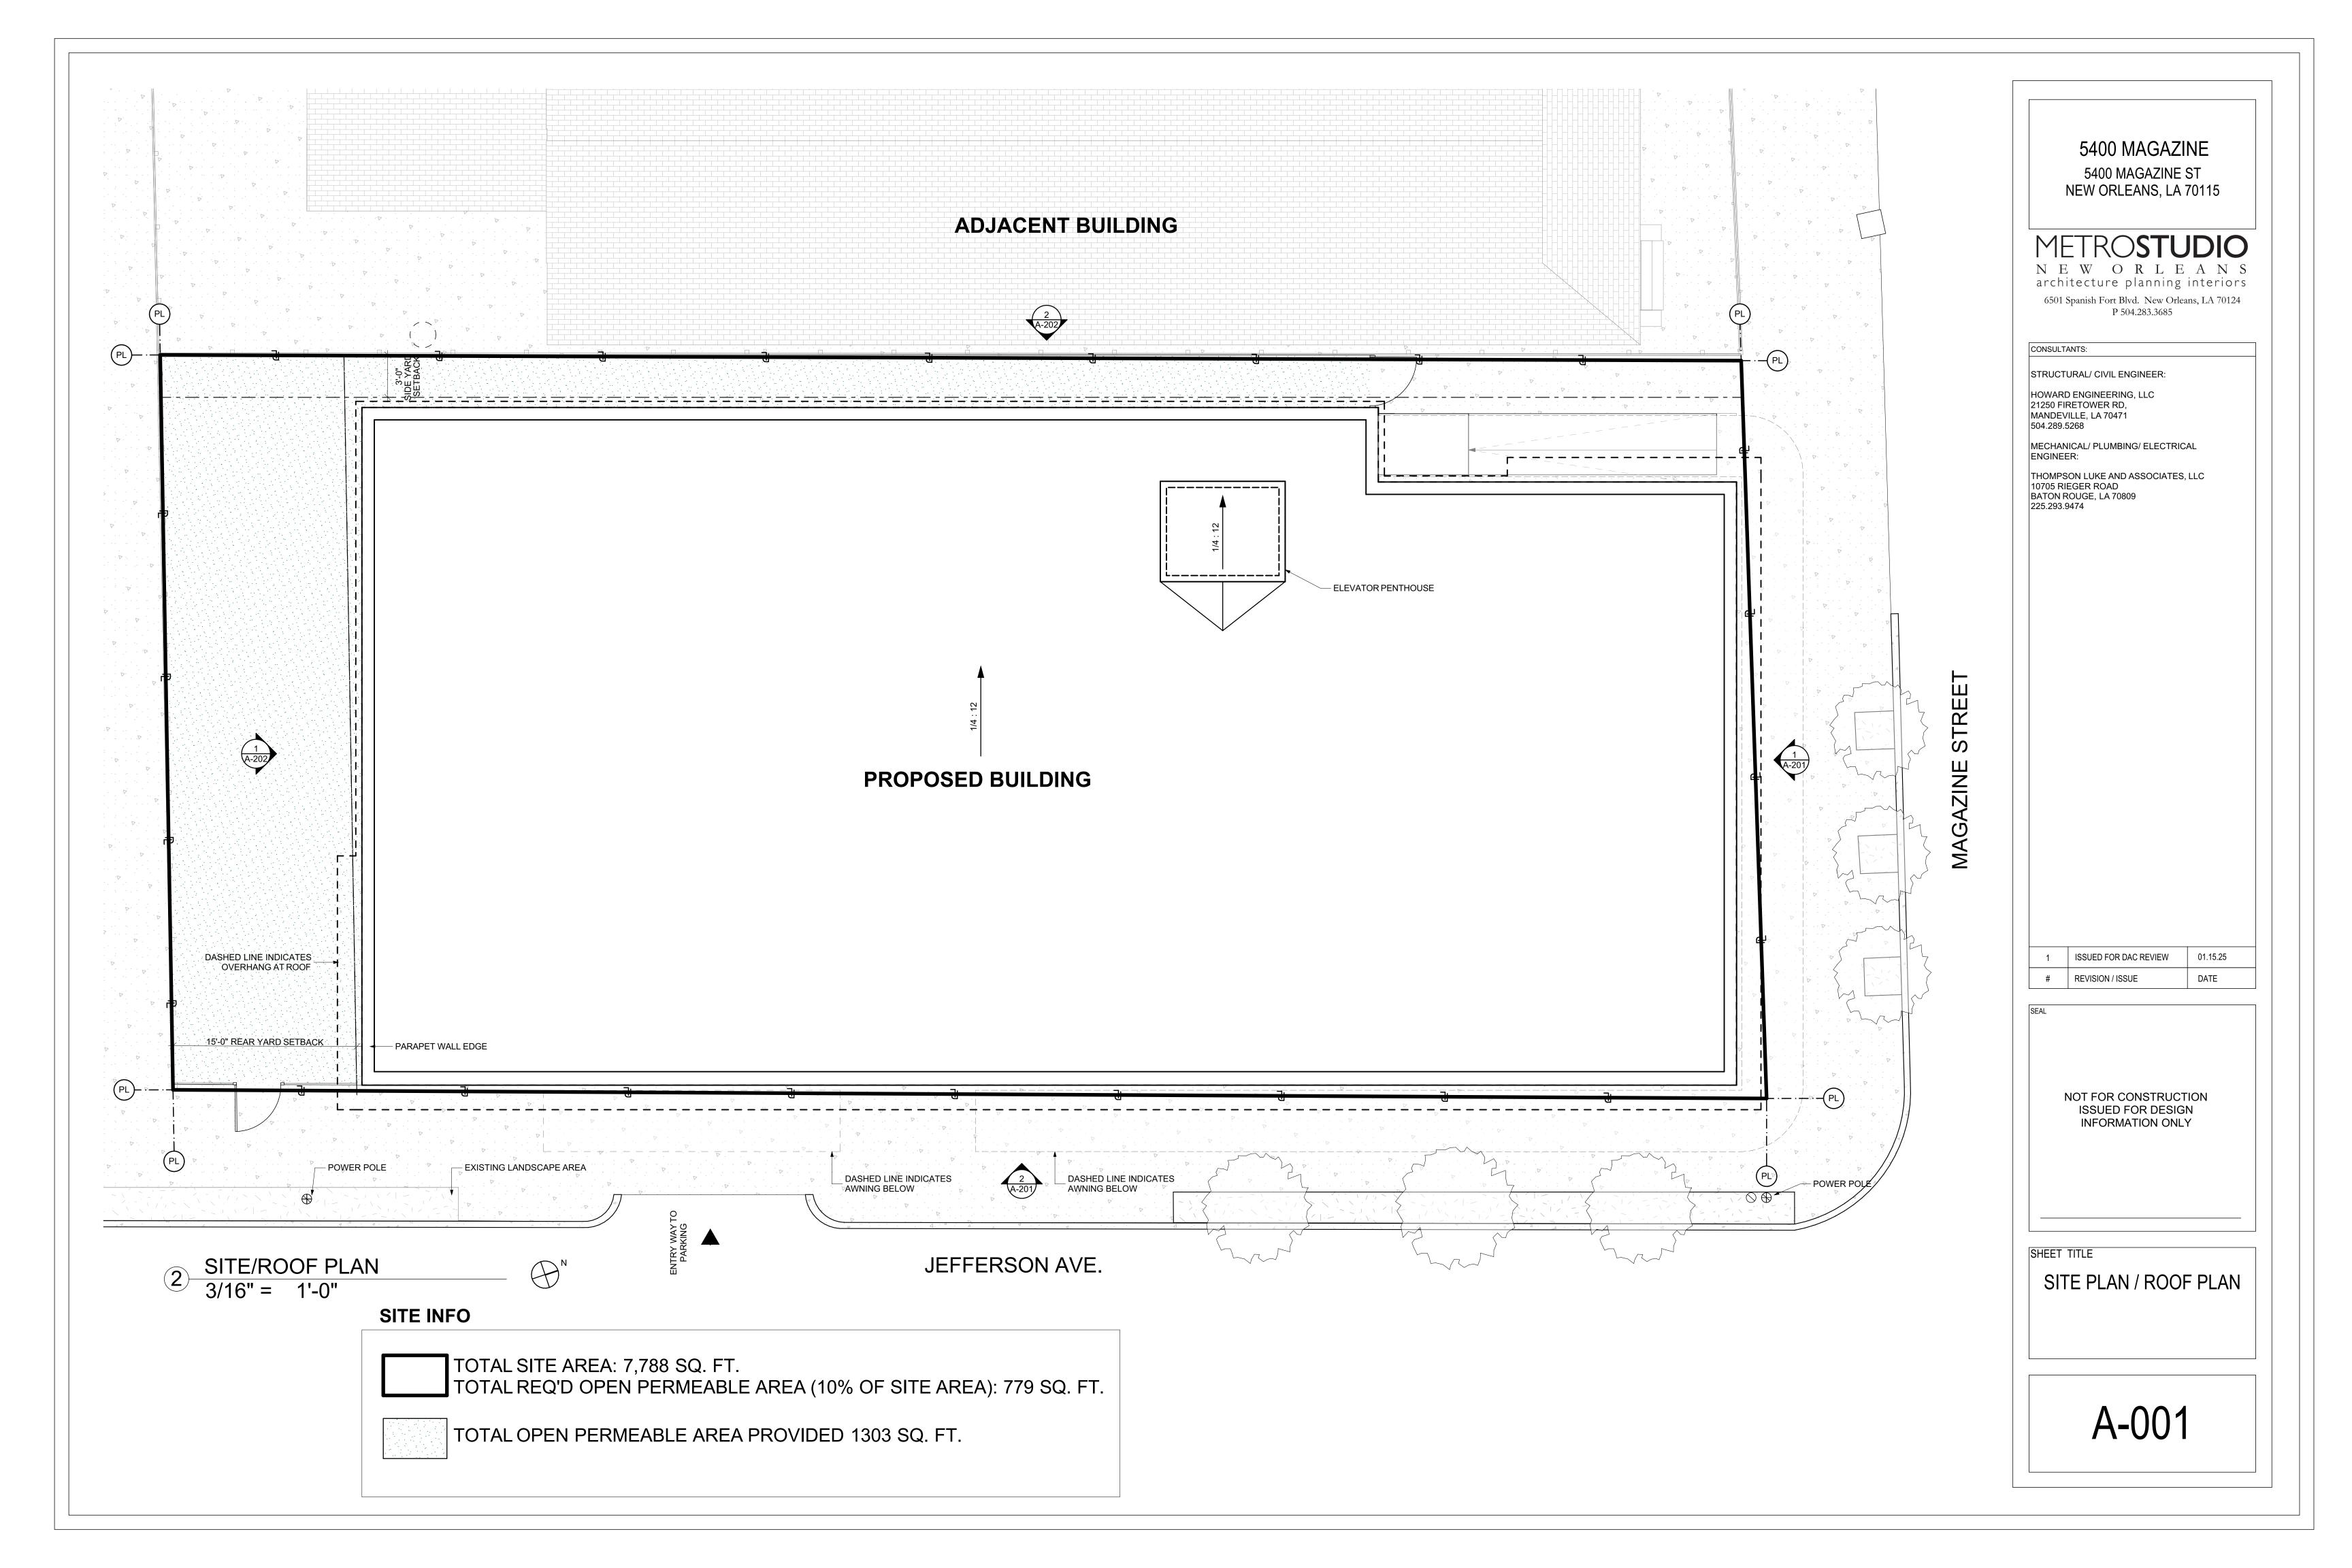

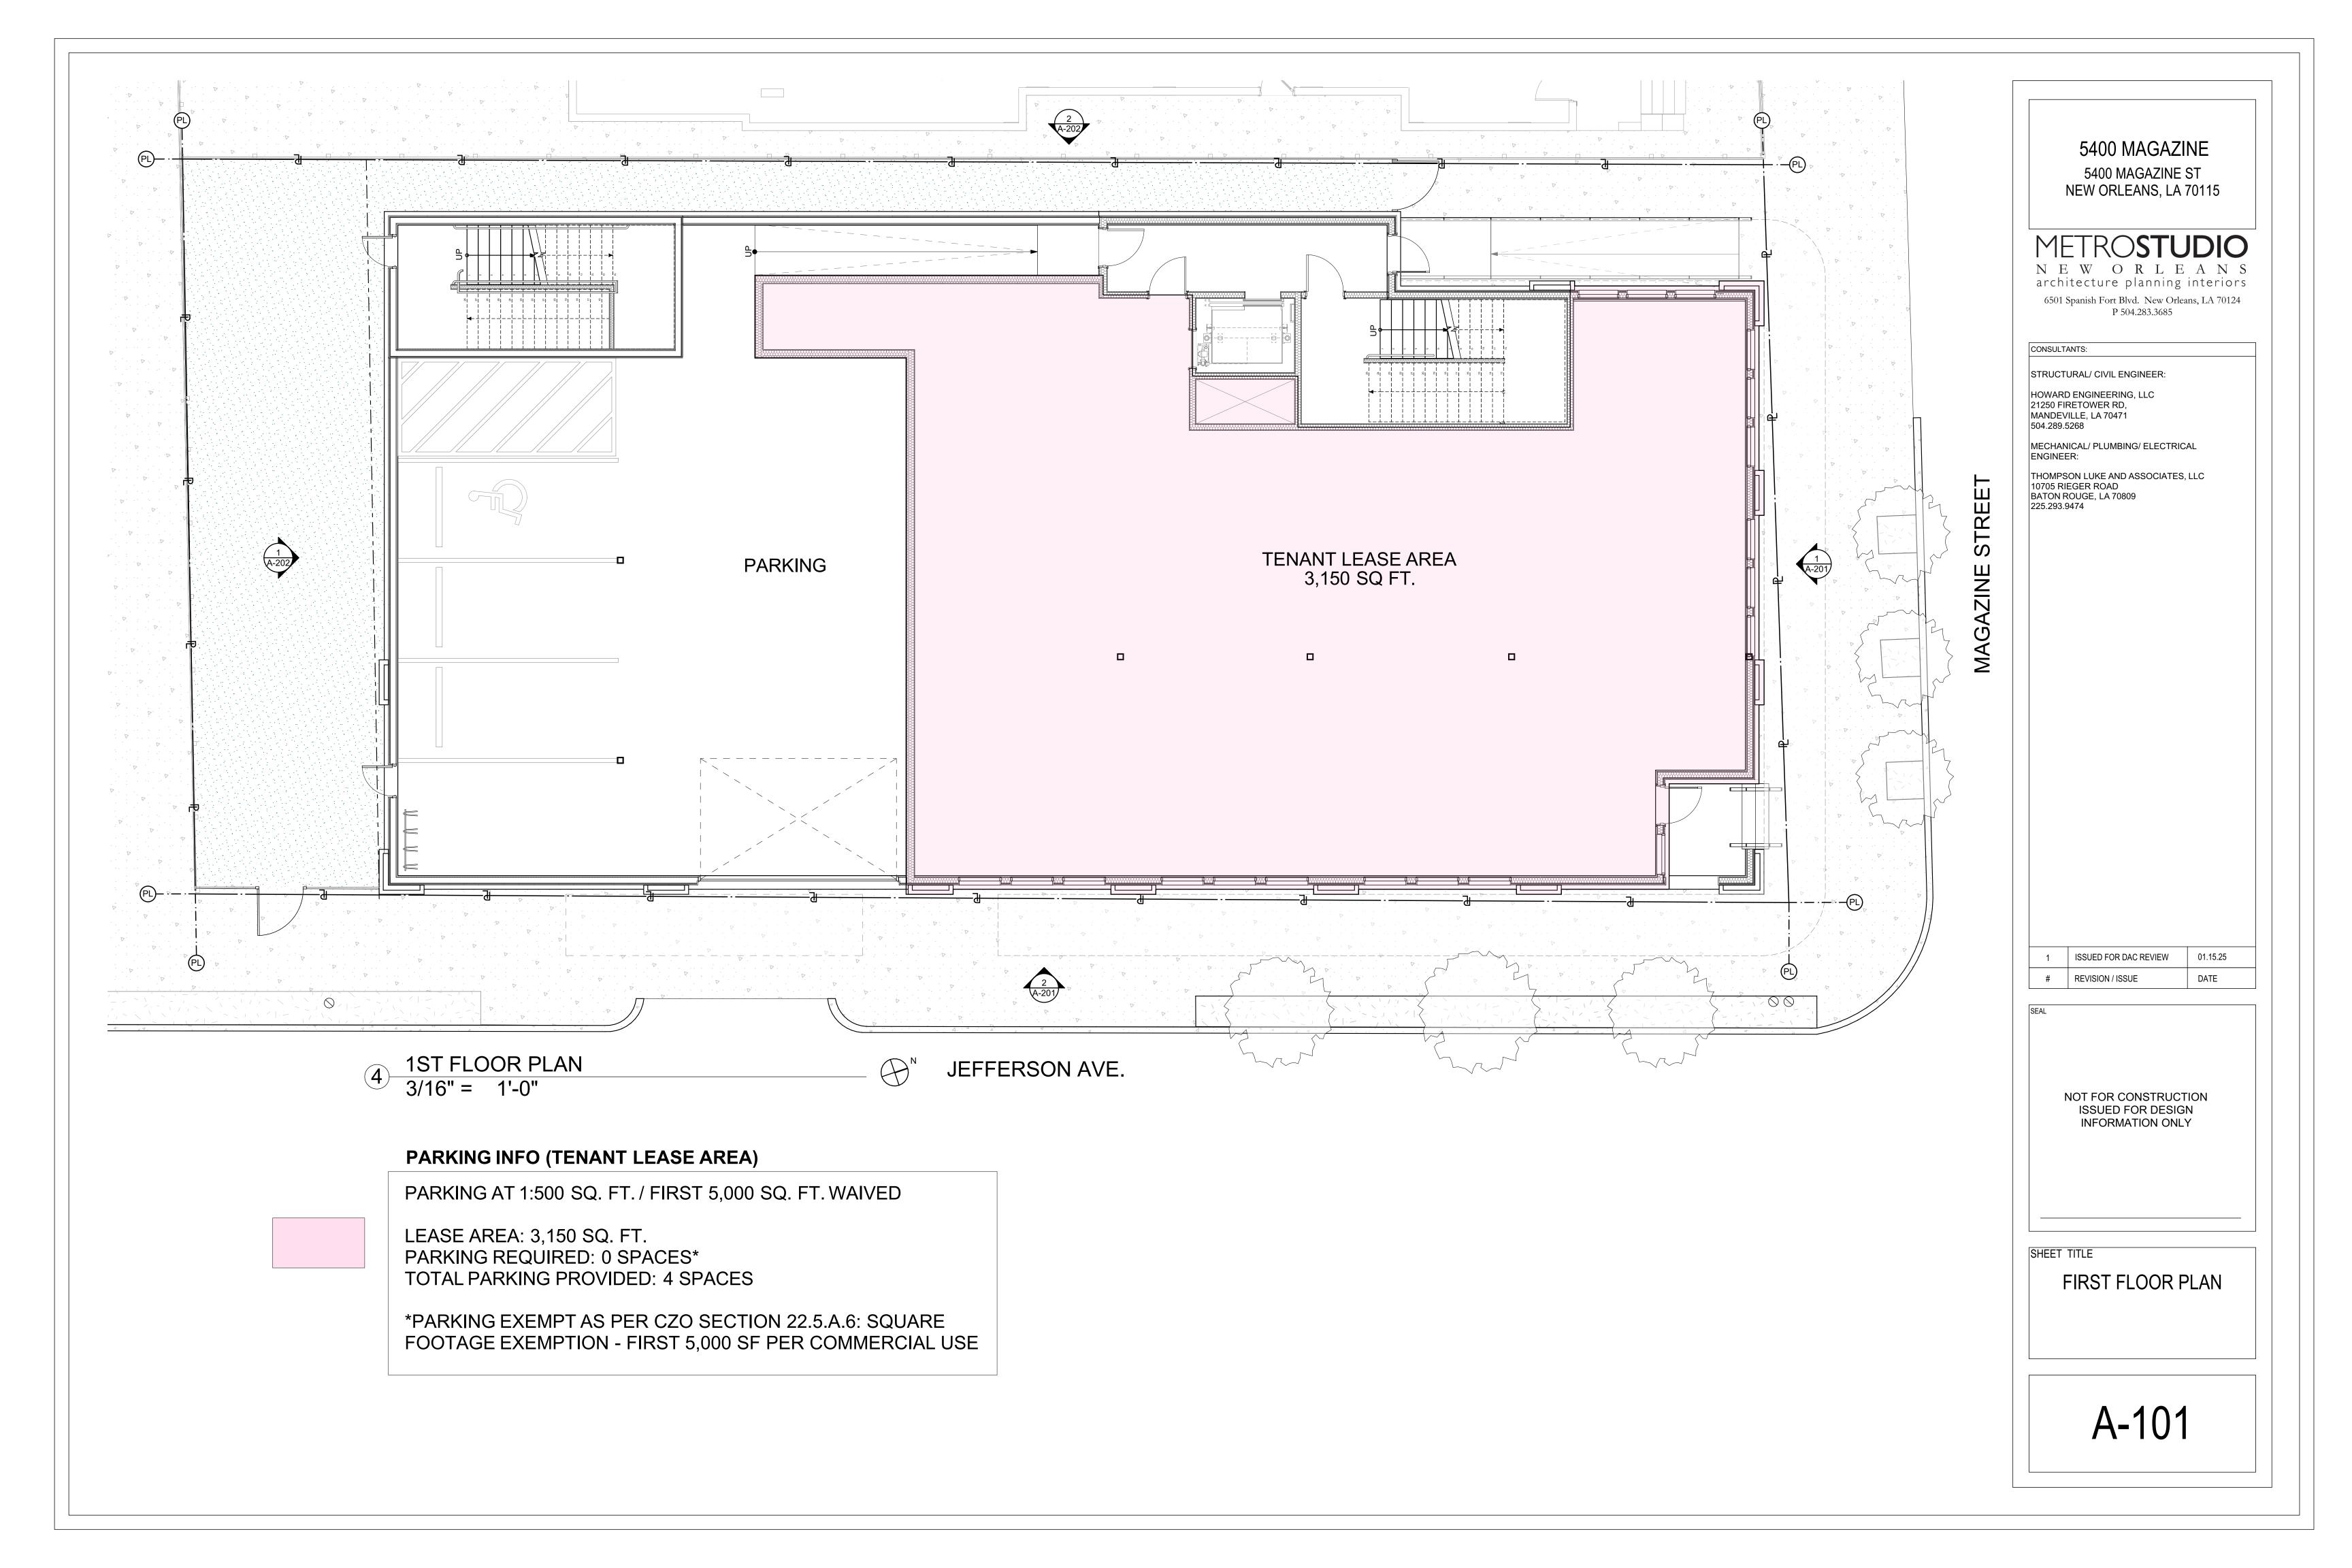



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METRO**STUDIO** 

NEWORLEANS architecture planning interiors 6501 Spanish Fort Blvd. New Orleans, LA 70124 P 504.283.3685

STRUCTURAL/ CIVIL ENGINEER:

MECHANICAL/ PLUMBING/ ELECTRICAL ENGINEER:


THOMPSON LUKE AND ASSOCIATES, LLC

ISSUED FOR DAC REVIEW 01.15.25 # REVISION / ISSUE

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SECOND FLOOR PLAN

A-102

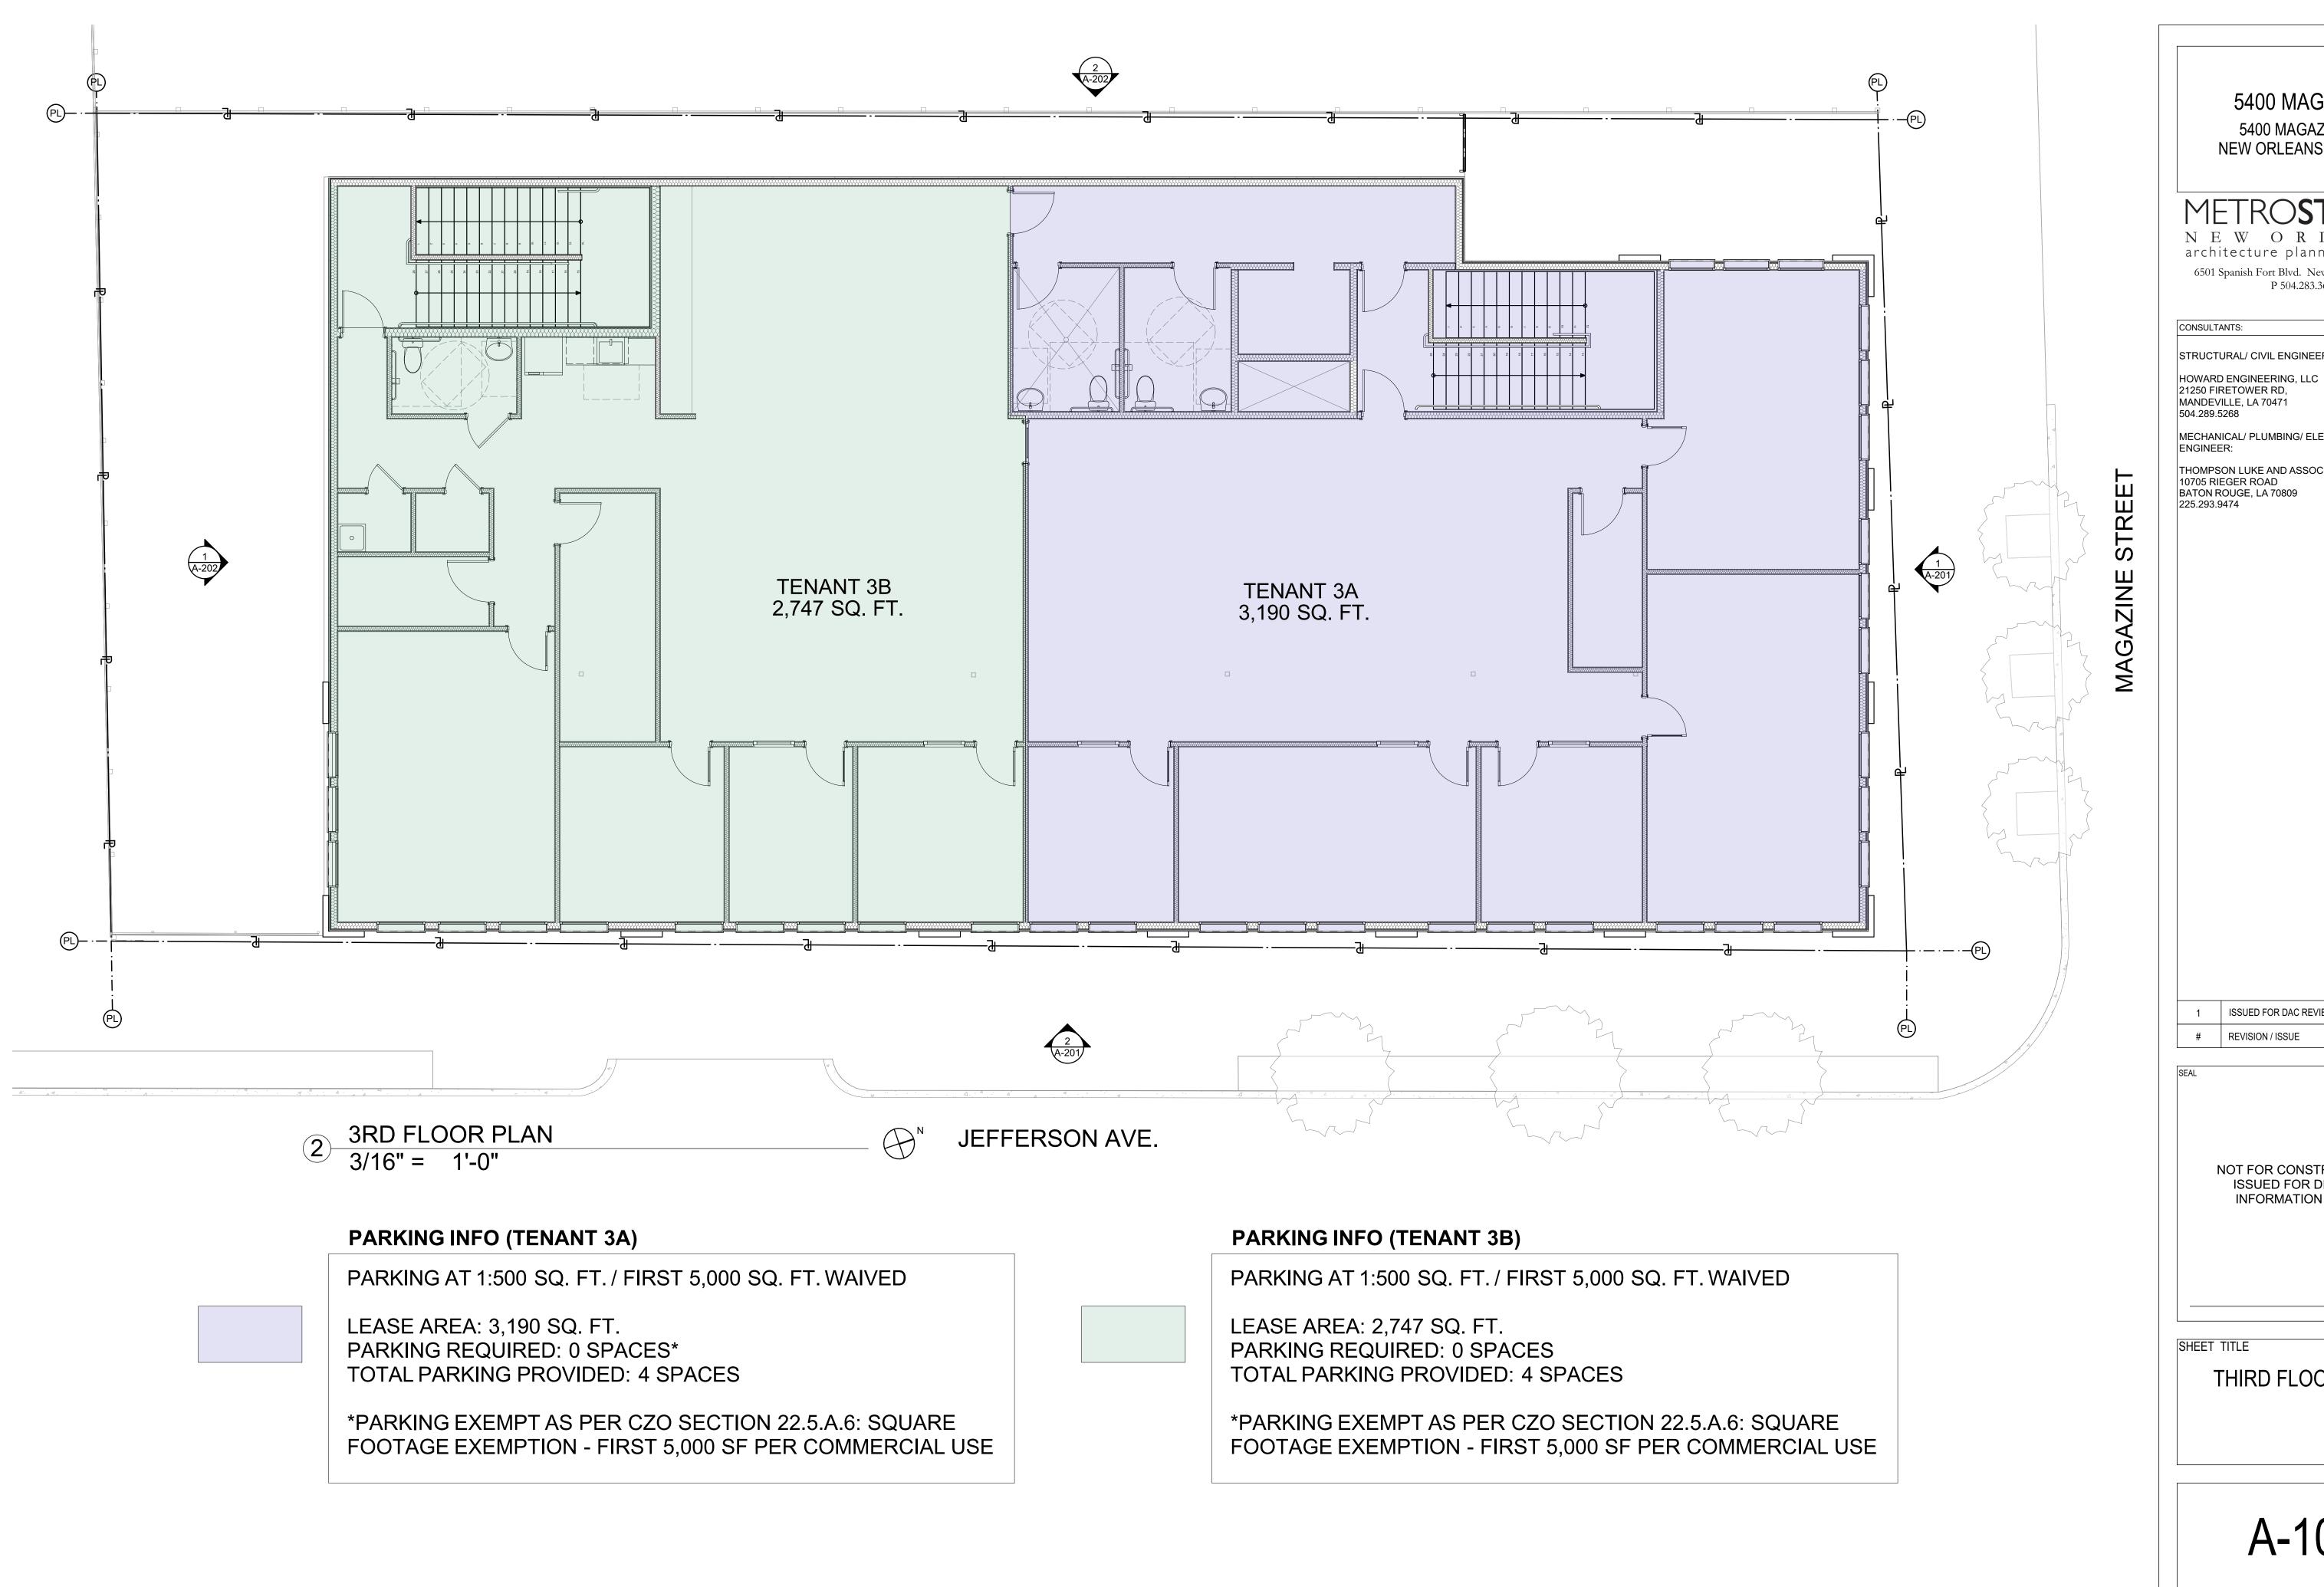

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STRUCTURAL/ CIVIL ENGINEER:

21250 FIRETOWER RD,

MECHANICAL/ PLUMBING/ ELECTRICAL

THOMPSON LUKE AND ASSOCIATES, LLC

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THIRD FLOOR PLAN

A-103

# MAX BUILDING HT - 1 TYP. TYP.2 T.O. THIRD FLOOR 26'-10" TYP. 4 T.O. SECOND FLOOR 5'-0" T.O. CONCRETE STEM WALL T.O. FLOOR SLAB GRADE 0'-0" 1 NORTH ELEVATION 3/16" = 1'-0"

### **ELEVATION KEYNOTES**

- 1. EXTERIOR PLASTER FINISH
- 2. CLAD WOOD WINDOWS
- 3. APPLIED CERAMIC TILE ORNAMENT
- 4. PAINTED FIBER CEMENT TRIM
- 5. PAINTED FIBER CEMENT FASCIA/SOFFIT **ASSEMBLY**
- 6. BRICK WATER TABLE
- 7. IRON RAILING
- 8. WOOD FENCE

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CONSULTANTS:

STRUCTURAL/ CIVIL ENGINEER:

HOWARD ENGINEERING, LLC 21250 FIRETOWER RD, MANDEVILLE, LA 70471 504.289.5268

MECHANICAL/ PLUMBING/ ELECTRICAL ENGINEER:

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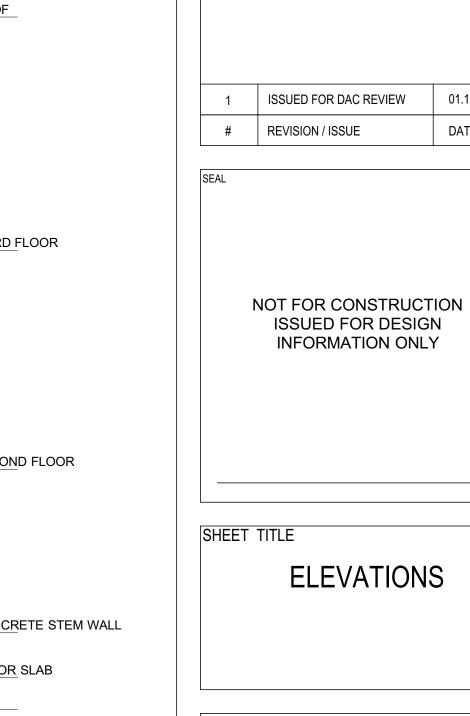
01.15.25

DATE


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**ELEVATIONS** 



		MAX BUILDING HT 40'-0" T.O. ROOF 39'-9 1/2"
*	<b>←</b>	T.O. THIRD FLOOR 26'-10"
	5'-0"	T.O. SECOND FLOOR
8 TYP. 2 TYP. 2 TYP. 2 TYP. 2 TYP. 3	5 TYP.	
	7 TYP	1:-9"



SOUTH ELEVATION (REAR YARD)

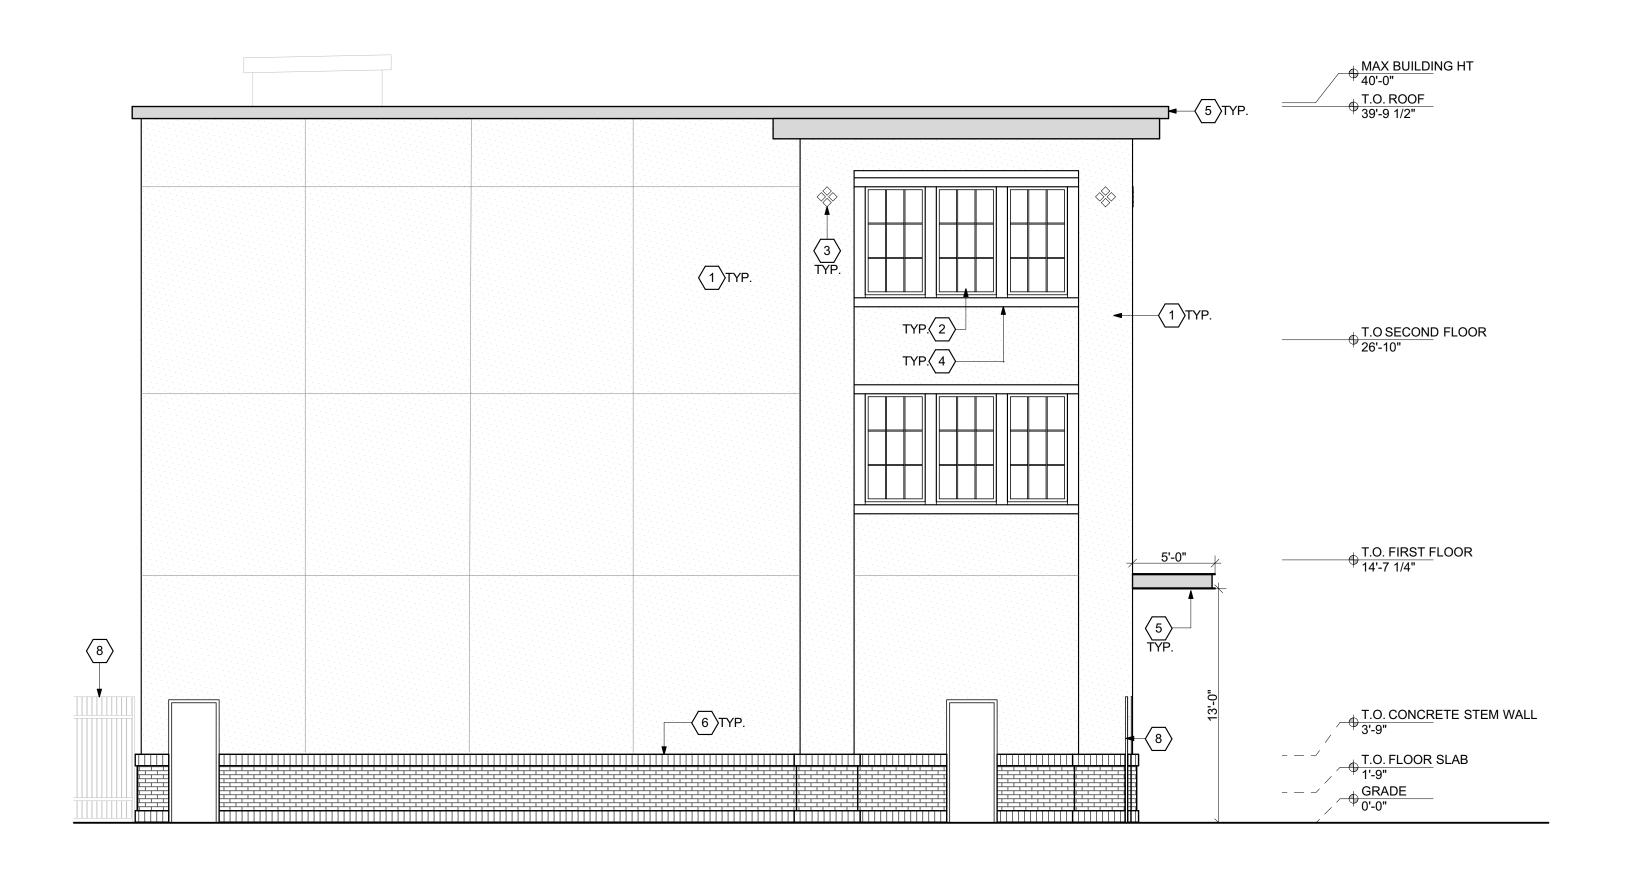3/16" = 1'-0"

2 WEST ELEVATION (SIDE YARD)
3/16" = 1'-0"

### **ELEVATION KEYNOTES**

- 1. EXTERIOR PLASTER FINISH
- 2. CLAD WOOD WINDOWS
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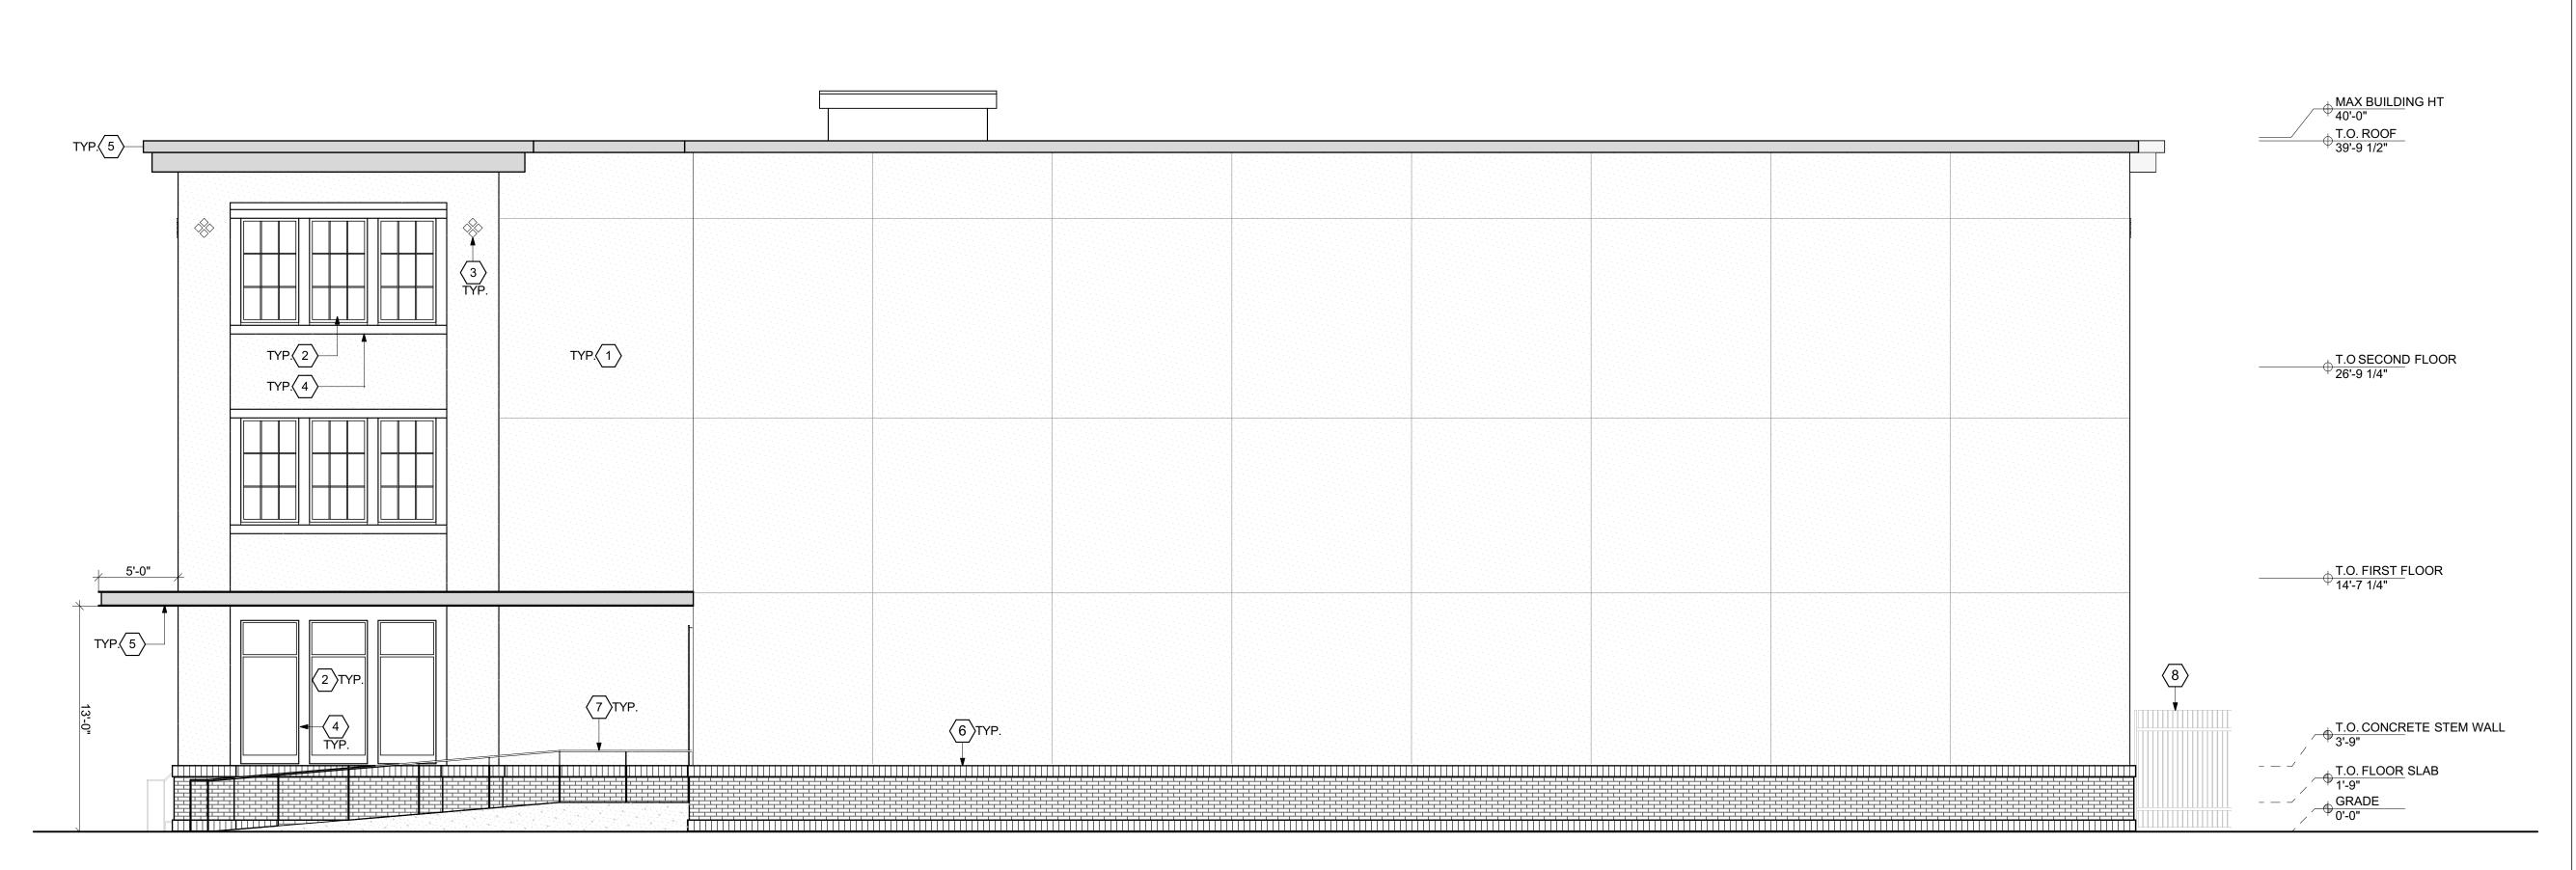
1 ISSUED FOR DAC REVIEW 01.15.25
# REVISION / ISSUE DATE

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SHEET TITLE

**ELEVATIONS** 

A-202










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Tracking Number	

#### **DEVELOPMENT PLAN AND DESIGN REVIEW APPLICATION**

Covid-19 Submittal Protocol: Please submit complete applications via email to CPCinfo@nola.gov. Applicants without the ability to
submit via email should contact (504) 658-7100 to make alternative arrangements. Incomplete applications will not be accepted
and will be returned to the applicant. Review time depends on the complexity of the project and can take up to 90 days.

Type of application:	Design	Review	Interim Z	oning Di	stricts Appeal	Moratorium Appeal	
Property Location							
APPLICANT IN	FORN	NOITAN					
Applicant Identity:		Property Ow	ner Agent				
Applicant Name							
Applicant Address							
City			State			Zip	
Applicant Contact Nur	nber _			Ema	il		
PROPERTY OV	VNFR	INFORI	MATION	SAME AS	S ABOVE		
Property Owner Name							
						Zip	
PROJECT DES	CRIPT	ION					
REASON FOR	REVIE	EW (REQL	JIRED FOR DESIGN RE	EVIEW)			
Design Overlay District Review Character Preservation Corridor Riverfront Design Overlay Enhancement Corridor Corridor Transformation Greenway Corridor Others as required		Developme Public Mar CBD FAR E Wireless A	Non-Design Overlay District Review Development over 40,000 sf Public Market CBD FAR Bonus Wireless Antenna/Tower Educational Facility		Changes to Approved Plans DAC Review of Public Projects Others as Required		
ADDITIONAL II	NFOF	OITAM	٧				
Current Use				Prop	oosed Use		
Square Number			Lot Number			Permeable Open Space (sf)	
New Development?	Yes	No	Addition?	Yes	No	Tenant Width	
Existing Structure(s)?	Yes	No	Renovations?	Yes	No	Building Width	
Change in Use?	Yes	No	Existing Signs?	Yes	No	Lot Width (sf)	
New Sign(s)?	Yes	No	Lot Area (sf)			BuildingArea (sf)	



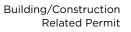



Date	Received by
Tracking Number	

#### DEVELOPMENT PLAN AND DESIGN REVIEW APPLICATION

#### REQUIRED ATTACHMENTS (One digital copy)

#### 1. SITE PLAN

North arrow, scale, and date of plan

Location, dimensions, and area of permeable open space Name, address of the professional who prepared the plan Legend of symbols, patterns, and abbreviations used The entire lot(s), including area and property lines dimensioned (including gross area of the site)
Curb cuts, interior streets, driveways, and parking and loading areas with dimensions and total area (sf)
Location and dimensions of buildings and structures, including total floor area and distance from property lines
Location of refuse storage locations

Proposed right-of-way improvements including sidewalks and plantings, and pedestrian walkways

Fence location, height, and materials

#### 2. FLOOR PLAN

Indicating the dimensions and square footage of proposed development

Room use

Location of all walls, doors, and windows

Location of all plumbing fixtures

Location of major appliances/mechanical equipment

Stairway location

Firewall location (if applicable)

#### 3. ARCHITECTURAL ELEVATIONS

Architectural elevations of easch side of the proposed structure drawn to scale indicating height, architectural elements, materials, colors, and textures proposed for any structures.

#### 4. LIGHTING PLAN

Location of all exterior lighting, including those mounted on poles and walls

Types, style, height, and the number of fixtures Manufacturer's illustrations and specifications of fixtures

#### 5. SIGNAGE PLAN

Proposed Signage with overall height, width, and materials Building Elevation (including building width and height) Site plan showing the location of all proposed detached sign(s) along with setback dimensions.

#### 6. LANDSCAPE PLAN

Name and address of professional who prepared the plan. Landscape plans shall be prepared by a registered landscape architect licensed by the Louisiana Horticulture Commission All landscape plans shall meet the minimum requirements of site plans

Legend defining all symbols, patterns, and abbreviations used

Location, quantity, size, name, and condition (both botanical and common) of all existing and proposed plant materials and trees.

Description of all tree preservation measures on-site and in the public right-of-way

Width, depth, and area of landscaped area(s)

Proposed right-of-way improvements and pedestrian walkways

Planting proposed in the right-of-way must have Parks and Parkways approval

#### 7. PHOTOS

Photographs of the subject site and/or building

#### 8. NARRATIVE

Narrative addressing compliance with applicable Comprehensive Zoning Ordinance requirements and design goals

#### 9. COLOR ELEVATIONS/RENDERING (DAC ONLY)

Color elevations and/or renderings are required for projects that trigger review by the Design Advisory Committee

#### **FEES**

Compliant Plan \$225
CBD Demolitions \$500
Moratorium Appeals \$1,000