

SITE PLAN LEGEND

- 6" BARRIER CURB. SEE DETAIL 4, SHEET CO4 SHEET C04.
- (2) EXISTING CURB TO REMAIN
- (3) EXISTING ASPHALT PAVEMENT TO REMAIN
- (4) NEW PARKING STALL STRIPING
- 4" CONCRETE SIDEWALK. SEE DETAIL
- NEW CONCRETE RAMPS. REFERENCE STRUCTURAL.
- 7 DRAINAGE STRUCTURE. REFERENCE UTILITY PLAN ON SHEET C03A.
- TYPICAL ADA HANDICAP PARKING (8) SYMBOL AND AISLE STRIPING. SEE DETAIL 5, SHEET C04.
- TYPICAL HANDICAP BOLLARD SIGN. SEE DETAIL 6, SHEET C04.
- TIE SIDEWALK INTO EXISTING SIDEWALK WITH DOWELS
- NEW MODULAR BUILDING. REFERENCE STRUCTURAL PLANS
- NEW SODDED/LANDSCAPED AREA.
- CONCRETE STAIR AND LANDING WITH (13) HANDRAIL. REFERENCE ARCH AND STRUCTURAL

- (14) EXISTING ARCH TANK STORMWATER DETENTION AREA DETENTION AREA
- (15) NEW GATE PER ARCH
- 6" CONCRETE PAD WITH HIGHWAY (16) Mesh for backflow preventer. See UTILITY PLAN, SHEET C03
 - (17) MOUNTABLE CURB PER DPW STANDARDS

 - APRON WAS REMOVED. TIE MOUNTABLE CURB INTO EXISTING

SOD RIGHT OF WAY WHERE DRIVEWAY

- (19) THE MODINION COURS WITH DOWELS NEW 6" CONCRETE DRIVEWAY APRON
- PER CITY OF NEW ORLEANS DPW STANDARDS. SEE DETAIL 9, SHEET C05. TRENCHING FOR NEW UTILITIES.
- (21) REPLACE ASPHALT TO MATCH EXISTING. SEE DETAIL 2, SHEET C04.
- PLAY AREA ENCLOSURE FENCE PER ARCH
- ADD FILL UNDER AND BEHIND CURB TO ADD FILL UNDER AND E SLOPE TO OPEN AREA
- (24) FENCE PER ARCH

SITE PLAN NOTES:

- 1. CONTRACTOR SHALL BE RESPONSIBLE FOR LAYING OUT THE WORK, VERIFYING ALL MEASUREMENTS AND GRADES AND REPORTING ANY DISCREPANCIES TO THE ENGINEER BEFORE STARTING CONSTRUCTION.
- 2. ANY WORK IN THE ROADWAY OR ADJACENT TO THE ROADWAY CAUSING AN INTERFERENCE TO VEHICULAR TRAFFIC REQUIRES PRIOR NOTIFICATION TO CITY OF NEW ORLEANS DPW TRAFFIC ENGINEERING DIVISION AND CONFORMITY TO THE REQUIREMENTS OF THE UNIFORM MANUAL ON TRAFFIC CONTROL DEVICES OF THE STATE OF LOUISIANA. THE CONTRACTOR MUST FURNISH ALL TRAFFIC SIGNS AND/OR BARRICADES AND MAINTAIN THEM DURING CONSTRUCTION ACTIVITY.
- 3. REFER TO BOUNDARY SURVEY FOR EXISTING MONUMENTS TO LAYOUT PROPERTY LINE.
- 4. BRING UP GRADE UNDER ALL PAVEMENT WITH STRUCTURAL FILL COMPACTED IN ACCORDANCE WITH SPECIFICATIONS.
- 6. ALL CURB RADII SHALL BE 3 FEET UNLESS OTHERWISE NOTED ON THIS PLAN.
- 7. ALL PAINT STRIPING, PAVEMENT MARKINGS, AND SIGNAGE SHALL CONFORM TO THE "MANUAL ON UNIFORM TRAFFIC CONTROL DEVICES" OR AS OTHERWISE SPECIFIED. ALL REFERENCED SIGN STANDARDS ARE TAKEN FROM THE "MANUAL ON UNIFORM TRAFFIC CONTROL DEVICES". ALL NEW SIGNS SHALL BE MOUNTED ON GALVANIZED POSTS AND IN ACCORDANCE WITH STATE AND LOCAL REGULATIONS.
- 8. CONTRACTOR IS RESPONSIBLE FOR THE INSTALLATION AND MAINTENANCE OF ALL EROSION CONTROL DEVICES SHOWN ON THE APPROVED PLANS FOR THE DURATION OF CONSTRUCTION OR UNTIL FINAL INSPECTION.

STORMWATER MANAGEMENT NOTE:


1. ALL PERMEABLE PAVING INSTALLATIONS SHALL BE SUBJECT TO INFILTRATION TESTING AFTER INSTALLATION. TESTING SHALL BE CONDUCTED ACCORDING TO THE ASTM INTERNATIONAL C1701 OR C1781 STANDARDS, AS APPROPRIATE. ALL TYPES OF PERMEABLE PAVEMENT SHALL MAINTAIN A MINIMUM INFILTRATION RATE OF 200 INCHES PER HOUR.

SURVEY BY OTHERS

SITE ELEMENTS AND PROPERTY BOUNDARY PER SURVEY TITLED "TOPOGRAPHIC SURVEY SURVEY OF LOT B & A PARTIAL TOPOGRAPHIC SURVEY OF LOT C PROSPER MARIGNY PLANTATION FIFTH DISTRICT CITY OF NEW ORLEANS, ORLEANS PARISH, LOUISIANA" BY DADING, MARQUES & ASSOCIATES, LLC, DATED JANUARY 9, 2025.

Call before you dig.

14

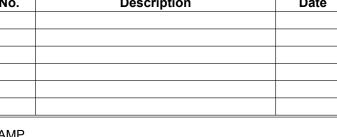



KEY PLAN

Mathes Brierre ARCHITECTS

201 St. Charles Avenue. Forty First Floor New Orleans, Louisiana 70170-4100 Voice. 504. 586. 9303. Fax. 504. 582. 1305 architecture@mathesbrierre.com

PROJECT TITLE

NEW CONSTELLATIONS BLDG & SITE WORK **IMPROVEMENTS AT** TUBMAN PARK CAMPUS

> 2701 Lawrence Street New Orleans, LA 70114

CONSTRUCTION DOCUMENTS

DESIGNED BY	CHECKED BY	
MARAIS CONSULTANTS		JMS
DRAWN BY	DATE	
CAP		04/30/25
SHEET TITLE		

SITE PLAN (SIDE A)

12400


2018 JENA STREET NEW ORLEANS, LA 70115 504.350.2644 PROJECT NO. SHEET NO. maraisconsultants.com


CONSULTANTS, LLC


PROFESSIONAL OF RECORD: jenny@maraisconsultants.com


15


MARAIS

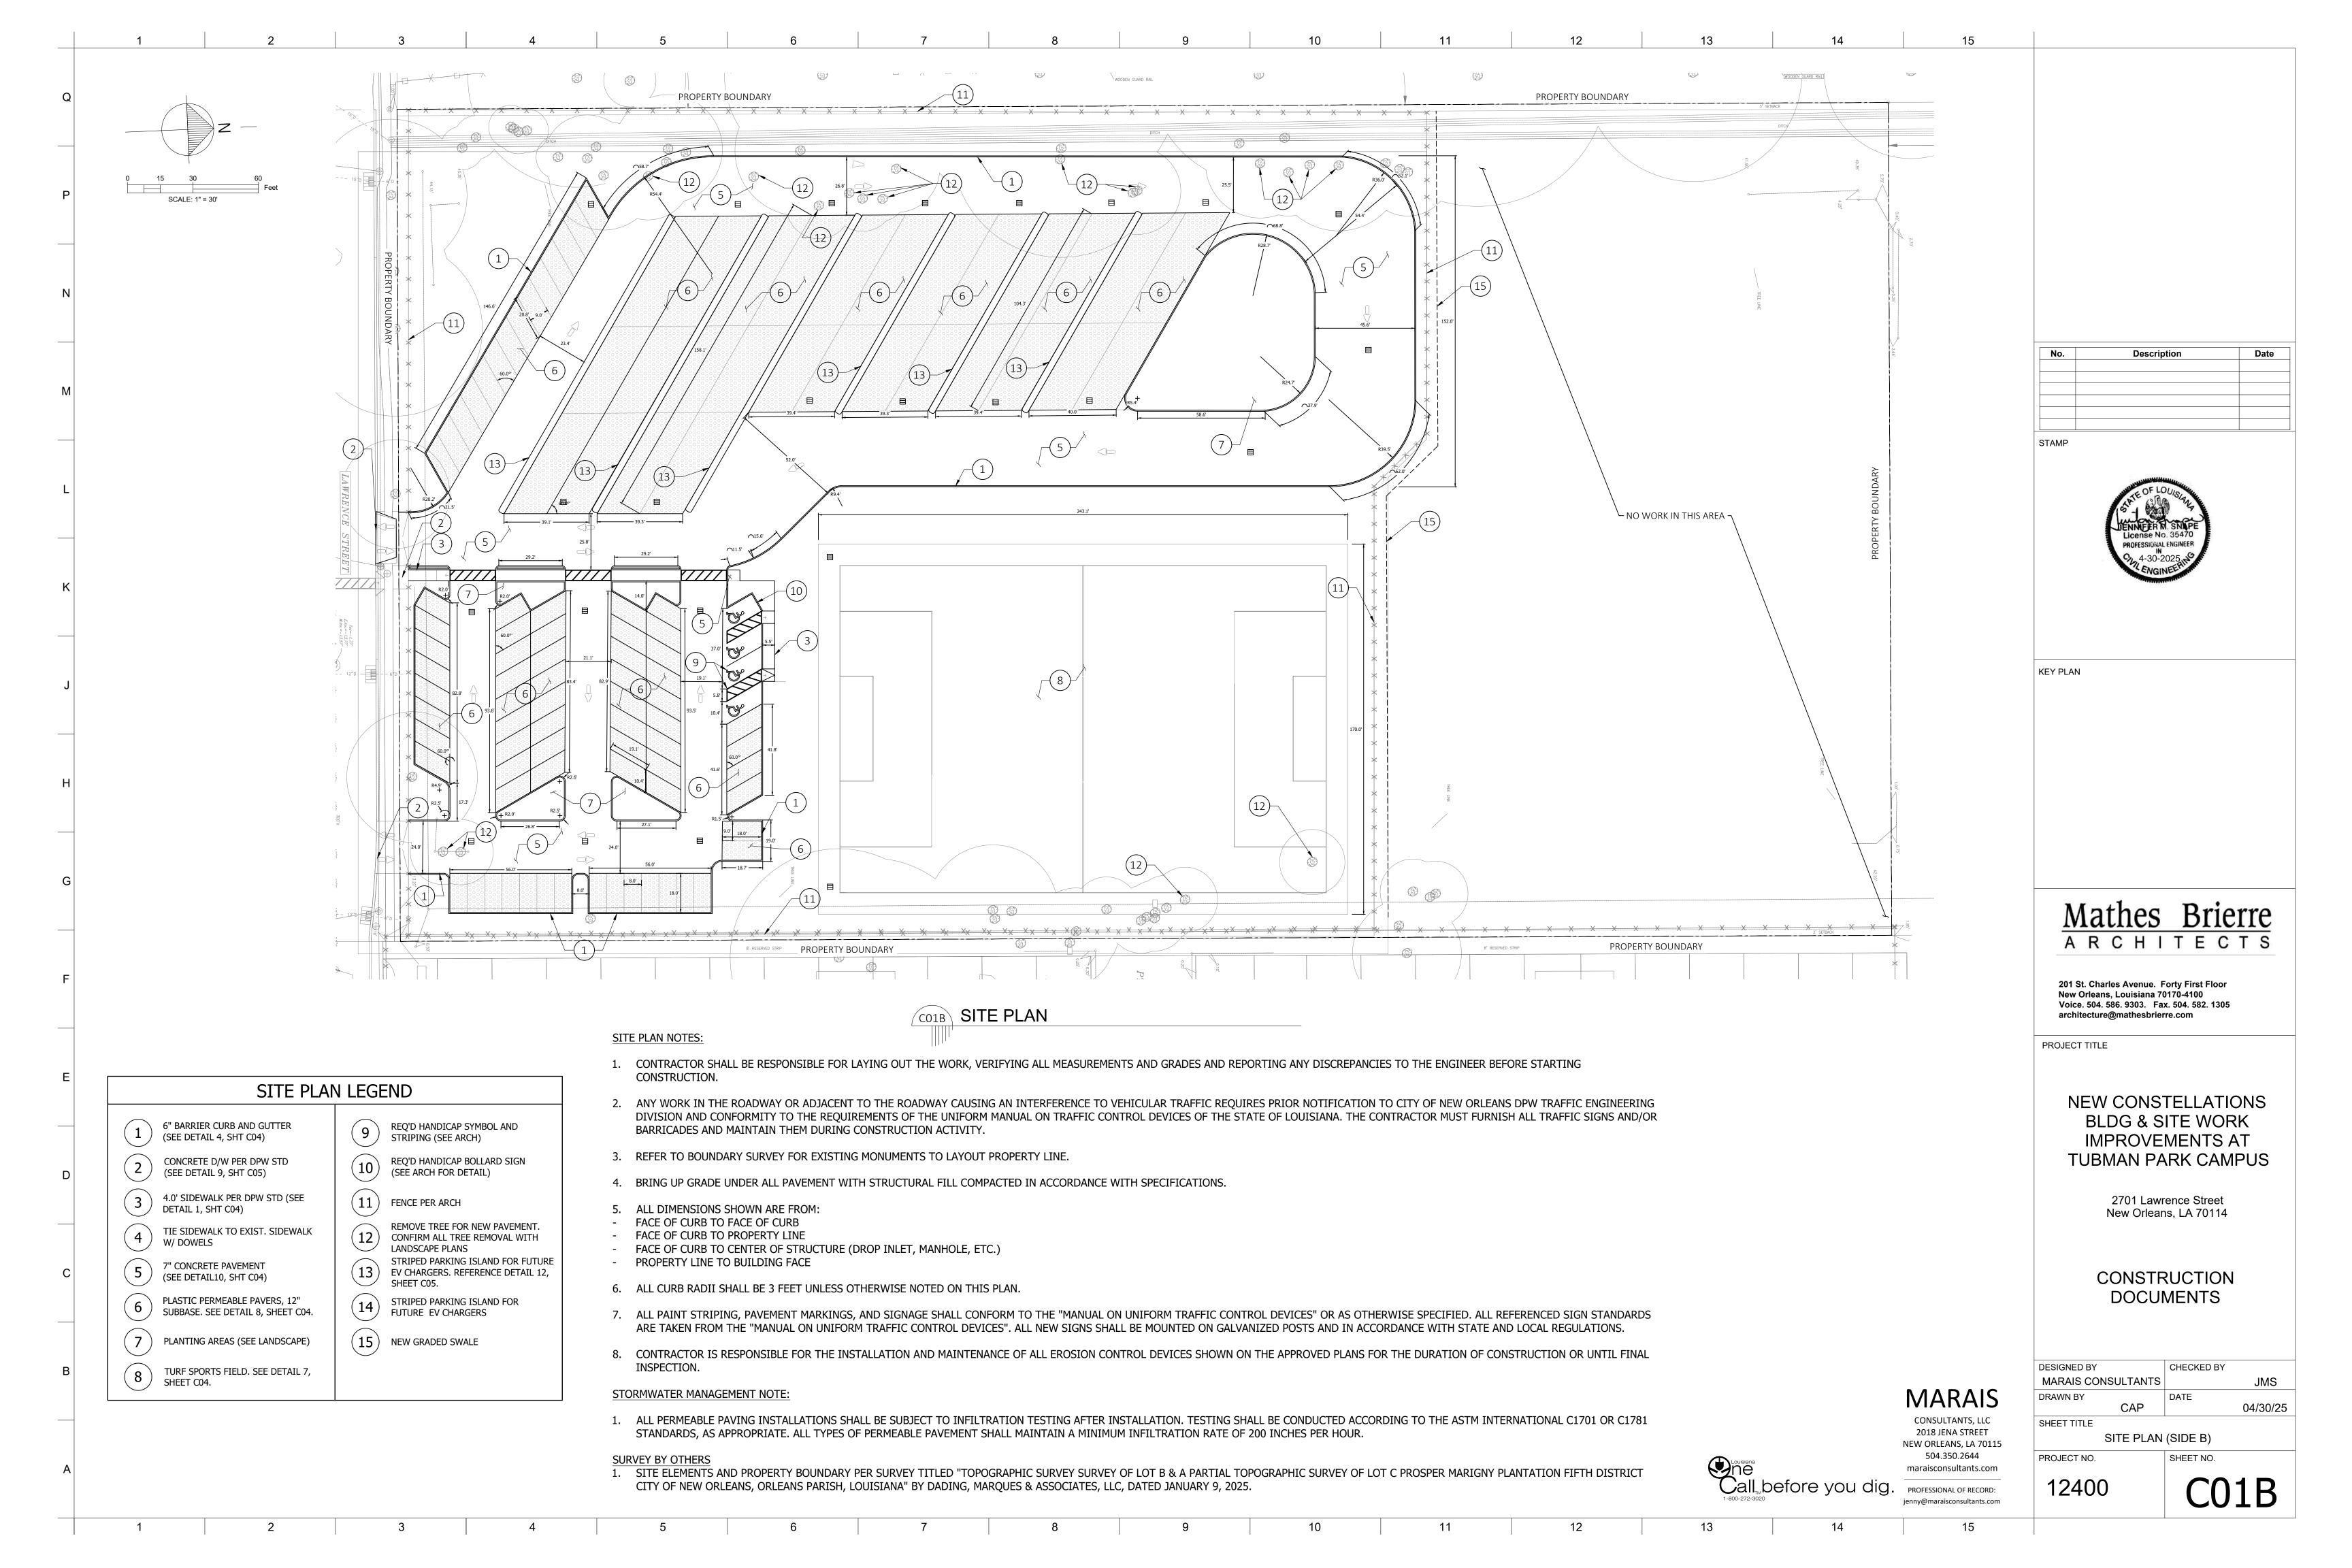

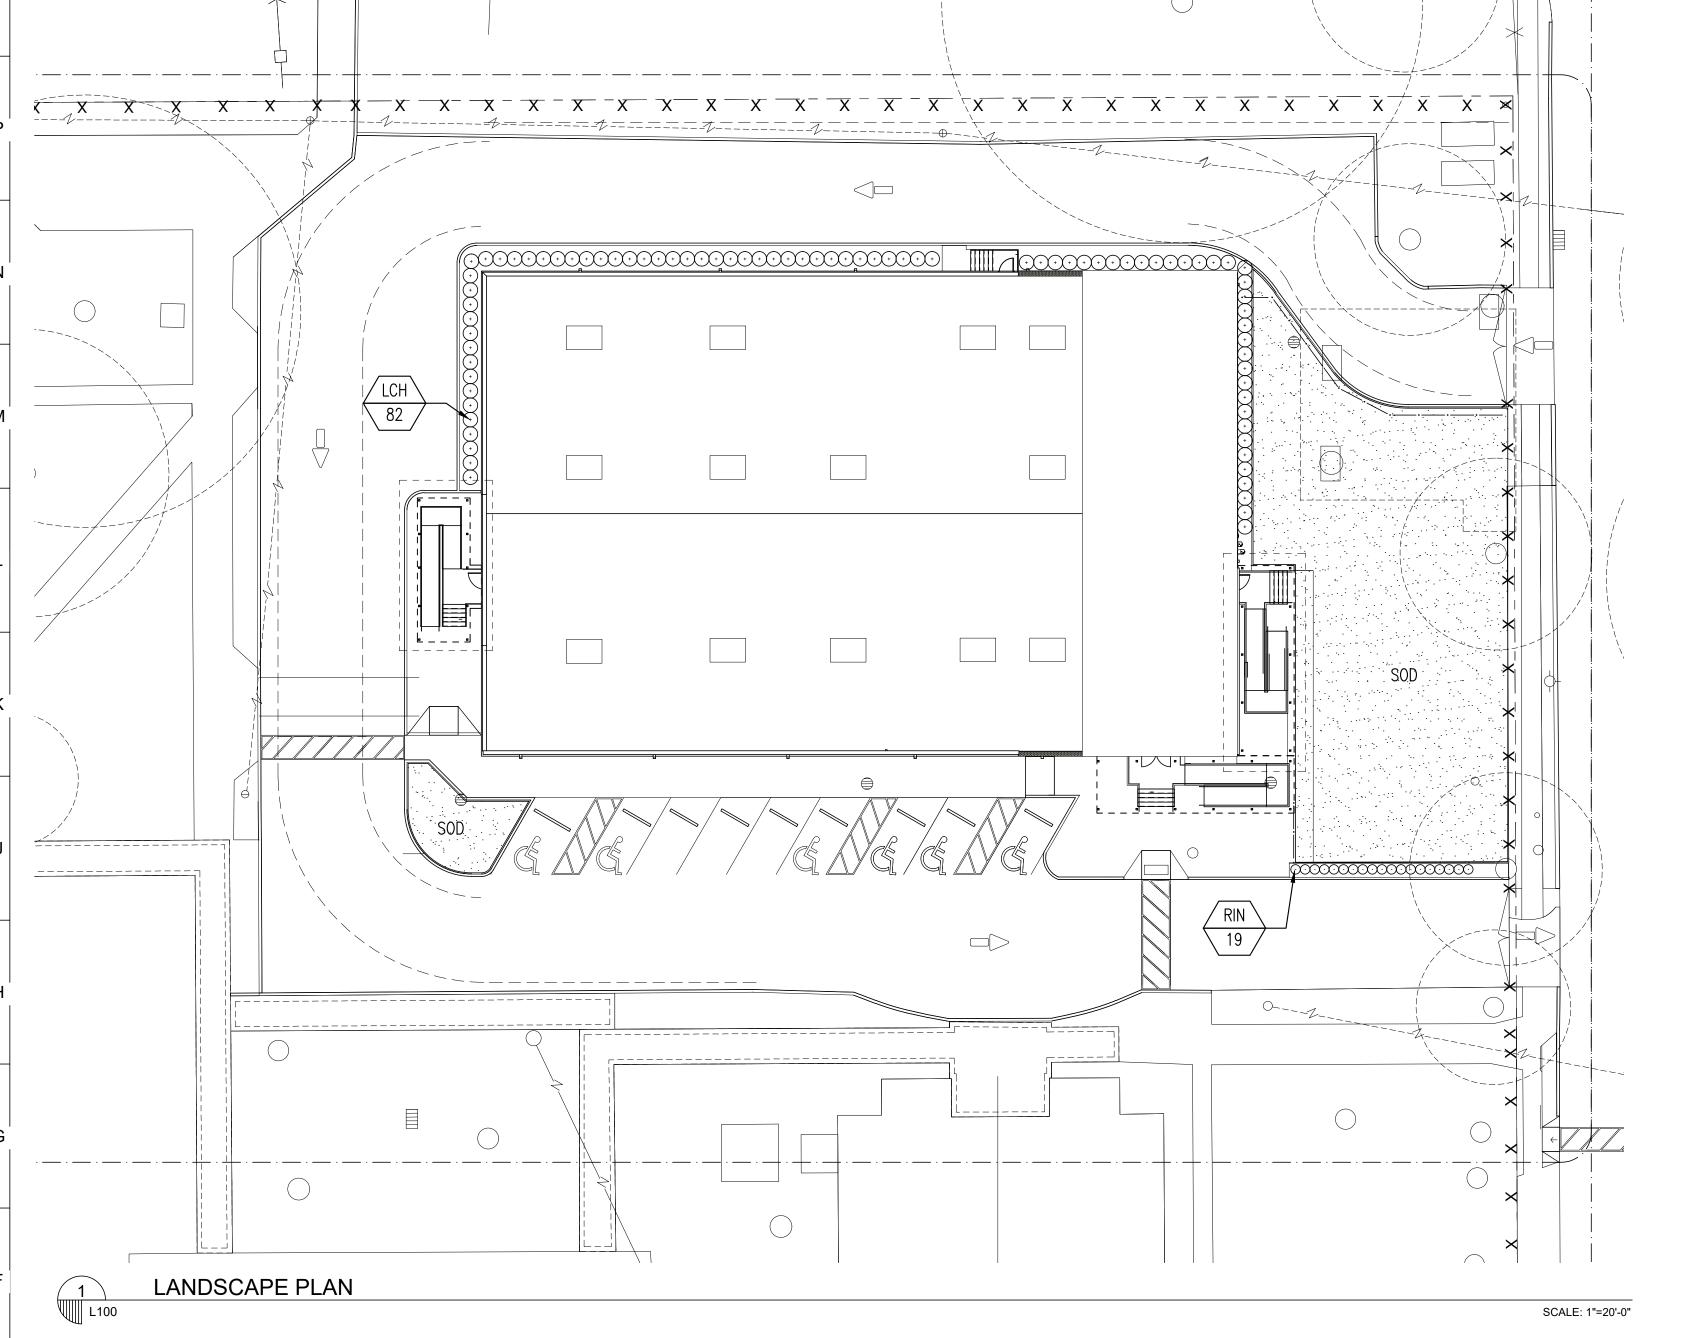

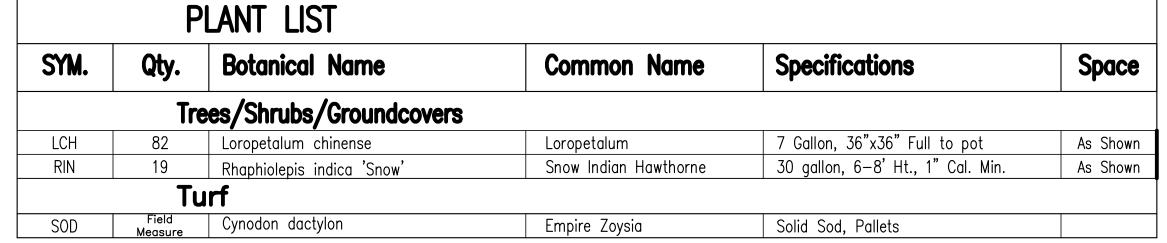

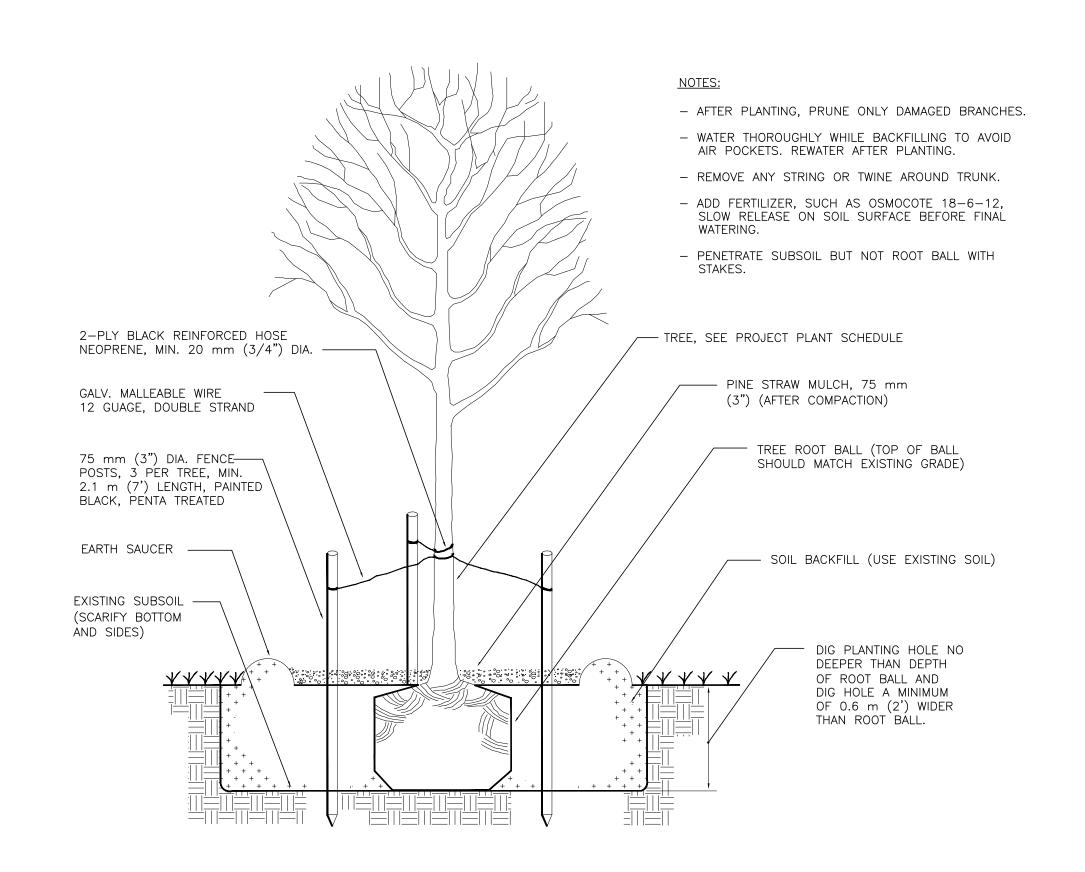

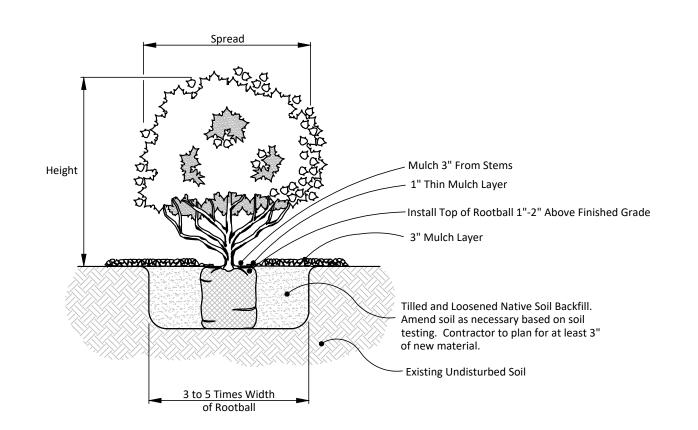



TREE PLANTING DETAIL

NOTE:

1. ALL AREAS DISTURBED DURING CONSTRUCTION SHALL BE SODDED IN ACCORDANCE WITH THE WRITTEN SPECIFICATIONS.

2. MULCH BELOW ALL EXISTING TREES ON SITE WITHIN 20'-0" OF CONSTRUCTION AREA.

3. ALL TREES SHALL HAVE A 6'-0" CLEAR TRUNK HEIGHT.

4. PROVIDE IRRIGATION SYSTEM 100% COVERAGE FOR ALL NEW LANDSCAPED AREAS

No.	Description	Date

STAMP



KEY PLAN

SCALE: NOT TO SCALE

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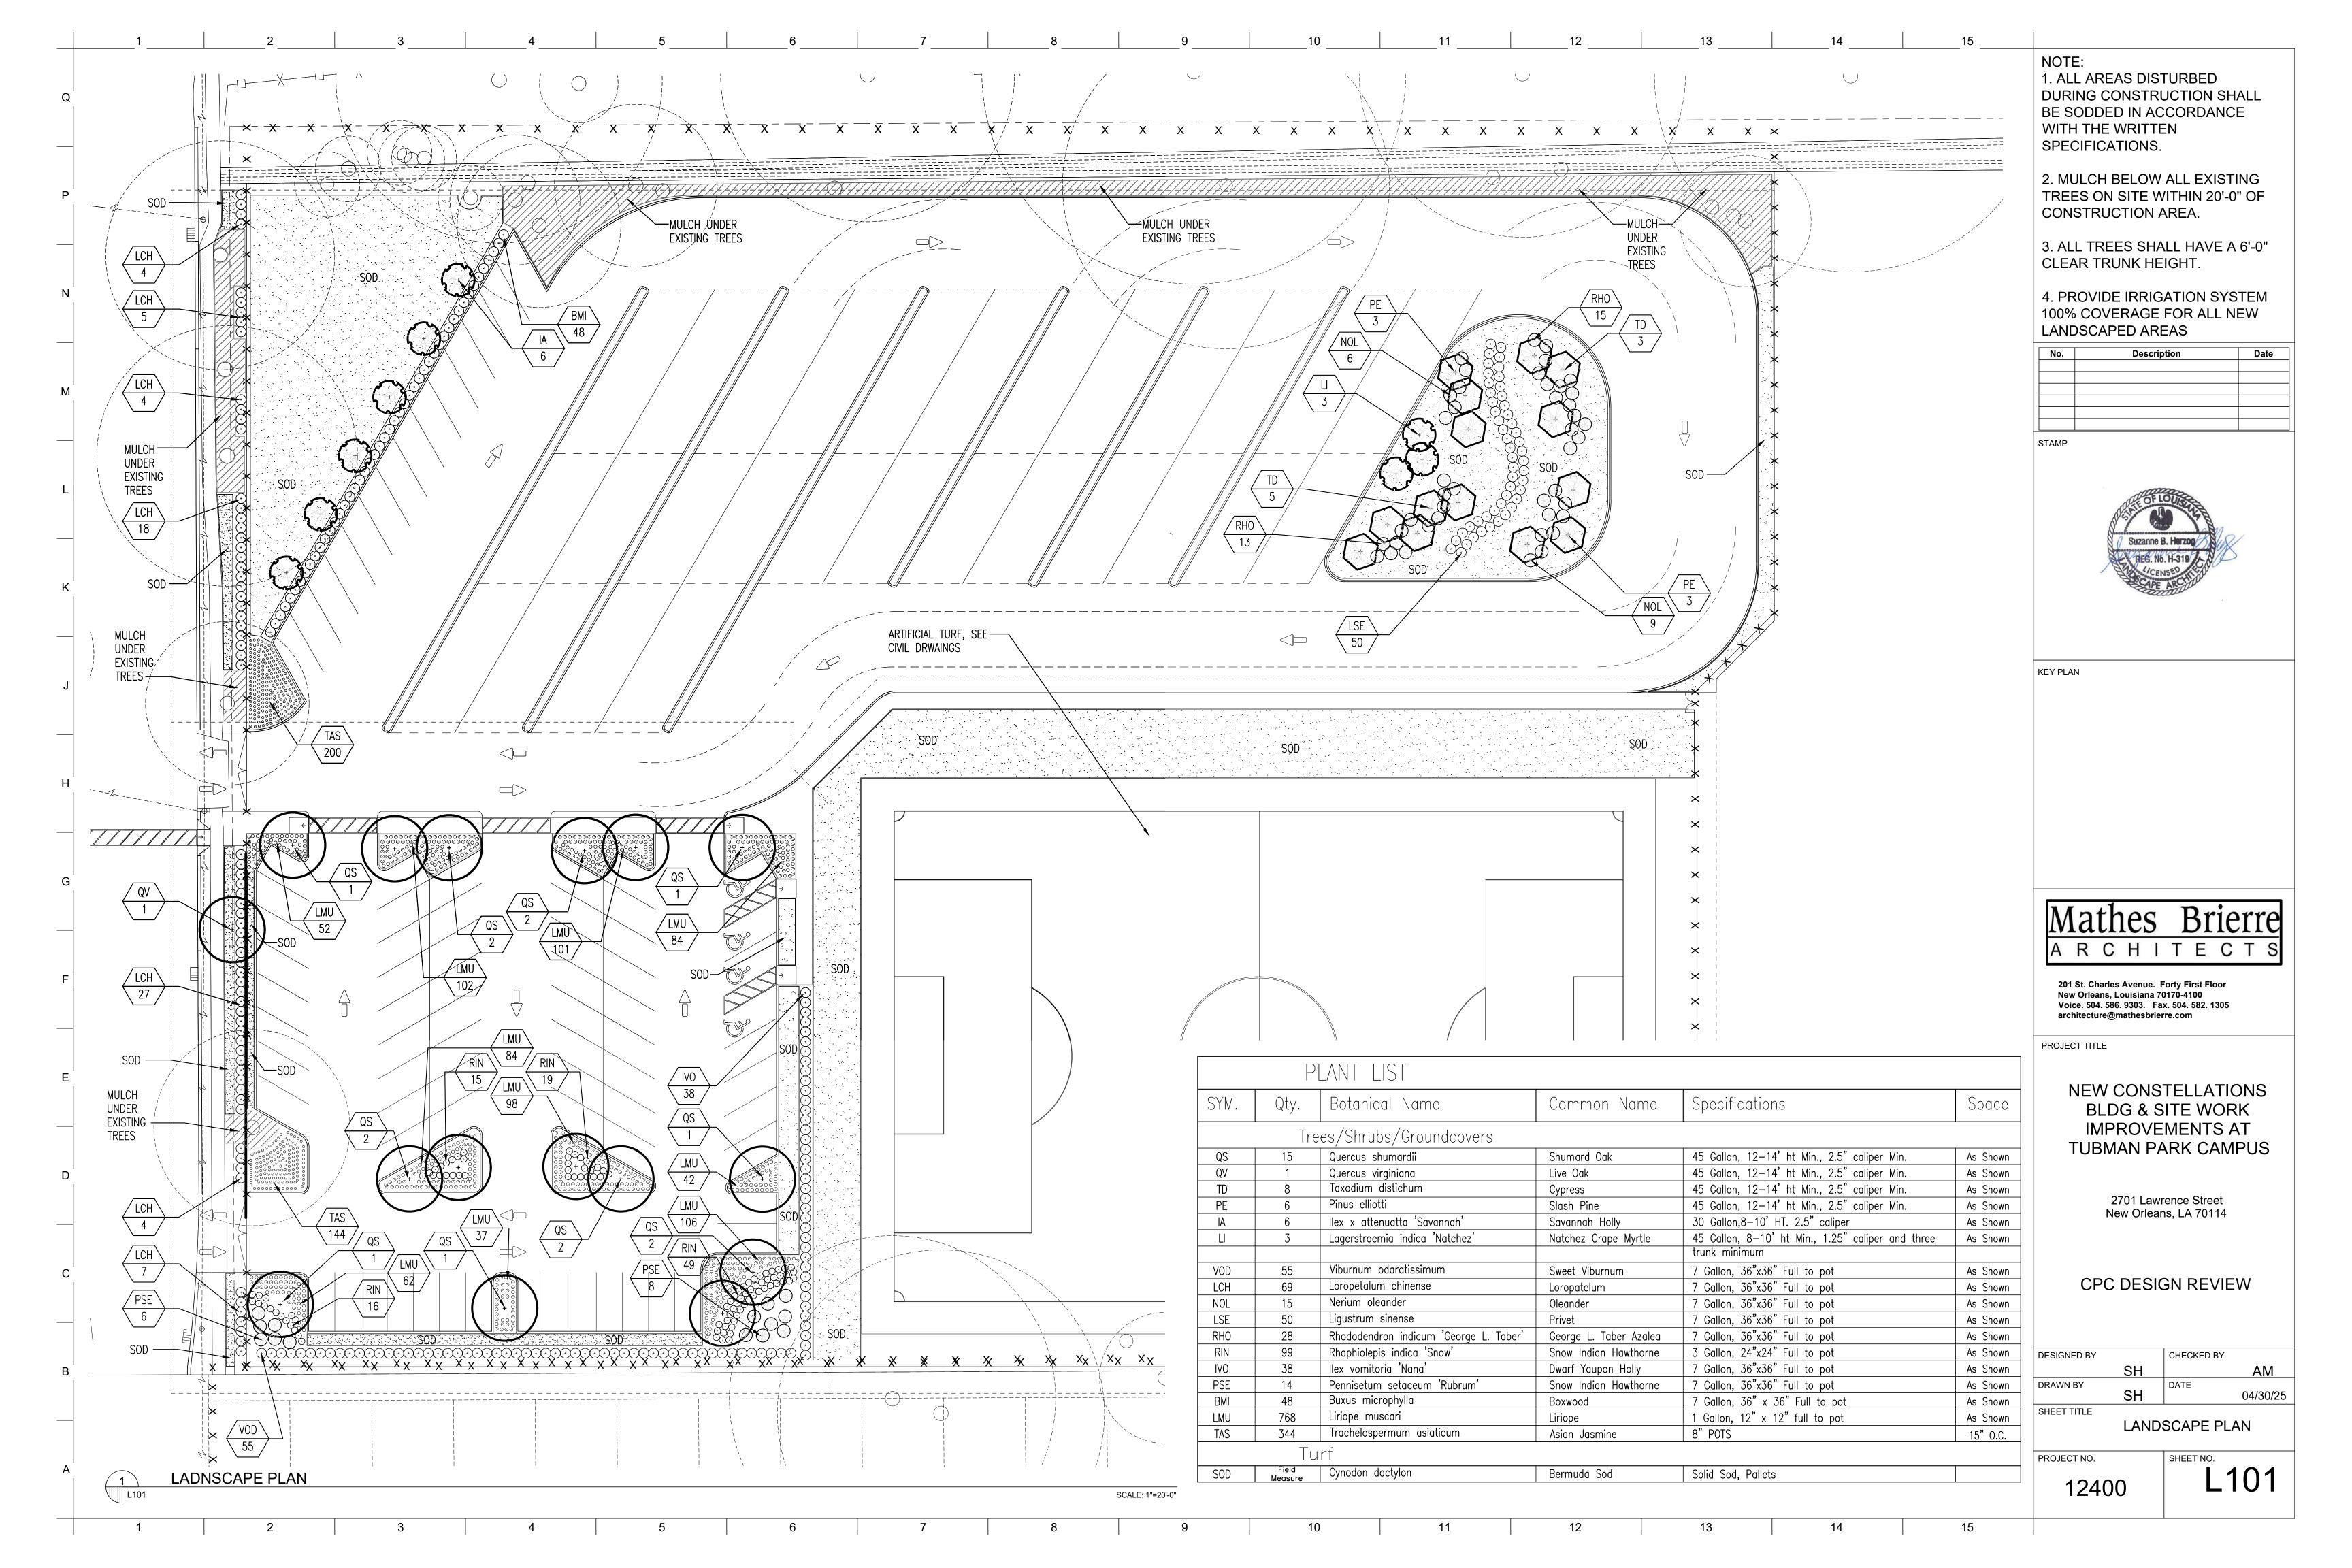
> 2701 Lawrence Street New Orleans, LA 70114


CPC DESIGN REVIEW

DESIGNED BY		CHECKED BY	
	SH		AM
DRAWN BY	SH	DATE	04/30/25
SHEET TITLE			

LANDSCAPE PLAN

PROJECT NO. L100 12400



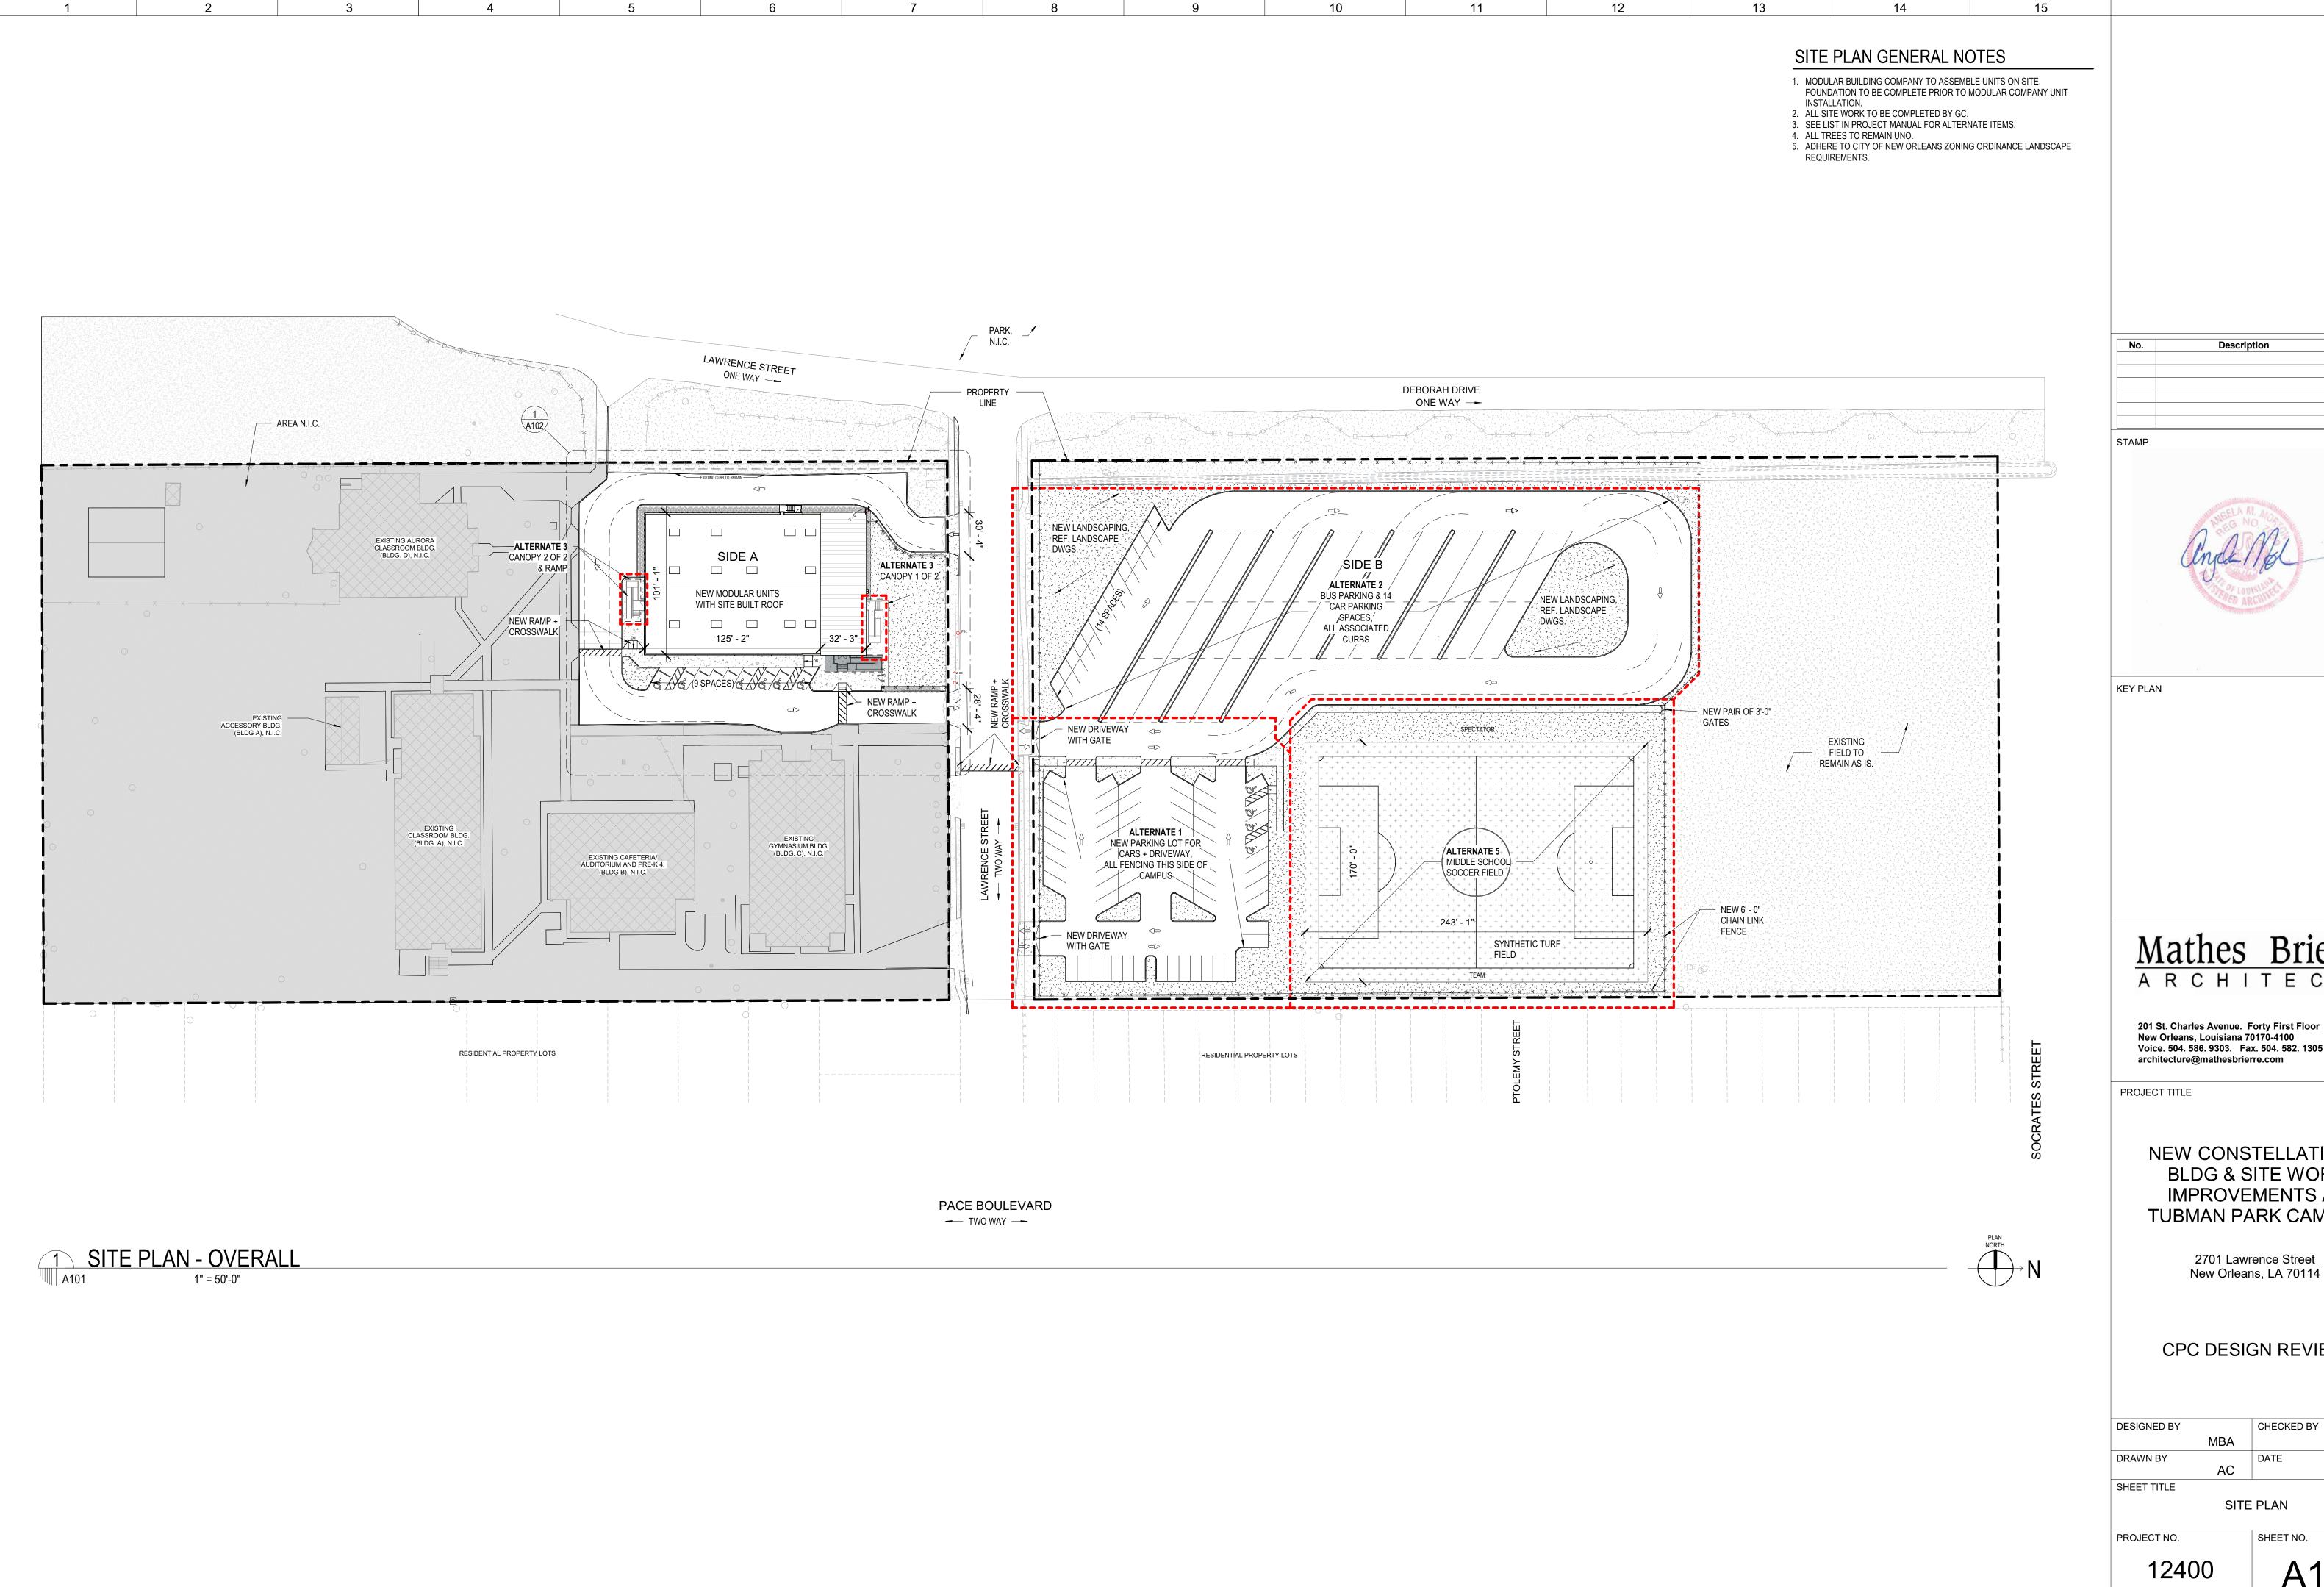

Date



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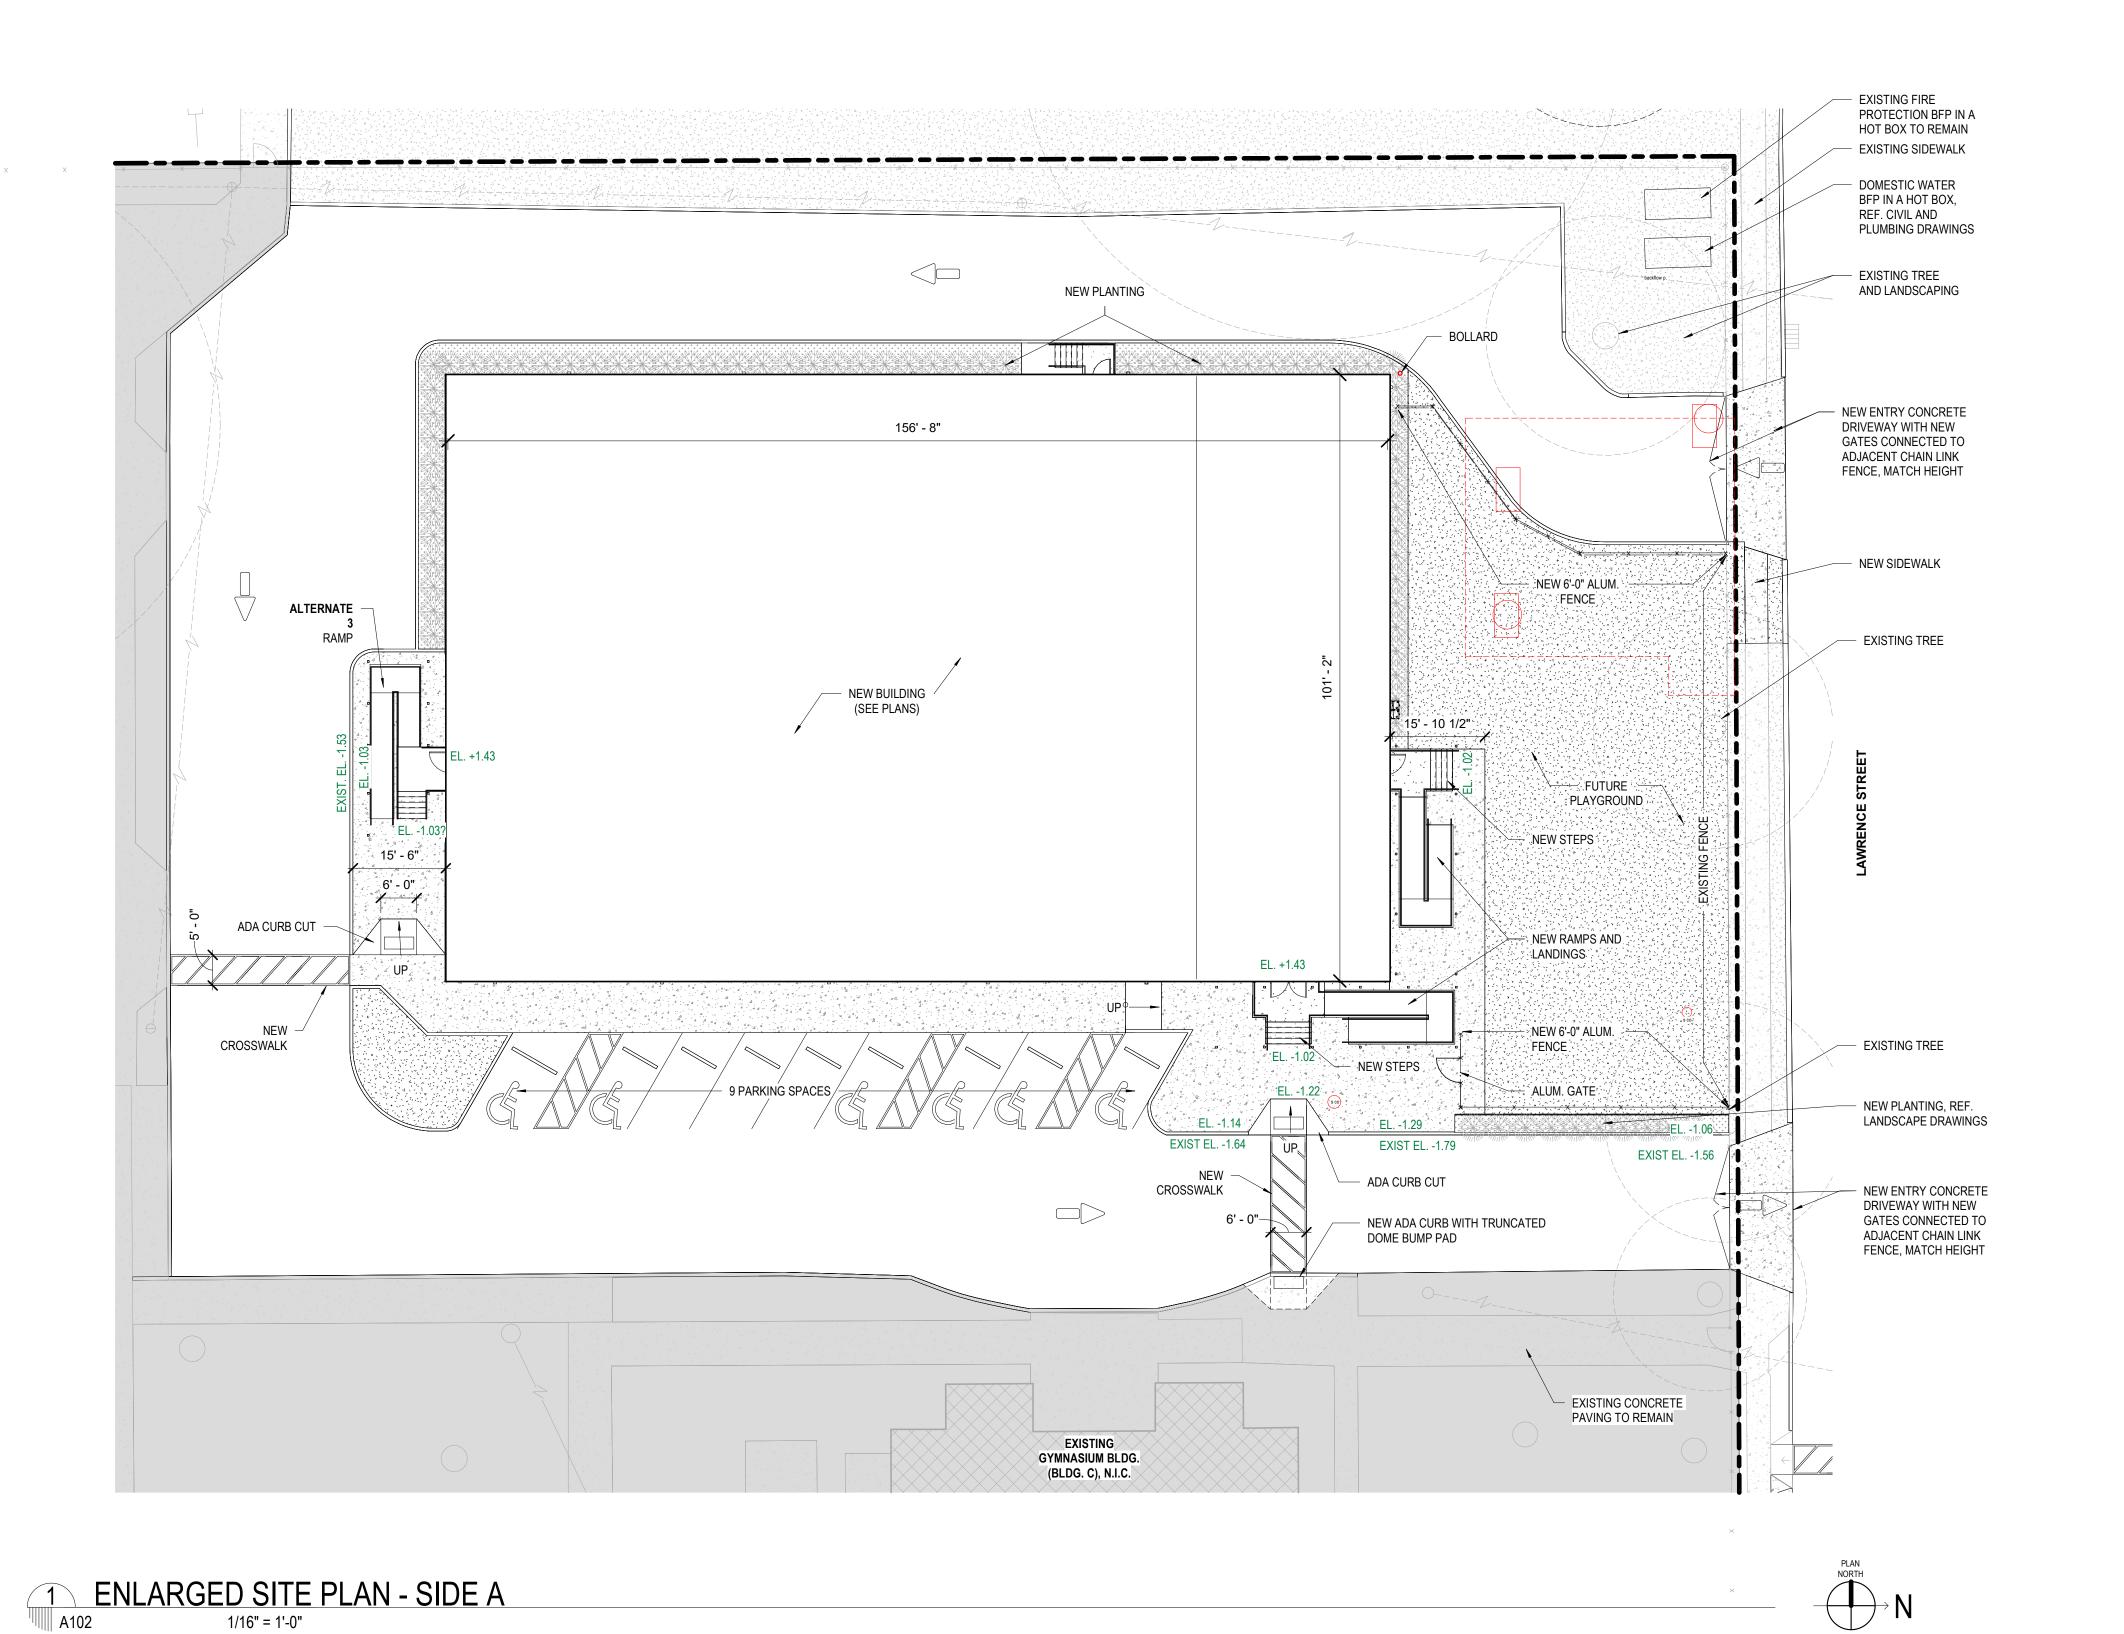
CPC DESIGN REVIEW

DESIGNED DI		CHECKED DI	
	MBA		AM
DRAWN BY		DATE	
	AC		04/30/25
SHEET TITLE			

SITE PLAN

13

A101



1/16" = 1'-0"

Description



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	MBA		AM
DRAWN BY		DATE	
	AC		04/30/25
SHEET TITLE			

PARTIAL SITE PLAN - SIDE A


12400


PROJECT NO.


12

A102

SHEET NO.

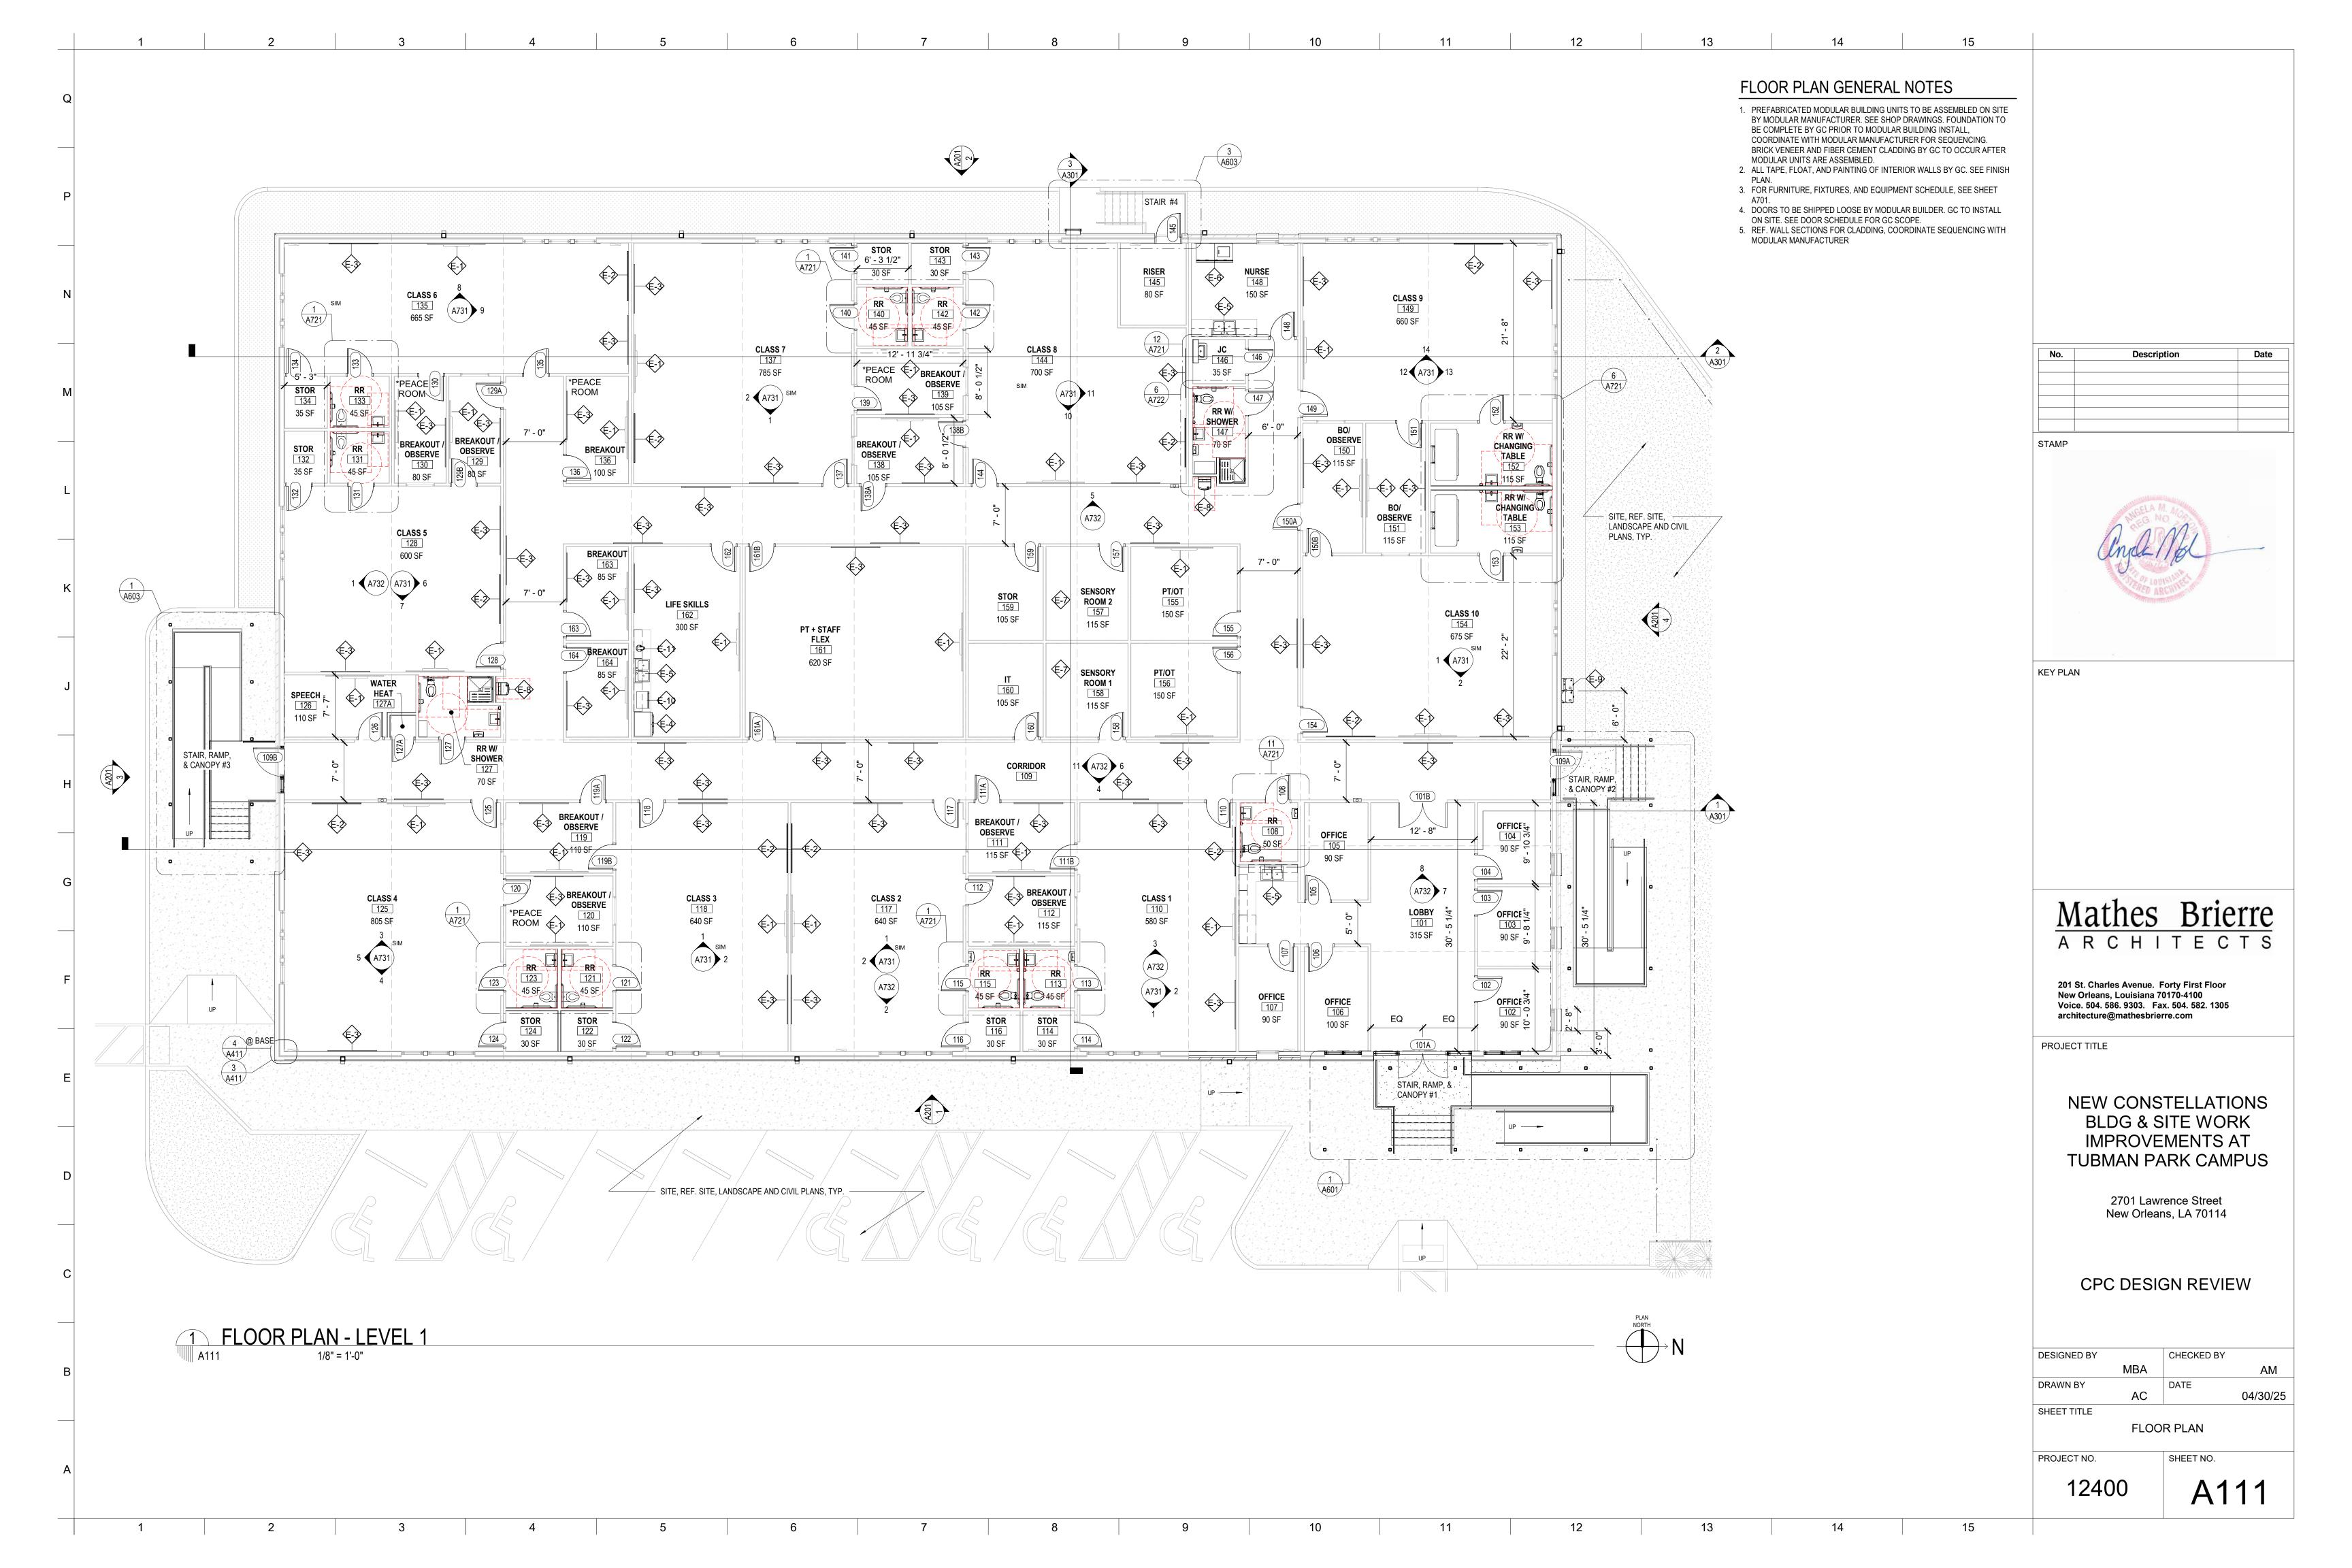

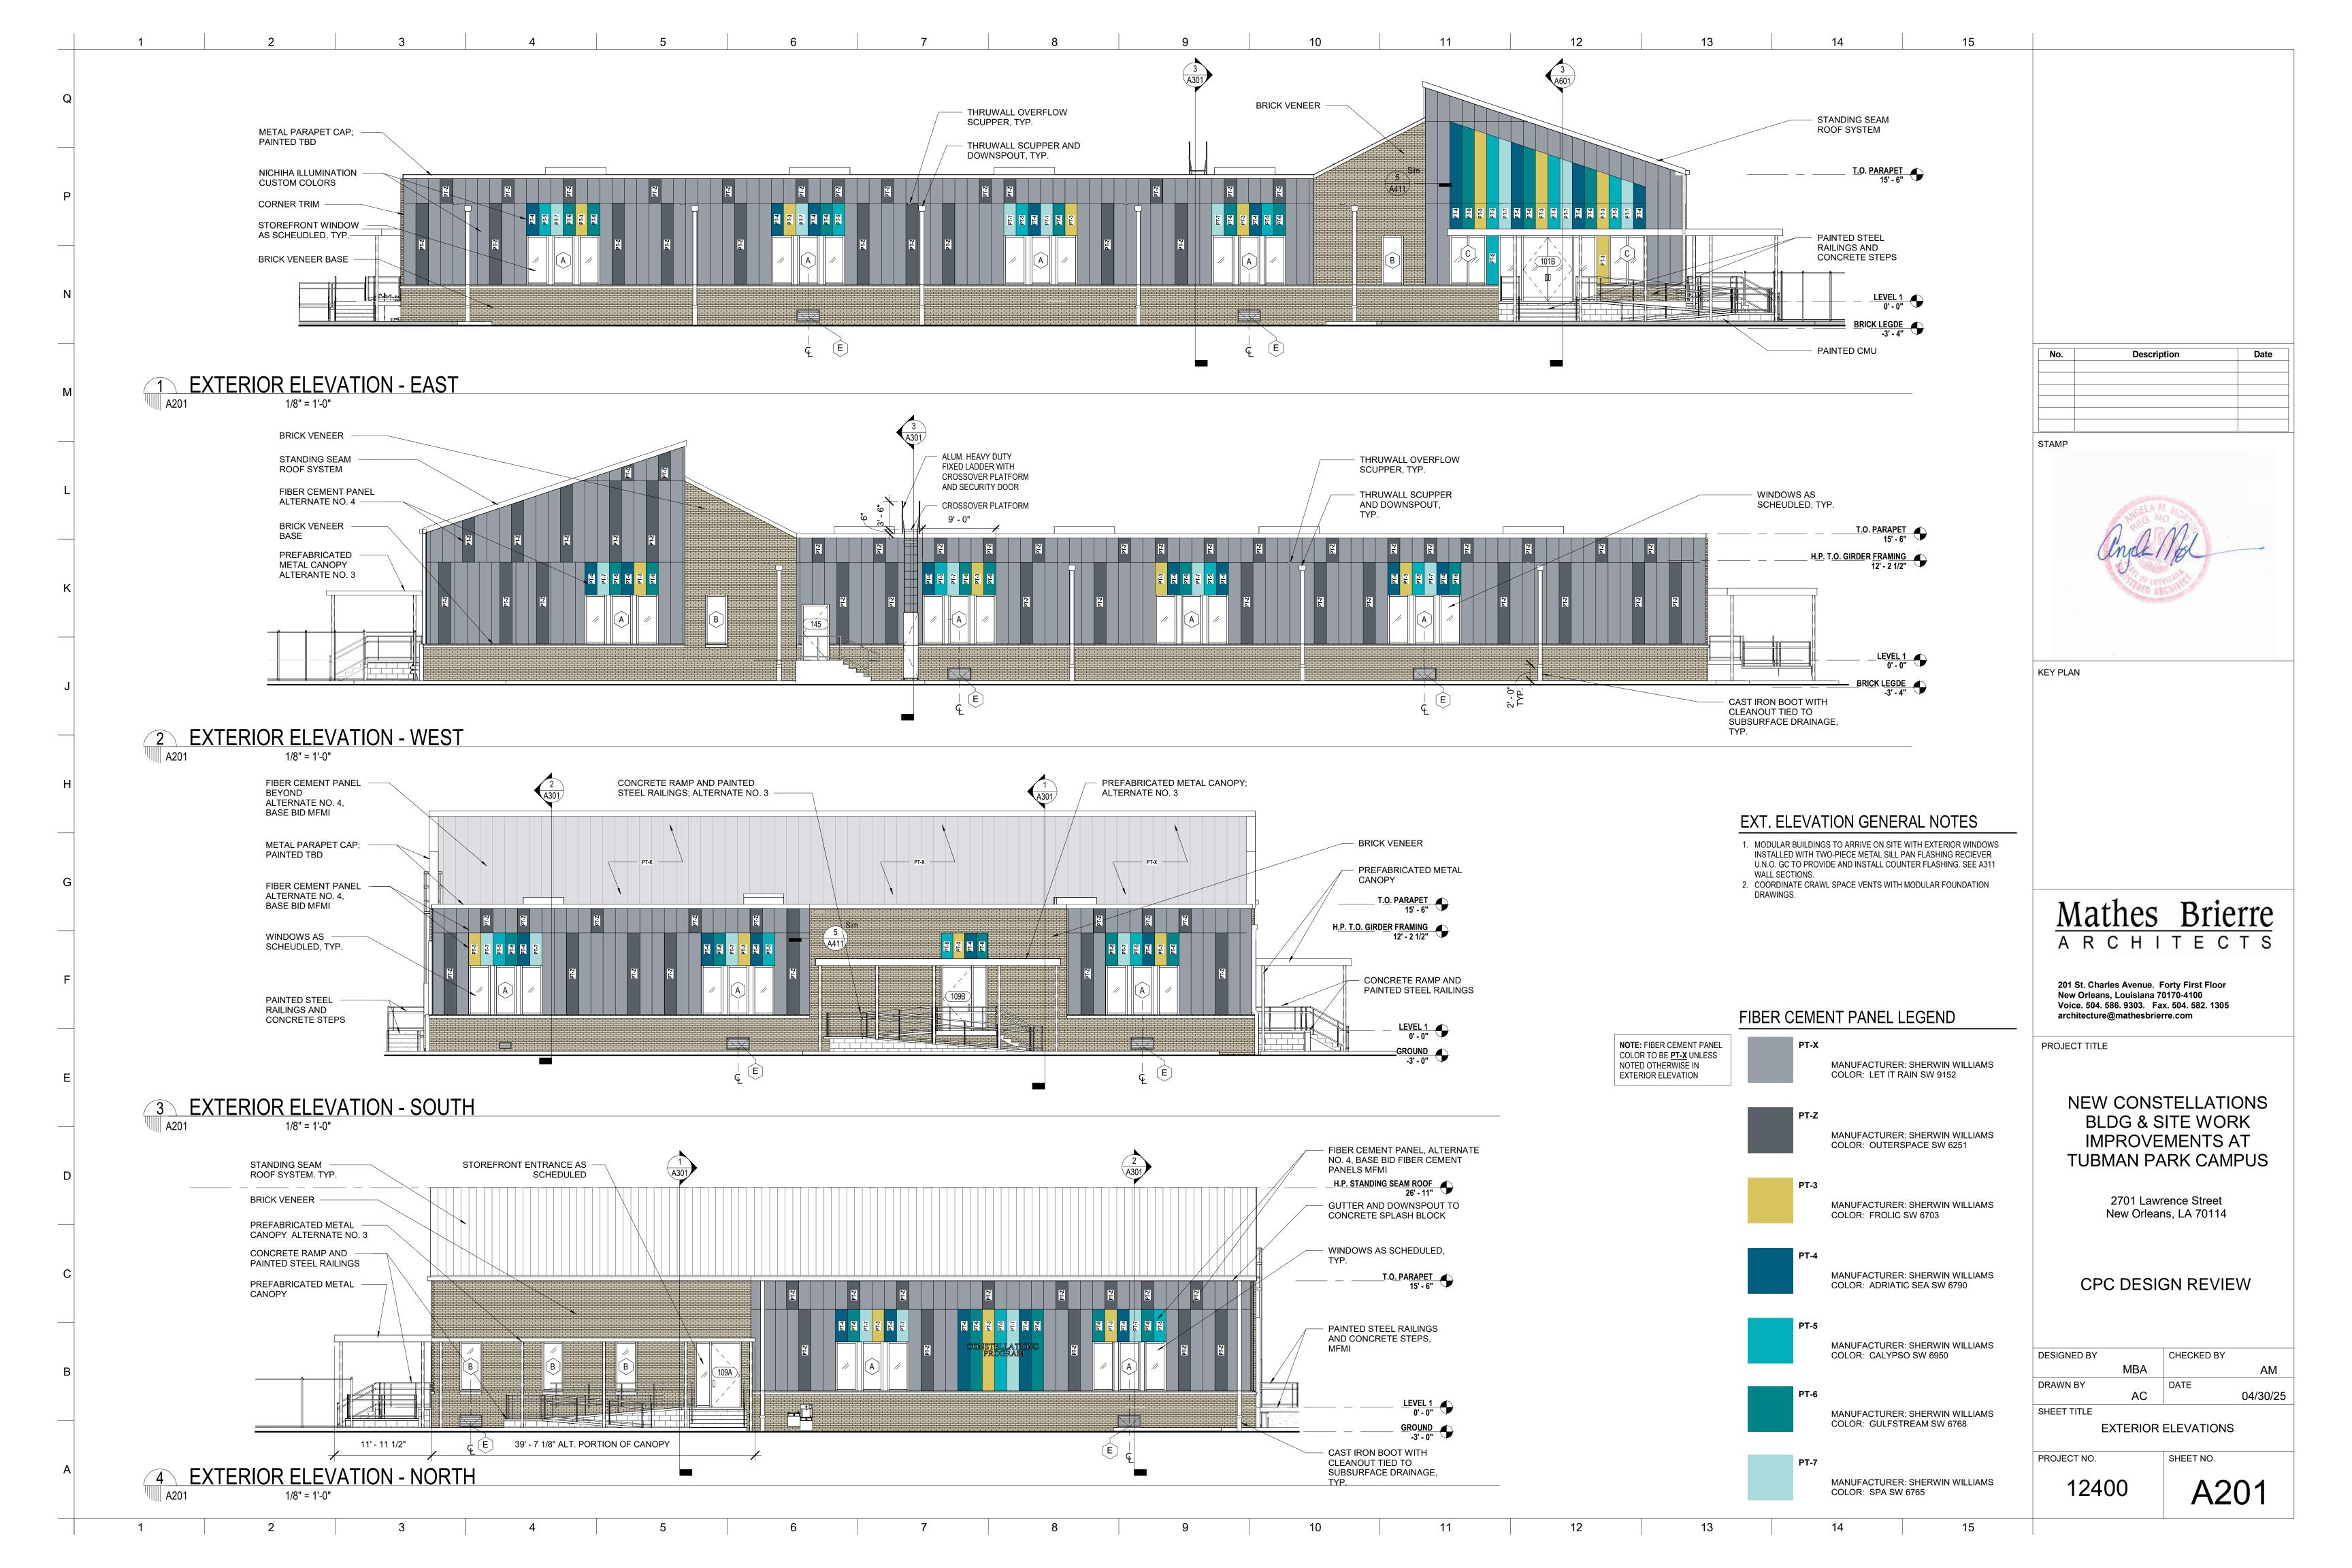

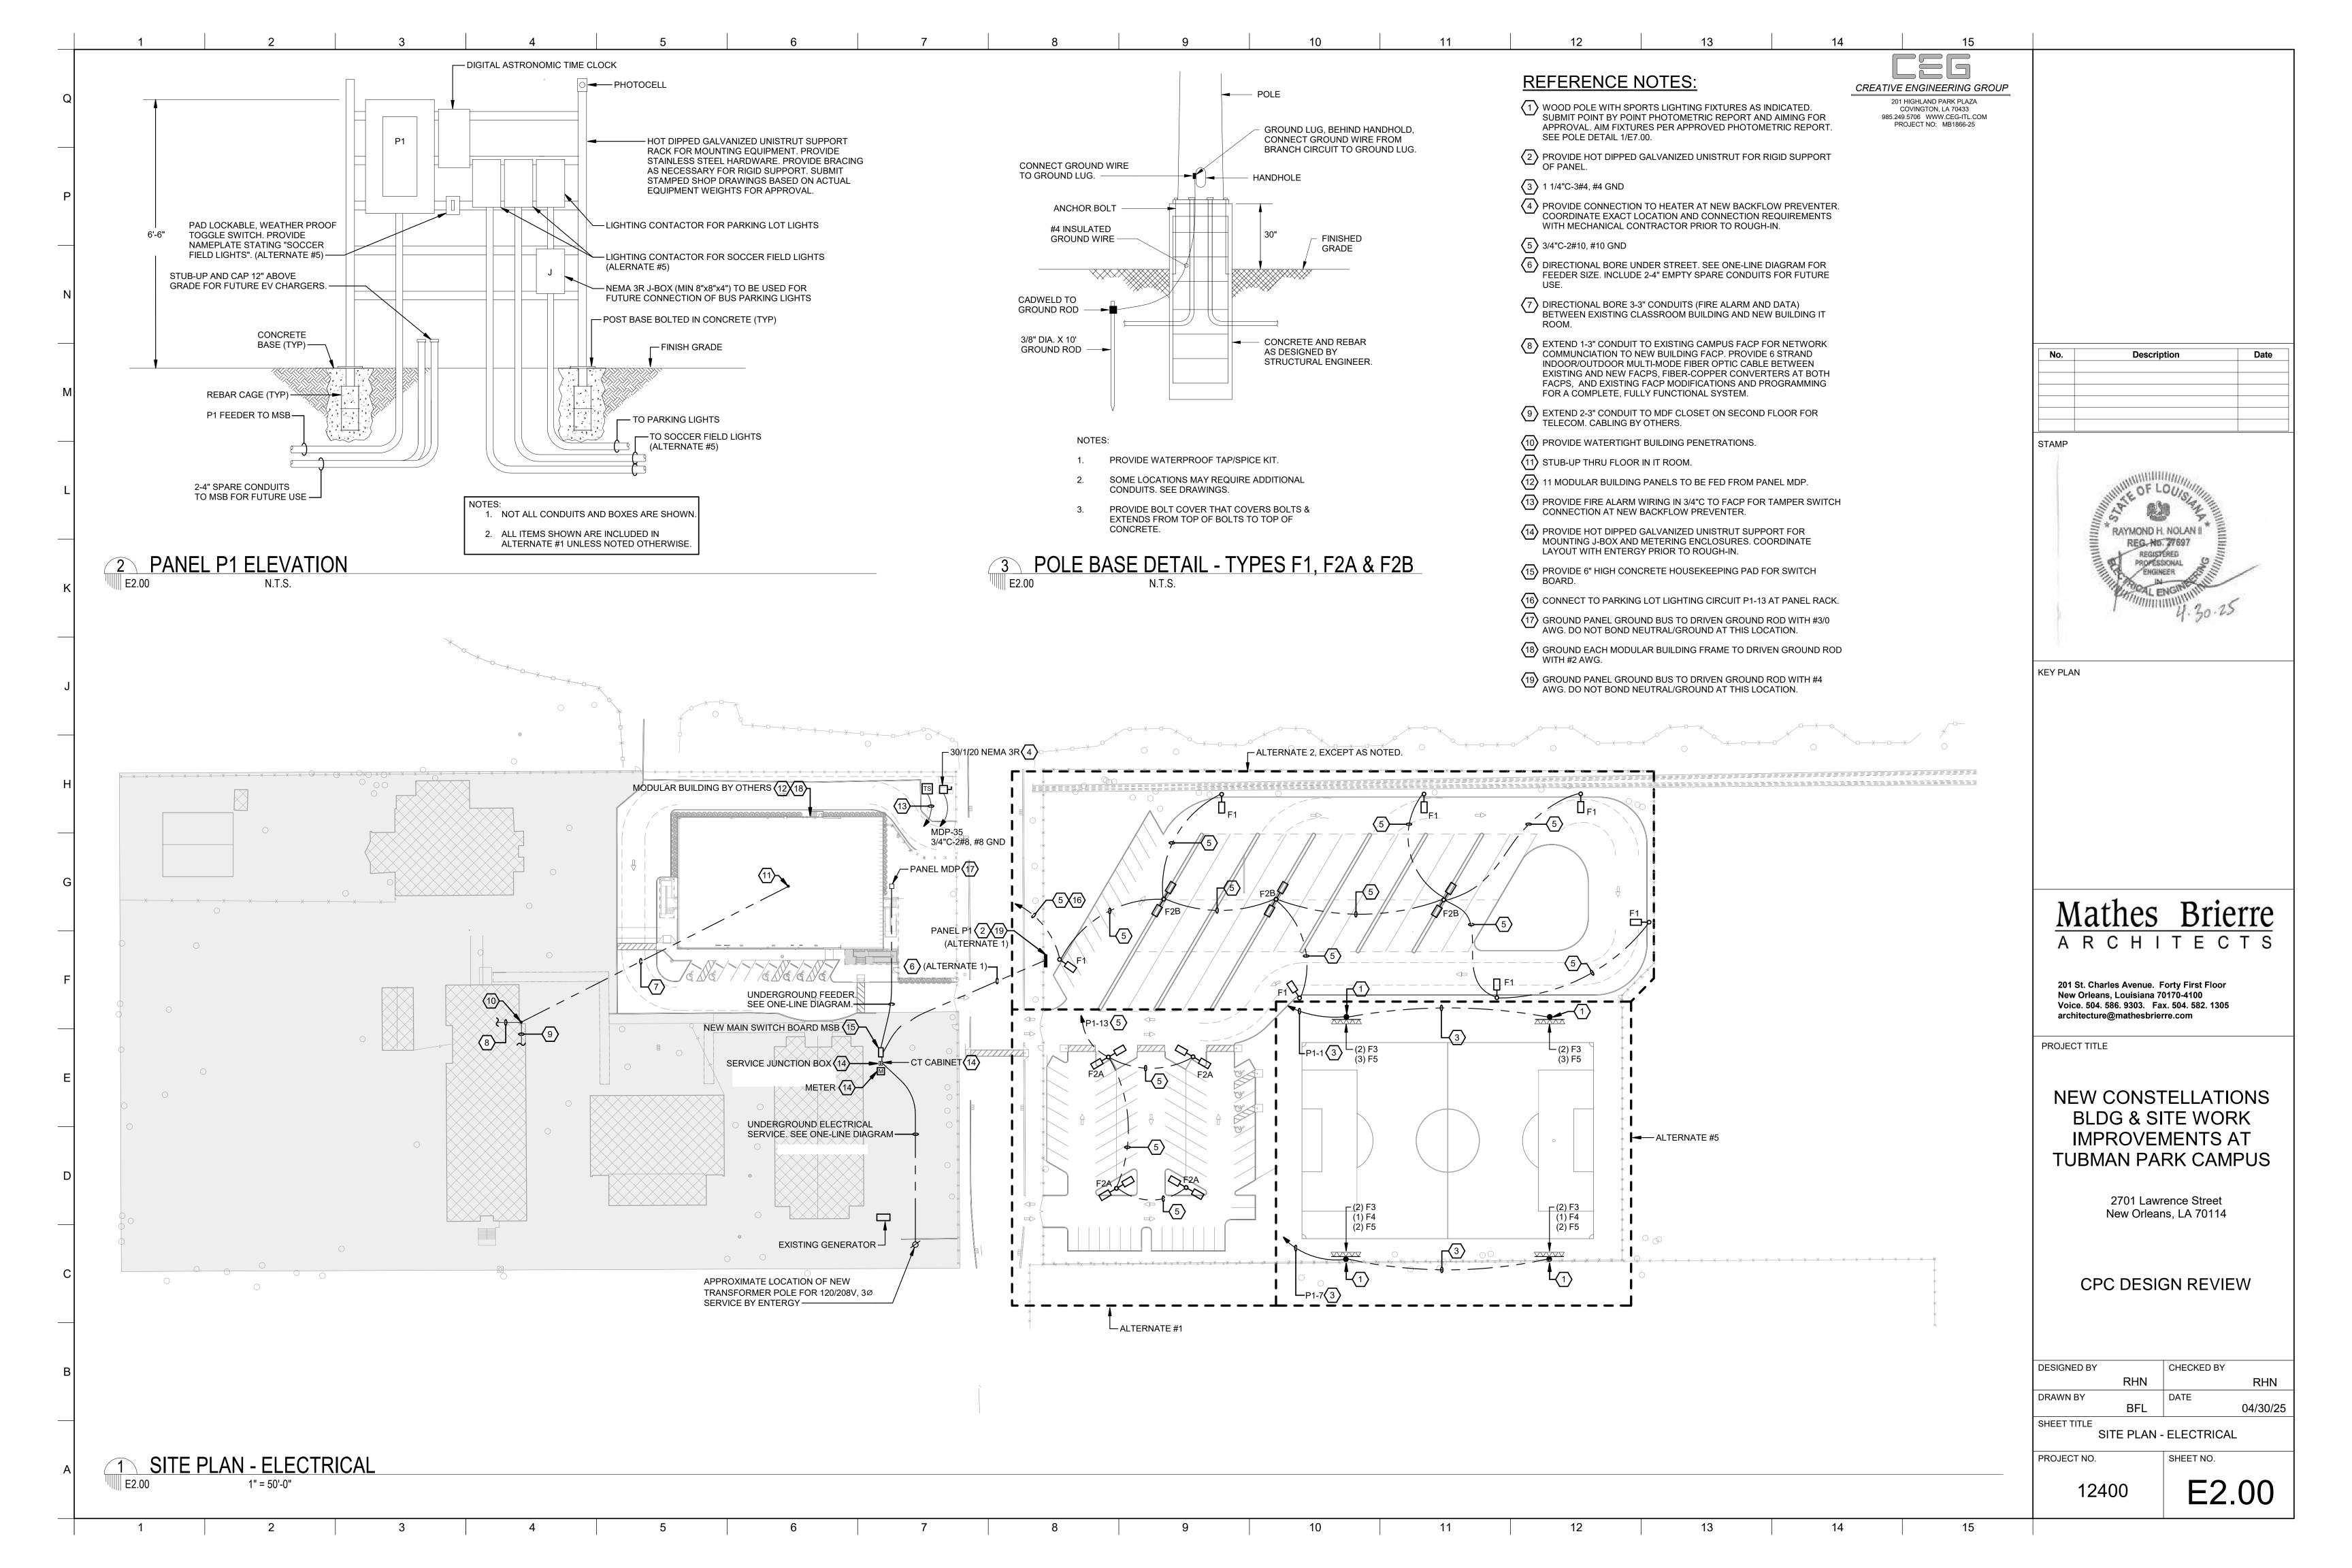






























1 SECONDARY ENTRANCE
G005





4 VIEW FROM LAWRENCE STREET

3 FRONT VIEW FROM LAWRENCE STREET

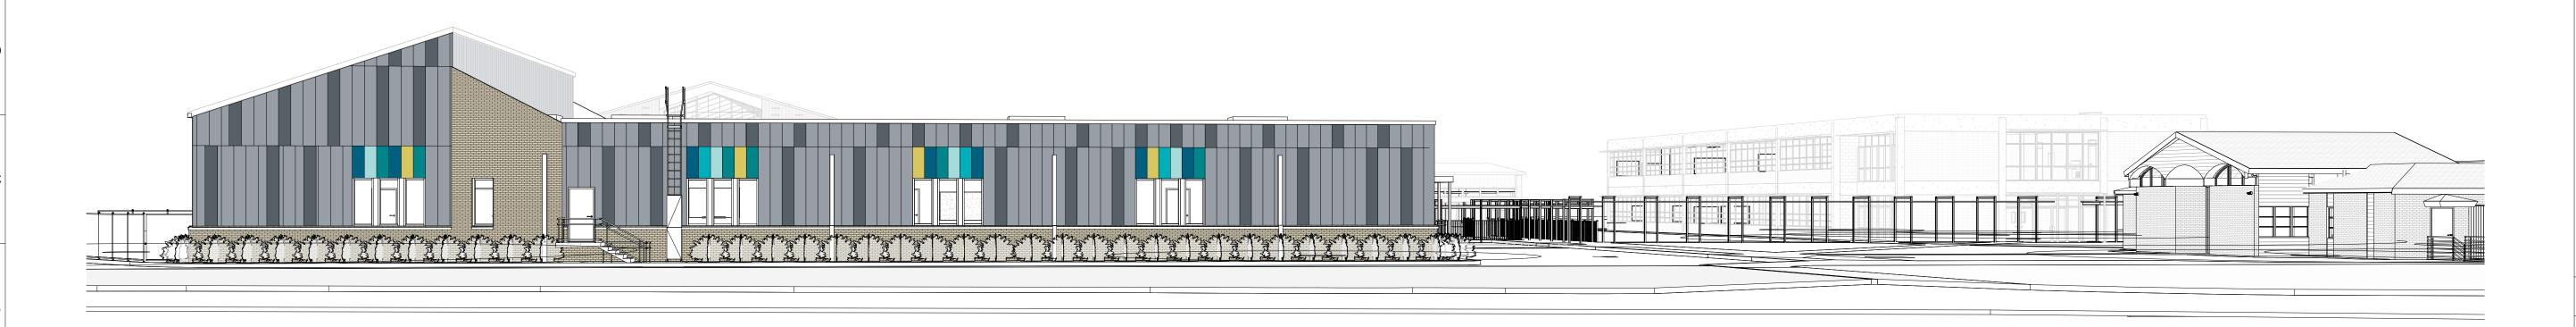

5 BACK VIEW
G005

12400

G005

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> 2701 Lawrence Street New Orleans, LA 70114

CPC DESIGN REVIEW

DESIGNED BY

MBA

CHECKED BY

AM

DRAWN BY

MBA

DATE

04/30/25

SHEET TITLE

RENDERINGS
PROJECT NO. SHEET NO.

LOT C

LOT B

TOTAL AREA

245,250 s.f.

IMPERVIOUS AREA

104,600 s.f.

TOTAL AREA

261,750 s.f.

IMPERVIOUS AREA

48,350 s.f.

PERMEABLE OPEN SPACE


140,650 s.f.

(57.3%)

PERMEABLE OPEN SPACE

213,400 s.f.

(81.5%)

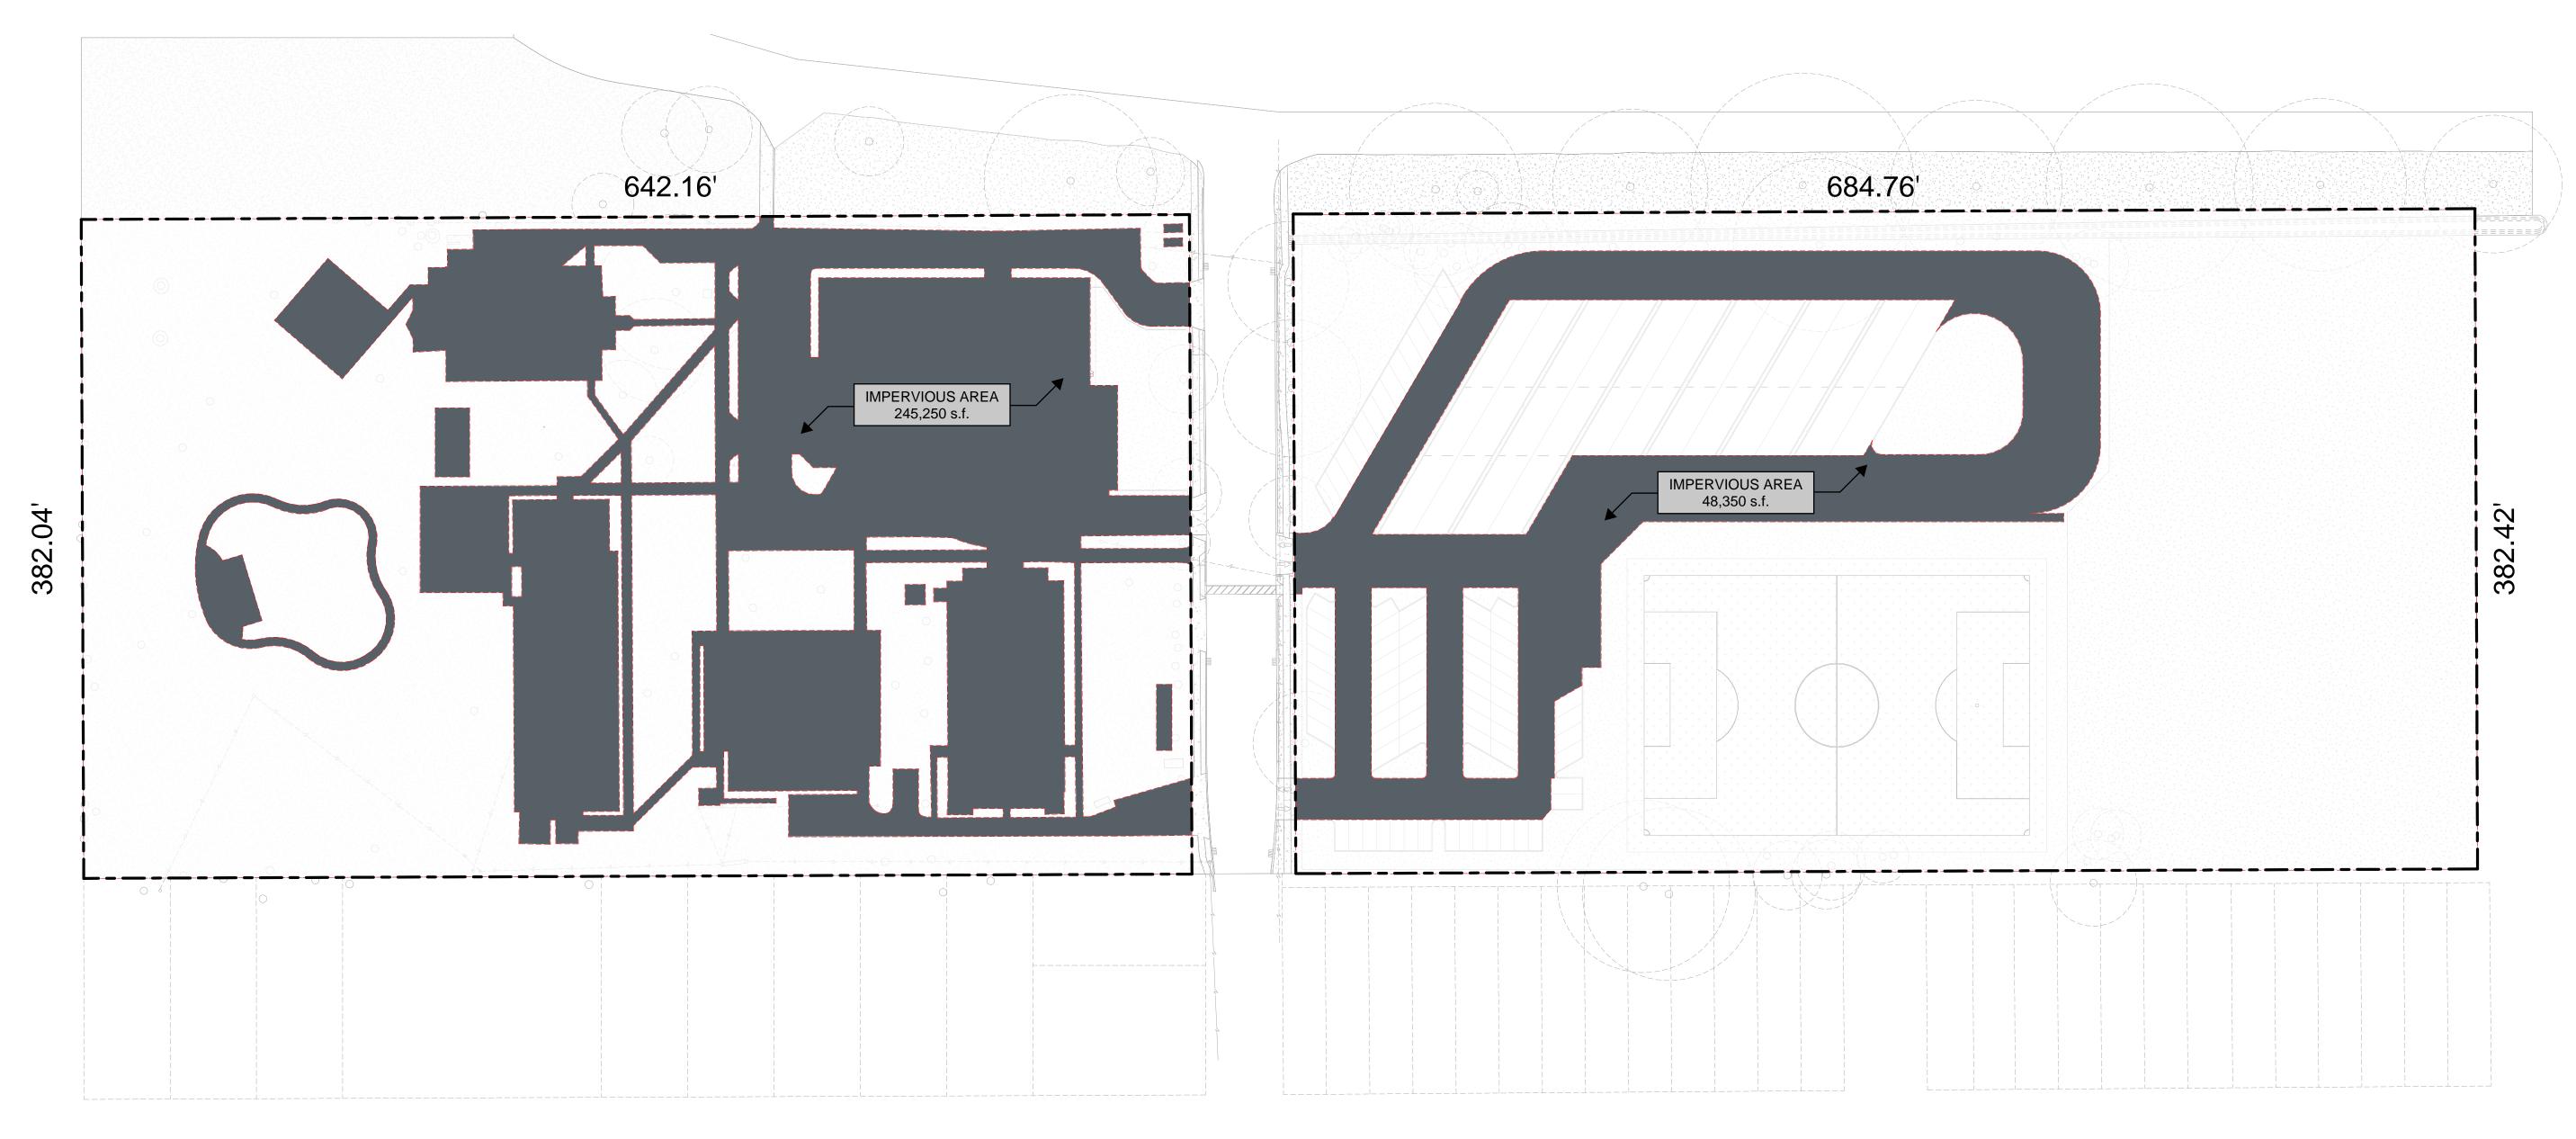

COMBINED TOTAL

TOTAL AREA

507,000 s.f.

IMPERVIOUS AREA

152,950 s.f.

PERMEABLE OPEN SPACE

354,050 s.f.

(69.8%)