# **Property Description**

One certain piece or portion of ground, together with all the buildings & improvements thereon and all of the rights, ways, servitudes, privileges, advantages and appurtenances thereunto belonging or in anywise appertaining, situated in the State of Louisiana, Parish of Orleans, Square No. 253 of the First Municipal District of the City of New Orleans, which square is bounded by Clio Street, Baronne Street, Erato Street and Oretha Castle Haley Boulevard, designated as Lot A1 on a plan of resubdivision of Lots "A", "B", 1, 5 and an Alley into Lot A1 dated September 5, 2025 by Gilbert, Kelly & Couturie, Inc., Professional Land Surveying, and is more particularly described as follows, to wit:


From the point of intersection of the easterly right of way line of Erato Street and the southerly right of way line of Oretha Castle Haley Boulevard proceed in an easterly direction along the southerly right of way line of Oretha Castle Haley Boulevard a distance of 79 feet 10 inches 7 lines (79.10.7) to the point of beginning; thence continuing in an easterly direction along the  $\frac{1}{2}$ southerly right of way line of Oretha Castle Haley Boulevard, a distance of 106 feet 6 inches 4 lines (106.6.4) to a point; thence in a southerly direction through an interior angle of 89 degrees 59 minutes 40 seconds, a distance of 110 feet 9 inches 6 lines (110.9.6) to a point; thence in a westerly direction through an interior angle of 90 degrees 00 minutes 20 seconds, a distance of 106 feet 6 inches 4 lines (106.6.4) to a point: thence in a northerly direction through an interior angle of 89 degrees 59 minutes 40 seconds, a distance of 110 feet 9 inches 6 lines (110.9.6) back to a point on the southerly right of way line of Oretha Castle Haley Boulevard, said point being the point of beginning. Lot A1 contains 11,805.74 square feet. The improvements thereon bear Municipal No. 1228 Oretha Castel Haley Boulevard, New Orleans, Louisiana 70113.

Gilbert, Kelly & Couturie', Inc., Professional Land Surveying 2121 N. Causeway Blvd. – Suite 121 Metairie, La 70001

# DAC SET

# 1228 OC HALEY BLVD. 1228 OC Haley Blvd. **NEW ORLEANS LA**



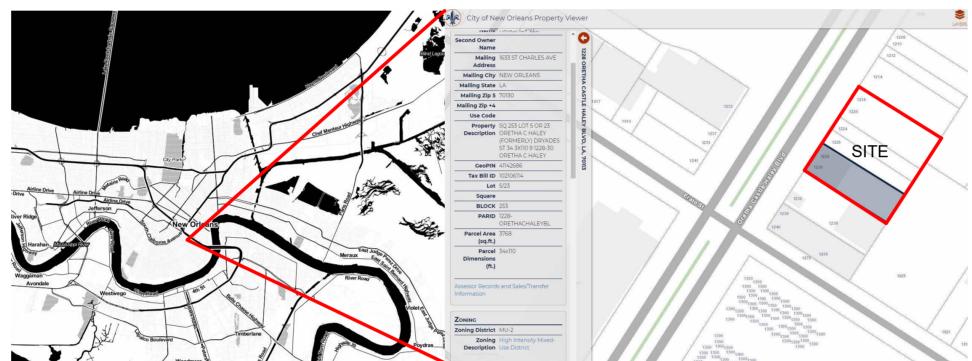

		SHEET INDEX		
Page Number	Sheet Number	Sheet Name	Sheet Issue Date	Current Revision Date
SITE/GEN	NERAL INFO			
1	A1.0	TITLE SHEET	09-15-25	
2	A1.1	EXISTING SITE PLAN	09-15-25	
2	A2.0	PROPOSED SITE PLAN	09-15-25	
2	A2.1	SITE PLAN DETAILS	09-15-25	
2	A2.2	SITE PLAN DETAILS	09-15-25	

# MEP VALUE OF WORK

THE MECHANICAL SCOPE OF WORK IS LESS THAN \$20,000 AND THEREFORE DOES NOT REQUIRE A MECHANICAL ENGINEER PER ORLEANS PARISH REQUIREMENTS. THIS WORK SHALL BE PERFORMED AS A PERFORMANCE SPECIFICATION AND THE GENERAL CONTRACTOR'S SUBCONTRACTOR SHALL PROVIDE ALL NECESSARY DOCUMENTS TO PROPERLY MEET CODE AND INDICATED SCOPE REQUIREMENTS.

# PLUMBING ENGINEER:

THE PLUMBING SCOPE OF WORK IS LESS THAN \$20,000 AND THEREFORE DOES NOT REQUIRE A MECHANICAL ENGINEER PER ORLEANS PARISH REQUIREMENTS. THIS WORK SHALL BE PERFORMED AS A PERFORMANCE SPECIFICATION AND THE GENERAL CONTRACTOR'S SUBCONTRACTOR SHALL PROVIDE ALL NECESSARY DOCUMENTS TO PROPERLY MEET CODE AND INDICATED SCOPE REQUIREMENTS.

# **ELECTRICAL ENGINEER:**

THE ELECTRICAL SCOPE OF WORK IS LESS THAN \$20,000 AND THEREFORE DOES NOT REQUIRE A MECHANICAL ENGINEER PER ORLEANS PARISH REQUIREMENTS. THIS WORK SHALL BE PERFORMED AS A PERFORMANCE SPECIFICATION AND THE GENERAL CONTRACTOR'S SUBCONTRACTOR SHALL PROVIDE ALL NECESSARY DOCUMENTS TO PROPERLY MEET CODE AND INDICATED SCOPE REQUIREMENTS.

# PROJECT / CONTRACT INFORMATION

# PROJECT DESCRIPTION

**EXPANSION OF EXISTING PROPERTY TO** INCLUDE 2 ADJACENT LOTS (TO BE SUBDIVIDED INTO 1 LOT OF RECORD). EXISTING 2 STORY BUILDING, 1ST FLOOR TO BE BAR USE, 2ND FLOOR NOT OCCUPIED. EXTERIOR IMPROVEMENTS INCLUDE NEW REAR YARD ACCESSORY STRUCTURE AND DECK, OFF-STREET PARKING LOT, FENCING, AND LANDSCAPE.

# ARCHITECT:

**ZACH SMITH** 530 N NORMAN C FRANCIS PARKWAY, NEW ORLEANS, LA 70119 504-383-3748

# ZONING/CODE INFORMATION

# **ZONING DISTRICT**: MU-2

OVERLAY DISTRICT: SMALL MULTI-FAMILY AFFORDABLE STR RESIDENTIAL STR

# HDLC DISTRICT: CENTRAL CITY

#### PROPOSED DEVELOPMENT: BUILDING SQUARE FOOTAGE (TOTAL): 2960 SQ. FT. COVERED REAR PATIO SQUARE FOOTAGE (TOTAL): 638 SQ. FT.

NO. OF STORIES: 2 **BUILDING HEIGHT: 30'-5"** 

#### **APPLICABLE CODES:** 2021 IBC WITH NEW ORLEANS CODE ADOPTIONS 2021 INTERNATIONAL MECHANICAL CODE 2021 LOUISIANA STATE PLUMBING CODE 2021 NATIONAL ELECTRIC CODE 2015 ADA ADDA GUIDELINES

PROJECT INFORMATION

# Description

228 1228 NEV



TITLE SHEET

Project number	23005
Date	09/11/25
Drawn by	MG
Checked by	ZS

TH	HE GENERAL CONTRACTOR	R IS RESPONSIBLE TO SU	IPPLY ALL SUBCONT	RACTORS WITH CONSTR	RUCTION DRAWINGS AND

SPECIFICATIONS NECESSARY TO BID AND/OR CONSTRUCT THIS PROJECT. TO THE GENERAL CONTRACTOR AND ALL SUBCONTRACTORS: ALL CONTRACTORS ARE RESPONSIBLE TO NOTIFY THE ARCHITECT OF ANY ERRORS, OMISSIONS OR DISCREPANCIES PRIOR TO MAKING ANY CHANGES TO THE CONSTRUCTION DOCUMENTS.

ALL DIMENSIONS ON THE FLOOR PLANS, UNLESS OTHERWISE NOTED, ARE TAKEN FROM INSIDE FACE OF STUDS OF EXTERIOR WALLS, CENTER OF STUDS OF NEW INTERIOR PARTITIONS, FACES OR CENTERLINE OF STRUCTURAL COLUMNS, AND FACES OF EXISTING WALLS.

THE OWNER SHALL BE RESPONSIBLE FOR NOTIFYING THE GENERAL CONTRACTOR FOR ALL WALL HUNG ITEMS TO BE INSTALLED THAT ARE NOT ON THE DRAWINGS.

IN ACCORDANCE WITH GENERALLY ACCEPTED CONSTRUCTION PRACTICES, THE CONTRACTOR WILL BE SOLELY AND COMPLETELY RESPONSIBLE FOR CONDITIONS OF THE JOB SITE, INCLUDING SAFETY OF ALL PERSONS AND PROPERTY DURING PERFORMANCE OF WORK. THIS REQUIREMENT WILL APPLY CONTINUOUSLY AND NOT BE LIMITED TO NORMAL WORKING HOURS. THE CONTRACTOR SHALL TAKE ALL NECESSARY PRECAUTIONS TO INSURE THE SAFETY OF THE PUBLIC AND/OR WORK PERSONS ON THE JOB TO PREVENT ACCIDENTS OR INJURY TO ANY PERSON ON, ABOUT OR ADJACENT TO THE PREMISES. THE CONTRACTOR SHALL COMPLY WITH ALL LAWS, ORDINANCES, CODES, RULES AND REGULATIONS RELATIVE TO SAFETY AND THE PREVENTION OF ACCIDENTS.

WHETHER OR NOT SPECIFICALLY INDICATED ON THE DRAWINGS, ALL CONTRACTORS SHALL BE RESPONSIBLE FOR REMOVING OR DEMOLISHING EXISTING CONSTRUCTION (INCLUDING UTILITIES) WHICH WILL INTERFERE WITH NEW WORK. PRIOR TO THE SHUT-DOWN OR TYING INTO ANY UTILITY, APPROVAL SHALL BE OBTAINED FROM THE OWNER'S


REPRESENTATIVE. COORDINATE WITH OWNER'S REPRESENTATIVE THE LOCATION OF CONTRACTOR'S EQUIPMENT AND MATERIAL STORAGE. THE CONSTRUCTION DRAWINGS CONTAIN INFORMATION FOR MULTIPLE CONTRACTORS. OWNER PROVIDED AND INSTALLED ITEMS ARE SHOWN FOR INFORMATIVE PURPOSES. THE GENERAL CONTRACTOR SHALL VERIFY OWNER PROVIDED AND INSTALLED ITEMS AND COORDINATE INSTALLATION WITH OWNER'S REPRESENTATIVE TO AVOID CONFLICTS OR

DISCREPANCIES. CONTRACTOR SHALL PROVIDE AND INSTALL ALL MATERIALS IN ACCORDANCE WITH ALL LOCAL, STATE, AND FEDERAL


ALL PERMIT FEES SHALL BE PAID BY CONTRACTOR.


CONTRACTOR SHALL BE RESPONSIBLE FOR AND PAY FOR ALL UTILITY DEPOSITS, IMPACT FEES AND CONNECTION FEES

**GENERAL NOTES - PROJECT** 

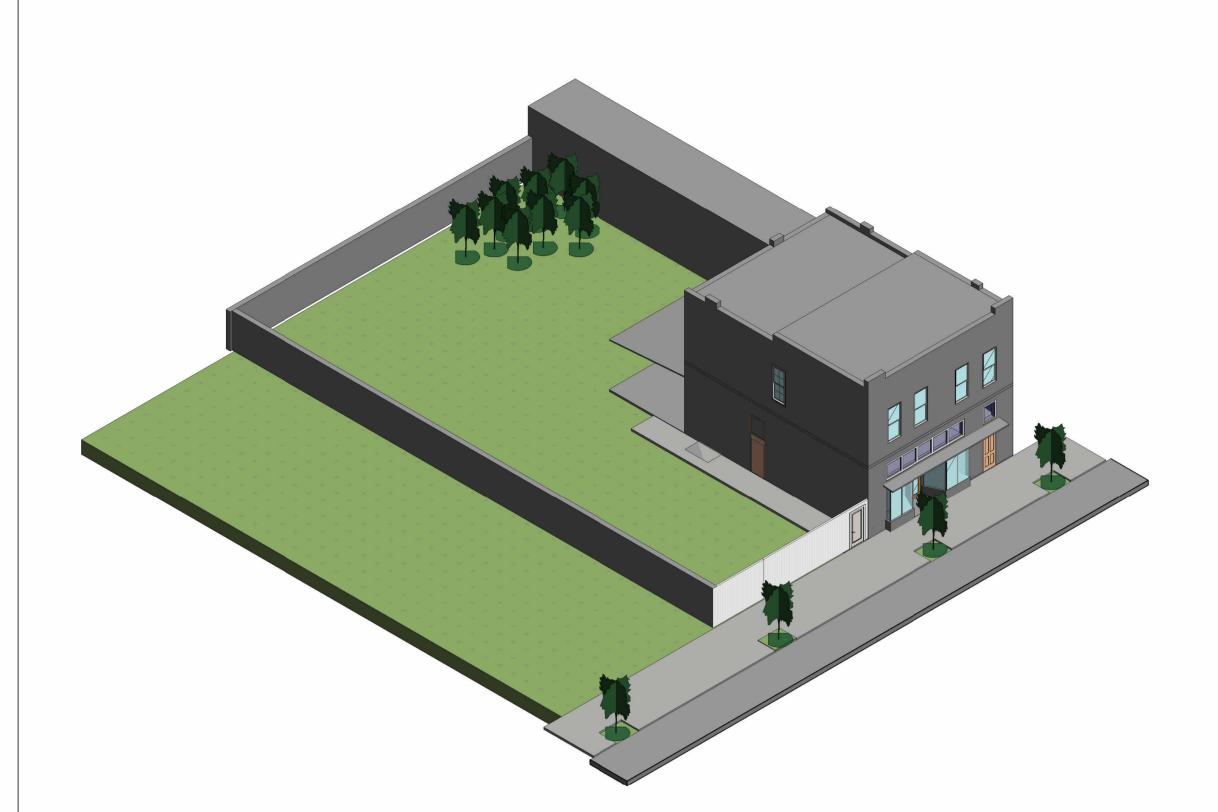


# BARONNE ST. (SIDE)

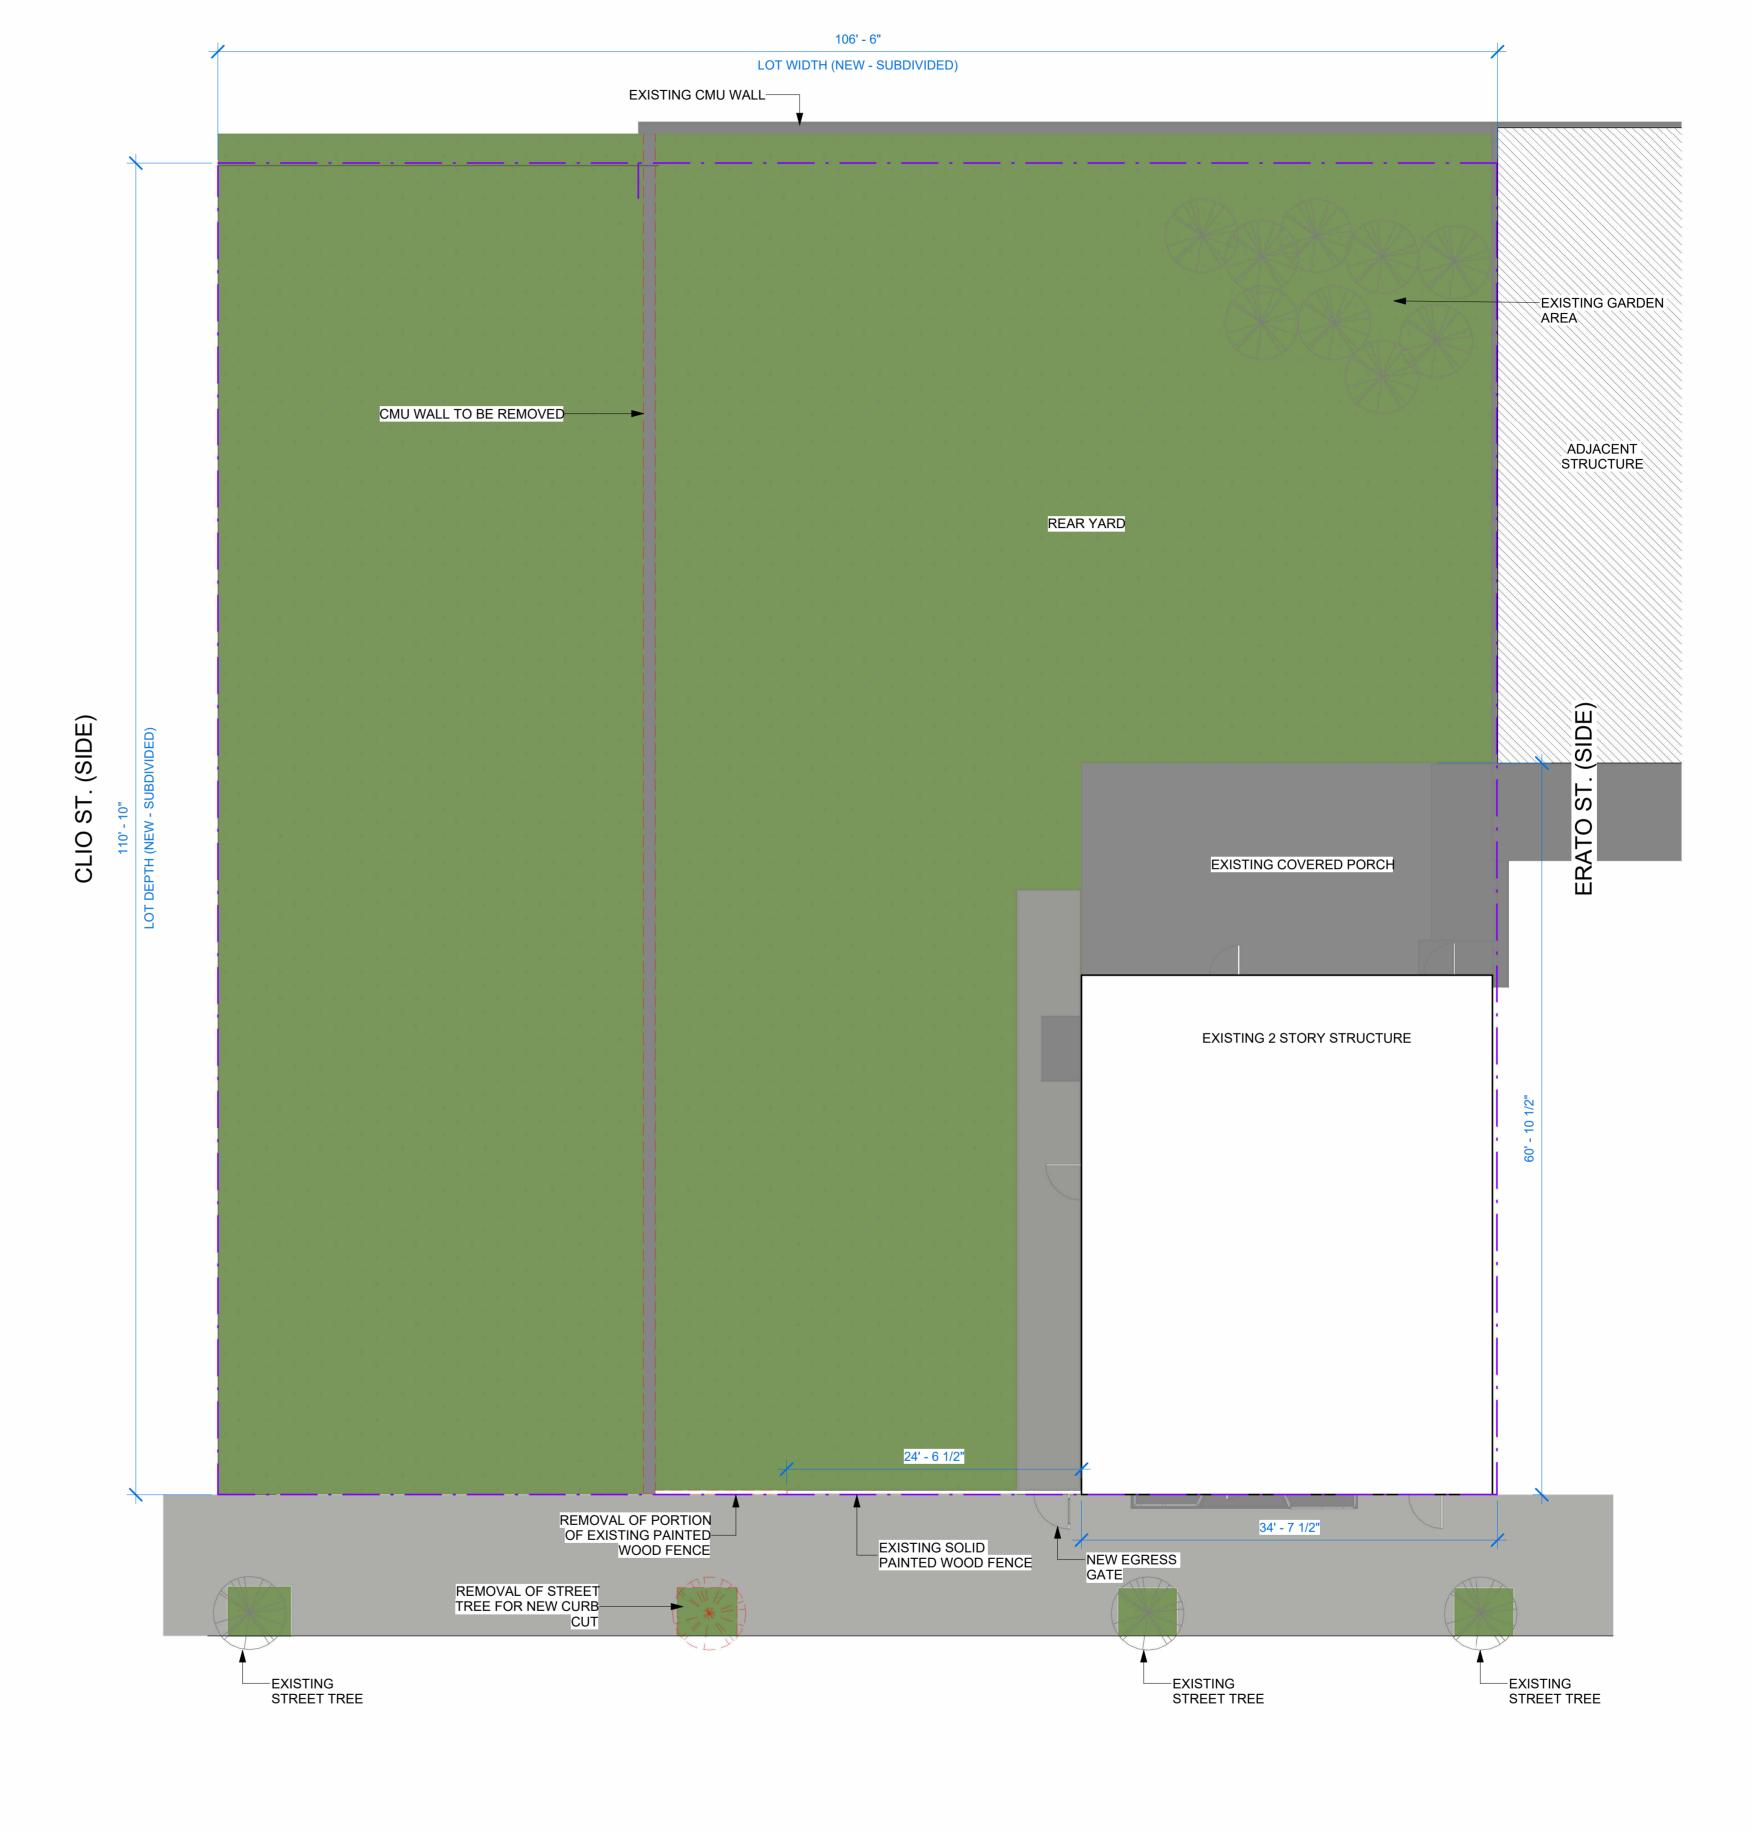

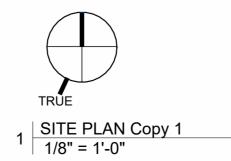

ORETHA CASTLE HALEY BLVD.


1228 OC HALEY BLVD. 1228 OC Haley Blvd. NEW ORLEANS LA

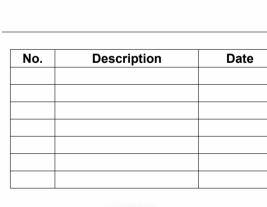



EXISTING SITE PLAN

Project number	23005
Date	09/11/25
Drawn by	MM
Checked by	MM

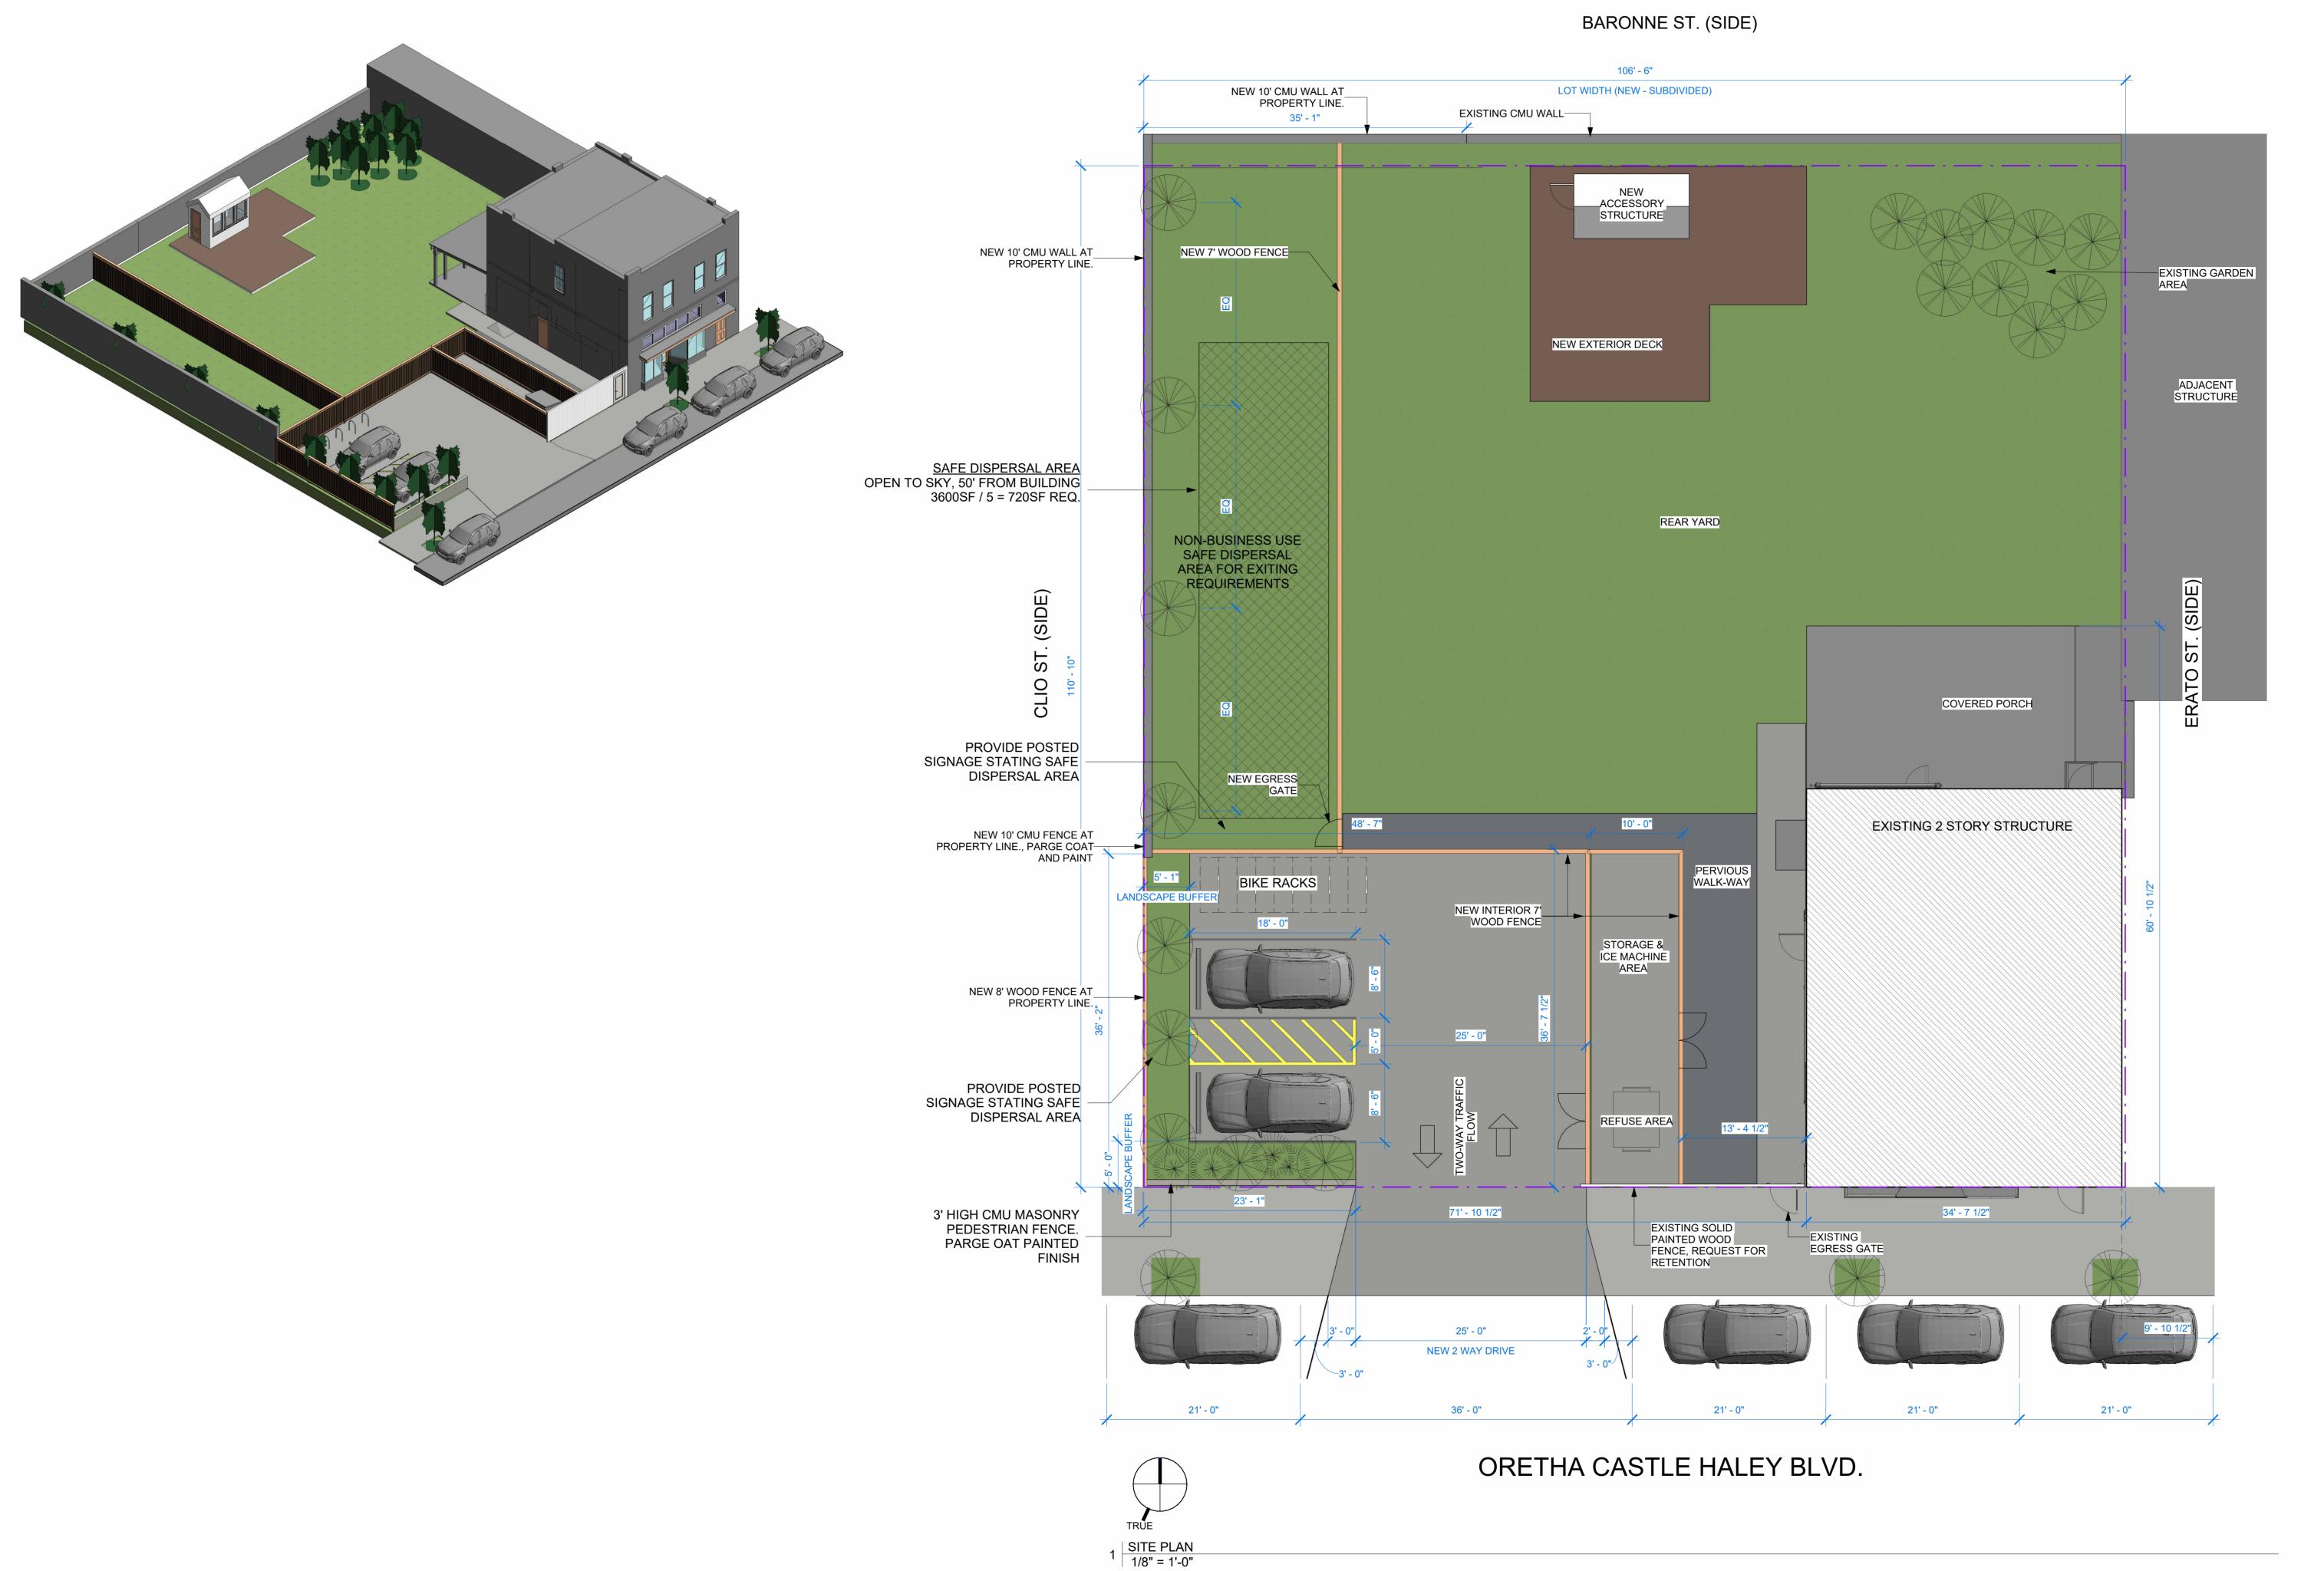



CONSULTING & DES
S Norman C Francis Parkway Suite 1
New Orleans, LA 70119

ALEY BLVD. Haley Blvd.

1228 O 1228 C NEW

No. Description Date



PROPOSED SITE PLAN

Project number	23005
Date	09/11/25
Drawn by	MM
Checked by	MM

ALL PLANTING SHALL CONFORM WITH LOCAL CODES AND ORDINANCES.
 QUANTITIES SHOWN IN THE PLANTING SCHEDULE ARE PROVIDED FOR CONVENIENCE ONLY. THE LANDSCAPE CONTRACTOR SHALL BEAR RESPONSIBILITY TO VERIFY AND INSTALL PLANT QUANTITIES AS DRAWN ON PLAN.

THE LANDSCAPE ARCHITECT SHALL APPROVE ALL PLANTING AREAS PRIOR TO THE INSTALLATION OF ANY MATERIALS, THE LANDSCAPE CONTRACTOR SHALL LAYOUT ALL PLANT MATERIAL IN THE FIELD PER THE PLANTING PLANS FOR REVIEW AND APPROVAL BY THE LANDSCAPE ARCHITECT. SECURE APPROVAL FROMTHE LANDSCAPE ARCHITECT BEFORE EXCAVATING PLANT PITS, MAKING NECESSARY ADJUSTMENTS AS DIRECTED.

4. LANDSCAPE CONTRACTOR SHALL NOTIFY THE LANDSCAPE ARCHITECT PROMPTLY SHOULD PLANT MATERIAL NOT BE AVAILABLE. LANDSCAPE CONTRACTOR SHALL PROPOSE SUBSTITUTION IN SIMILAR SIZE AND GROWTH HABITS AS PREVIOUSLY SPECIFIED PLANT MATERIAL. ONLY UPON APPROVAL FROM LANDSCAPE ARCHITECT SHALL THE SUBSTITUTION BE ACCEPTABLE.

5. TREE PLANTING PITS SHALL BE DUG PER THE DETAILS. COMPACTED SOIL AT SIDES AND BOTTOMS SHALL BE LOOSENED BY SCARIFYING OR OTHER APPROVED METHOD. PITS SHALL BE BACKFILLED WITH "PLANTING MIX" AS DESCRIBED BELOW. "PLANTING MIX" SHALL BE THOROUGHLY BACKFILLED AND WASHED IN BY WATER APPLICATION.

SHALL BE BACKFILLED WITH "PLANTING MIX" AS DESCRIBED BELOW. "PLANTING MIX" SHALL BE THOROUGHLY BACKFILLED AND WASHED IN BY WATER APPLICATION.

6. SHRUB PLANTING PITS SHALL BE PREPARED PER THE DETAILS. COMPACTED SOIL AT BOTTOM OF PIT SHALL BE LOOSENED AND THE PIT FILLED WITH "PLANTING MIX" TO THE BOTTOM OF THE ROOTBALL. WHEN THE SHRUB HAS BEEN PROPERLY SET, THE PIT SHALL BE FILLED TO THE REQUIRED GRADE WITH "PLANTING MIX" AND THOROUGHLY

SETTLED BY TAMPING AND WATERING. "PLANTING MIX" SHALL BE AS DESCRIBED BELOW.

7. SET PLANTS IN CENTER OF PIT, IN A VERTICAL POSITION, SO THAT THE CROWN OF THE ROOTBALL WILL BE LEVEL WITH FINISH GRADE AFTER SETTLING AND SHALL BEAR THE

SAME RELATIONSHIP TO THE FINISH GRADE THAT IT DID TO THE CONTAINER SOIL SURFACE.

8. LANDSCAPE PLANTING BEDS SHALL BE CONSTRUCTED IN A MANNER TO PROVIDE POSITIVE DRAINAGE AWAY FROM BUILDINGS.

. "PLANTING MIX" COMPOSITION: PUMPED RIVER SAND: 60% BY VOLUME


PINE BARK FINES: 30% BY VOLUME


SPHAGNUM PEAT MOSS: 10% BY VOLUME
ORGANIC MULCH: PINE STRAW (BALED OR EQUAL)

1. LANDSCAPE PLANTING MAINTENANCE & ESTABLISHMENT:
LANDSCAPE CONTRACTOR SHALL MAINTAIN ALL PLANTINGS BY WATERING, FERTILIZING, PRUNING AND ANY OTHER INDUSTRY STANDARD MEANS FOR A PERIOD OF 30
CALENDAR DAYS BEYOND SUBSTANTIAL
COMPLETION IN ORDER TO INSURE SURVIVABILITY OF NEWLY PLANTED MATERIAL

# GENERAL NOTES - LANDSCAPE

1/8" = 1'-0"

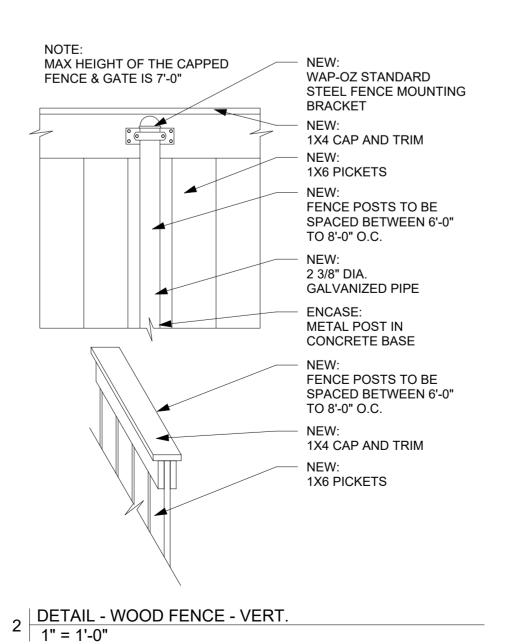

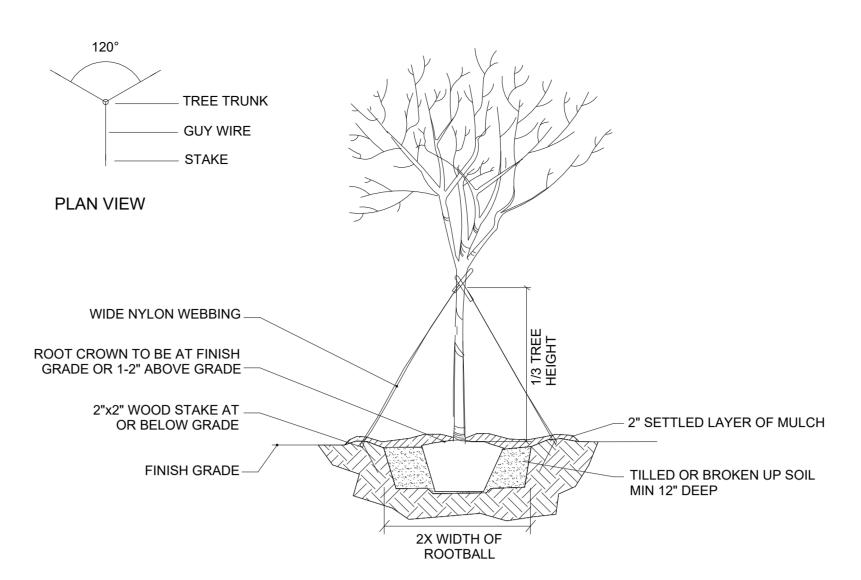

#### NOTES: TREE PLANTING (>2"CAL.)

1. ALL PLANT MATERIALS SHALL BE IN ACCORDANCE WITH THE AMERICAN STANDARDS FOR NURSERY STOCK (ANSI Z60.1-2004). PLANT ACCORDING TO ANSI A300 PART 6.

2. DIG THE PLANTING HOLE A MINIMUM OF 2x WIDTH OF ROOTBALL FOR AT LEAST THE FIRST 12 INCHES OF DEPTH. BELOW 12 INCHES, DIG HOLE WIDE ENOUGH TO PERMIT ADJUSTING. DO NOT DIG THE HOLE DEEPER THAN ROOT BALL DEPTH.

3. SCARIFY THE SUBGRADE AND SIDES OF THE PLANTING HOLE WHEN PLANTING IN CLAY SOILS (MORE THAN 15% CLAY).

4. LIFT AND SET THE TREE BY ROOT BALL ONLY. DO NOT LIFT USING THE TREE TRUNK AND DO NOT USE TREE TRUNK AS A LEVER.

5. SET THE TOP OF THE ROOT BALL LEVEL WITH THE SOIL SURFACE OR SLIGHTLY HIGHER IF THE SOIL IS PRONE TO SETTLING.

6. AFTER THE TREE IS SET IN PLACE, REMOVE BURLAP, WIRE AND STRAPS FROM AT LEAST THE UPPER 1/3 OF THE ROOTBALL.

7. BACKFILL WITH EXISTING SOIL THAT HAS BEEN WELL-TILLED OR BROKEN UP. DO NOT ADD AMENDMENTS TO THE BACKFILL SOIL. AMEND THE SURFACE WITH

8. USE THREE 2" X 2" WOOD STAKES DRIVEN INTO UNDISTURBED SOIL A MINIMUM OF 16 INCHES. SPACE STAKES EQUALLY AROUND THE TREE.

9. ATTACH 3/4" NYLON WEBBING TO CONNECT THE TREE TO STAKES. ATTACH

WEBBING AT 1/3 THE TREE HEIGHT.

10. APPLY A 2-3" (SETTLED) DEPTH OF PINE STRAW OR BARK MULCH TO THE PLANTING SURFACE. LEAVE A 2" SPACE AROUND THE TRUNK FOR AIR CIRCULATION.

11. PRUNING SHALL BE LIMITED TO DEAD, DISEASED, OR BROKEN LIMBS ONLY AND SHALL BE IN ACCORDANCE WITH ANSI A300 SPECIFICATIONS.


12. REMOVE ANY TRUNK WRAP REMAINING AT TIME OF PLANTING. NO WRAPS SHALL BE PLACED ON TRUNK.

# CONSUL 530 S Norman C Fra

Suite

TREE PLANTING DETAIL


1/4" = 1'-0"

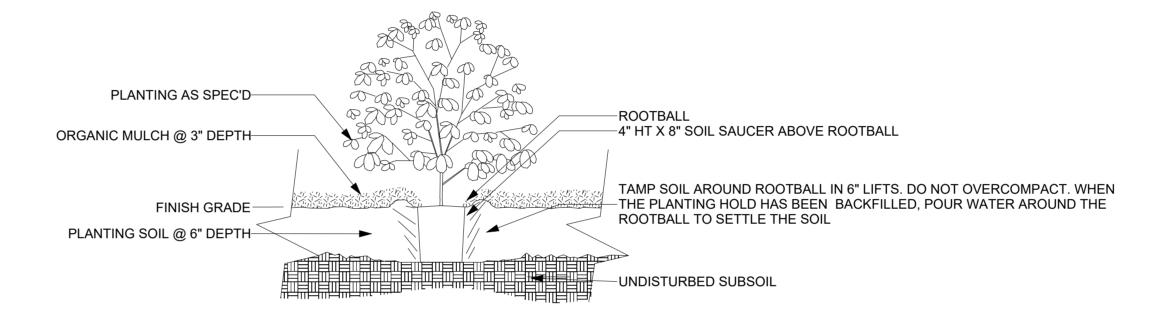

# SHRUB PLANTING DETAIL 1/16" = 1'-0"

TREES	CODE  LAG IND	BOTANICAL / COMMON NAME  Lagerstroemia indica x fauriei `Natchez` / Natchez Crape Myrtle	SIZE  Container or B&B	CAL.	<b>HT.</b> 8-10` Ht.	<b>SPD.</b> 3-4` Spd.	NOTES  Multi-Trunk / 3-5 Canes
SHRUBS	CODE	BOTANICAL / COMMON NAME	CONT.		нт.	SPD.	NOTES
$\bigcirc$	MUH CAP	Muhlenbergia capillaris / Pink Muhly	3-Gal 18-24" Ht.		12-15" Spd		SQUARE SPACING

4 LANDSCAPE LEGEND
3" = 1'-0"

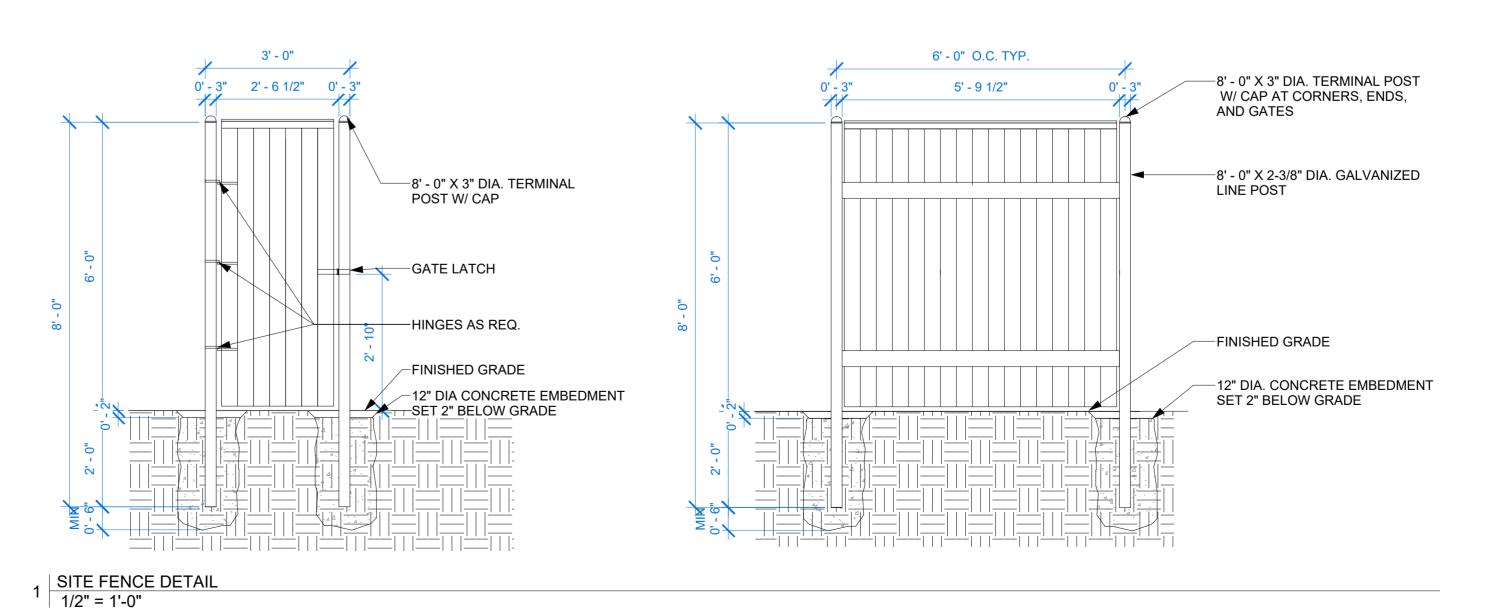


SITE PLAN DETAILS

Description

Project number	23005
Date	09/11/25
Drawn by	MM
Checked by	MM

A2.1


1228 OC HALEY BLVD. 1228 OC Haley Blvd. NEW ORLEANS LA

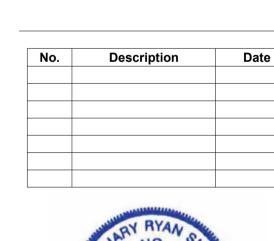




SITE PLAN DETAILS

Project number	23005
Date	09/11/25
Drawn by	MM
Checked by	MM

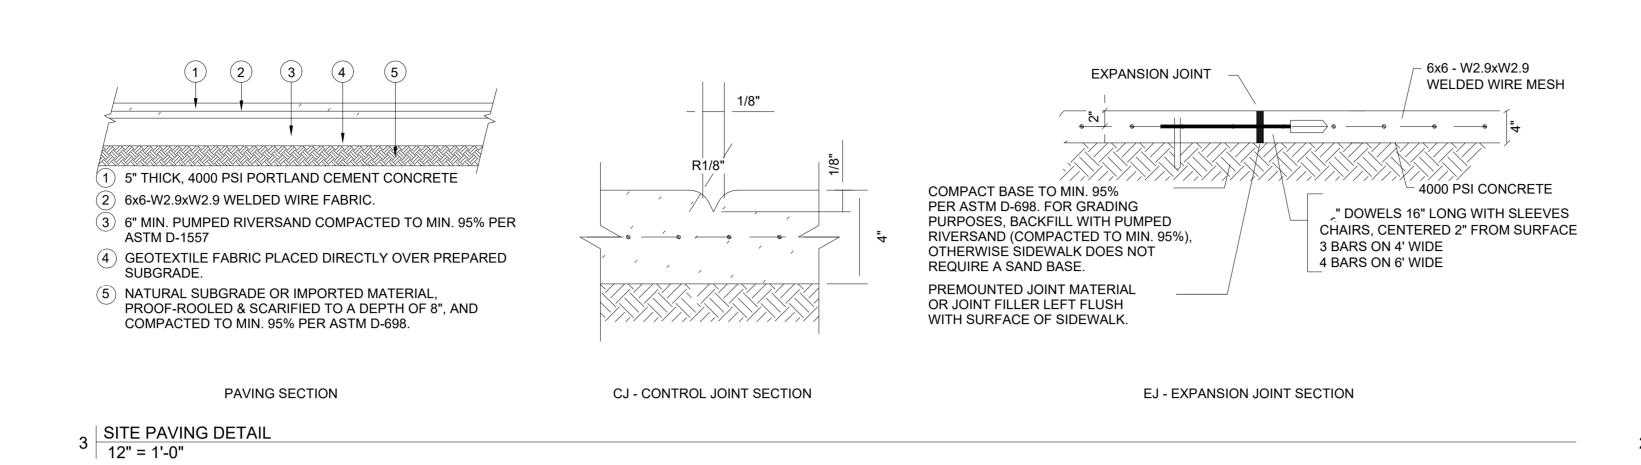

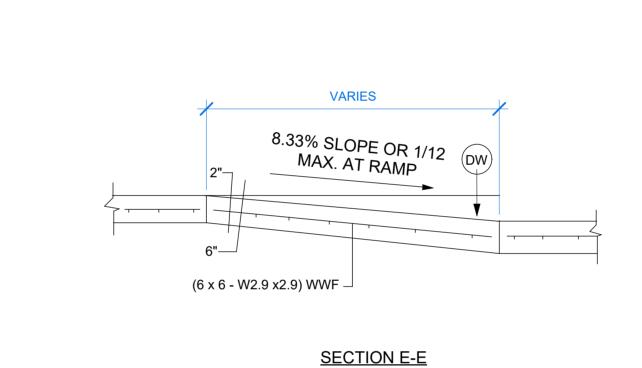

N.T.S.

DETECTABLE WARNINGS (YELLOW) (ADA) TRUNCATED DOME TILE (TYP.)

AS PÉR APPROVAL OF D.P.W.

SEE NOTES (4) THRU (7)

(1) MIN. 2 3/8" THICK PERMEABLE CONC. PAVERS WITH

MIN 6" THICK COMPACTED NO. 57 BASE STONE

7 COMPACTED AGGREGATE BERM ONSIDES WRAPPED IN GEOTEXTILE FABRIC

**PAVING SECTION** 

ASTM NO. 8, 89, OR 9 STONE IN JOINTS


PLASTIC OR METAL EDGE RESTRAINER

(a) UNCOMPACTED NATIVE SOIL SUBGRADE

2 2" THICK ASTM NO. 8 BEDDING STONE

GEOTEXTILE FABRIC

PERMEABLE PAVING DETAILS

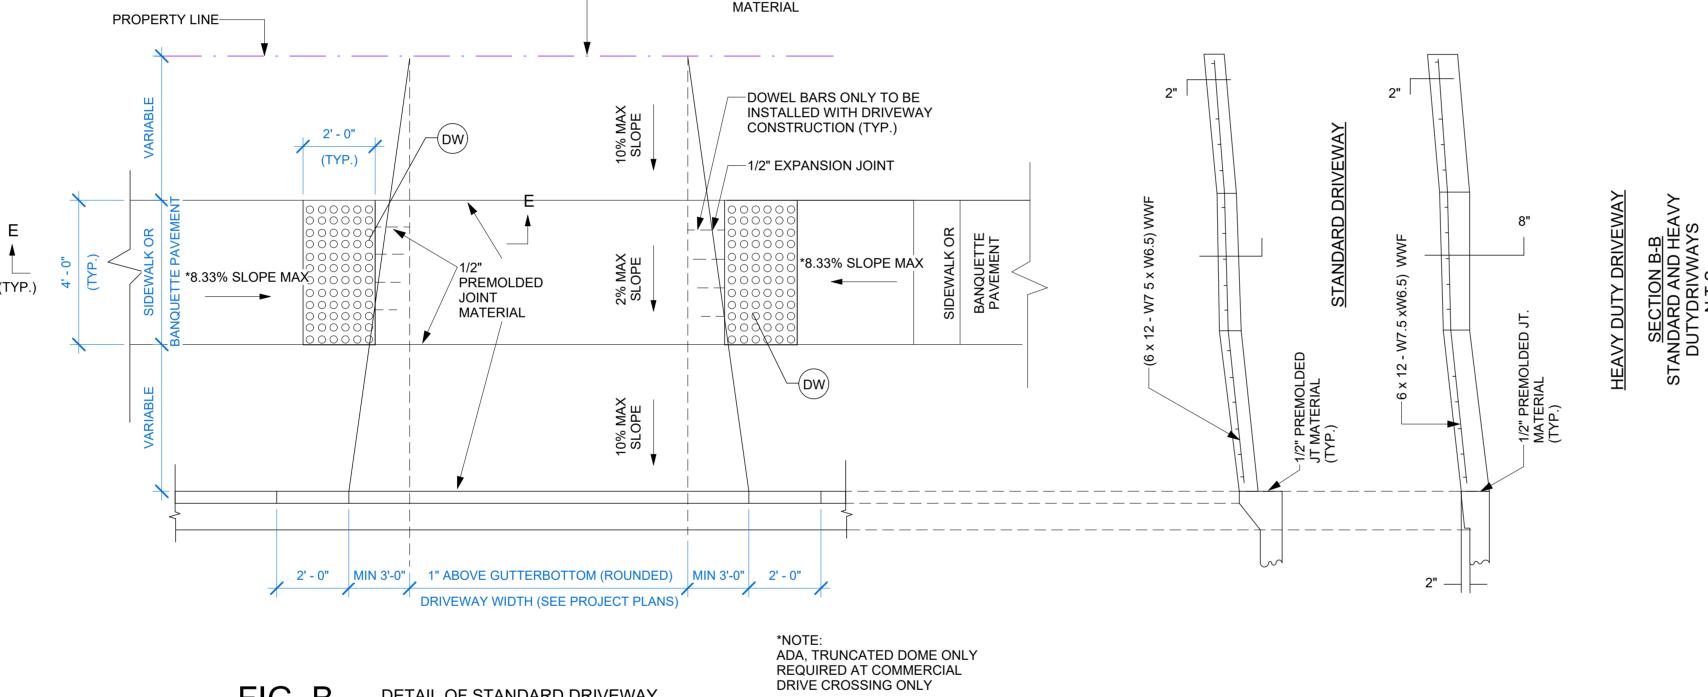

LONG, BAR

DOWELED BARS SEE \*BAR DETAIL\* DWG. STD4

1/2" PREMOLDED JOINT

**DETAIL OF STANDARD DRIVEWAY** N.T.S.

TOP OF CURB -

FRONT VIEW OF CURB

**DETAIL OF STANDARD AND HEAVY DUTY** 

DRIVEWAYS FOR MOUNTABLE CONCRETE CURB

N.T.S

DEPRESSION, VARIES, 3" MAX. (SEE NOTES 1 THRU 3)

NOTES (\*):

- 1. FOR STANDARD DRIVEWAYS: DEPRESS ONLY WHEN DIRESTED BY THE
- FIELD ENGINEER.
- 2. FOR HEAVY DUTY DRIVEWAYS: DEPRESS 3" AS SHOWN. 3. MAXIMUM DRIVEWAY SLOPE IS 10%. ANYTHING EXCEEDING 10% SHOULD
- BE APPROVED BY THE DEPARTMENT. 4. ALL HANDICAPPED RAMPS SHALL INCLUDE DETECTABLE WARINGS AND BE
- CONSTRUCTED IN ACCORDANCE WITH THE CITY OF NEW ORLEANS STANDARD PLAN AND THE LATEST ADA REQUIREMENTS.
- 5. DETECTABLE WARNINGS, I.E. RAISED TRUNCATED DOMES SHALL BE USED BETWEEN PEDESTRIAN CIRCULATION AREAS AND VEHICULAR CIRCULATION
- PR PARKING AREAS FOR COMMERCIAL DRIVEWAYS ONLY.
- 0.2 INCHES IN NOMINAL HEIGHT, AND CENTERED 2.35 INCHES APART.
- 7. RAISED TRUNCATED DOMES SHALL BE 24" x 4" (MIN.) SYSTEMS. THE TILE TYPE, SIZE, SHAPE, INSTALLATION METHODS, ETC., MUST

6. RAISED TRUNCATED DOMES SHALL BE 0.9 INCHES IN NOMINAL DIAMETER,

BE APROED BY THE D.P.W. BEFORE THE CONTRACTOR ORDERS HIS MATERIALS.

TYP. CURB CUT DETAILS ADA
3/8" = 1'-0"

FIG. B

TOP OF CURB AT DRIVEWAY (SEE NOTES 1 THRU 3)

— 2" CLR



1000 S. N. C Francis Pky, 2nd Floor New Orleans LA 70125 (504) 345-8950 <a href="https://www.ZachSmithConsulting.com">www.ZachSmithConsulting.com</a>

9-15-25

**DAC Narrative for** 1228 Oretha Castle Haley Blvd, Project Location 1228 Oretha Castle Haley Blvd, NO LA 70113 Permit HPVJFT

#### **Project Overview**

The proposed site improvements at 1228 OC Haley Blvd, New Orleans, involve enhancing the property surrounding an existing two-story structure, with no modifications to the structure itself. The project includes the addition of adjacent lots to the property, the creation of a small parking lot, installation of fencing, landscaping enhancements, and the construction of a small accessory structure in the rear yard. The site is located within the Central City neighborhood and is subject to the regulations of the City of New Orleans Comprehensive Zoning Ordinance (CZO), specifically Article 4, which governs Development Plan and Design Review, and applicable design guidelines. This narrative outlines how the proposed improvements comply with the CZO and align with the city's design goals.

#### Compliance with Comprehensive Zoning Ordinance (CZO)

The proposed site improvements fully comply with the requirements of the CZO, particularly Article 4, Section 4.5, which governs Development Plan and Design Review. There are no requests for variances at this time but we are still working through review with the city at the time of this application. Concurrently, the property is going through the property subdivide process to combine 3 lots of record into 1 lot of record.

Below is a detailed breakdown of compliance:

- Parking Lot: The proposed small parking lot will provide off-street parking for the existing structure, adhering to Article 22 of the CZO, which outlines parking requirements. The lot will include two parking spaces, designed to meet the minimum parking requirements for the existing two-story structure's use. The parking area will comply with dimensional standards, including setbacks of at least 5 feet from the property line, as required by Article 22, Table 22-1. The parking lot layout ensures accessibility and safe circulation, with a minimum 24-foot-wide drive aisle. Refuse area and bicycle rack access is provided from within the parking lot
- **Fencing**: The proposed fencing will consist of a 8-foot-high wooden privacy fence along the parking lot left side and the matching of a CMU fence wall along the remainder of the left side and rear left property line. A new 3' solid masonry pedestrian fence is to be installed in front of the parking lot.
- **Landscaping**: The landscaping plan includes native and adaptive plantings, with trees and low-maintenance shrubs, consistent with Article 23, Section 23.7, which encourages



1000 S. N. C Francis Pky, 2nd Floor New Orleans LA 70125 (504) 345-8950 <a href="https://www.ZachSmithConsulting.com">www.ZachSmithConsulting.com</a>

sustainable landscaping practices. The landscaping will enhance the site's aesthetic appeal, provide shade, and contribute to stormwater management along the parking lot's perimeter.

Accessory Structure: The proposed rear yard accessory structure is a small, single-story shed (approximately 70 square feet) intended for storage. The shed will be constructed with materials that match the existing structure's exterior (wood siding with a neutral paint color) to ensure visual continuity. The structure's footprint and height comply with the maximum lot coverage and height restrictions outlined in Article 12, Table 12-1, for the HU-MU district.

#### **Design Goals**

The design of the site improvements addresses the CZO's overarching goals, as outlined in Article 4, Section 4.1, which emphasize creating developments that are compatible with the character, scale, and density of the surrounding area while promoting public health, safety, and welfare. The following design goals are addressed:

- Character: The proposed improvements enhance the property's character by
  maintaining the existing two-story structure as the focal point while introducing functional
  and aesthetically pleasing site elements. The parking lot is compact and positioned to
  minimize visual impact from OC Haley Blvd, preserving the pedestrian-friendly character
  of the streetscape. The fencing and landscaping complement the Central City
  neighborhood's urban aesthetic, using materials and plantings that reflect local traditions
  and environmental conditions.
- Scale: The scale of the proposed improvements is modest and proportionate to the
  existing structure and surrounding properties. The parking lot is limited to six spaces,
  ensuring it does not overwhelm the site or detract from the residential and mixed-use
  character of the area. The accessory structure is small in footprint and height,
  subordinate to the principal building, and positioned in the rear yard to minimize its
  visibility from the public right-of-way.
- Sustainability and Public Welfare: The use of permeable paving in the parking lot and
  native plantings in the landscaping plan promotes environmental sustainability by
  reducing runoff and supporting local ecosystems. The fencing enhances site security,
  contributing to the safety of the property and surrounding community. The accessory
  structure provides functional storage, supporting the practical needs of the property's
  occupants without altering the site's overall use.