COVER SHEET, INDEX, SITE PLAN

G00

LEGEND

GENERAL REQUIREMENTS

- PROJECT MANAGEMENT AND COORDINATION FOR CONTRACTOR:
 - a. FOR ADDITIONAL INFORMATION OR INTERPRETATION OF THE CONTRACT DOCUMENTS, CONTRACTOR SHALL PREPARE AND SUBMIT A REQUEST FOR INFORMATION FORM.

GENERAL REQUIREMENTS

- b. CONTRACTOR IS TO SCHEDULE AND CONDUCT MEETINGS AND CONFERENCES AT PROJECT SITE FOR CONSTRUCTION PROGRESS AND COORDINATION.
- CONTRACTOR IS TO PROVIDE PROGRESS DOCUMENTATION OF CONSTRUCTION AND PERFORMANCE OF THE WORK. CONTRACTOR TO PROVIDE CONTRACTOR'S CONSTRUCTION SCHEDULE.
- SUBMITTAL PROCEDURES
- a. PROVIDE SUBMITTAL SCHEDULE
- b. CONTRACTOR'S REVIEW
- I. ACTION AND INFORMATIONAL SUBMITTALS: REVIEW EACH SUBMITTAL AND CHECK FOR COORDINATION WITH OTHER WORK OF THE CONTRACT AND FOR COMPLIANCE WITH THE CONTRACT DOCUMENTS. NOTE CORRECTIONS AND FIELD DIMENSIONS. MARK WITH APPROVAL STAMP BEFORE SUBMITTING TO ARCHITECT.
- II. APPROVAL STAMP: STAMP TO INCLUDE PROJECT NAME AND LOCATION, SUBMITTAL NUMBER, SPECIFICATION SECTION TITLE AND NUMBER, NAME OF REVIEWER, DATE OF CONTRACTOR'S APPROVAL, AND STATEMENT CERTIFYING THAT SUBMITTAL HAS BEEN REVIEWED, CHECKED, AND APPROVED FOR COMPLIANCE WITH THE CONTRACT DOCUMENTS
- c. SUBMITTALS TO INCLUDE:
- i. PRODUCT DATA
- II. SHOP DRAWINGS:
- II.a. PREPARE PROJECT-SPECIFIC INFORMATION, DRAWN ACCURATELY TO SCALE.
- II.b. SUBMIT FIVE COPIES OF EACH SUBMITTAL. ARCHITECT WILL RETAIN TWO COPIES; REMAINDER WILL BE RETURNED.

III. SAMPLES, IF REQUIRED

- III.a. SUBMIT SAMPLES FOR REVIEW OF KIND, COLOR, PATTERN AND TEXTURE FOR A CHECK OF THESE CHARACTERISTICS WITH OTHER ELEMENTS AND FOR A COMPARISON OF THESE CHARACTERISTICS BETWEEN SUBMITTAL AND ACTUAL COMPONENT AS DELIVERED AND INSTALLED.
- III.b. ATTACHED IDENTIFICATION LABEL ON EACH SAMPLE, TO INCLUDE:
 - -GENERIC DESCRIPTION OF SAMPLE
 - -PRODUCT NAME AND NAME OF MANUFACTURER
 - -SAMPLE SOURCE
- -NUMBER AND TITLE OF APPLICABLE SPECIFICATION SECTION


I. QUALITY REQUIREMENTS

- a. FOR QUALITY ASSURANCE AND QUALITY CONTROL TESTING AND INSPECTING SERVICES ARE REQUIRED TO VERIFY COMPLIANCE WITH REQUIREMENTS SPECIFIED OR INDICATED. THESE SERVICES DO NOT RELIEVE CONTRACTOR OF RESPONSIBILITY FOR COMPLIANCE WITH THE CONTRACT DOCUMENT REQUIREMENTS. ALL NECESSARY TESTING AND INSPECTING SERVICES ARE TO BE COORDINATED AND PAID FOR BY THE CONTRACTOR.
- TESTING LABORATORY SERVICES
- a. CONTRACTOR TO PROVIDE TESTING AND INSPECTING.
- b. CONTRACTOR SHALL BE SOLELY RESPONSIBLE FOR MAKING ARRANGEMENTS TO HAVE LABORATORY PERSONNEL AVAILABLE WHEN TESTS ARE REQUIRED AND FOR OBTAINING MIX DESIGNS AS REQUIRED.
- C. UPON COMPLETION OF EACH TEST AND/OR INSPECTION. PROMPTLY DISTRIBUTE COPIES OF TEST OR INSPECTION REPORTS TO THE ENGINEER, TO GOVERNMENTAL AGENCIES REQUIRING SUBMISSION OF SUCH REPORTS, AND TO SUCH OTHER PERSONS AS DIRECTED BY THE ENGINEER.
- SELECTIVE DEMOLITION
- a. SELECTIVE DEMOLITION INCLUDES:
- I. DEMOLITION AND REMOVAL OF SELECTED PORTION OF BUILDING OR STRUCTURE
- II. DISCONNECTING, CAPPING OR SEALING SITE UTILITIES
- III. SALVAGE OF EXISTING ITEMS TO BE REUSED OR RECYCLED
- b. CONTRACTOR TO:
- I. DETAIL SPECIAL MEASURES PROPOSED TO PROTECT ADJACENT BUILDING TO REMAIN
- II. SCHEDULE OF DEMOLITION ACTIVITIES

GENERAL NOTES

- I. THE CONTRACTOR IS TO VISIT THE SITE AND VERIFY ALL EXISTING BUILDING AND SITE CONDITIONS PRIOR TO COMMENCING THE WORK. SHOULD ANY DISCREPANCIES BE ENCOUNTERED. THE ARCHITECT / ENGINEER SHOULD BE NOTIFIED IN WRITING.
- 2. THE CONTRACTOR IS TO ACQUIRE AND PAY FOR ALL REQUIRED PERMITS FOR THE CONSTRUCTION AND OCCUPANCY OF THE PROJECT.
- 3. THE CONTRACTOR SHALL REPAIR EXISTING SURFACES DAMAGED BY DEMOLITION, TO MATCH EXISTING.
- 4. PRIOR TO COMMENCING WORK, THE CONTRACTOR SHALL VERIFY LOCATION OF ALL EQUIPMENT AND UTILITIES. REMOVAL OF EQUIPMENT AND UTILITIES SHALL BE COORDINATED WITH THE OWNER, ARCHITECT / ENGINEER, UTILITY COMPANIES, AND ALL AUTHORITIES HAVING JURISDICTION.
- 5. CLEANING: REMOVE RUBBISH AND DEBRIS DAILY. LEAVE JOB SITE CLEAN UPON COMPLETION OF WORK.
- 6. THE CONTRACTOR SHALL PROVIDE AN ITEMIZED COST BREAKDOWN FOR LABOR AND MATERIALS OF ALL ITEMS AND PHASES OF CONSTRUCTION PROMPTLY AFTER BEING AWARDED THE CONTRACT.
- 7. DEVIATION FROM THE CONTRACT DOCUMENTS NOT APPROVED IN WRITING BY THE ARCHITECT OR OWNER SHALL BE THE RESPONSIBILITY OF THE CONTRACTOR.
- 8. THE GENERAL CONTRACTOR SHALL VERIFY ANY OWNER PROVIDED AND INSTALLED ITEMS AND COORDINATE WITH OWNER'S REPRESENTATIVE TO AVOID CONFLICTS OR DISCREPANCIES.
- 9. DO NOT SCALE DRAWINGS, USE WRITTEN DIMENSIONS ONLY, SUBMIT A REQUEST FOR CLARIFICATION IN WRITING TO THE ARCHITECT FOR ANY DISCREPANCIES.
- IO. WHERE MATERIAL FASTENERS ARE NOT INDICATED, PROVIDE AS SPECIFIED BY THE MATERIAL MANUFACTURER'S RECOMMENDATIONS AND PROCEDURES
- 15. ALL VERTICAL RUNS OF ELECTRICAL/DATA WIRING TO BE INSIDE OF CONDUIT, INSIDE OF WALLS. CONTRACTOR TO COORDINATE SUBCONTRACTOR WORK TO
- 16. PROVIDE TEMPORARY SAFETY FENCE TO SEPARATE THE WORK AREA FROM ADJACENT PEDESTRIAN AREAS.
- 17. ALL WORK TO BE PERFORMED THAT IS NOT COVERED BY THESE PLANS SHALL BE CONSTRUCTED IN ACCORDANCE WITH APPLICABLE SATE, COUNTY, OR LOCAL CODES.

-DIRECTION OF CUTTING PLANE NORTH ARROW SECTION OR DETAIL NUMBER DRAWING NUMBER → DRAWING TITLE WALL SECTION CUT DRAWING TITLE SHEET # ON WHICH → DRAWING SCALE SECTION OR DETAIL IS DRAWN SHEET # ON WHICH DRAWING IS LOCATED -DRAWING NUMBER

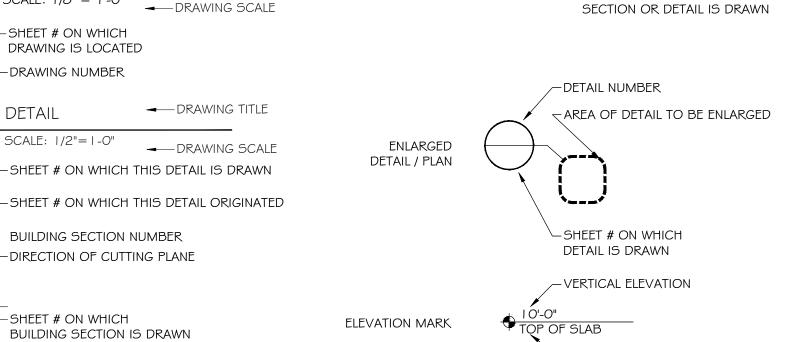

REFERENCE # FOR CONSTRUCTION NOTES, ETC. OR ANY INFORMATION TO BE CONVEYED WHICH IS REPETITIVE OR SPACE AVAILABLE PROHIBITS A WRITTEN DESCRIPTION OF AN ITEM

- DESCRIPTION OF ELEVATION POINT

PROJECT DESCRIPTION

CONSTRUCTION OF THE MAIN BRANCH OF THE NEW ORLEANS PUBLIC LIBRARY SYSTEM WAS COMPLETED IN 1958. DUE TO A COMBINATION OF HURRICANE KATRINA DAMAGE, THE BUILDING IN USE FOR OVER FIFTY YEARS, AND MAINTENANCE REQUIREMENTS, THE BUILDING REQUIRES MODIFICATIONS TO REMOVE BARRIERS TO THE BUILDING IN ORDER TO MAKE IT ADA (AMERICAN DISABILITY ACT) ACCESSIBLE. THIS SET OF DRAWINGS COVERS CONSTRUCTION DOCUMENTS THAT ARE SEPARATED INTO THREE SCOPES:

SCOPE A - DEMOLITION OF EXISTING ENTRY STAIRS AND CONSTRUCTION OF NEW ENTRY STAIRS AND RAMP. THIS SCOPE INCLUDES NEW CONCRETE PAVING AND A RAISED PLANTER ADJACENT TO THE RAMP AND STAIRS.

SCOPE B - REPAIR TO AN EXISTING RAMP'S HANDRAILS.

SCOPE C - THE MAIN PUBLIC ELEVATOR LOCATED NEAR THE MAIN ENTRANCE AND THE STAFF ELEVATOR LOCATED AT THE REAR OF THE FACILITY WILL BE IMPROVED TO MAKE THEM MORE COMPLIANT WITH ADA STANDARDS

- ALL CONCRETE TO BE 4000 PSI @ 28 DAYS WITH I-I/2" MAXIMUM AGGREGATE, UNLESS OTHERWISE NOTED. MAXIMUM SLUMP 4 INCHES. 0.45 MAXIMUM W/C RATIO
- 2. REINFORCING STEEL SHALL BE DEFORMED TYPE AND SHALL BE NEW BILLET STEEL. GRADE 60. ASTM A-615 WELDED WIRE MESH SHALL BE IN ACCORDANCE WITH ASTM A-185.
- 3. EXPOSED CORNERS OF CONCRETE SHALL HAVE A 3/4" X 45 DEG. CHAMFER.

AGO1 SCALE: 1/2"=1-0"

-SHEET # ON WHICH

BUILDING SECTION

4. CONTRACTOR SHALL COORDINATE HIS EFFORTS WITH REGARD TO ACCESS, SCHEDULE, GROUNDING SLEEVES. SEWER LINE, AND MISC. WITH ELECTRICAL AND MECHANICAL CONTRACTOR.

CONCRETE NOTES

- 5. DESIGN, FABRICATION AND ERECTION SHALL BE IN ACCORDANCE WITH ACI 318, BUILDING CODE REQUIREMENTS FOR STRUCTURAL CONCRETE, LATEST EDITION AND ACI 301 SPECIFICATIONS FOR STRUCTURAL CONCRETE FOR BUILDINGS, LATEST EDITION.
- G. IN THE EVENT OF HOT WEATHER ALL WORK SHALL BE IN ACCORDANCE WITH ACI 305R HOT WEATHER CONCRETING, LATEST EDITION. IN THE EVENT OF COLD WEATHER ALL WORK SHALL BE IN ACCORDANCE WITH ACI 30GR COLD WEATHER CONCRETING, LATEST EDITION.
- 7. CONSTRUCTION TOLERANCES SHALL BE IN ACCORDANCE WITH ACI 117 STANDARD SPECIFICATION FOR TOLERANCES FOR CONCRETE CONSTRUCTION AND MATERIALS, LATEST EDITION.
- 8. CONTRACTOR SHALL ENGAGE A TESTING LABORATORY ACCEPTABLE TO THE OWNER TO PERFORM AND SUBMIT TEST REPORTS. SAMPLING AND TESTING FOR QUALITY CONTROL DURING PLACEMENT OF CONCRETE MAY INCLUDE THE FOLLOWING AS DIRECTED BY THE OWNER:
- SLUMP: ASTM C 143 ONE TEST AT POINT OF DISCHARGE FOR EACH SET OF COMPRESSIVE TESTS CYLINDERS. AIR CONTENT; ASTM C 23 I ONE TEST AT PONT OF PLACEMENT FOR EACH SET OF COMPRESSIVE CYLINDERS. CONCRETE TEMPERATURE; TEST HOURLY WHEN AIR TEMPERATURE IS 40 DEG F AND BELOW, AND WHEN 80
- DEG F AND ABOVE; AND AT EACH COMPRESSIVE TEST COMPRESSIVE STRENGTH: ASTM C 39 ONE SET FOR EACH DAY'S POUR EXCEEDING TO CUBIC YARDS PLUS ADDITIONAL SETS FOR EACH 50 CUBIC YARDS OVER AND ABOVE THE FIRST 25 CUBIC YARDS; ONE SPECIMEN TESTED AT 7 DAYS, TWO SPECIMENS TESTED AT 28 DAYS AND ONE SPECIMEN RETAINED IN RESERVE FOR
- LATER TESTING IF REQUIRED. STRENGTH LEVEL OF CONCRETE WILL BE CONSIDERED SATISFACTORY IF AVERAGES OF SETS OF THREE CONSECUTIVE STRENGTH TEST RESULTS EQUAL OR EXCEED SPECIFIED COMPRESSIVE STRENGTH, AND NO INDIVIDUAL STRENGTH TEST RESULTS FALLS BELOW SPECIFIED COMPRESSIVE STRENGTH BY MORE THAN 500
- TEST RESULTS WILL BE REPORTED IN WRITING TO THE OWNER WITHIN 24 HOURS AFTER TESTS.
- 9. PROVIDE A 90 DEGREE HOOK ON ALL TOP REINFORCEMENT IN ALL BEAMS AT DISCONTINUOUS ENDS AND LAP SPLICE 30 BAR DIAS AT MID-SPAN. CONTINUOUS BOTTOM BARS SHOULD BE LAP SPLICED 6" AT CENTER OF SUPPORT.
- IO. TEMPERATURE BARS IN SLAB AND INTERMEDIATE HORIZONTAL BARS IN WALLS AND BEAMS, TENSION LAP SPLICE: SEE TABLE BELOW:
- II. PROVIDE CORNER BARS AT EACH OUTSIDE CORNER FOR EACH HORIZONTAL BAR IN WALLS AND BEAMS; SEE LAP SPLICE TABLE FOR REQUIRED LAP LENGTH. HOOK INSIDE BAR IN WALLS AT ENDS.
- LAP SPLICE TABLE IN INCHES: #4 25 #5 31
- #6 37
- #7 54 #8 62
- I 2. CONCRETE PROTECTION FOR REINFORCING: 3" AT FOOTINGS AND GRADE BEAMS; 2" AT FORMED SURFACES LATER EXPOSED TO SOIL; I 3" AT BEAMS, COLUMNS, AND WALLS; I" AT SLABS.
- 13. NO HOLES OR OPENINGS THROUGH FOUNDATION AND/OR FOOTING WITHOUT PRIOR APPROVAL.
- 14. FOR GRADE BEAMS USE CONCRETE WEDGES FOR REINFORCING STEEL SUPPORTS. BRICK OR MASONRY BLOCK IS NOT ACCEPTED.
- I 5. SECTIONS DO NOT INDICATE ALL CONCRETE REINFORCING. CHECK SCHEDULES AND NOTES FOR REINFORCING

CIVIL NOTES

. THE SITE UNDER THE NEW RAMP AND STAIRS SHALL BE CLEANED OF ALL TRASH, TREES, AND LOOSE STONES AND STRIPPED OF UPPER LOOSE SOIL CONTAINING VEGETATION OR OTHER UNSUITABLE MATERIAL

OWNER

CITY OF NEW ORLEANS

1300 PERDIDO STREET

504.658.8665

NEW ORLEANS, LA 70112

DEPARTMENT OF CAPITAL PROJECTS

- 2. ALL EXCAVATION SHALL BE MADE TO LINES AND ELEVATIONS AS SHOWN ON THESE DRAWINGS. AFTER EXCAVATION, THE EXPOSED SOILS SHALL BE INSPECTED AND ANY UNSUITABLE DEPOSITS REMOVED.
- 3. ALL SURPLUS EXCAVATED MATERIAL AND UNAPPROVED MATERIALS SHALL BE TRANSPORTED OFF THE CONSTRUCTION SITE. THE CONTRACTOR SHALL BEAR ALL COSTS CONNECTED WITH REMOVAL AND DISPOSAL THE CONTRACTOR SHALL PROPERLY DISPOSE OF ALL MATERIAL REQUIRED TO BE DISPOSED OF OFFSITE OF THE OWNER'S PROPERTY.
- 4. FILL UNDER FOUNDATION SHALL BE FREE OF WOOD, ROOTS, AND ORGANIC MATTER AND DEBRIS. THE SAND SHOULD NOT CONTAIN MORE THAN 10% (BY WEIGHT) OF MATERIAL PASSING A NO. 200 MESH SIEVE. AND SHALL BE NON PLASTIC. FILL SHALL BE SPREAD IN 6 INCH THICK LAYERS AND EACH LAYER COMPACTED TO NOT LESS THAN 95% OF MAXIMUM DRY DENSITY AT OPTIMUM WATER CONTENT AS DETERMINED IN
- 5. PRIOR TO PLACING FILL, THE SURFACES SHALL BE SCARIFIED FOR A DEPTH OF AT LEAST 6 INCHES AND COMPACTED AT A MOISTURE CONTENT ABOVE OPTIMUM BUT WHICH WILL PERMIT PROPER COMPACTION.
- 6. SHOULD UNSUITABLE SOIL BE ENCOUNTERED 3 FEET BELOW EXISTING GRADE THE CONTRACTOR SHALL REMOVE AND REPLACE WITH COMPACTED SAND.
- 7. IN-PLACE DENSITY TESTING SHALL BE TAKEN AT THE FREQUENCY OF ONE TEST PER 2500 SQUARE FEET PER LIFT. FIELD DENSITY TESTS SHALL BE IN ACCORDANCE WITH ASTM D 1556 (SAND CONE METHOD) OR ASTM D 2922 (NUCLEAR DENSITY METHOD). IF IN THE OPINION OF THE OWNER, BASED ON TESTING SERVICE REPORTS AND INSPECTION, FILLS WHICH HAVE BEEN PLACED ARE BELOW SPECIFIED DENSITY, ADDITIONAL COMPACTION SHALL BE PERFORMED AT NO ADDITIONAL EXPENSE TO THE OWNER.
- 8. REFERENCE CONCRETE JOINT DETAIL 11/A101.

ACCORDANCE WITH ASTM D-1557.

9. ALL WORK IN PUBLIC RIGHT-OF-WAY SHALL BE IN ACCORDANCE WITH ALL STATE AND LOCAL REQUIREMENTS AND STANDARDS.

LOYOLA AVENUE



CITY OF NEW ORLEANS

MAIN LIBRARY REPAIRS

NEW ORLEANS PUBLIC LIBRARY

219 LOYOLA AVENUE

NEW ORLEANS, LA 70112

NEW ORLEANS

PUBLIC LIBRARY

PROJECT DIRECTORY

82 | BARONNE STREET

www.wdgnola.com

NEW ORLEANS, LA 70113

PHONE: 504.754.5280

WDG | ARCHITECTS ENGINEERS

ARCHITECT



ELECTRICAL ENGINEER


821 BARONNE STREET

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NEW ORLEANS, LA 70113

PHONE: 504.754.5280

WDG | ARCHITECTS ENGINEERS

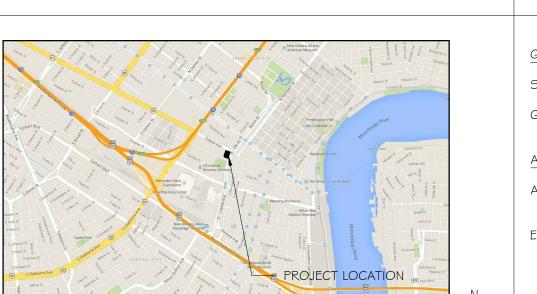

VICINITY MAP

INDEX OF DRAWINGS

SURVEY FOR REFERENCE ONLY

COVER SHEET, INDEX, SITE PLAN, GENERAL NOTES, GENERAL REQUIREMENTS

ADA SCOPE ITEMS STAIRS AND RAMP - DEMOLITION PLAN \$ NOTES, NEW WORK PLANS, SECTIONS AND DETAILS

E I OO ELEVATOR ADA UPGRADE, ELECTRICAL

DATE REV# DESCRIPTION DESCRIPTION DESCRIPTION DESCRIPTION DESCRIPTION $| \triangle |$

SCALE: 1" = 20' DATE: 8/26/2014

DRAWN BY: K.J.E. CHECKED BY: J.S.T.

PROJECT NO. 8724 8724 SHEET OF

FIRM ZONE: A1 BASE FLOOD ELEVATION: 2.5

GENERAL NOTES

THE LOCATIONS OF UNDERGROUND AND OTHER NONVISIBLE
UTILITIES SHOWN HEREON HAVE BEEN DETERMINED FROM DATA
EITHER FURNISHED BY THE AGENCIES CONTROLLING SUCH DATA
AND/OR EXTRACTED FROM RECORDS MADE AVAILABLE TO US BY
THE AGENCIES CONTROLLING SUCH RECORDS. WHERE FOUND, THE
SURFACE FEATURES OF LOCATIONS ARE SHOWN. THE ACTUAL
NONVISIBLE LOCATIONS MAY VARY FROM THOSE SHOWN HEREON.
EACH AGENCY SHOULD BE CONTACTED RELATIVE TO THE PRECISE
LOCATION OF ITS UNDERGROUND INSTALLATION PRIOR TO ANY
RELIANCE UPON THE ACCURACY OF SUCH LOCATIONS SHOWN
HEREON, INCLUDING PRIOR TO EXCAVATION AND DIGGING.

BASIS OF ELEVATION


ELEVATIONS SHOWN ON THIS SURVEY ARE BASED ON THE NORTH AMERICAN VERTICAL DATUM OF 1988 (NAVD88) UTILIZING GEOID 12A. THEY ARE DERIVED FROM GPS OBSERVATIONS REFERENCED TO THE LOUISIANA STATE UNIVERSITY CONTINUOUSLY OPERATING REFERENCE STATIONS NETWORK IN ACCORDANCE WITH LOUISIANA R.S. 50:173.1 COVERING VERTICAL CONTROL STANDARDS.

SERVITUDES

THE SERVITUDES AND RESTRICTIONS SHOWN ON THIS SURVEY ARE LIMITED TO THOSE SET FORTH IN THE DESCRIPTION FURNISHED US AND THERE IS NO REPRESENTATION THAT ALL APPLICABLE SERVITUDES AND RESTRICTIONS ARE SHOWN HEREON. THE SURVEYOR HAS MADE NO TITLE SEARCH OR PUBLIC RECORD SEARCH IN COMPILING THE DATA FOR THIS SURVEY.

SPECIAL FLOOD HAZARD AREA
I HAVE CONSULTED THE FEDERAL INSURANCE ADMINISTRATION
FLOOD HAZARD BOUNDARY MAPS AND FOUND THIS PROPERTY IS/IS
NOT IN A SPECIAL FLOOD HAZARD AREA.

COMMUNITY PANEL NO. 225203 0160 E MAP DATED/REVISED: 3/1/1984

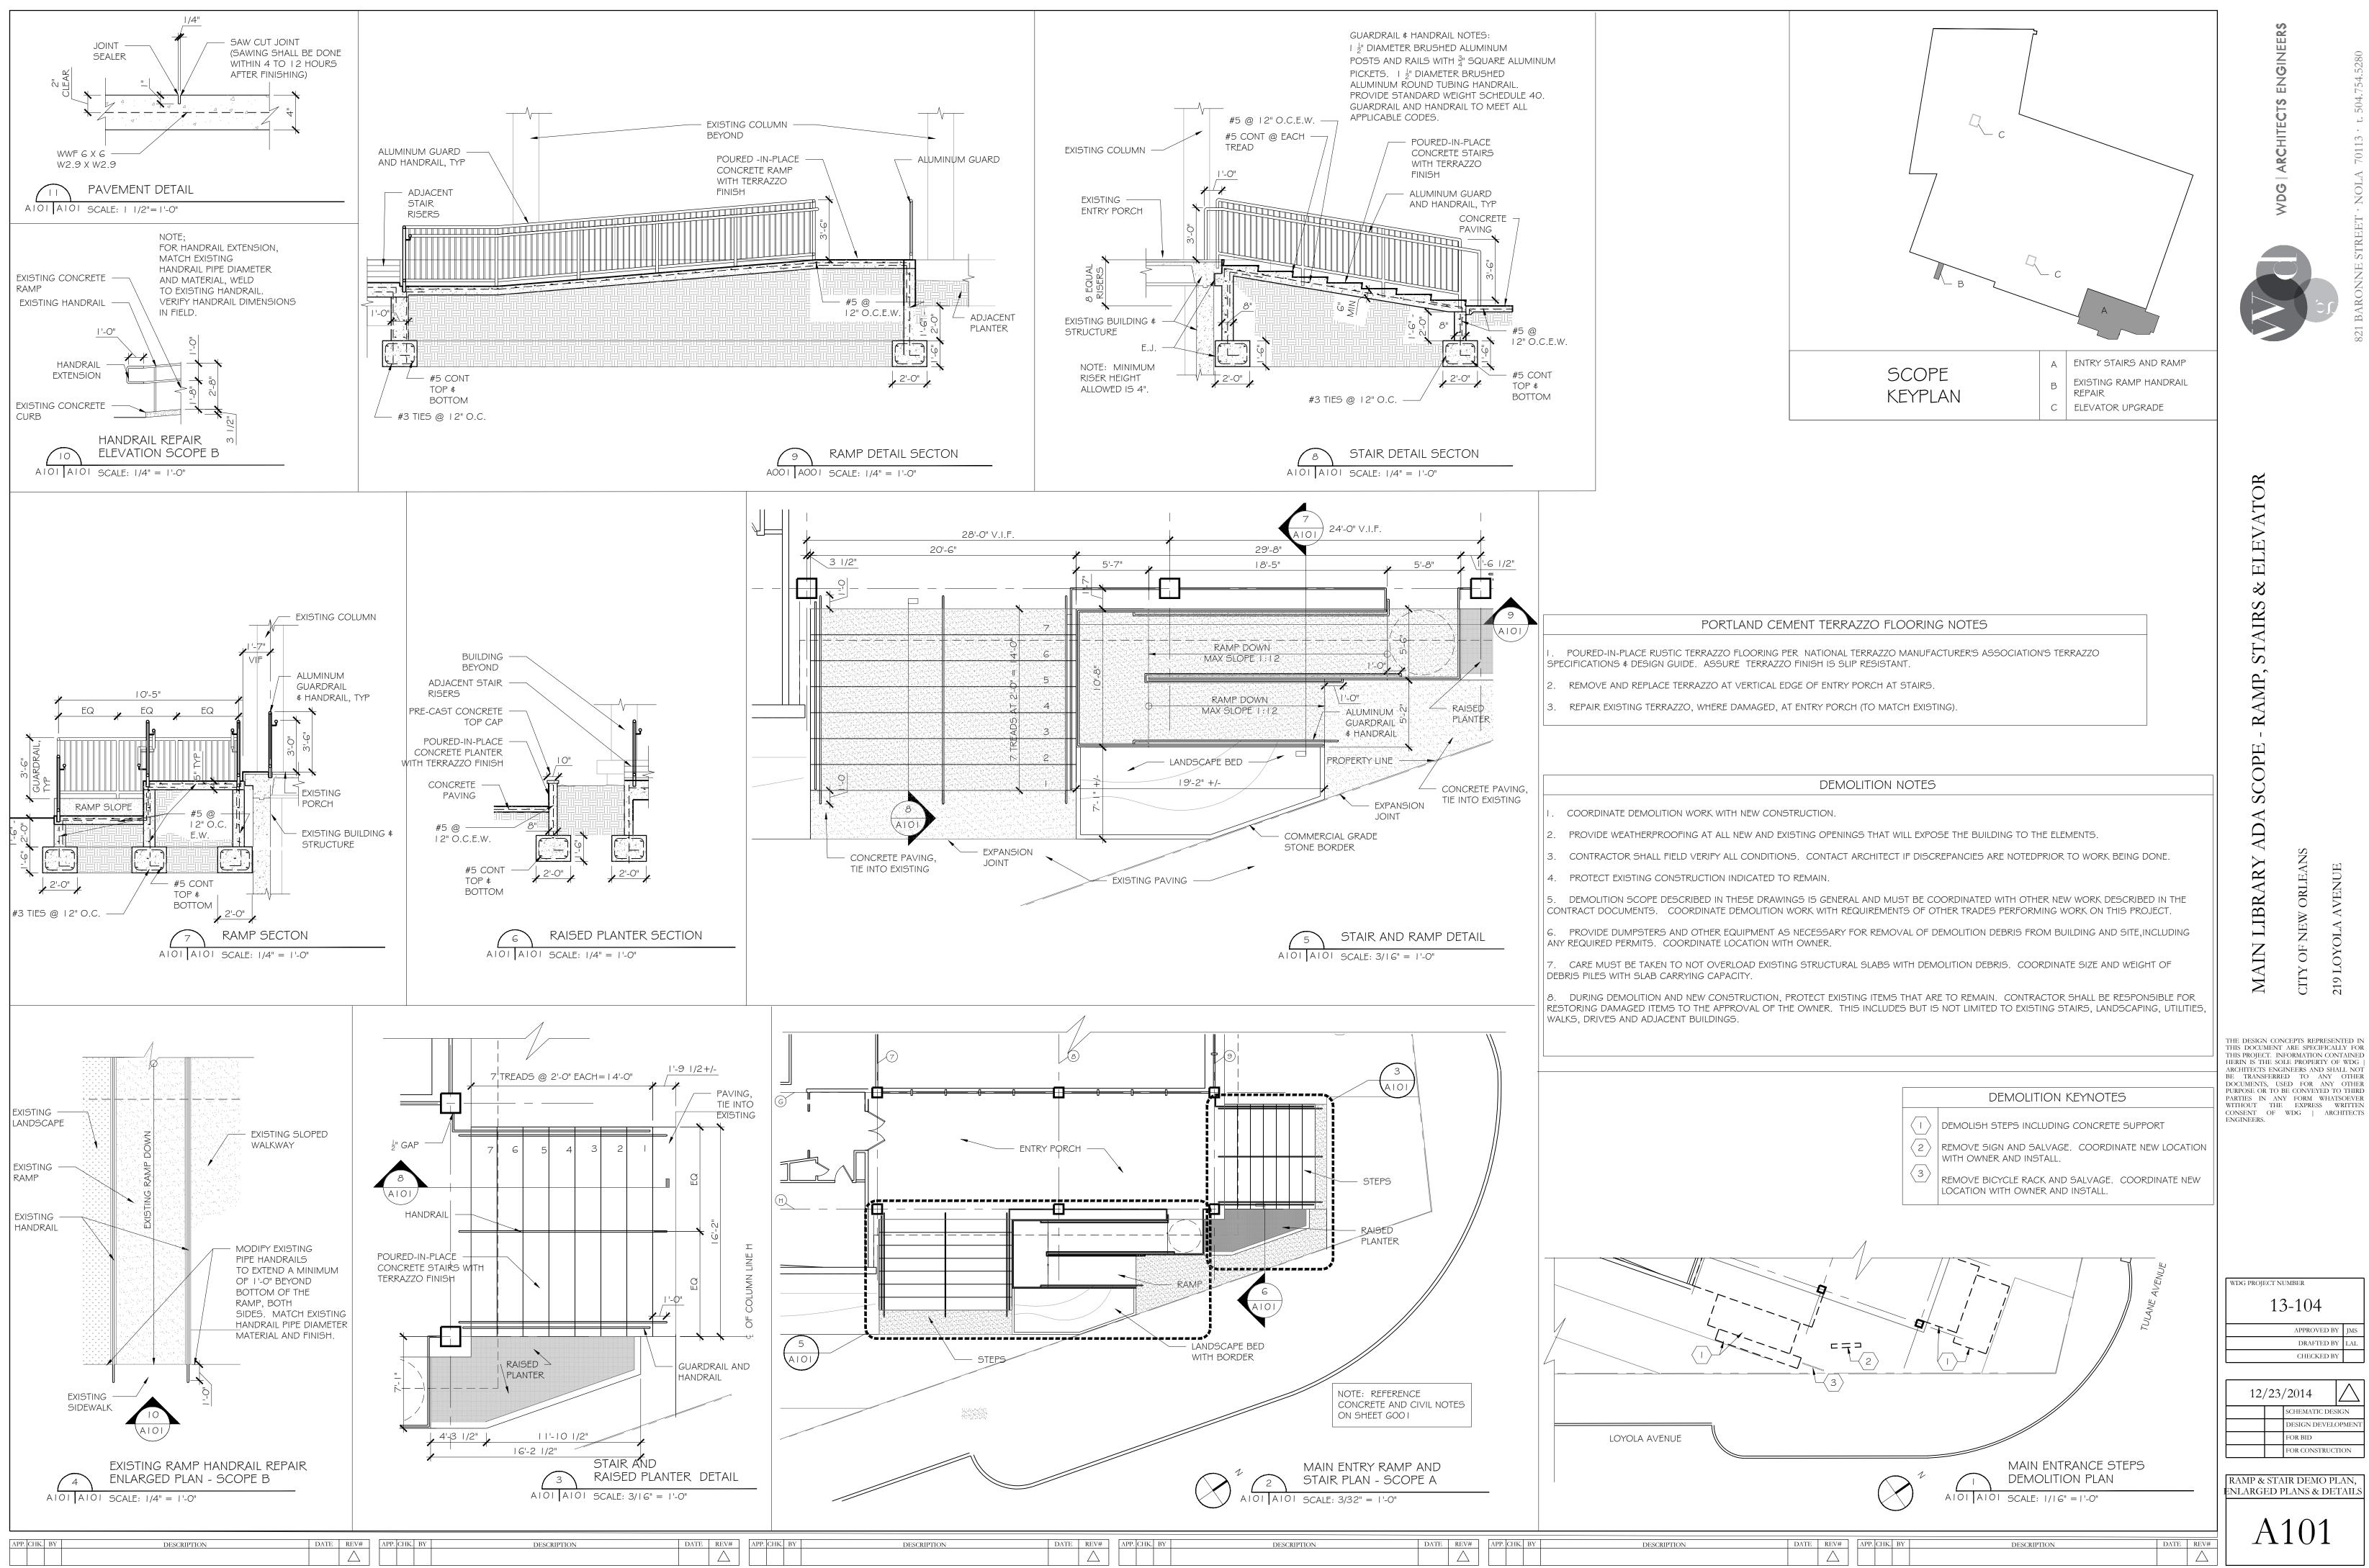

THE DESIGN CONCEPTS REPRESENTED IN THIS DOCUMENT ARE SPECIFICALLY FOR THIS PROJECT. INFORMATION CONTAINED HERIN IS THE SOLE PROPERTY OF WDG |

APPROVED BY IMS DRAFTED BY LAL CHECKED BY 12/23/2014

SCHEMATIC DESIGN DESIGN DEVELOPMEN FOR BID FOR CONSTRUCTION

RAMP & STAIR DEMO PLAN, ENLARGED PLANS & DETAILS

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THIS DOCUMENT ARE SPECIFICALLY FOR THIS PROJECT. INFORMATION CONTAINED HERIN IS THE SOLE PROPERTY OF WDG ARCHITECTS ENGINEERS AND SHALL NOT BE TRANSFERRED TO ANY OTHER DOCUMENTS, USED FOR ANY OTHER PURPOSE OR TO BE CONVEYED TO THIRD PARTIES IN ANY FORM WHATSOEVER WITHOUT THE EXPRESS WRITTEN CONSENT OF WDG | ARCHITECTS ENGINEERS.

WDG PROJECT NUMBER 13-104

DRAFTED BY CHECKED BY B 12/23/2014

DESIGN DEVELOPMI FOR CONSTRUCTION

E100

ELECTRICAL