


ORLEANS PARISH, LOUISIANA KENILWORTH PLAYGROUND

7820 REDFISH STREET
NEW ORLEANS, LA 70126
MARCH 2017

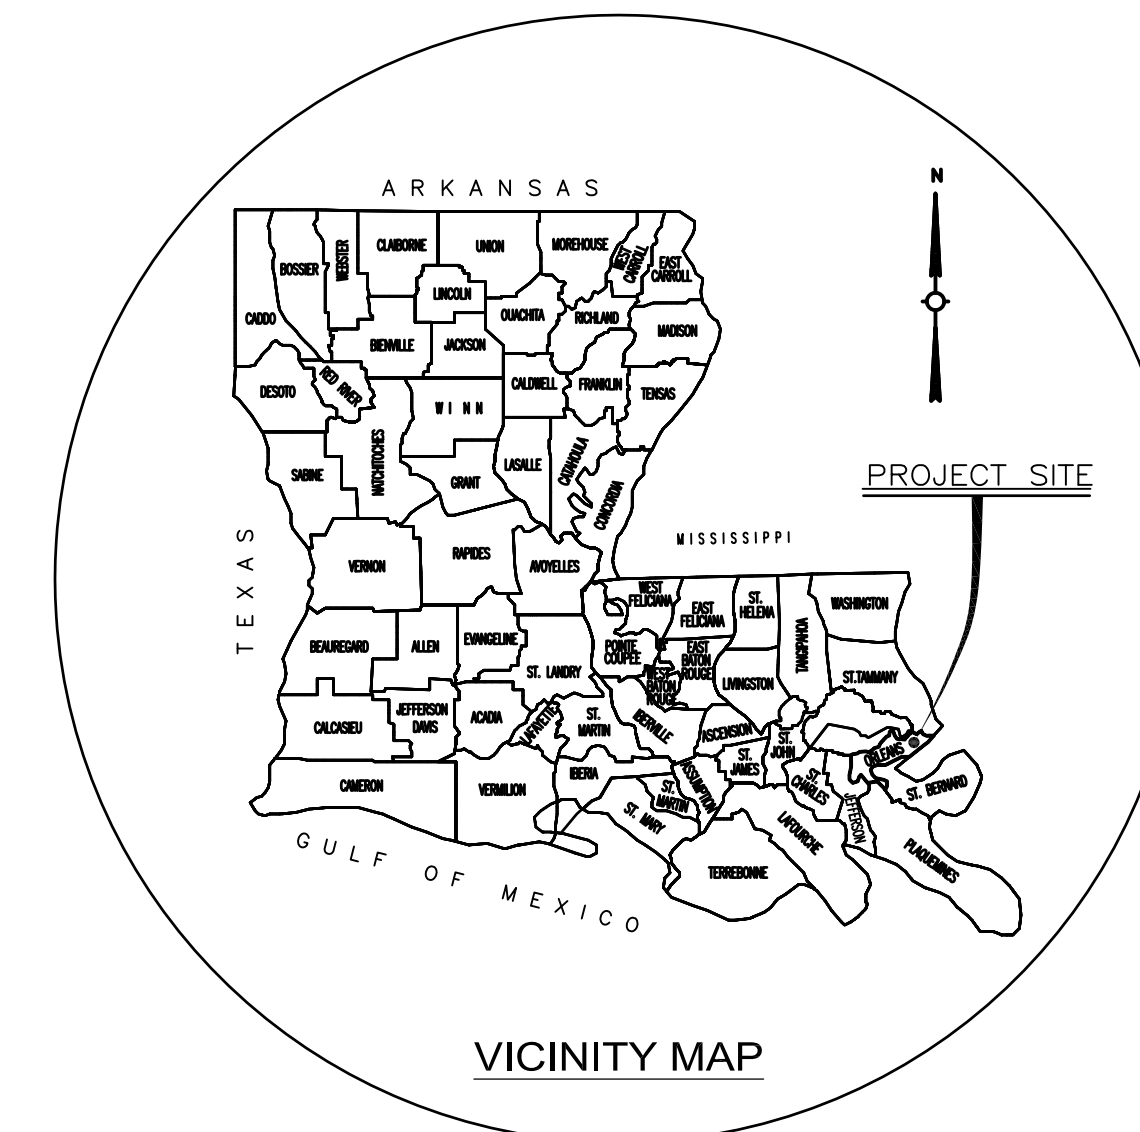

MITCHELL J. LANDRIEU
MAYOR

STACY HEAD
COUNCILMEMBER-AT-LARGE

JASON ROGERS WILLIAMS
COUNCILMEMBER-AT-LARGE

COUNCIL

SUSAN G. GUIDRY	DISTRICT "A"
LATOYA CANTRELL	DISTRICT "B"
NADINE M. RAMSEY	DISTRICT "C"
JARED C. BROSSETT	DISTRICT "D"
JAMES AUSTIN GRAY II	DISTRICT "E"



IMAGE: EXISTING SITE CLUB HOUSE



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3608 18th Street / Suite 200
Metairie, Louisiana 70002
(504) 833-5300 / (504) 833-5350 Fax



INDEX TO SHEETS

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3	DEMOLITION PLAN
4	HARDSCAPE PLAN
5	HARDSCAPE DETAILS
6	BASKETBALL COURT DETAILS (ALTERNATE #1)
7	BATTING CAGE & FENCE DETAILS
8	TREE PROTECTION DETAILS
9	CHAIN LINK BACKSTOP DETAILS
10	BUILDING DEMOLITION NOTES
11	BUILDING PLAN AND NOTES
12	ROOF REPAIR
13	STAGING LIMITS PLAN
E-1.0	LIGHTING DEMOLITION PLAN
E-1.1	LIGHTING PLAN
M-1	HVAC PLAN
P-1	SANITARY SEWER
P-2	DOMESTIC WATER

TYPE OF CONSTRUCTION

DEMOLITION, CONCRETE, FENCING, BATTING
CAGES AND BUILDING RENOVATIONS

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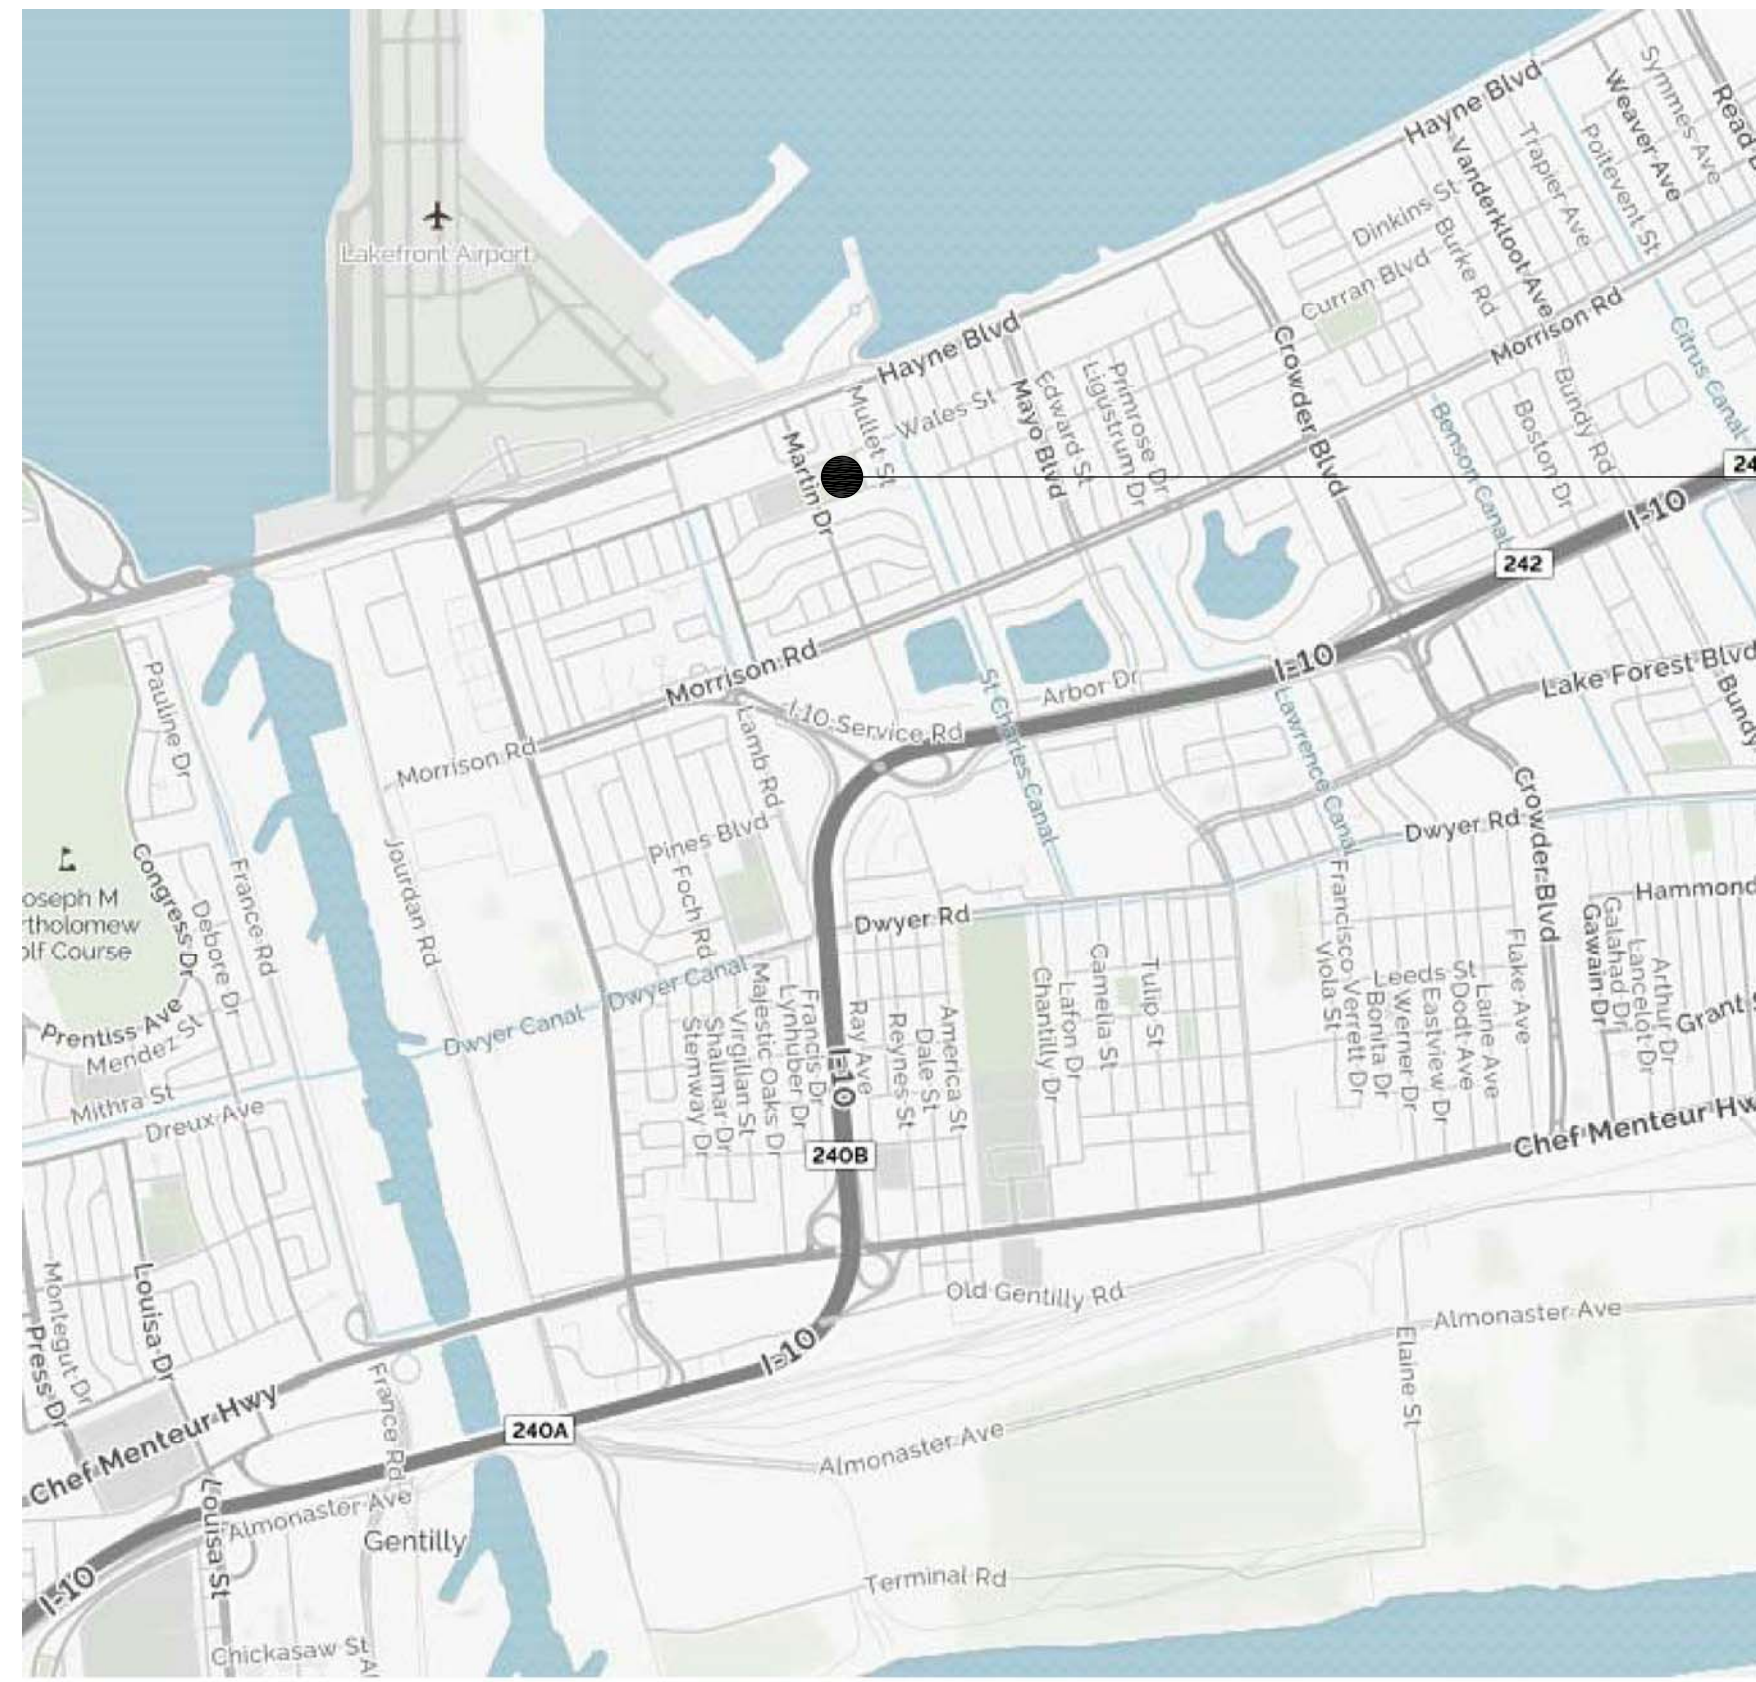


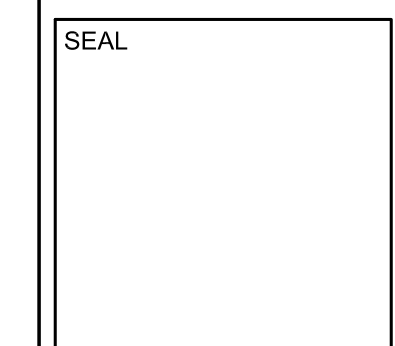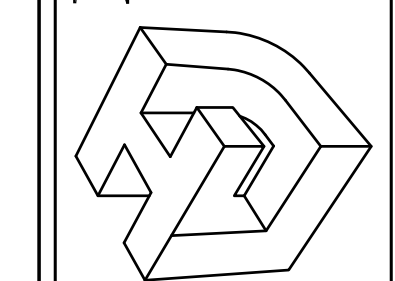REV. NO.	DATE


KENILWORTH PLAYGROUND
NEW ORLEANS, LOUISIANA
COVER SHEET / LOCATION MAPS
DRAWN BY: LHJ
CHECKED BY: LHJ
APPROVED BY: LHJ

PROJ. NO.	15-190
DATE	03-29-2017
SHEET NO.	1

FINAL PLANS




1 VICINITY MAP
N.T.S.

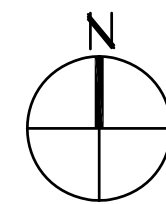

PROJECT SITE

PROJECT SITE

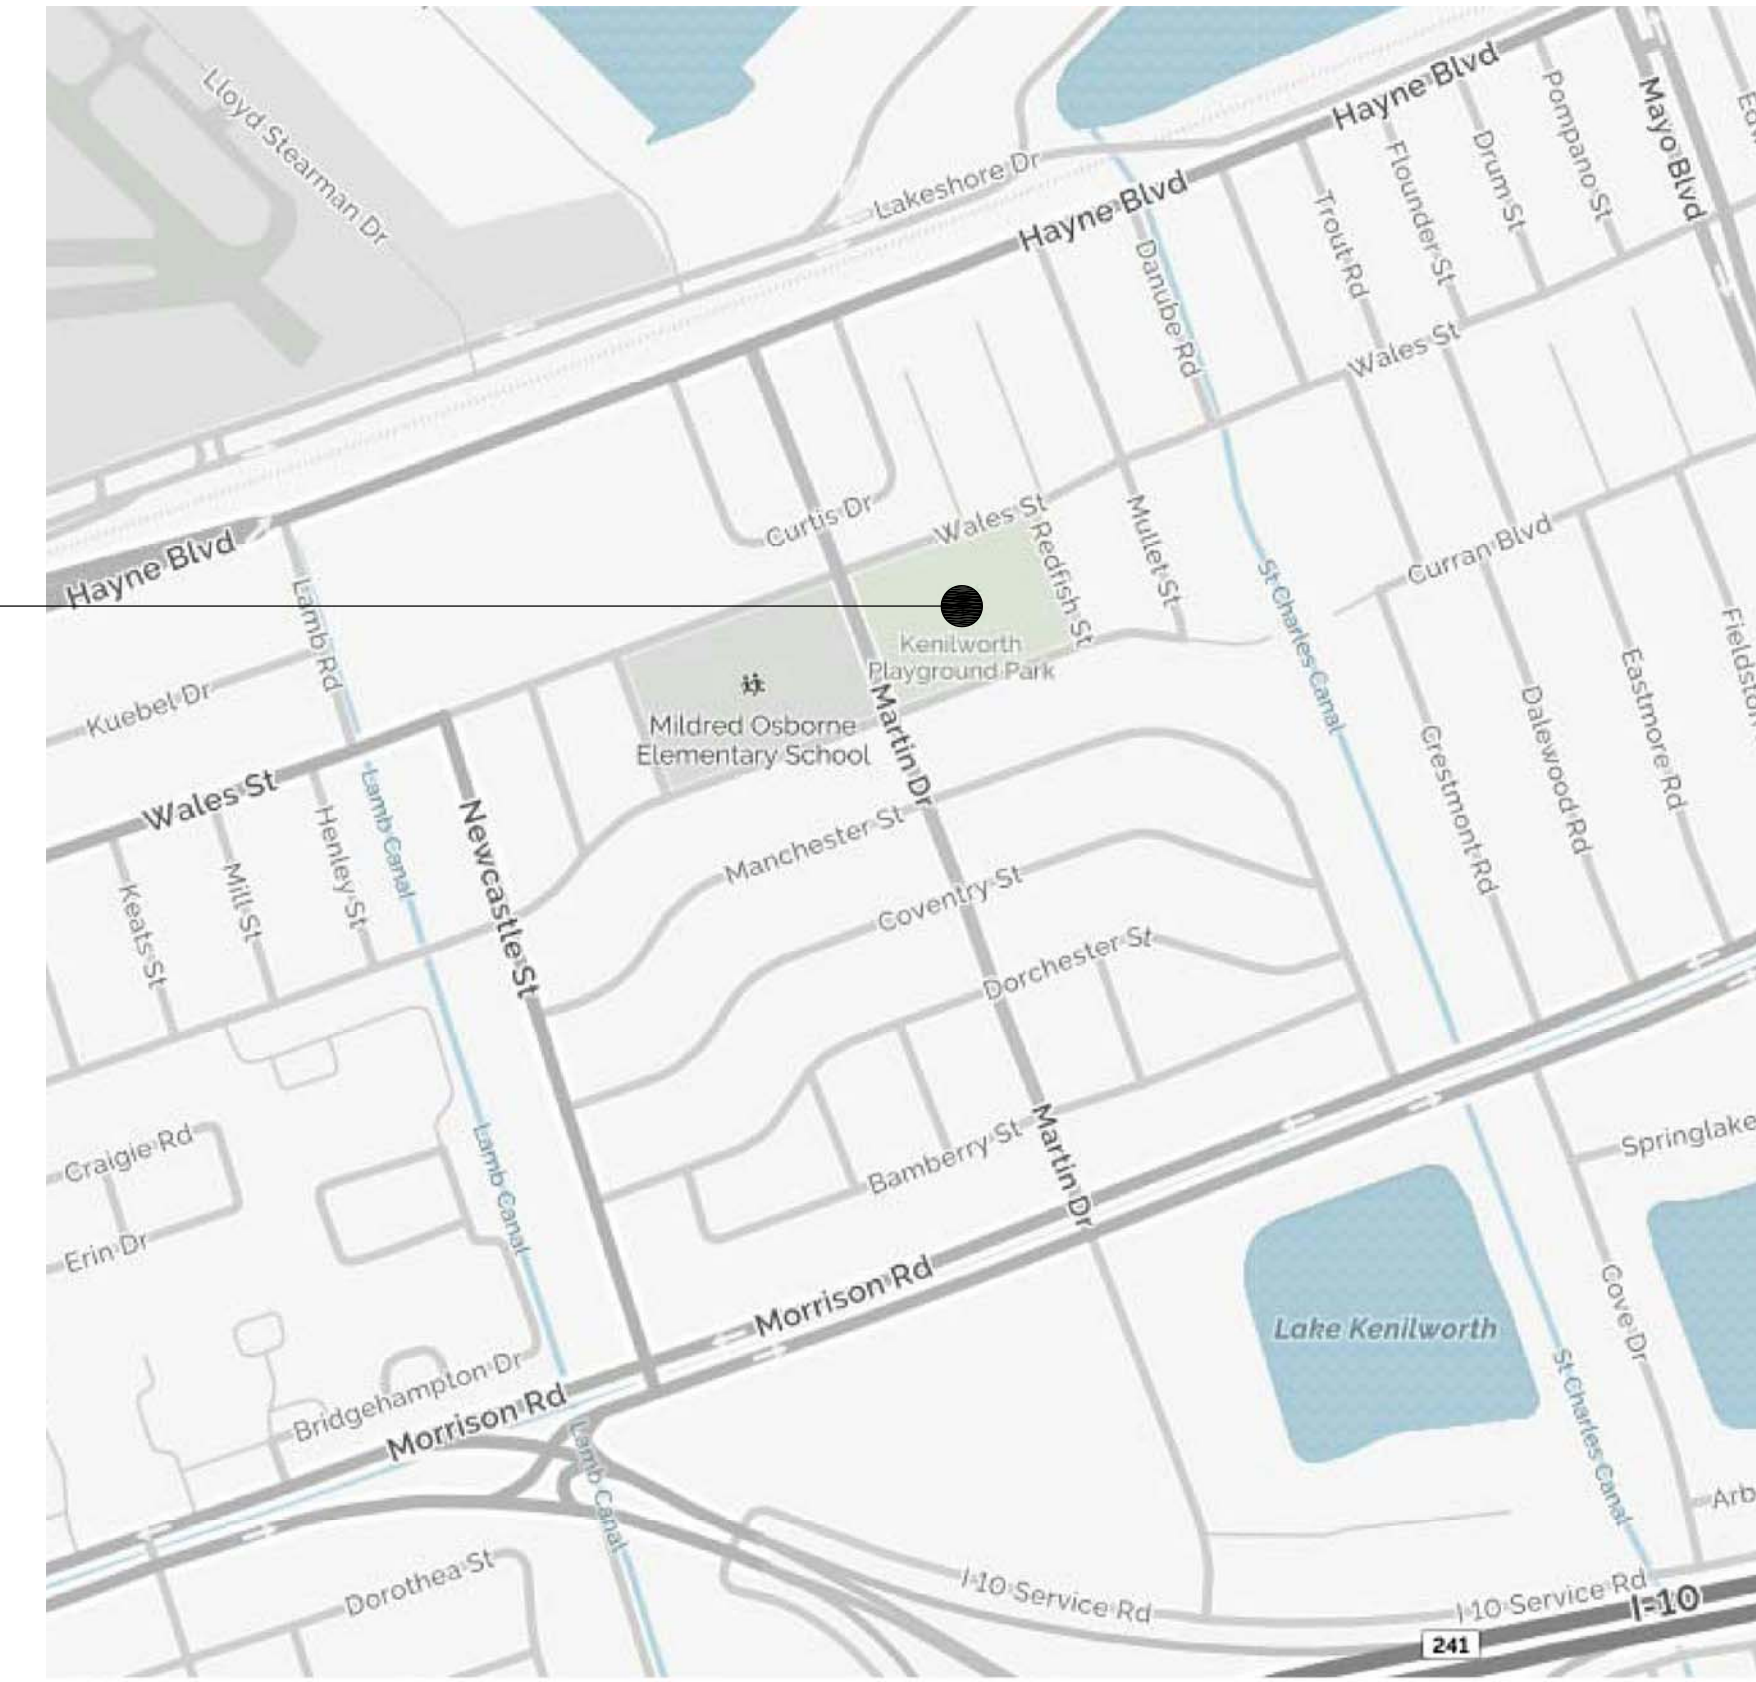

2 LOCATION MAP
N.T.S.



GENERAL NOTES:

- 1 DRAWINGS ARE GENERALLY TO SCALE, BUT SHOULD NOT BE SCALED.
- 2 DIMENSIONS AND/OR ELEVATIONS MARKED (N.T.S.) ARE NOT SHOWN TO SCALE.
- 3 DIMENSIONS AND/OR ELEVATIONS MARKED THUS (+/-) ARE APPROXIMATE. CONTRACTOR SHALL VERIFY ACTUAL DIMENSIONS IN THE FIELD.
- 4 CONTRACTOR SHALL BE RESPONSIBLE FOR LAYING OUT THE WORK AND VERIFYING ALL MEASUREMENTS AND GRADES PRIOR TO BEGINNING OF CONSTRUCTION. ANY POTENTIAL CONFLICTS SHALL BE BROUGHT TO LANDSCAPE ARCHITECT'S ATTENTION PRIOR TO CONSTRUCTION.
- 5 THE CONTRACTOR SHALL BE RESPONSIBLE TO ESTABLISH AND MAINTAIN TEMPORARY BENCH MARKS DURING CONSTRUCTION AS NEEDED.
- 6 LOCATION OF EXISTING UTILITIES INDICATED ON THE PLAN SHEETS ARE SHOWN FOR INFORMATIONAL PURPOSES ONLY AND ARE BASED, IN PART, ON INFORMATION PROVIDED BY THE RESPECTIVE UTILITY COMPANIES. IT IS THE CONTRACTOR'S RESPONSIBILITY TO LOCATE AND VERIFY ALL EXISTING PRIVATE AND PUBLIC UTILITY LOCATIONS PRIOR TO CONSTRUCTION.
- 7 ALL UTILITIES ARE TO REMAIN UNLESS OTHERWISE NOTED.
- 8 IT IS THE CONTRACTOR'S RESPONSIBILITY TO HAVE ANY NECESSARY UTILITIES TEMPORARILY SHUT DOWN DURING CONSTRUCTION.
- 9 ALL WORK AROUND HIGH VOLTAGE POWER LINES SHALL BE IN ACCORDANCE WITH OSHA AND ENERGY REQUIREMENTS.
- 10 CONTRACTOR SHALL NOTIFY THOSE AFFECTED BY CONSTRUCTION 48 HOURS PRIOR TO DISRUPTION OF WATER, SEWER OR OTHER UTILITY SERVICE. THESE SERVICES SHALL BE PROMPTLY REPAIRED AND NOT REMAIN OUT OF SERVICE OVERNIGHT, UNLESS OTHERWISE APPROVED.
- 11 THE CONTRACTOR IS RESPONSIBLE FOR ANY DAMAGE TO EXISTING UTILITIES CAUSED BY CONSTRUCTION OPERATIONS. THE DAMAGE SHALL BE REPAIRED AT THE CONTRACTOR'S EXPENSE.
- 12 CONTRACTOR SHALL NOT IMPEDE THE EXISTING DRAINAGE DURING THE CONSTRUCTION. CONTRACTOR SHALL BE RESPONSIBLE TO TAKE NECESSARY STEPS TO FACILITATE THE DRAINAGE AT ALL TIMES. EROSION CONTROL METHODS SHALL BE IMPLEMENTED AROUND ALL CATCH BASINS THROUGHOUT CONSTRUCTION.
- 13 CONTRACTOR SHALL NOT BE ALLOWED TO IMPEDE EXISTING OR NEW DRAINAGE DURING RAINSTORM OR WHEN A STORM IS IMMINENT.
- 14 CONTRACTOR SHALL TAKE REASONABLE MEASURES TO AVOID UNNECESSARY NOISE APPROPRIATE FOR THE AMBIENT SOUND LEVELS IN THE AREA DURING WORKING HOURS. ALL CONSTRUCTION MACHINERY AND VEHICLES SHALL BE EQUIPPED WITH PRACTICAL SOUND MUFFLING DEVICES, AND OPERATED IN A MANNER TO CAUSE THE LEAST NOISE, CONSISTENT WITH EFFICIENT PERFORMANCE OF THE WORK.
- 15 CONTRACTOR SHALL TAKE REASONABLE MEASURES TO PREVENT UNNECESSARY DUST. EACH SURFACE SUBJECT TO DUSTING SHALL BE KEPT MOIST WITH WATER OR BY APPLICATION OF CHEMICAL DUST SUPPRESSANT. DUSTY MATERIALS IN PILES OR IN TRANSIT SHALL BE COVERED TO PREVENT BLOWING.
- 16 CONTRACTOR SHALL BE REQUIRED TO ADEQUATELY FENCE HIS CONSTRUCTION OPERATIONS. THE CONTRACTOR SHALL KEEP THE SITE SECURED AS TO NOT AFFECT THE HEALTH, SAFETY AND WELFARE OF THE GENERAL PUBLIC.
- 17 CONTRACTOR TO KEEP VEHICULAR SIGHT LINES CLEAR AT ALL TIMES, UNLESS PROPER LANE RESTRICTIONS ARE IN PLACE. NO STOCKPILING OR STORAGE OF MATERIAL OR EQUIPMENT WITHIN VEHICULAR SIGHT LINES.

GENERAL NOTES: (CONTINUED)

- 18 ALL EQUIPMENT, AND MATERIALS, REQUIRED FOR CONSTRUCTION OF THE PROJECT IS TO REMAIN INSIDE THE LIMITS OF WORK AT ALL TIMES. CONTRACTOR IS RESPONSIBLE FOR ANY DAMAGE CAUSED BY HIS EQUIPMENT OR MATERIALS THAT OCCURS OUTSIDE OF THE LIMITS OF WORK.
- 19 CONTRACTOR SHALL NOT HAVE AN ON SITE OFFICE (TRAILER). ANY EQUIPMENT LEFT ON SITE IS THE CONTRACTOR'S RESPONSIBILITY. NO STORAGE OF EQUIPMENT OR MATERIALS CAN BLOCK ANY TRAFFIC SIGHT LINES.
- 20 CONTRACTOR IS RESPONSIBLE TO OBTAIN ANY AND ALL REQUIRED PERMITS, INSPECTIONS, APPROVALS, AND APPLICABLE FEES INVOLVED WITH THIS PROJECT.
- 21 THE CONTRACTOR SHALL COOPERATE WITH ANY CITY OF NEW ORLEANS EMPLOYEES OR CONTRACTORS THAT MAY BE WORKING WITHIN THE LIMITS OF WORK AT THE SAME TIME AS THIS CONTRACT.
- 22 ALL ITEMS SCHEDULED FOR REMOVAL SHALL BE HAULED OFF FROM THE SITE THE SAME DAY IN IN WHICH IT IS REMOVED. NO STOCKPILING OF REMOVED MATERIAL SHALL BE ALLOWED.
- 23 THE CONTRACTOR SHALL BE REQUIRED TO FENCE AROUND THE EXISTING TREES. THE CONTRACTOR SHALL NOT STOCKPILE ANY EQUIPMENT, MATERIAL OR DEBRIS UNDER THE CANOPY OF ANY EXISTING TREES. THE CONTRACTOR SHALL NOT CHANGE THE GRADE, UNLESS SHOWN ON THE PLANS, UNDER THE CANOPY OF ANY EXISTING TREES. ANY DAMAGE OCCURRING TO THE EXISTING TREES SHALL BE ASSESSED BY A CONTRACTOR PROVIDED LICENSED ARBORIST. THE ARBORIST SHALL SUPPLY THE OWNER WITH A WRITTEN REPORT OF THE DAMAGE AND OUTLINE THE PROPOSED WORK TO REMEDY THE DAMAGE FOR APPROVAL BY THE OWNER. THE CONTRACTOR SHALL BE RESPONSIBLE FOR FOLLOWING THE ARBORIST'S RECOMMENDATION FOR TREE REMEDIATION. ANY TREES DAMAGED BEYOND THE ARBORIST'S REMEDIATION REPORT SHALL BE REPLACE WITH A TREE(S) OF EQUAL SIZE AND SPECIES.


CONTACT INFORMATION:

LANDSCAPE ARCHITECT: LINFELD, HUNTER & JUNIUS, INC. 3608 18th STREET METAIRIE, LOUISIANA 70002	(504) 833-5300
OWNER: NEW ORLEANS CAPITAL PROJECTS ADMINISTRATION 1300 PERDIDO STREET NEW ORLEANS, LOUISIANA 70112	(504) 658-8666
NEW ORLEANS RECREATION DEVELOPMENT COMMISSION NEW ORLEANS DEPT. OF PUBLIC WORKS: SEWERAGE & WATER BOARD OF NEW ORLEANS: ENERGY NEW ORLEANS: ATMOS ENERGY SERVICES, LLC: LA ONE CALL:	(504) 658-3052 (504) 658-8000 (504) 529-2837 (800) 368-3749 (504) 681-3100 811

GENERAL LEGEND:

- EXISTING BUILDING
- EXISTING DUGOUT
- EXISTING PRESS BOX
- EXISTING BLEACHERS
- EXISTING HIGHMAST LIGHT
- EXISTING CHAIN LINK FENCE
- EXISTING CHAIN LINK FENCE GATE
- EXISTING SCOREBOARD
- EXISTING BASKETBALL GOAL
- EXISTING CONCRETE
- EXISTING CHAIN LINK BATTING CAGE
- EXISTING OAK TREE (TO REMAIN)
- REQUIRED TREE PROTECTION FENCE

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Metairie, Louisiana 70002

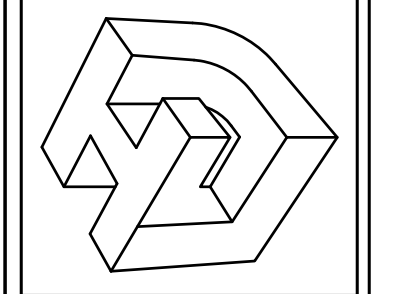

SEAL	
REV. NO.	DATE

KENILWORTH PLAYGROUND NEW ORLEANS, LOUISIANA	
THIS SHEET DRAWN BY LHU	APPROVED BY LHU
MAPS & GENERAL NOTES	

PROJ. NO.	15-190
DATE	03-29-2017
SHEET NO.	2
OF 17 SHEETS	



TIME: 4:12 PM

DATE: 4/10/2017


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MARTIN DRIVE

WALES STREET

REDFISH STREET


CURRAN BOULEVARD

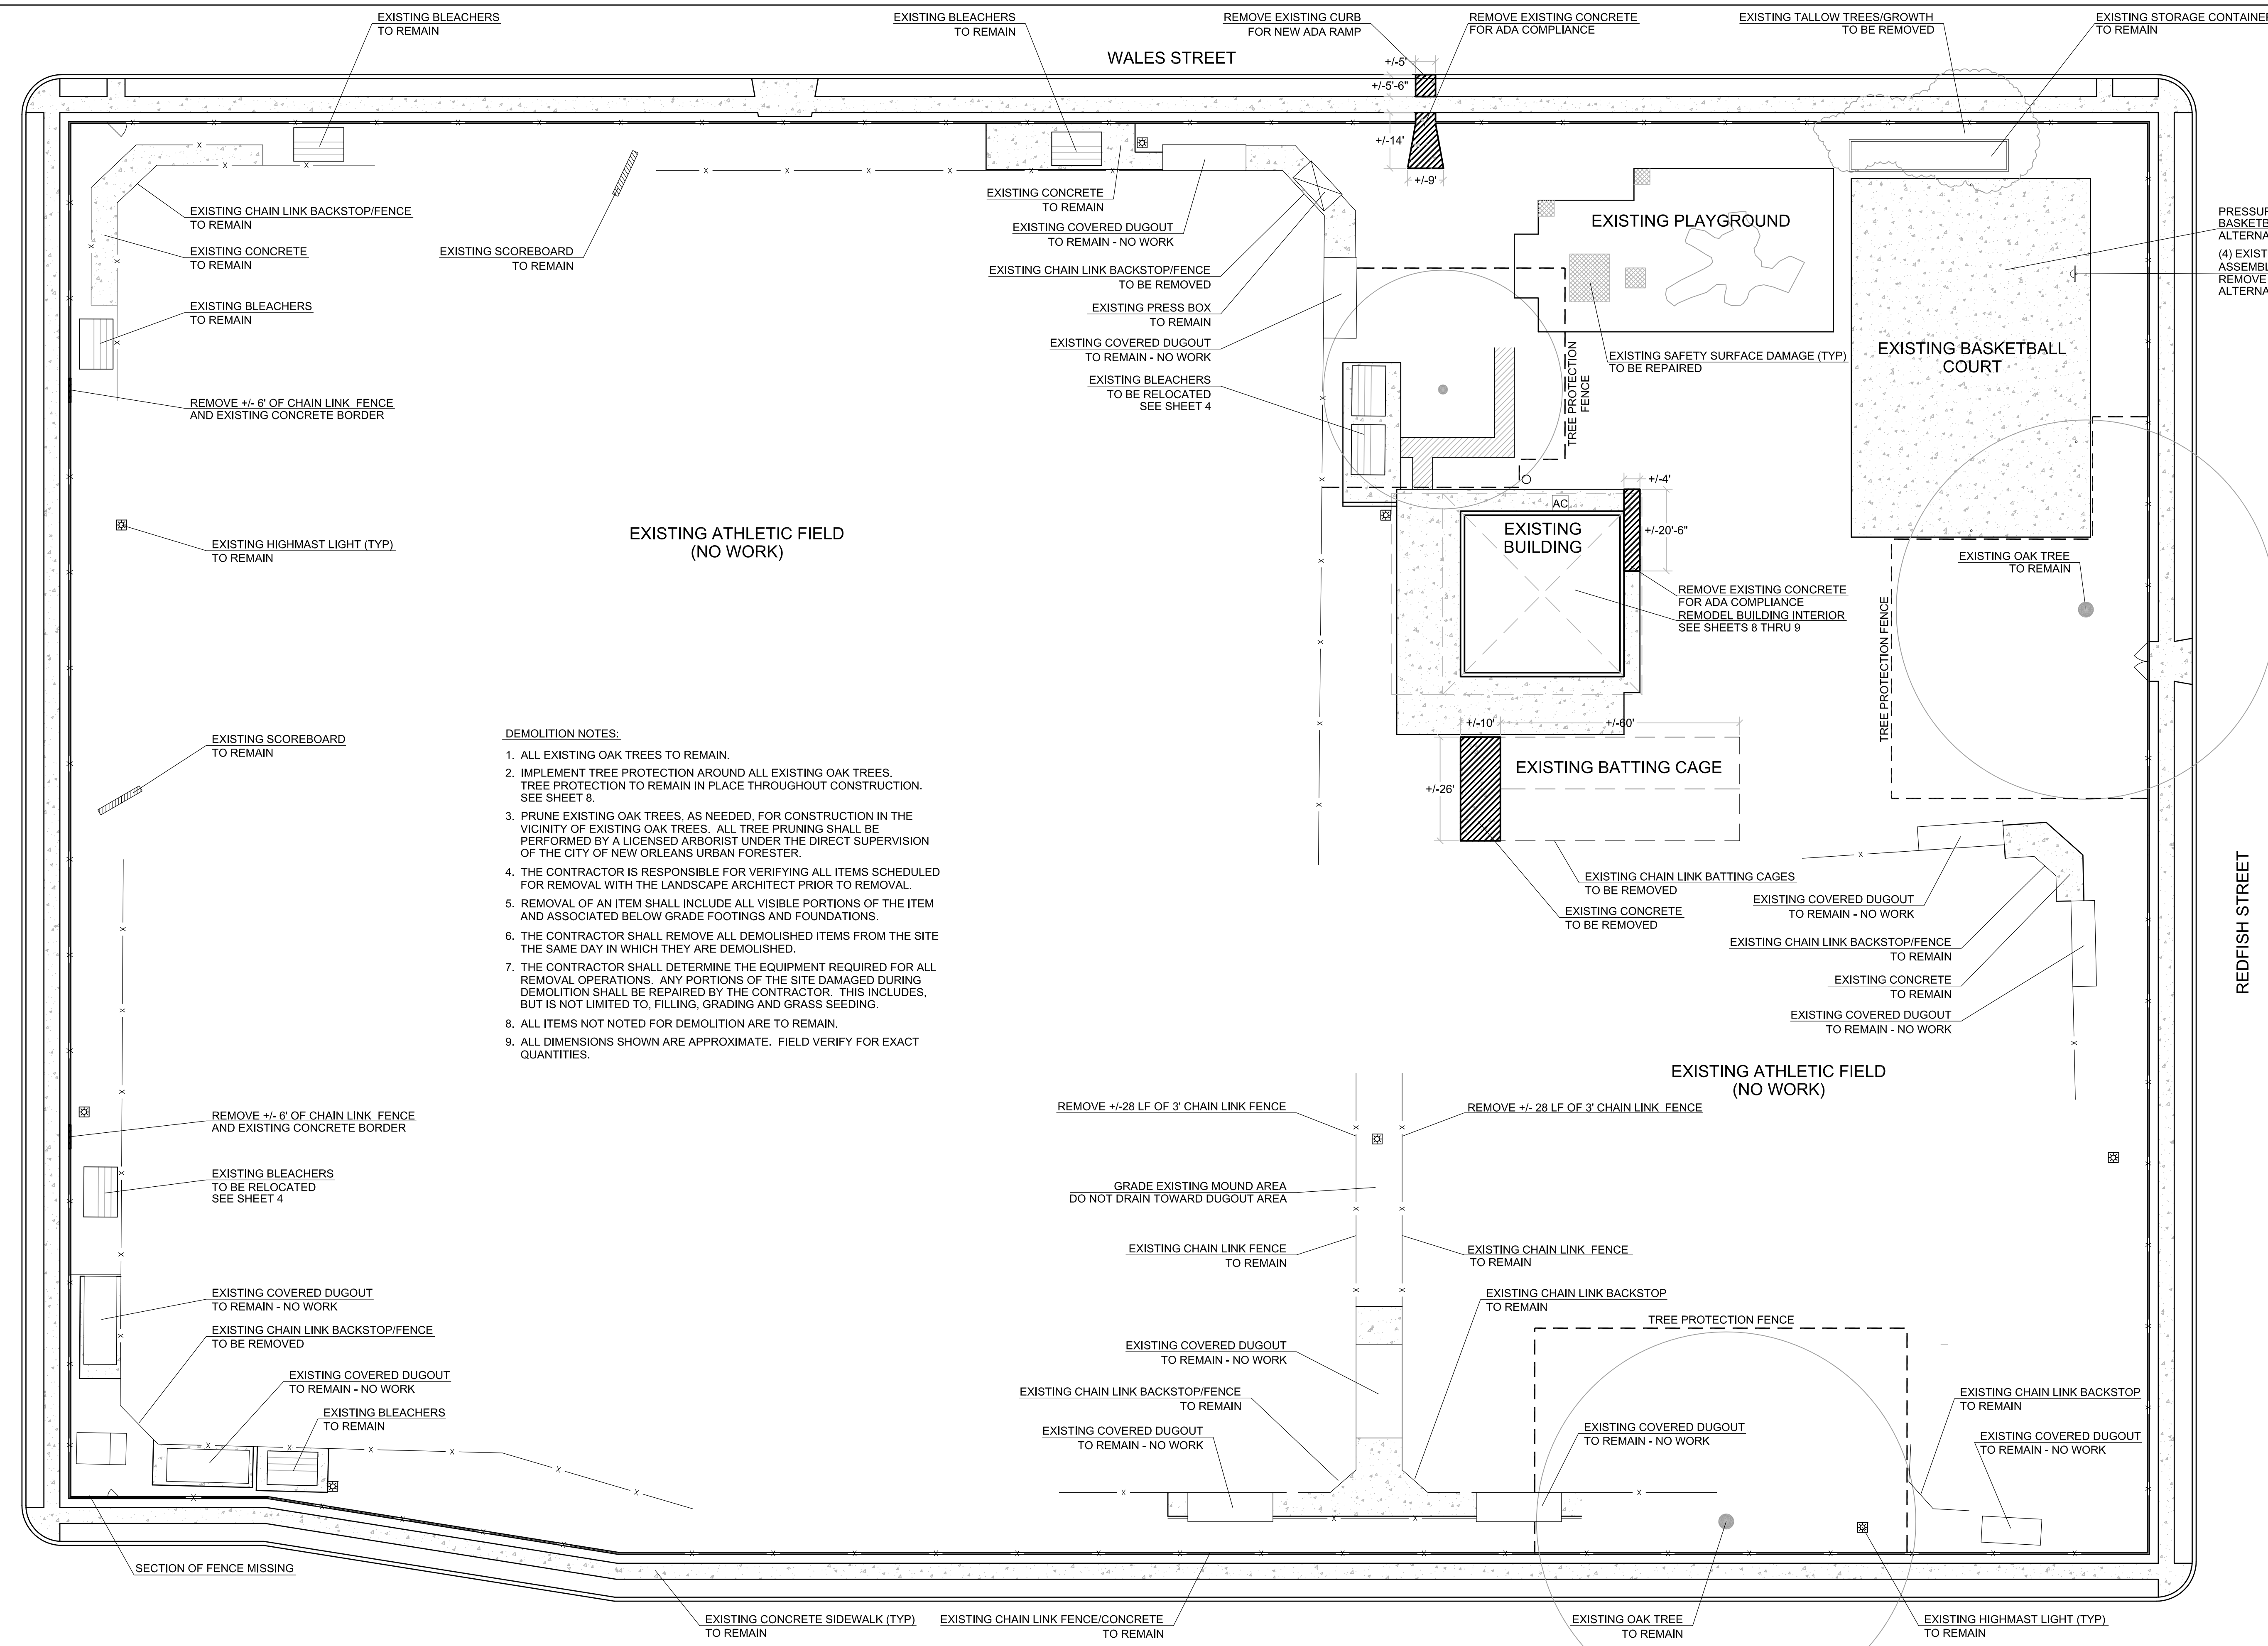

DEMOLITION NOTES:

1. ALL EXISTING OAK TREES TO REMAIN.
2. IMPLEMENT TREE PROTECTION AROUND ALL EXISTING OAK TREES. TREE PROTECTION TO REMAIN IN PLACE THROUGHOUT CONSTRUCTION. SEE SHEET 8.
3. PRUNE EXISTING OAK TREES, AS NEEDED, FOR CONSTRUCTION IN THE VICINITY OF EXISTING OAK TREES. ALL TREE PRUNING SHALL BE PERFORMED BY A LICENSED ARBORIST UNDER THE DIRECT SUPERVISION OF THE CITY OF NEW ORLEANS URBAN FORESTER.
4. THE CONTRACTOR IS RESPONSIBLE FOR VERIFYING ALL ITEMS SCHEDULED FOR REMOVAL WITH THE LANDSCAPE ARCHITECT PRIOR TO REMOVAL.
5. REMOVAL OF AN ITEM SHALL INCLUDE ALL VISIBLE PORTIONS OF THE ITEM AND ASSOCIATED BELOW GRADE FOOTINGS AND FOUNDATIONS.
6. THE CONTRACTOR SHALL REMOVE ALL DEMOLISHED ITEMS FROM THE SITE THE SAME DAY IN WHICH THEY ARE DEMOLISHED.
7. THE CONTRACTOR SHALL DETERMINE THE EQUIPMENT REQUIRED FOR ALL REMOVAL OPERATIONS. ANY PORTIONS OF THE SITE DAMAGED DURING DEMOLITION SHALL BE REPAIRED BY THE CONTRACTOR. THIS INCLUDES, BUT IS NOT LIMITED TO, FILLING, GRADING AND GRASS SEEDING.
8. ALL ITEMS NOT NOTED FOR DEMOLITION ARE TO REMAIN.
9. ALL DIMENSIONS SHOWN ARE APPROXIMATE. FIELD VERIFY FOR EXACT QUANTITIES.

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 Metairie, Louisiana 70002

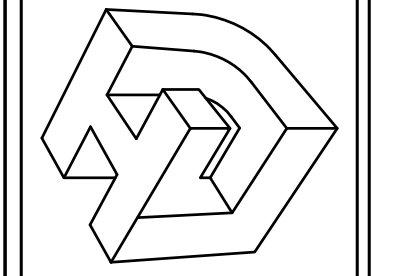

SEAL


REV. NO.	DATE

**KENILWORTH PLAYGROUND
 NEW ORLEANS, LOUISIANA**
 THIS SHEET
SITE DEMOLITION PLAN
 DRAWN BY: LHJ
 CHECKED BY: LHJ
 APPROVED BY: LHJ

PROJ. NO.	15-190
DATE	03-29-2017
SHEET NO.	3

OF 17 SHEETS

1
SITE DEMOLITION PLAN
 1" = 20'-0"

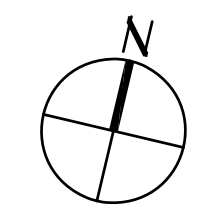

TIME: 4:13 PM

DATE: 4/10/2017


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MARTIN DRIVE


WALES STREET

REDFISH STREET


CURRAN BOULEVARD

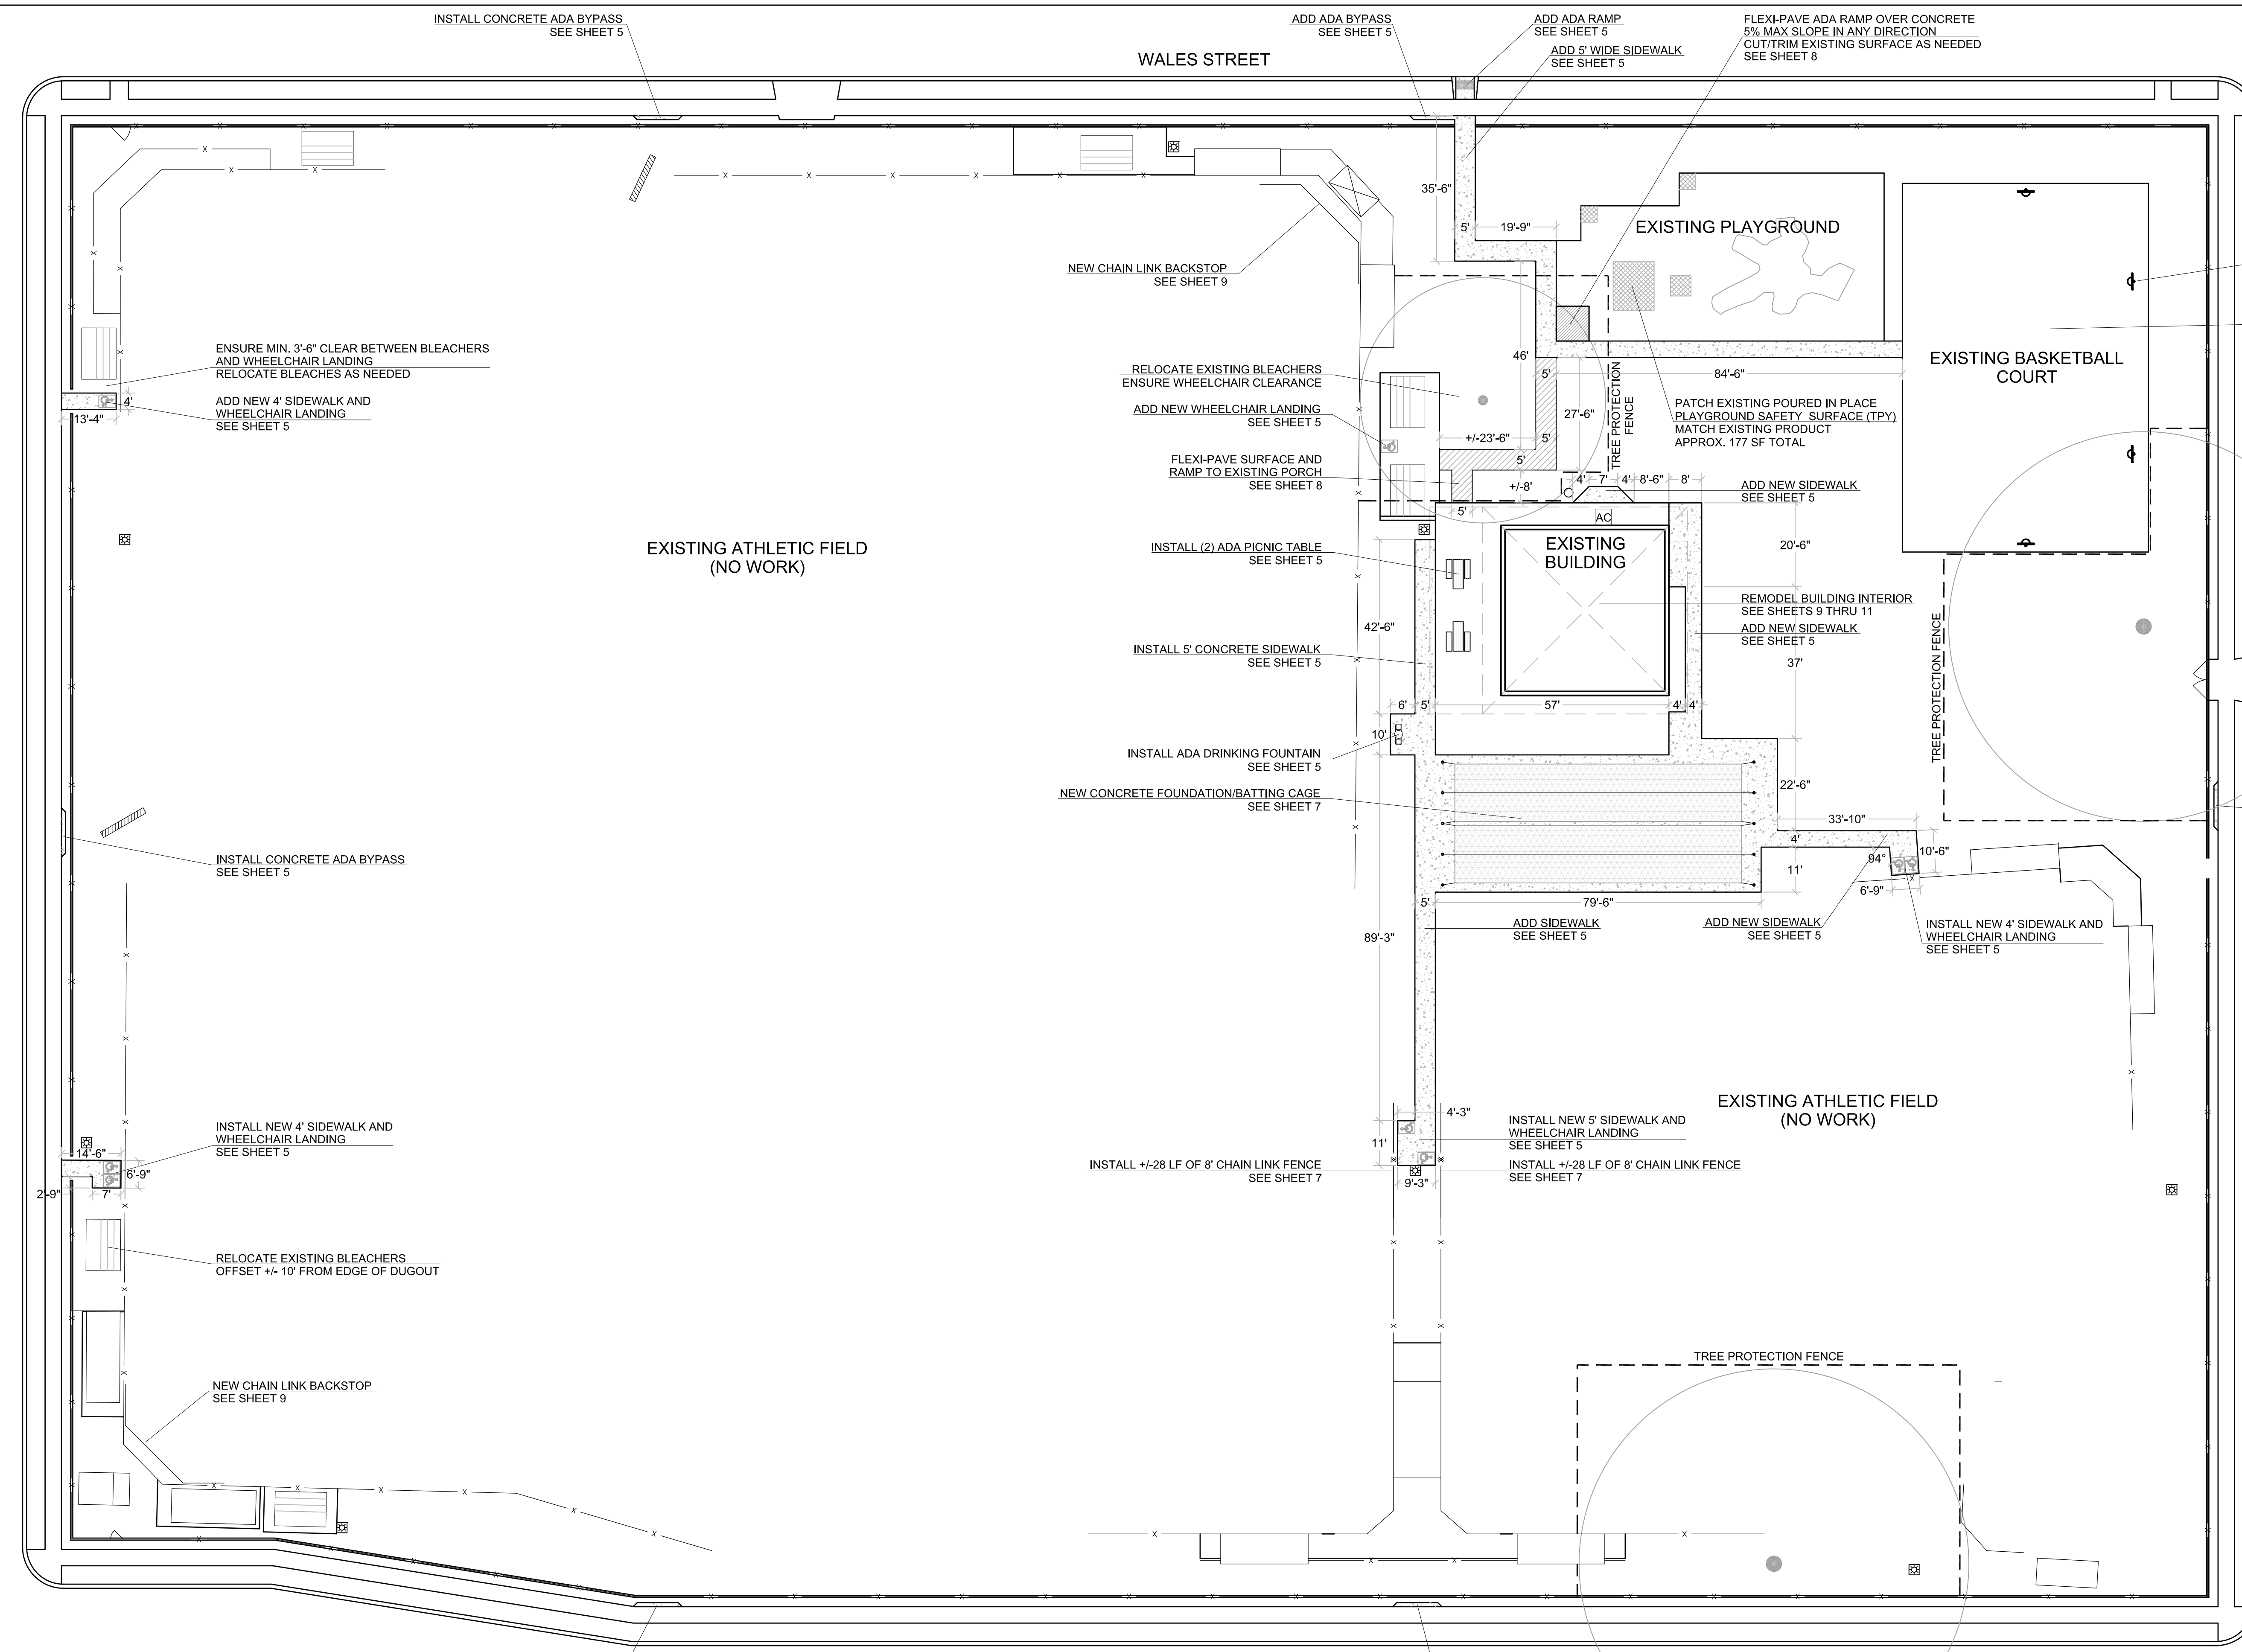

1 SITE HARDSCAPE PLAN
 4
 1" = 20'-0"

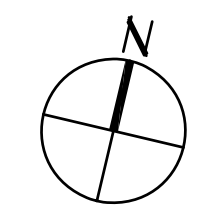

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 AND SURVEYORS
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 Metairie, Louisiana 70002

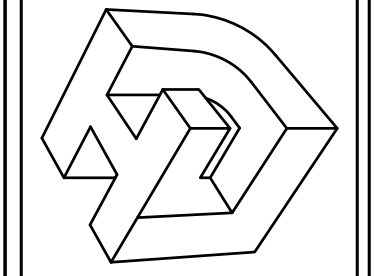

SEAL

REV. NO.	DATE


KENILWORTH PLAYGROUND
 NEW ORLEANS, LOUISIANA
 THIS SHEET
 SITE HARDSCAPE PLAN
 DRAWN BY LHJ
 CHECKED BY LHJ
 APPROVED BY LHJ

PROJ. NO. 15-190
 DATE 03-29-2017
 SHEET NO. **4**
 OF 17 SHEETS

TIME: 4:13 PM

DATE: 4/10/2017


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- NOTES:
- DUMOR, INC. TABLE 443 6' TABLE W/6' BENCHES (OR APPROVED EQUAL)
 - MOUNTING: SURFACE MOUNT
 - COLOR: GREEN
 - MOUNTING HARDWARE: UTILIZE TAMPERPROOF STAINLESS STEEL HARDWARE AS PER MANUFACTURER'S SPECIFICATIONS
 - QUANTITY: 2

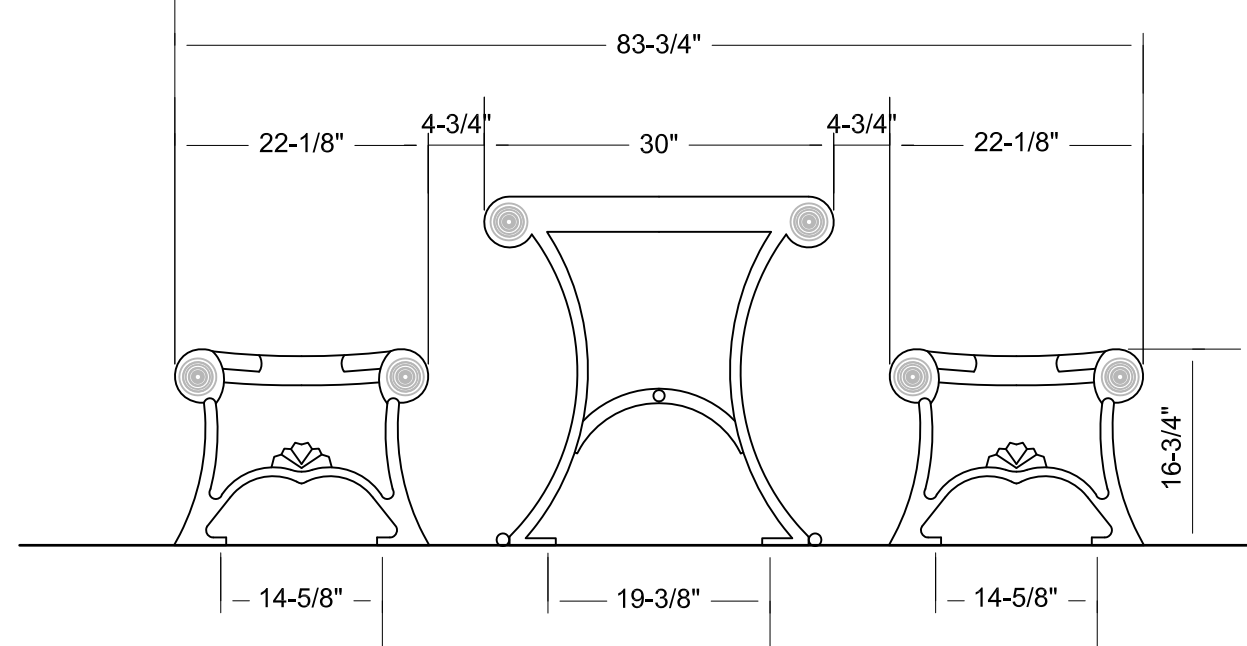
1 ADA PICNIC TABLE
N.T.S.

MOST DEPENDABLE FOUNTAINS, INC.
5705 COMMANDER DRIVE
ARLINGTON, TENNESSEE 38002
1-800-552-6331
1-901-867-0039
FAX: 1-901-867-4008
INFO@MOSTDEPENDABLE.COM
WWW.MOSTDEPENDABLE.COM




- NOTES:
- MOST DEPENDABLE FOUNTAINS, INC MODEL 10145SMFA WITH BOTTLE FILLER
 - COLOR: GREEN
 - FOUNTAIN SHALL MEET ALL LOCAL ADA REGULATIONS.
 - PROVIDE OPTIONAL STAINLESS STEEL SURFACE CARRIER.
 - INSTALLATION TO BE COMPLETED IN ACCORDANCE WITH MANUFACTURER'S SPECIFICATIONS AND WITH CITY OF NEW ORLEANS PLUMBING CODE.
 - DO NOT SCALE DRAWING.
 - THIS DRAWING IS INTENDED FOR USE BY ARCHITECTS, ENGINEERS, CONTRACTORS, CONSULTANTS AND DESIGN PROFESSIONALS FOR PLANNING PURPOSES ONLY. THIS DRAWING MAY NOT BE USED FOR CONSTRUCTION.
 - ALL INFORMATION CONTAINED HEREIN WAS CURRENT AT THE TIME OF DEVELOPMENT BUT MUST BE REVIEWED AND APPROVED BY THE PRODUCT MANUFACTURER TO BE CONSIDERED ACCURATE.
 - CONTRACTOR'S NOTE: CONTACT THE MANUFACTURER FOR INSTALLATION INSTRUCTIONS.
 - QUANTITY: 1

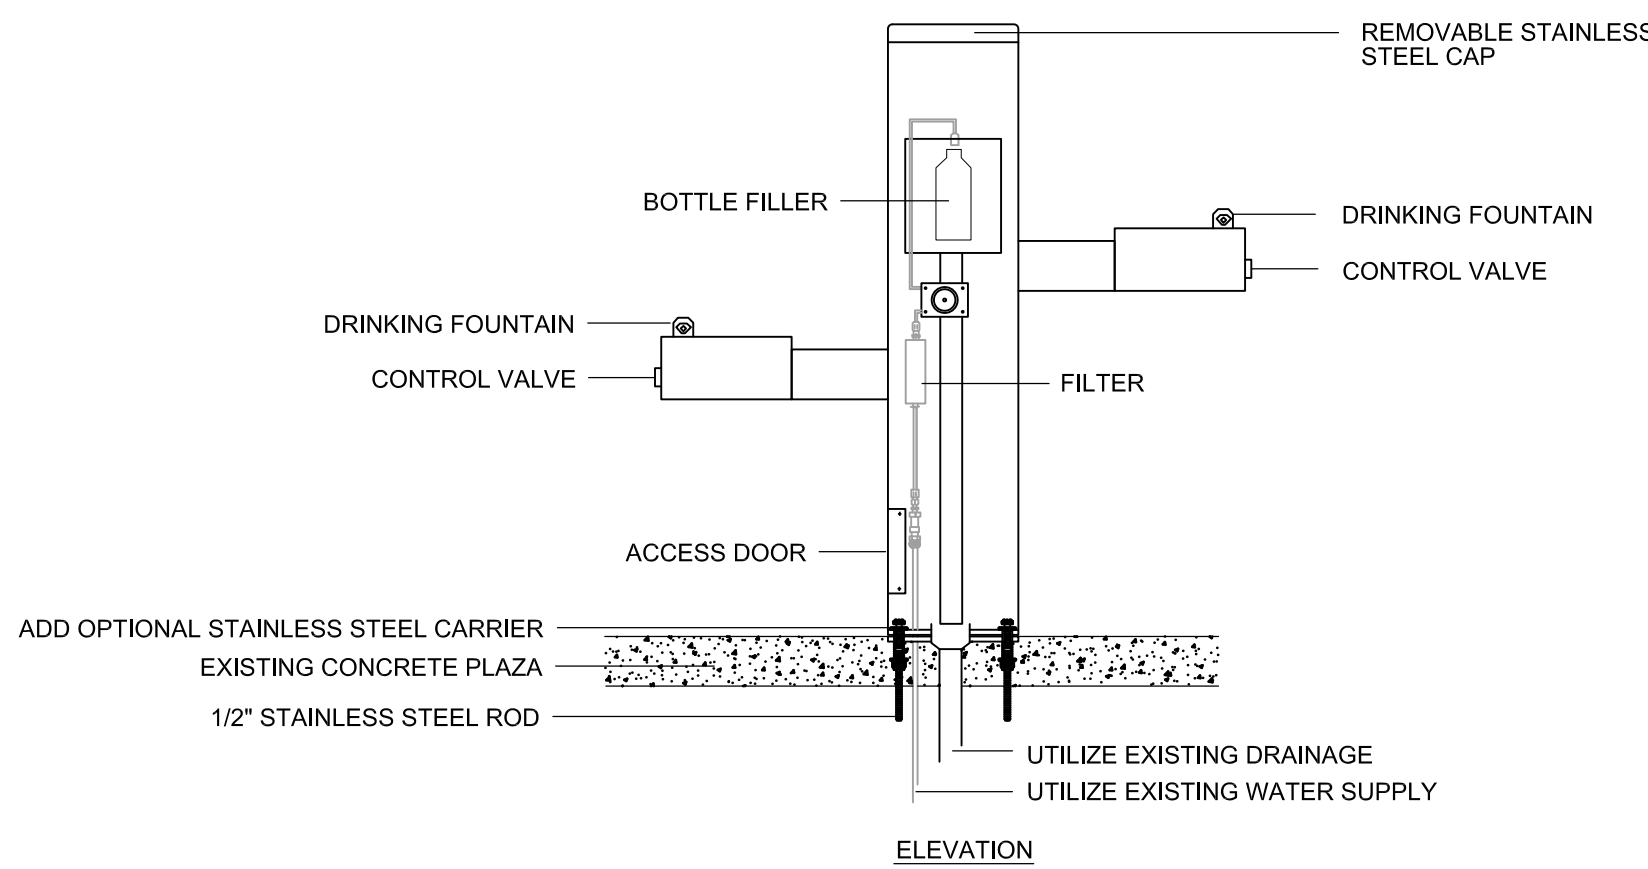2 ADA DRINKING FOUNTAIN
N.T.S.


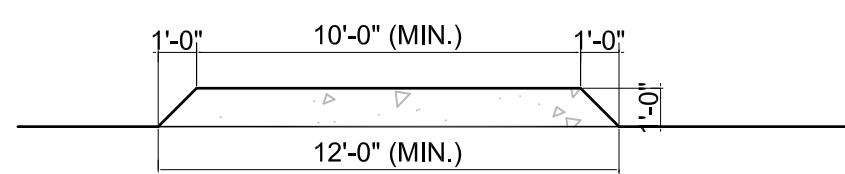


3 TYPICAL ADA BYPASS PLAN
N.T.S.

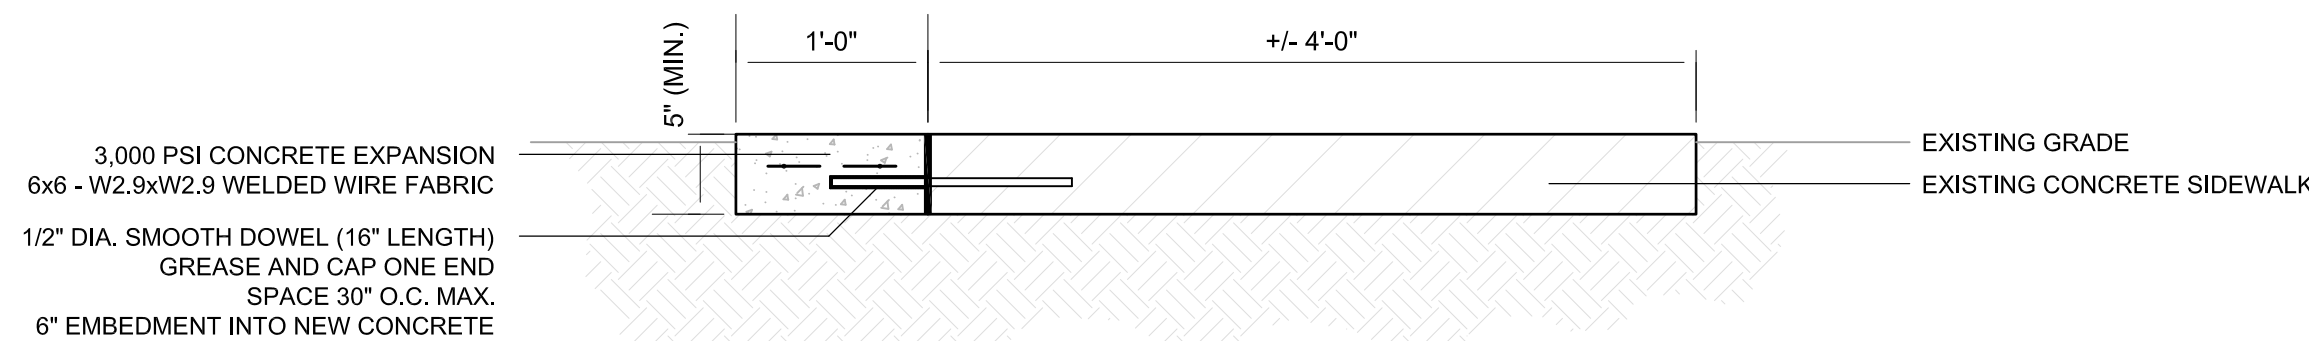


- NOTES:
- FIELD LOCATE EACH BYPASS.
 - ENSURE 5' MIN. TOTAL WIDTH FOR SIDEWALK AND BYPASS.
 - ENSURE 200 LF MAX. BETWEEN BYPASS LOCATION (OR STREET CORNER).

4 TYPICAL ADA BYPASS SECTION
N.T.S.

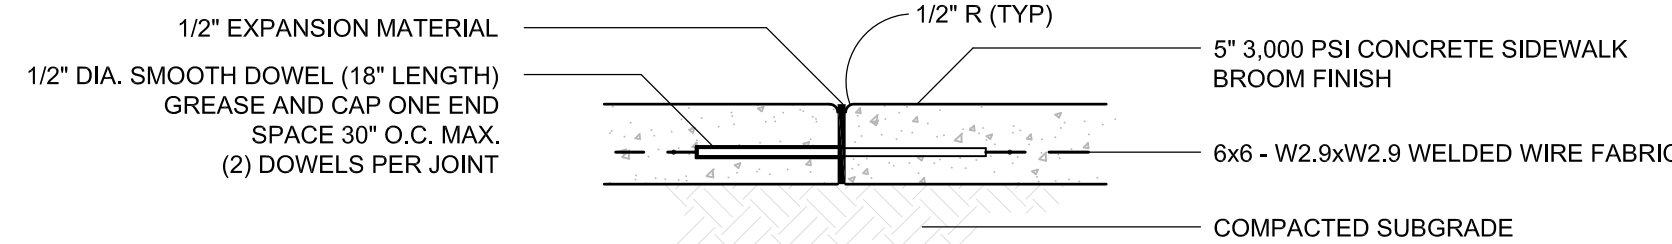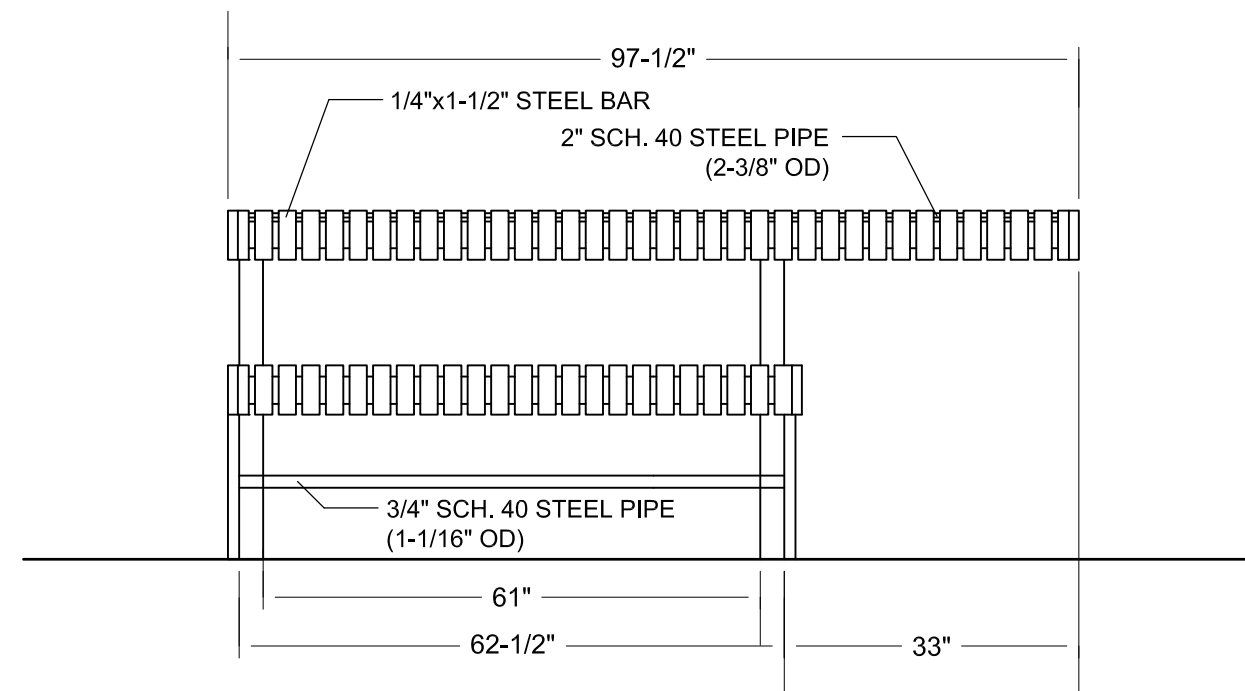

- NOTES: EVENLY SPACE EXPANSION JOINTS @ 20' O.C. MAX.
EXPANSION MATERIAL/DOWELS SHALL BE INSTALLED EVERYWHERE NEW CONCRETE MEETS EXISTING.

7 TYPICAL SIDEWALK EXPANSION JOINT
N.T.S.

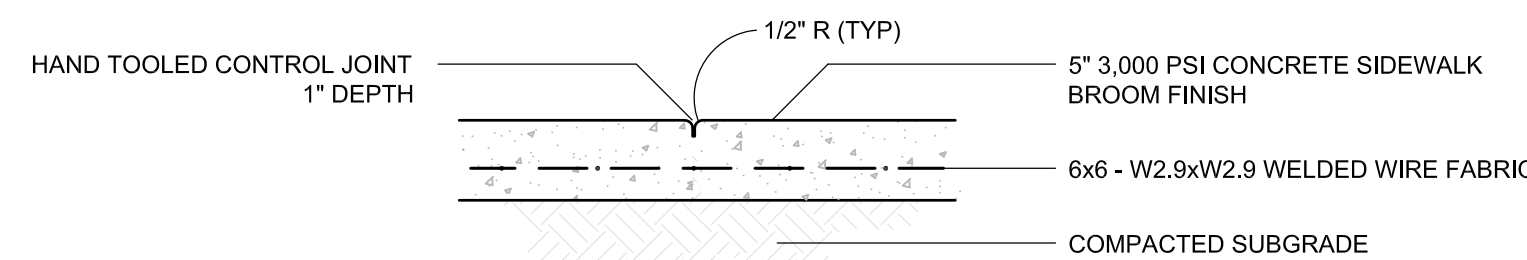


NOTE: EVENLY SPACE CONTROL @ 5' O.C. MAX.

8 TYPICAL SIDEWALK CONTROL JOINT
N.T.S.


TRUNCATED DOMES NOTES:

- TRUNCATED DOMES IN A DETECTABLE WARNING SURFACE SHALL HAVE A BASE DIA. OF 0.9" (23 mm) TO 1.4" (36 mm) MAX., A TOP DIA. OF 50% OF THE BASE DIA. MIN. TO 65% OF THE BASE DIA. MAX., AND A HEIGHT OF 0.2" (5 mm).
- TRUNCATED DOMES IN A DETECTABLE WARNING SURFACE SHALL HAVE A CENTER-TO-CENTER SPACING OF 1.6" (41 mm) MIN. AND 2.4" (61 mm) MAX., AND A BASE-TO-BASE SPACING OF 0.65" (16 mm) MIN., MEASURED BETWEEN THE MOST ADJACENT DOMES ON SQUARE GRID.
- TRUNCATED DOMES SURFACES SHALL CONTRAST VISUALLY WITH ADJACENT WALKING SURFACES EITHER LIGHT-ON-DARK, OR DARK-ON-LIGHT.
- THE MATERIAL USED TO PROVIDE CONTRAST SHALL BE AN INTEGRAL PART OF THE WALKING SURFACE. DETECTABLE WARNINGS USED ON INTERIOR SURFACES SHALL DIFFER FROM ADJOINING WALKING SURFACES IN RESILIENCY OR SOUND-ON-CANE CONTACT.
- TRUNCATED DOMES ON CURB RAMPS WITHIN THE STREET R.O.W. SHALL BE PREFABRICATED DETECTABLE WARNING UNITS INSTALLED DIRECTLY IN NEWLY POURED CONCRETE.
- TRUNCATED DOMES SHALL COVER AT LEAST 2' IN DEPTH AND EXTEND FULL WIDTH OF THE RAMP. ANY RAMP HAVING FLARED SIDES WILL NOT BE REQUIRED TO HAVE THESE DETECTABLE WARNINGS ON THE FLARES.
- THE LIMITS OF THE MAIN SURFACE OF THE RAMP ON WHICH THE DETECTABLE WARNINGS ARE PLACED SHALL HAVE A REDDISH COLOR SIMILAR TO THAT OF 'BRICK RED'. THE COLOR MUST BE APPROVED BY THE OWNER.
- STAMPING OF TRUNCATED DOMES WITHIN THE R.O.W. WILL NOT BE ALLOWED.

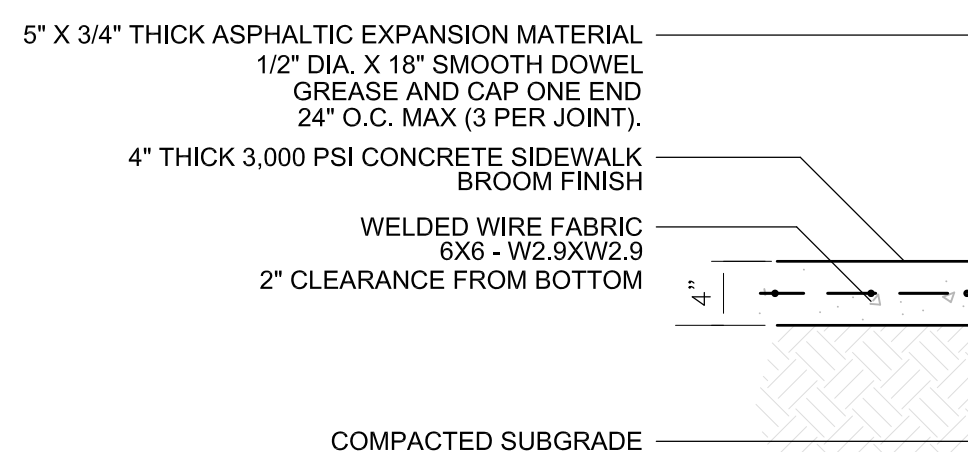


- SIDEWALK NOTES:
CONTROL JOINTS: 5' O.C. MAX.
EXPANSION JOINTS: 20' O.C. MAX. (3 GREASED DOWELS PER JOINT)


10 ADA RAMP (SECTION)
N.T.S.

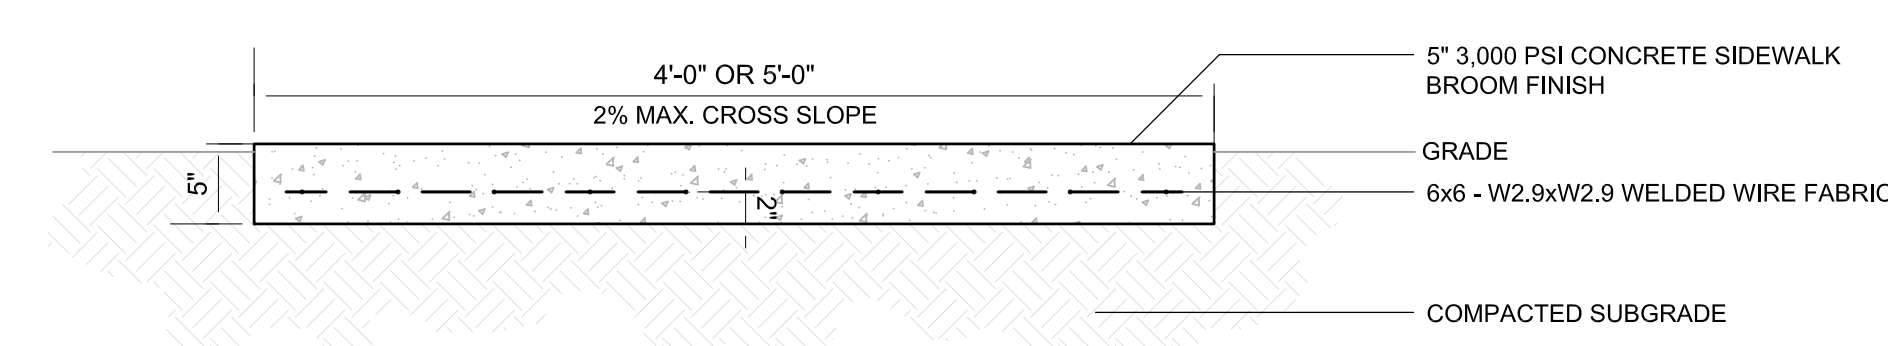



5 TYPICAL SIDEWALK SECTION
N.T.S.

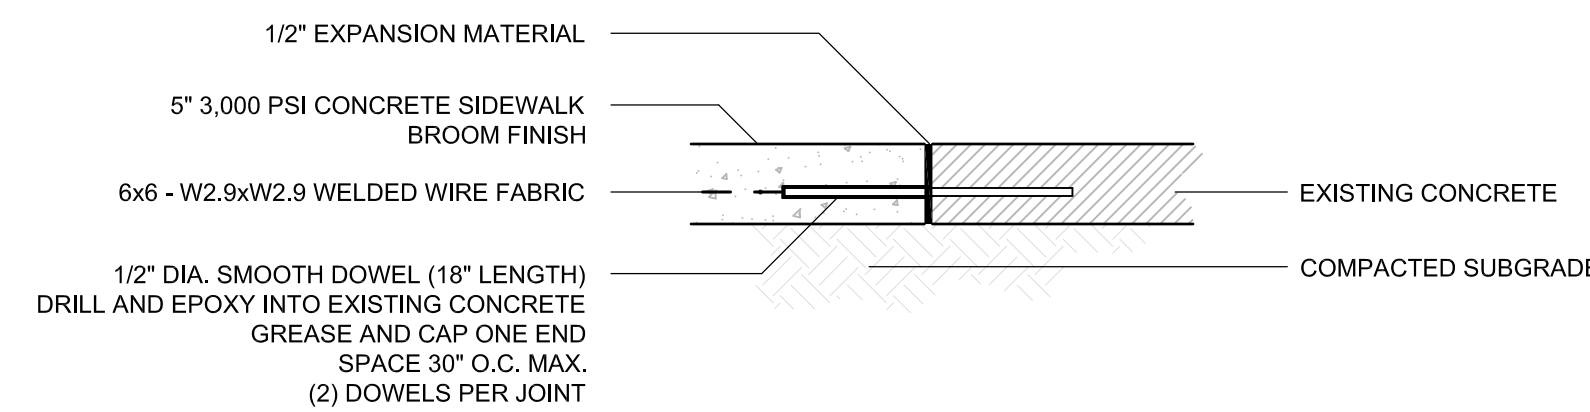


6 TYPICAL SIDEWALK TIE IN DETAIL
N.T.S.

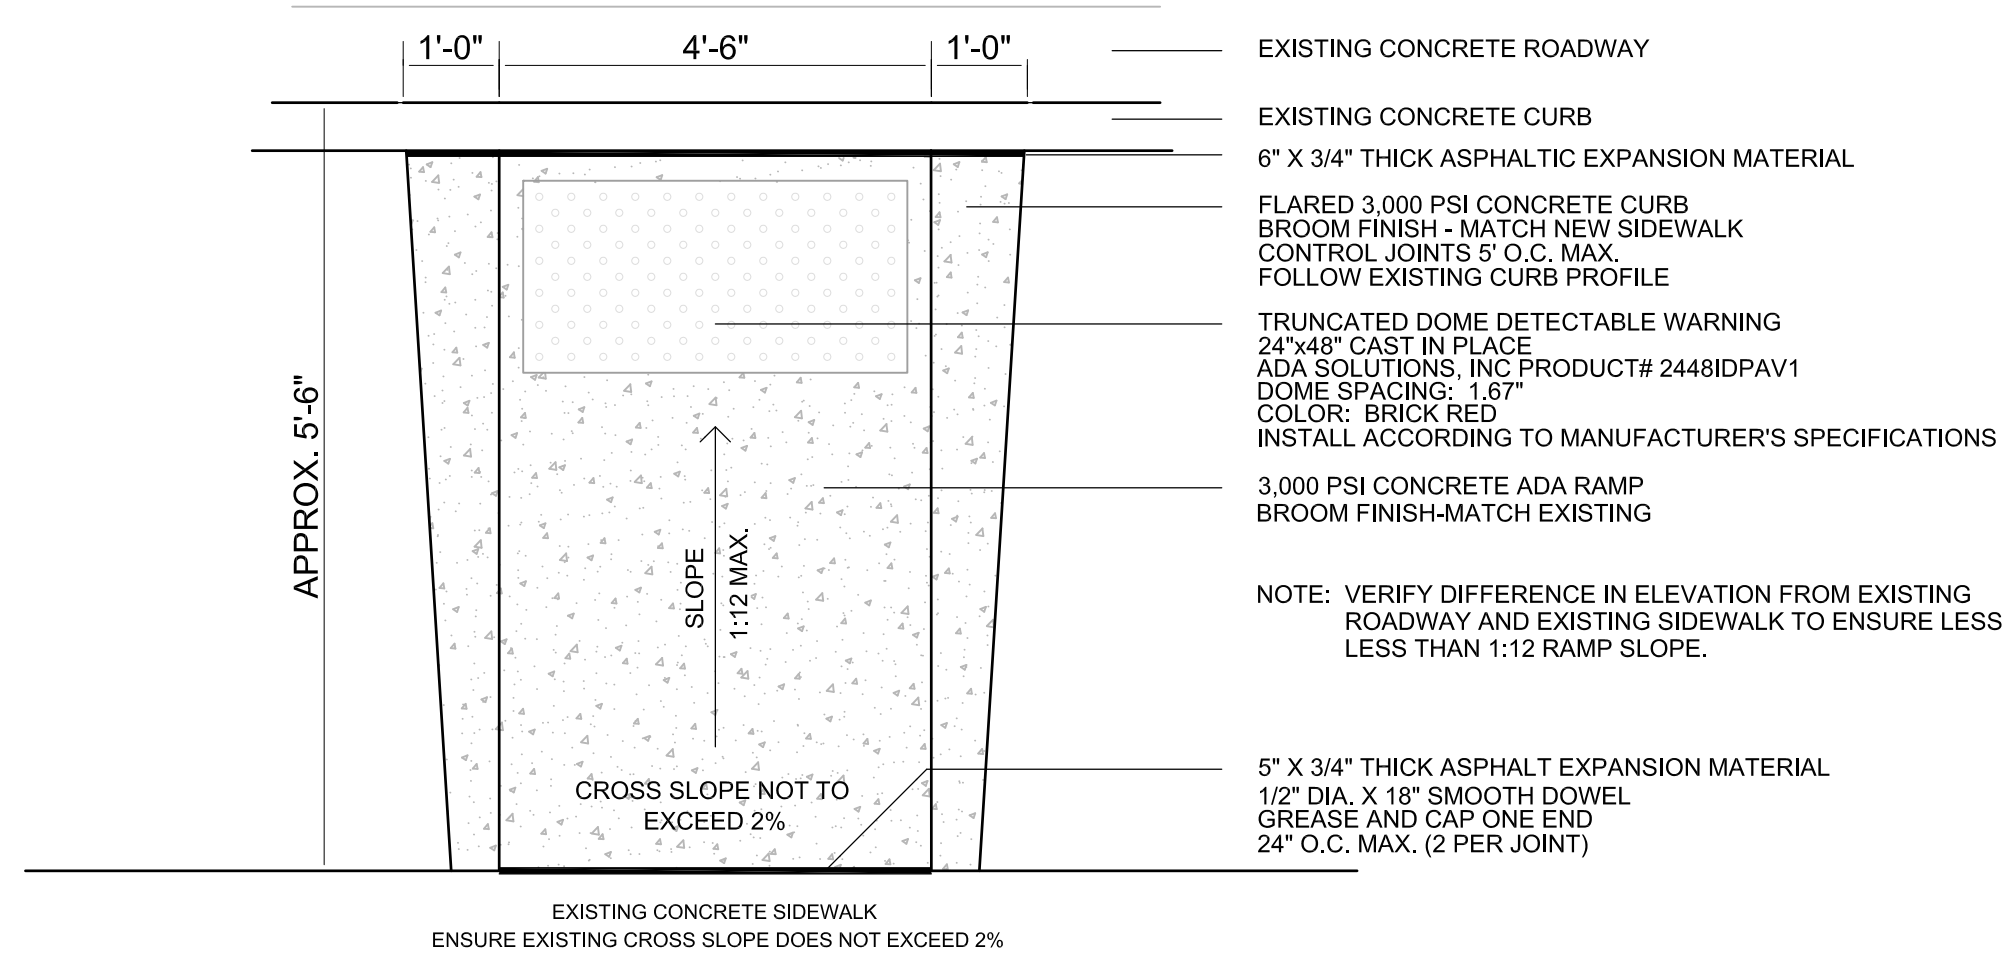

9 ADA RAMP (PLAN)
N.T.S.

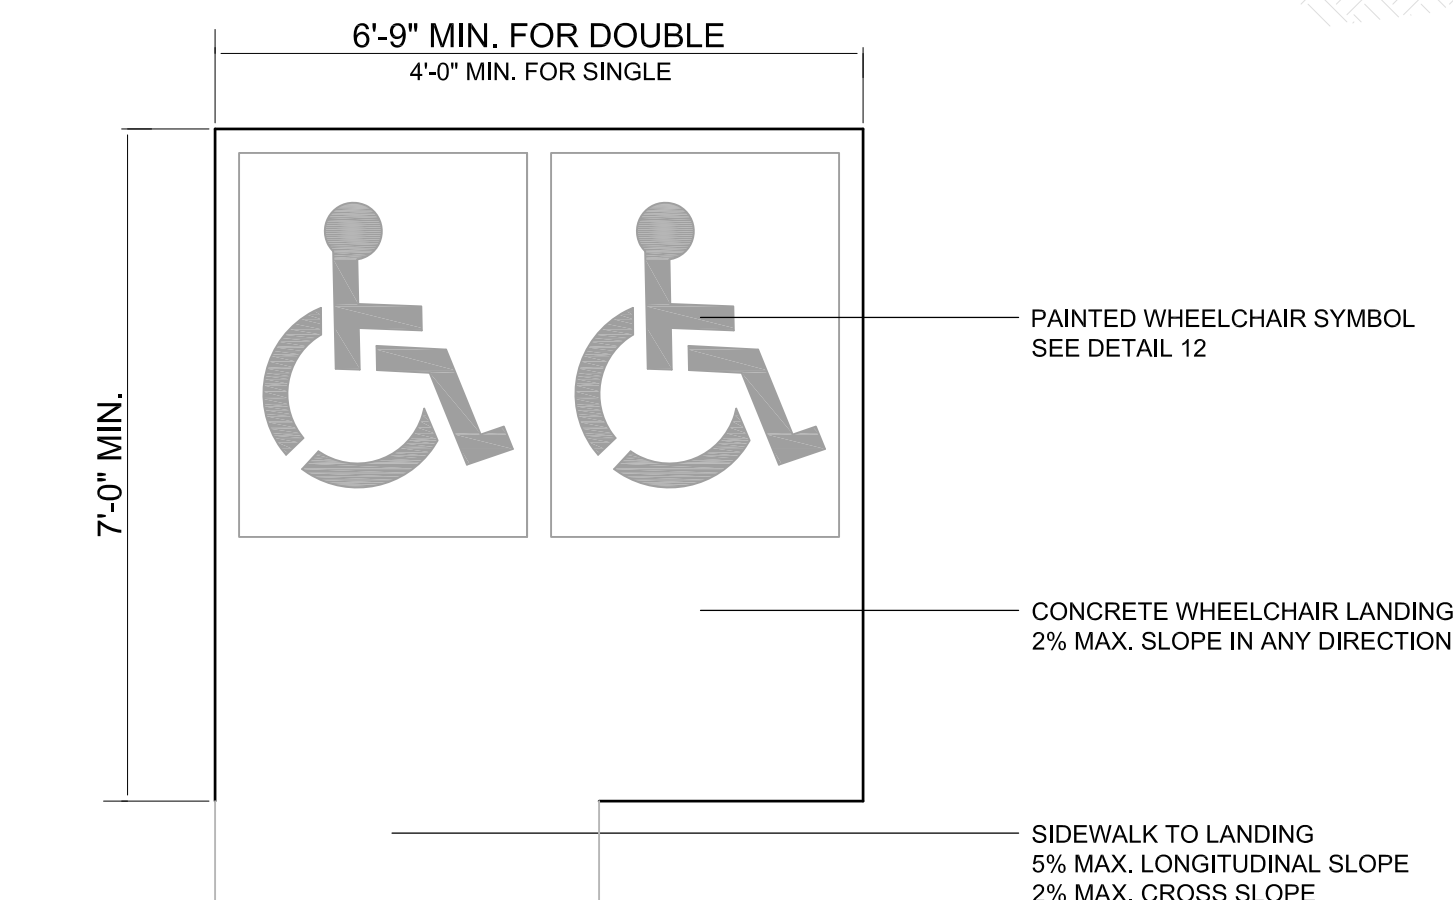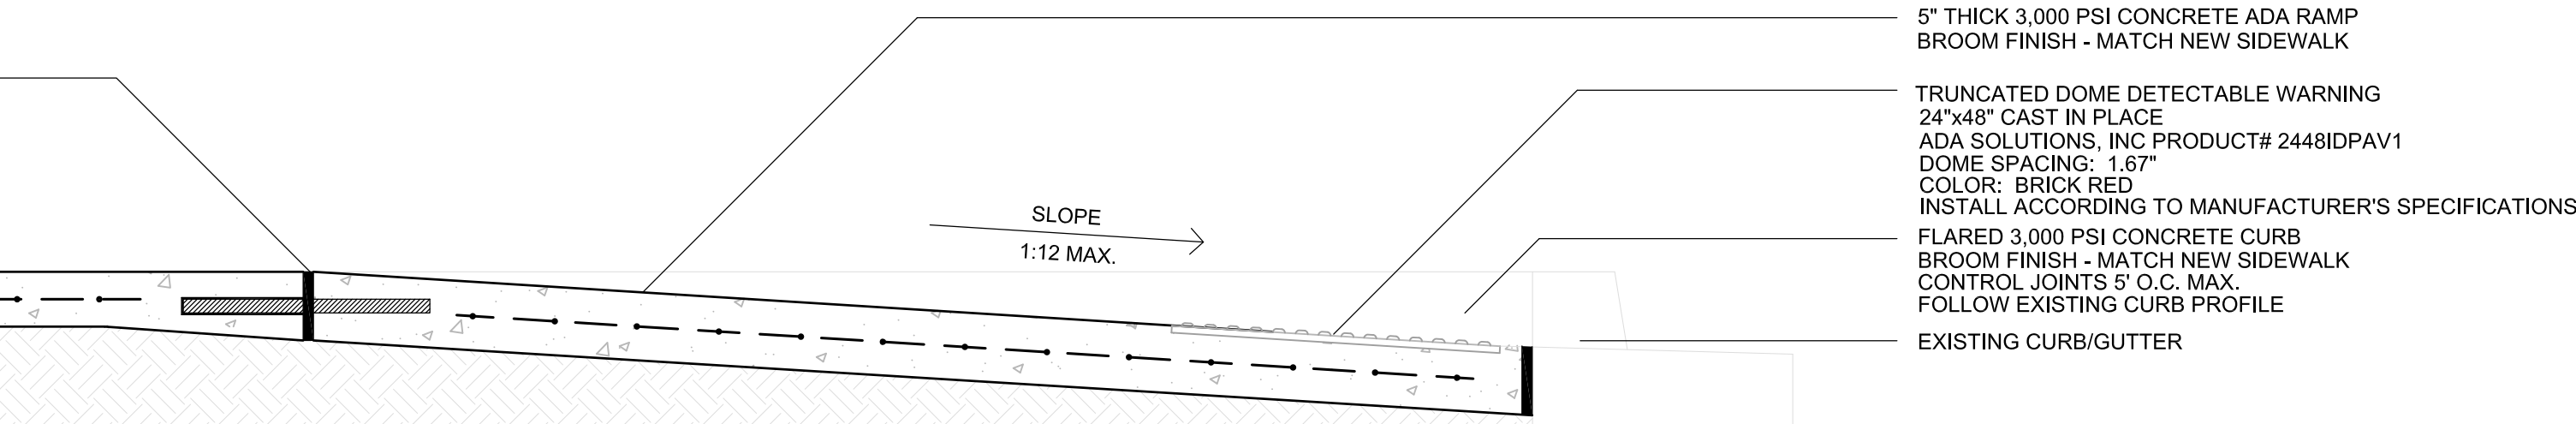


11 WHEELCHAIR LANDING DETAIL
1/2" = 1'-0"

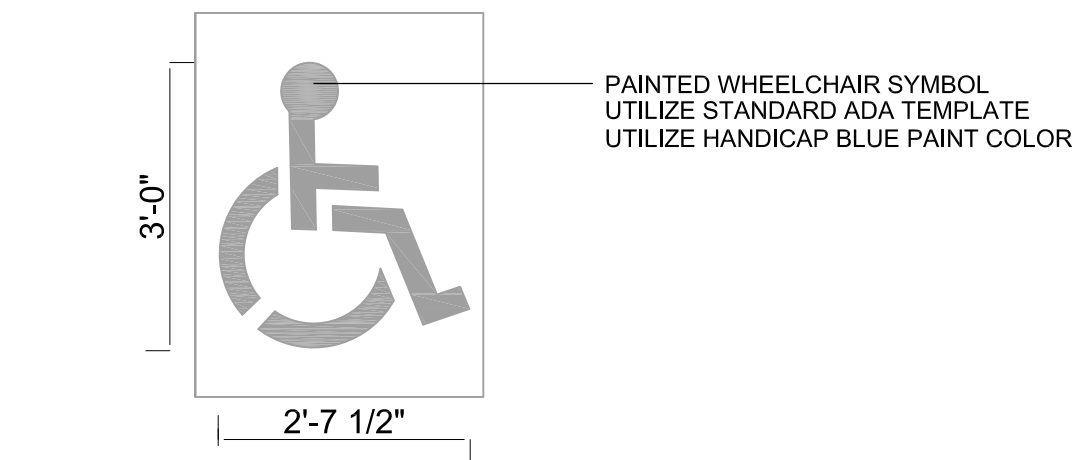

12 WHEELCHAIR SYMBOL
1/2" = 1'-0"

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PROFESSIONAL ENGINEERS, ARCHITECTS
AND SURVEYORS
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Metairie, Louisiana 70002

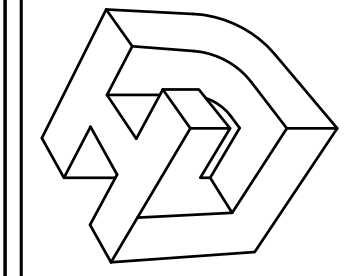

REV. NO.	DATE

**KENILWORTH PLAYGROUND
NEW ORLEANS, LOUISIANA**


THIS SHEET
HARDSCAPE DETAILS

DRAWN BY: LHJ
CHECKED BY: LHJ
APPROVED BY: LHJ


PROJ. NO. 15-190
DATE 03-29-2017
SHEET NO.
5
OF 17 SHEETS

BASKETBALL BACKBOARD/GOAL/NET NOTES:

1. REMOVE ALL EXISTING BACKBOARDS, GOALS AND NETS AND DISPOSE OF OFF SITE. ALL POLES WILL BE USED FOR MOUNTING OF NEW BASKETBALL EQUIPMENT.
2. INSTALL TWO (2) NEW BASKETBALL BACKBOARDS/GOALS/NETS ON THE REDFISH STREET SIDE OF THE COURT (ON THE EXISTING BRACKETS). INSTALL DRAPER, INC. PART NUMBER: 503148 (OR APPROVED EQUAL). SEE DETAILS 3 & 4
3. INSTALL TWO (2) NEW BASKETBALL BACKBOARDS/GOALS/NETS ON THE WALES STREET AND CURRAM BOULEVARD ENDS OF THE COURT (ON THE EXISTING RETRACTABLE BRACKETS). INSTALL DRAPER, INC. PART NUMBER: 503167 (OR APPROVED EQUAL). SEE DETAILS 2 & 4

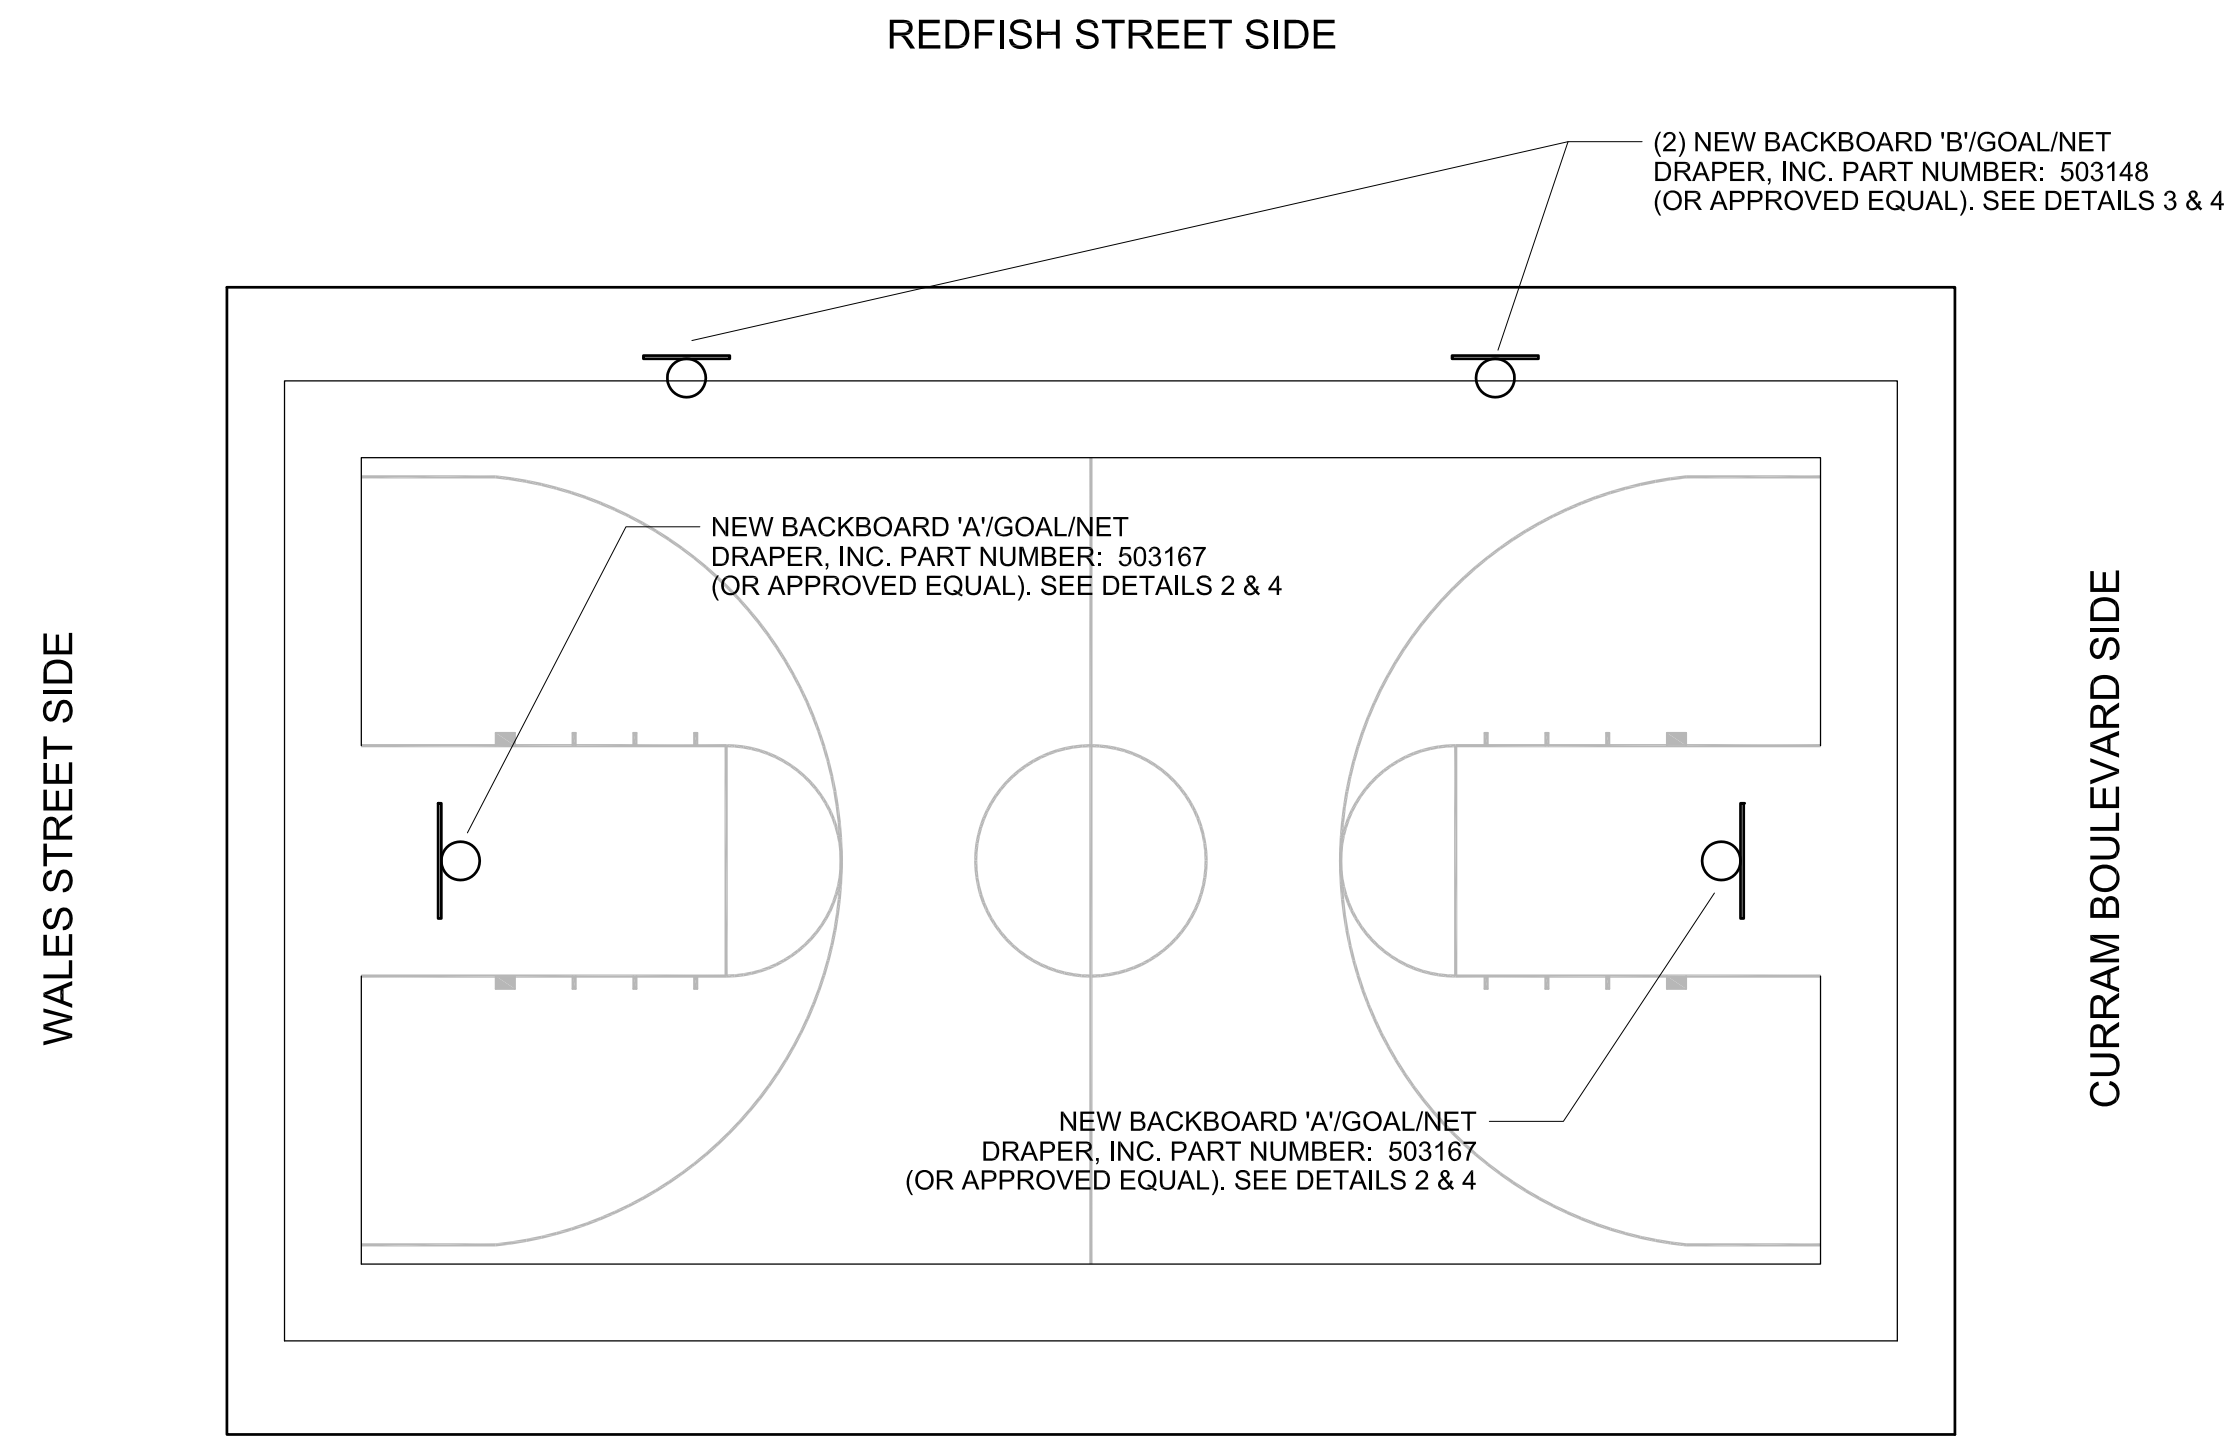

1 BASKETBALL COURT TILE PLAN (ALTERNATE #1)
1" = 10'-0"

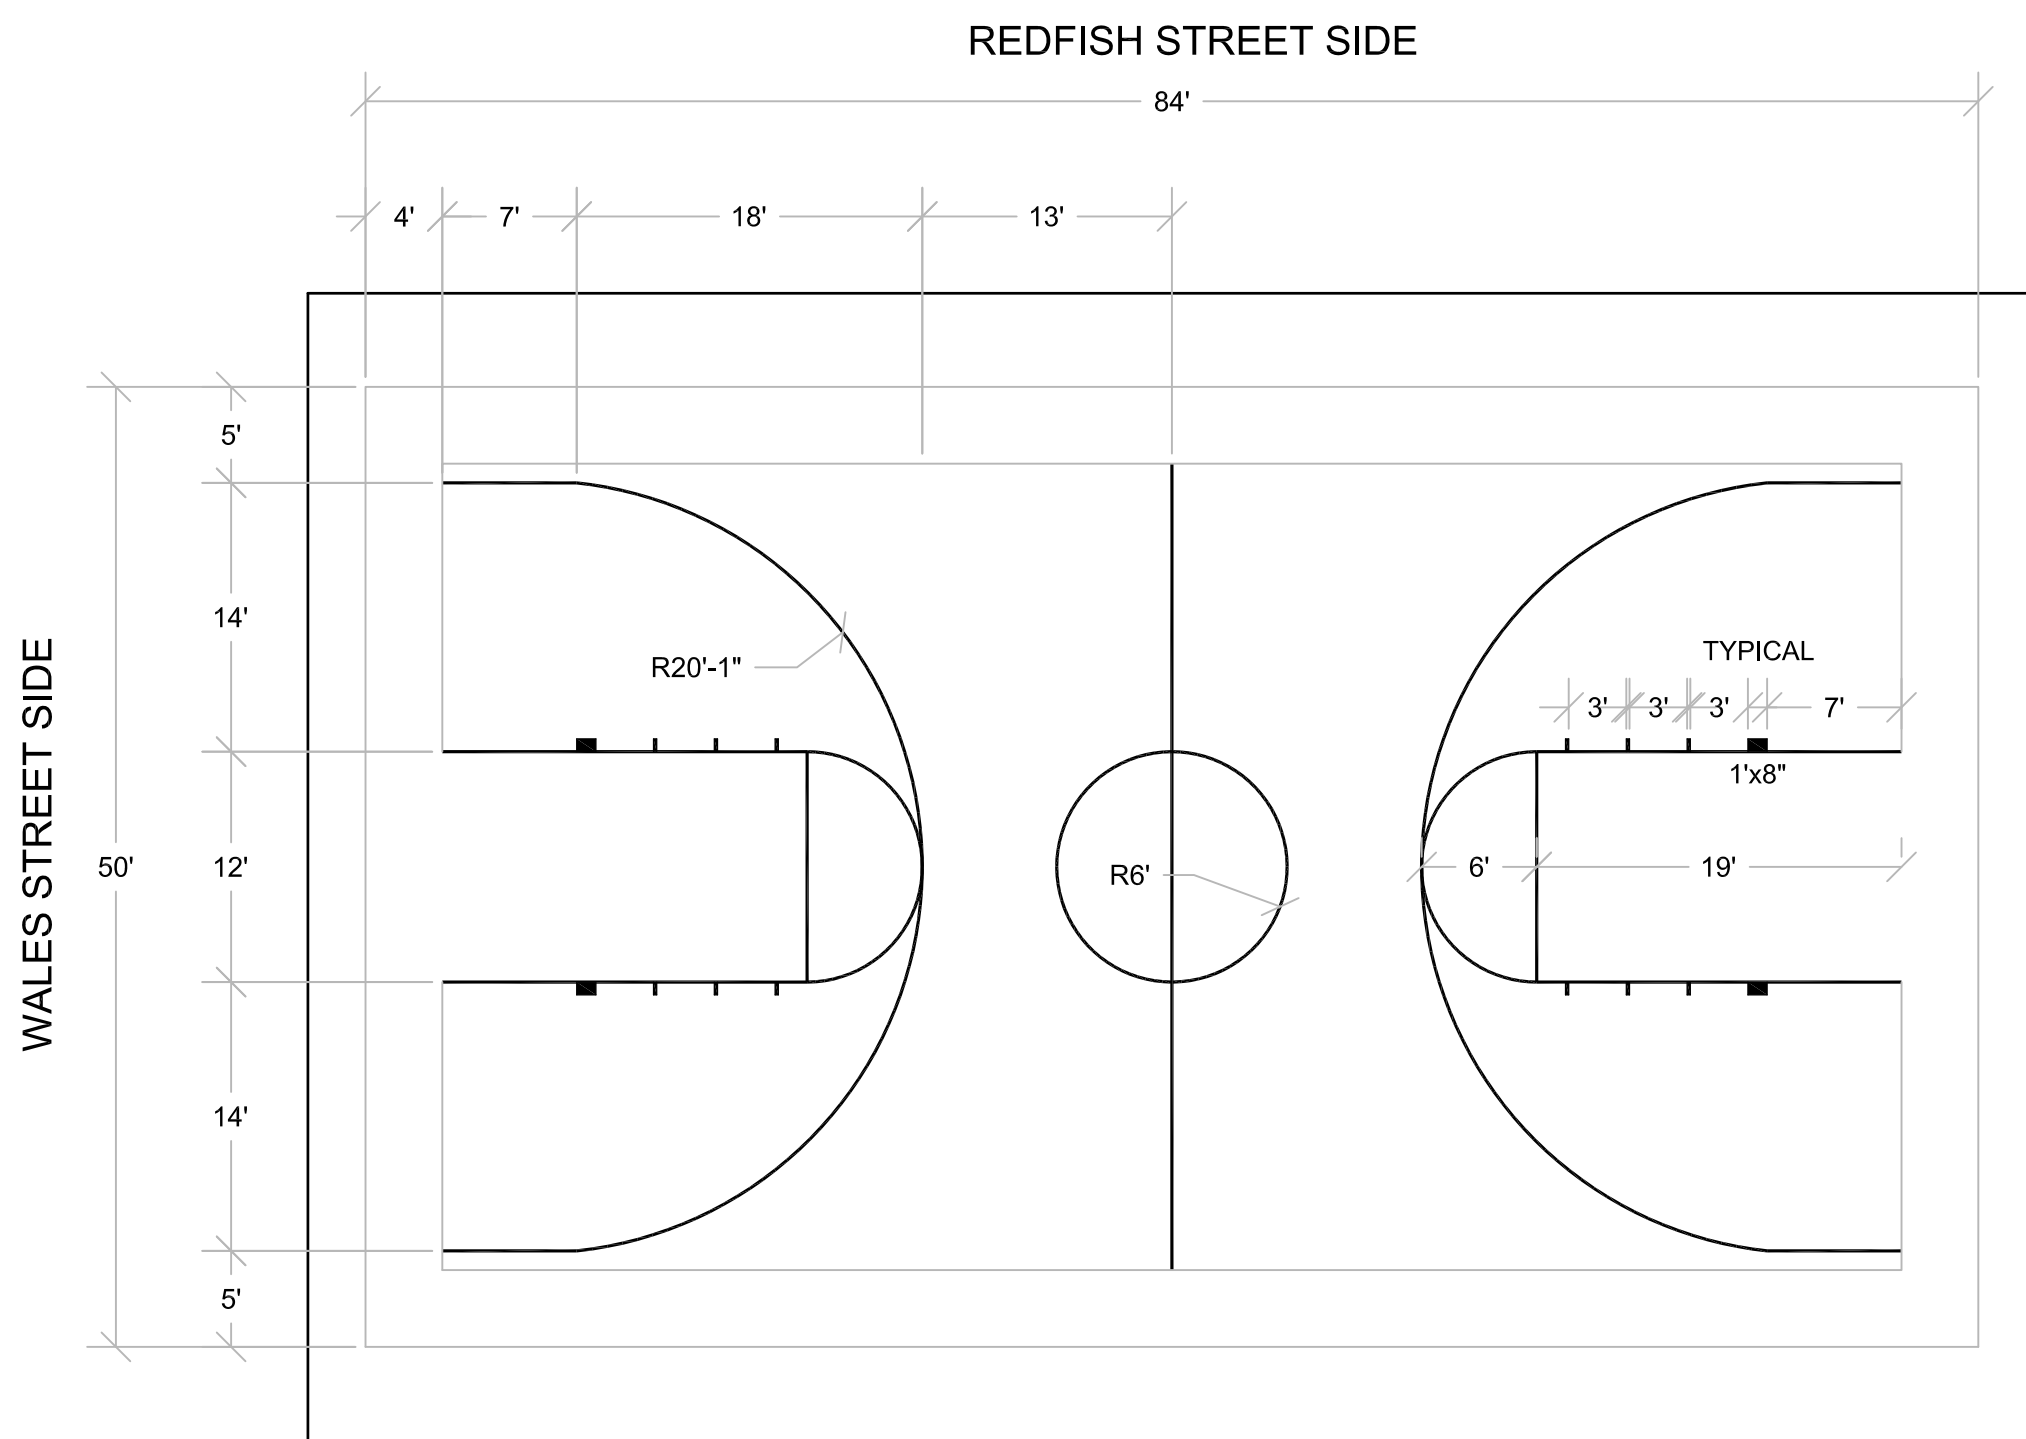


COURT STRIPING NOTES:

1. PRESSURE WASH EXISTING COURT. FILL ALL CRACKS WITH SELF LEVELING SEALANT.
2. PRIME ALL COURT LINES WITH A CONCRETE PRIMER INTENDED FOR COURT STRIPING.
3. AFTER PRIMING, PAINT COURT LINES WITH A CONCRETE PAINT INTENDED FOR COURT STRIPING.
4. ALL STRIPING SHALL BE WHITE IN COLOR.
5. ALL STRIPES SHALL BE 2" WIDTH (NEUTRAL ZONES EXCLUDED).


2 BASKETBALL STRIPING PLAN (ALTERNATE #1)
1" = 10'-0"

MANUFACTURER:
DRAPER, INC.
411 S. PEARL STREET
SPICELAND, INDIANA 47385
765-987-7999
(OR APPROVED EQUAL)

LOCAL DISTRIBUTOR:
HAHN ENTERPRISES, INC.
3702 BIENVILLE STREET
NEW ORLEANS, LOUISIANA 70119
504-488-3536

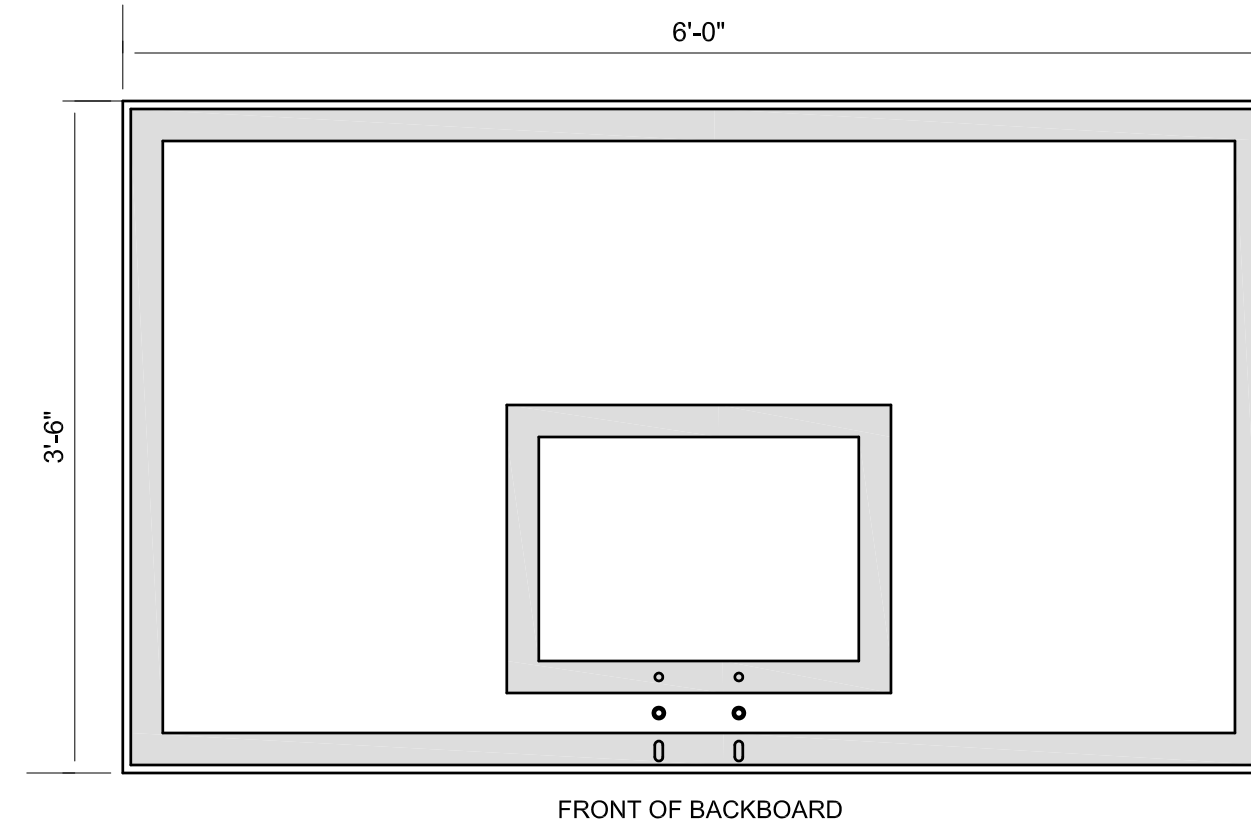


BACKBOARD 'A'
REPLACEMENT BASKETBALL BACKBOARD (WALES ST AND CURRAM BLVD SIDES):
MANUFACTURER: DRAPER, INC.
PART NUMBER: 503167
SIZE: 72"x42"
MATERIAL: 12 GAUGE STEEL WITH BORDER AND TARGET
FINISHING: GLOSS WHITE POWDERCOAT FINISH WITH ORANGE SILK-SCREENED PERIMETER AND TARGET AREA
QUANTITY: 2
ADDITIONAL: ADD (2) GOALS/NETS. SEE DETAIL 4
NOTE: INSTALL IN ACCORDANCE WITH THE MANUFACTURER'S SPECIFICATIONS

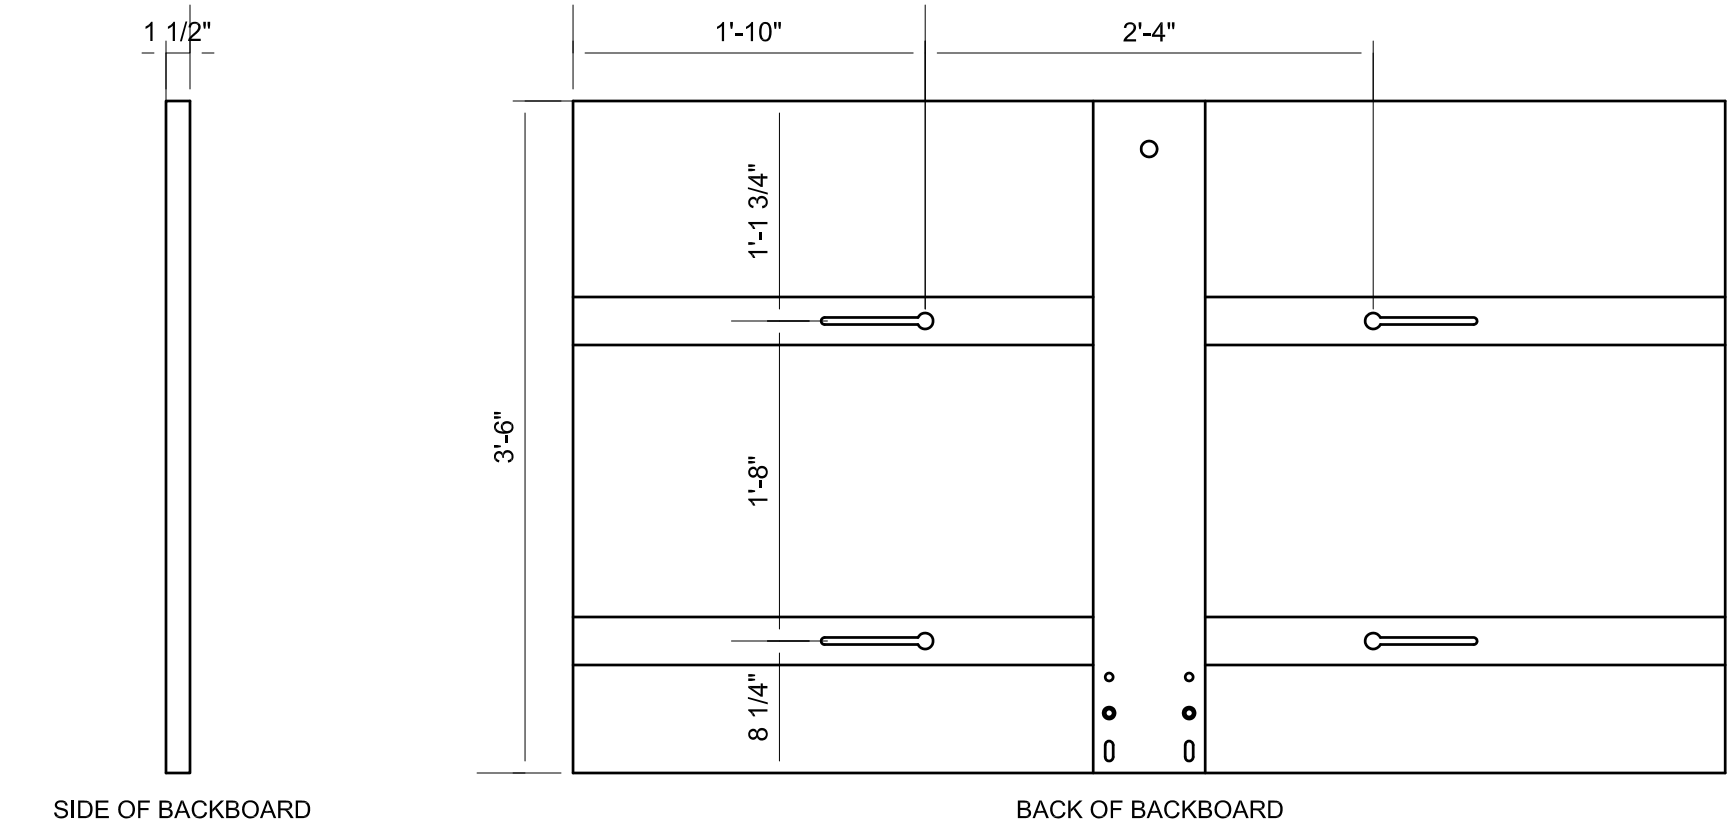


3 BASKETBALL BACKBOARD 'A' (ALTERNATE #1)
1" = 1'-0"

MANUFACTURER:
DRAPER, INC.
411 S. PEARL STREET
SPICELAND, INDIANA 47385
765-987-7999
(OR APPROVED EQUAL)

LOCAL DISTRIBUTOR:
HAHN ENTERPRISES, INC.
3702 BIENVILLE STREET
NEW ORLEANS, LOUISIANA 70119
504-488-3536




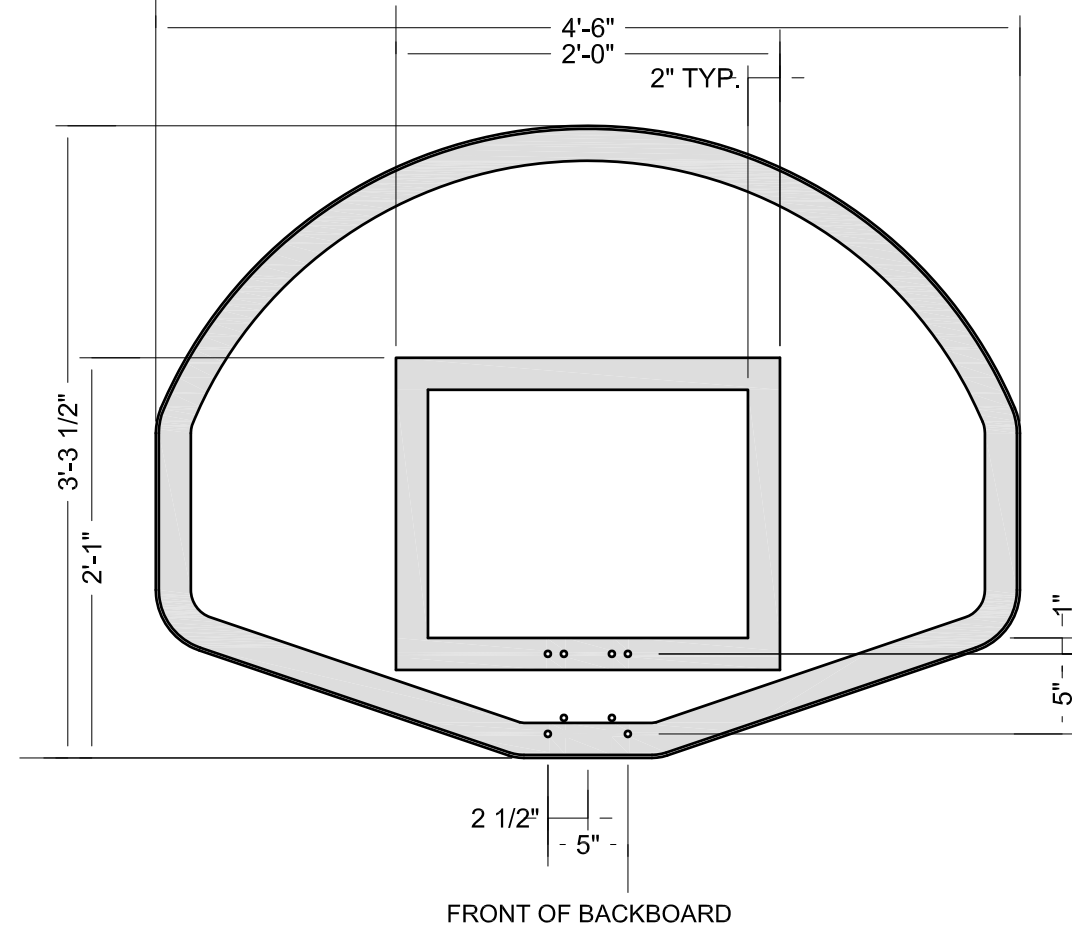


BACKBOARD 'B'
REPLACEMENT BASKETBALL BACKBOARD (REDFISH ST SIDE):
MANUFACTURER: DRAPER, INC.
PART NUMBER: 503148
SIZE: 54"x39"
MATERIAL: HIGH STRENGTH FIBERGLASS
FINISHING: GLOSS WHITE POWDERCOAT FINISH WITH ORANGE SILK-SCREENED PERIMETER AND TARGET AREA
QUANTITY: 2
ADDITIONAL: ADD (2) GOALS/NETS. SEE DETAIL 4
NOTE: INSTALL IN ACCORDANCE WITH THE MANUFACTURER'S SPECIFICATIONS

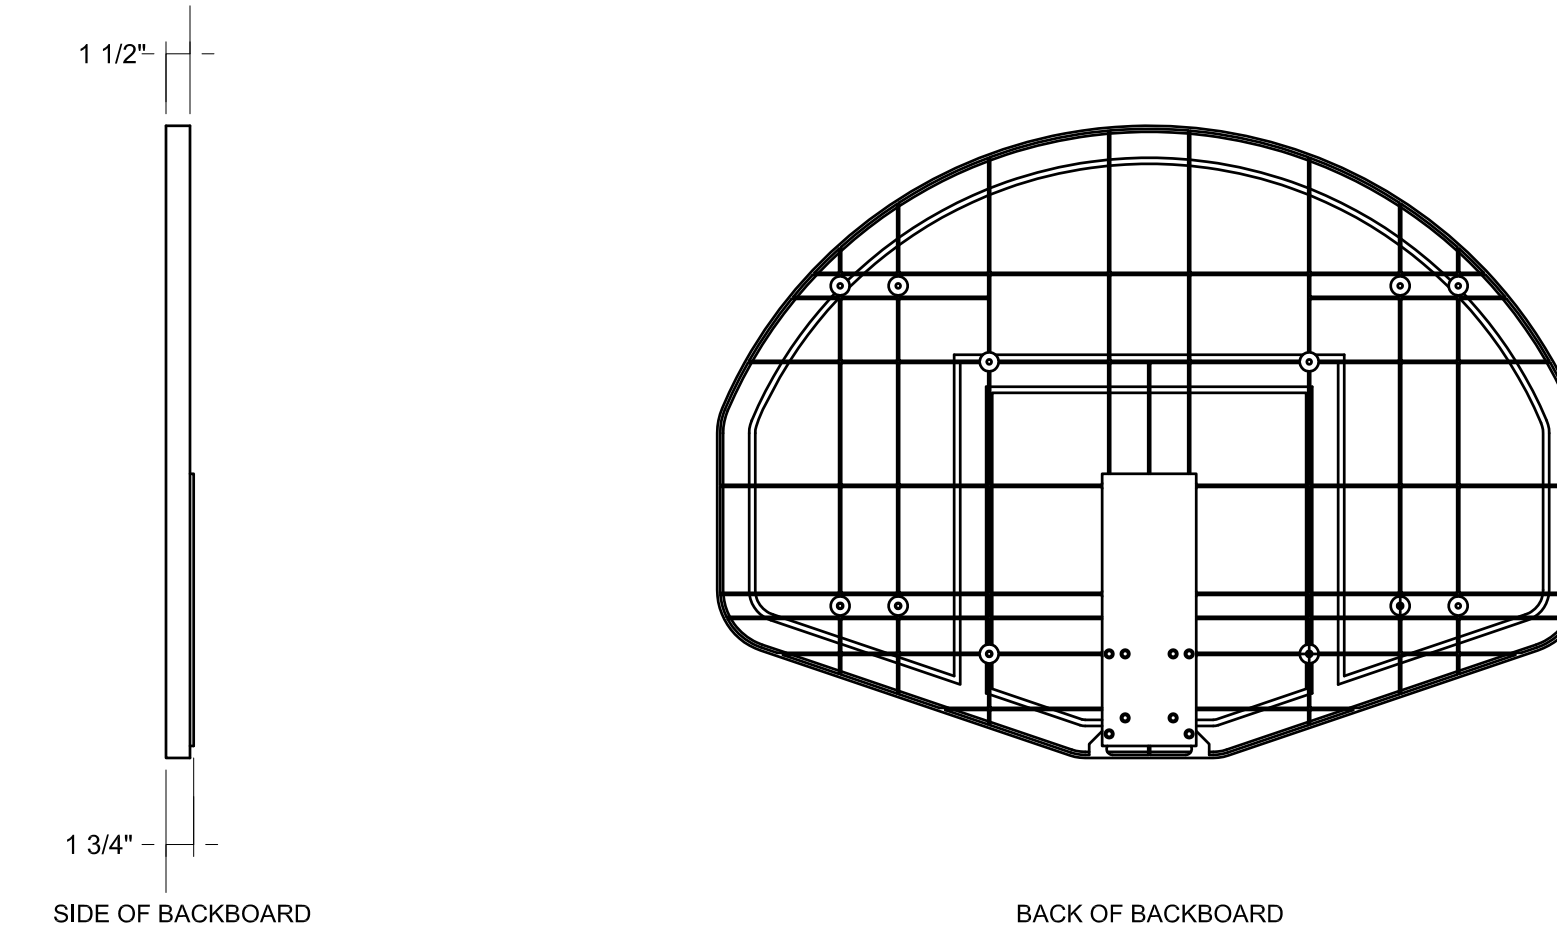


4 BASKETBALL BACKBOARD 'B' (ALTERNATE #1)
1" = 1'-0"

REPLACEMENT BASKETBALL GOAL:
MANUFACTURER: DRAPER, INC.
PART NUMBER: 503079
DEFLECTION: 15 DEG. DOWNWARD DEFLECTION
DESCRIPTION: OUTDOOR BREAKAWAY GOAL
NET: INSTALL HEAVY-DUTY NYLON NET
QUANTITY: 4
NOTE: INSTALL IN ACCORDANCE WITH THE MANUFACTURER'S SPECIFICATIONS

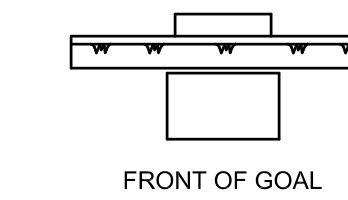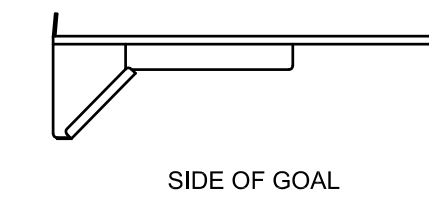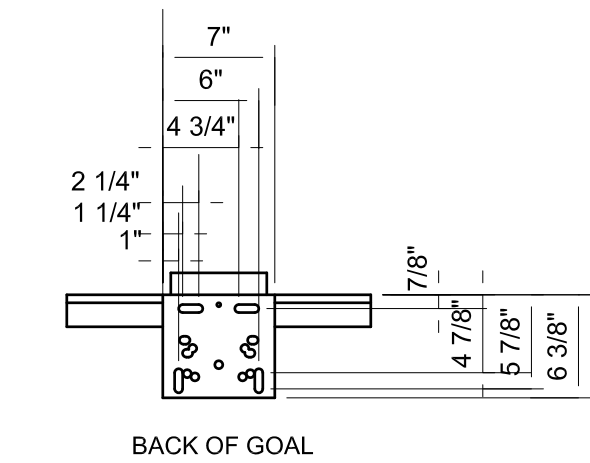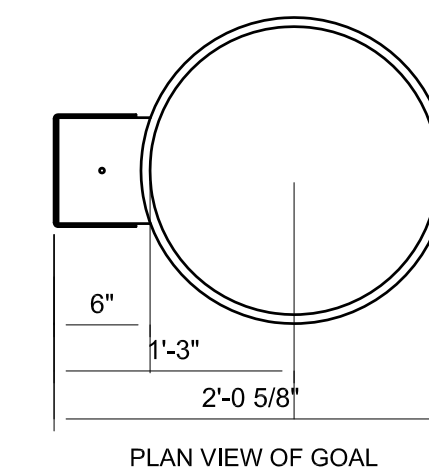

5 BASKETBALL GOAL (ALTERNATE #1)
1" = 1'-0"

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Metairie, Louisiana 70002

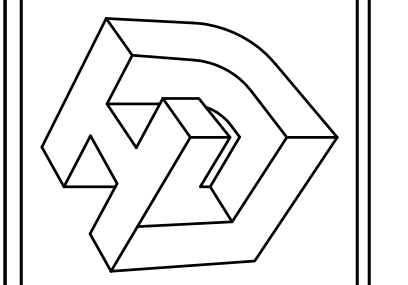


REV. NO.	DATE

KENILWORTH PLAYGROUND
NEW ORLEANS, LOUISIANA
BASKETBALL COURT DETAILS (ALT # 1)
DRAWN BY: LHJ
CHECKED BY: LHJ
APPROVED BY: LHJ

PROJ. NO. 15-190
DATE 03-29-2017
SHEET NO.

6


BEACON ATHLETICS
 8233 FORSYTHIA STREET
 SUITE 120
 MIDDLETON, WISCONSIN 53562
 1-800-747-5985
 FAX: 1-608-836-0724
 WWW.BEACONATHLETICS.COM

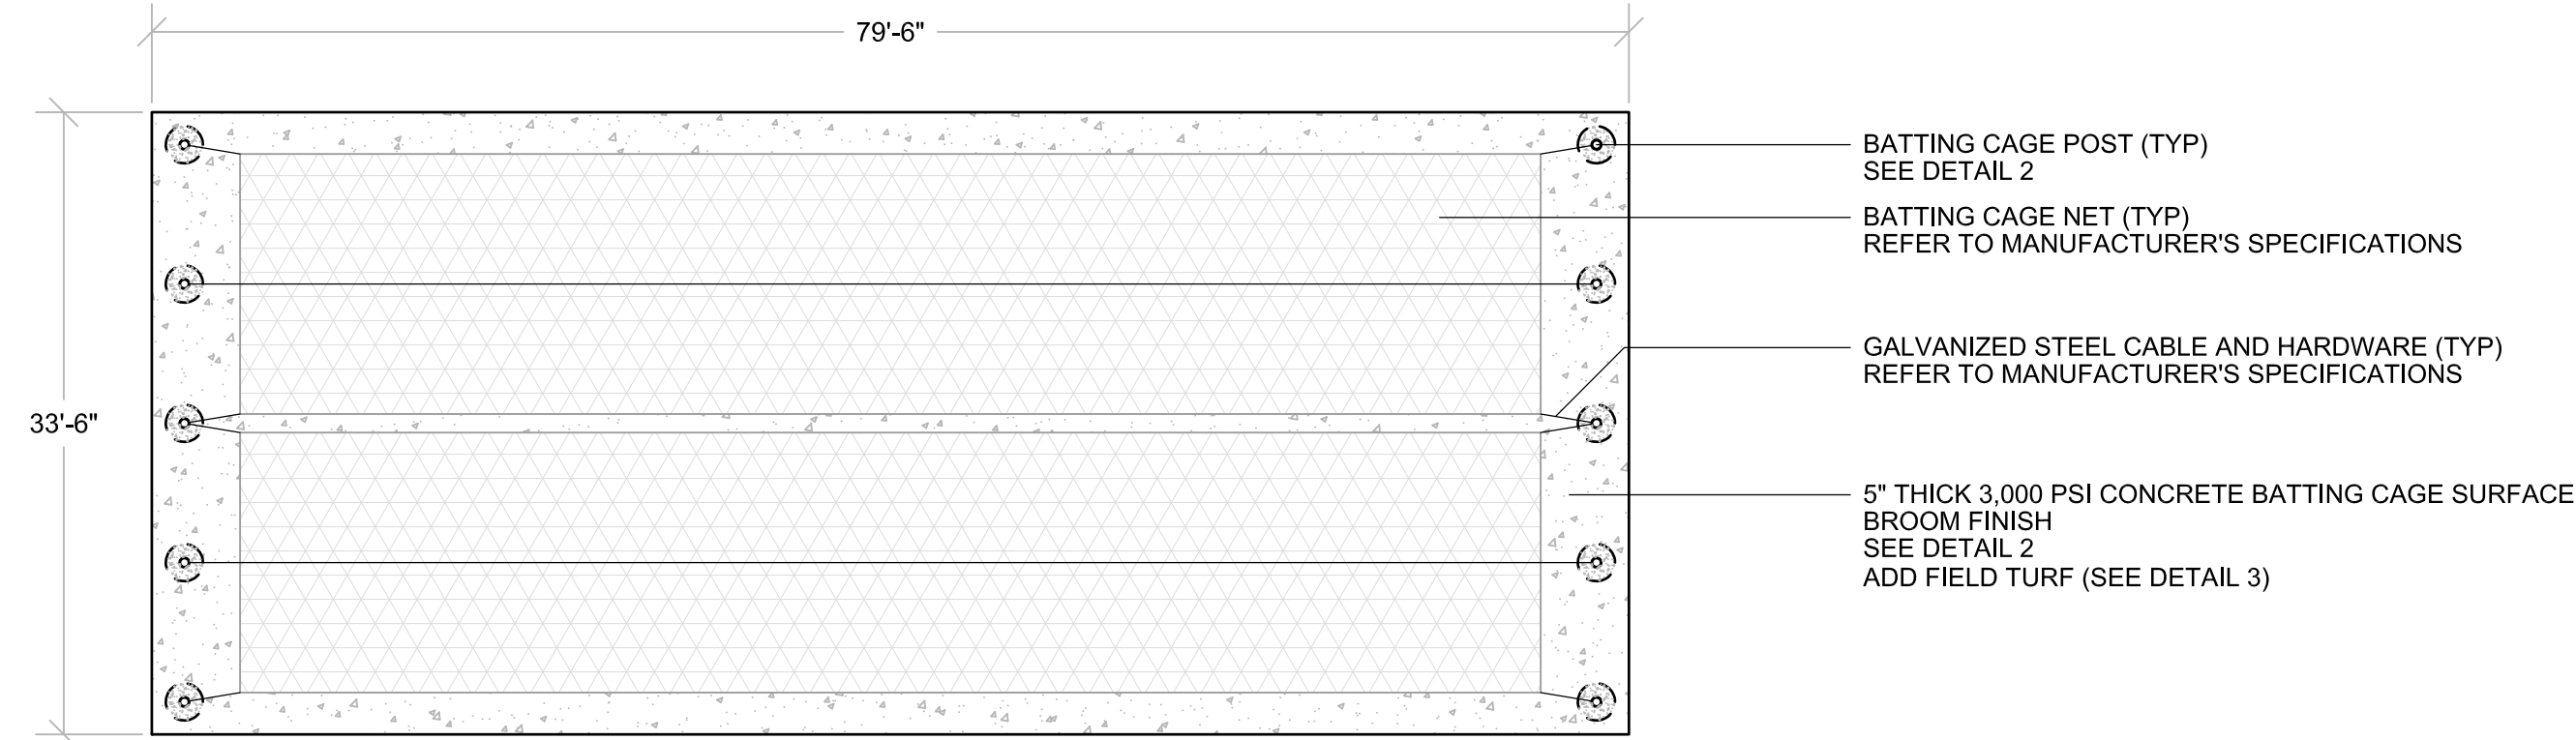

NOTES:
 INSTALL EXPANSION JOINT (EAST/WEST) AT CENTER OF THE BATTING CAGE FOUNDATION
 INSTALL EXPANSION JOINTS (NORTH/SOUTH) AT 20' O.C. MAX.

1 BATTING CAGE PLAN
 1" = 10'-0"


ON DECK SPORTS
 150 WOOD ROAD
 SUITE 200
 BRAintree, MA 02184
 1-800-365-6171
 INFO@ONDECKSPORTS.COM

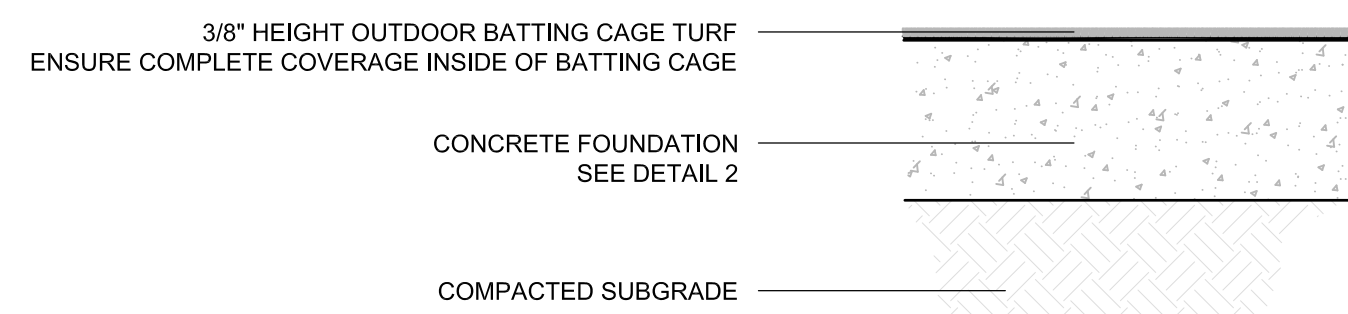

MANUFACTURER: ON DECK SPORTS
 PRODUCT: BCT ARTIFICIAL TURF
 ITEM NO.: NTOV1BCT
 COLOR: SOLID GREEN
 FACE WEIGHT: 18 OZ
 YARN TYPE: MONO
 HEIGHT: 3/8"
 DRAINABLE
 BACKING: LATEX
 15' WIDE

INSTALL IN ACCORDANCE WITH THE MANUFACTURER'S SPECIFICATIONS


3 BATTING CAGE TURF
 N.T.S.

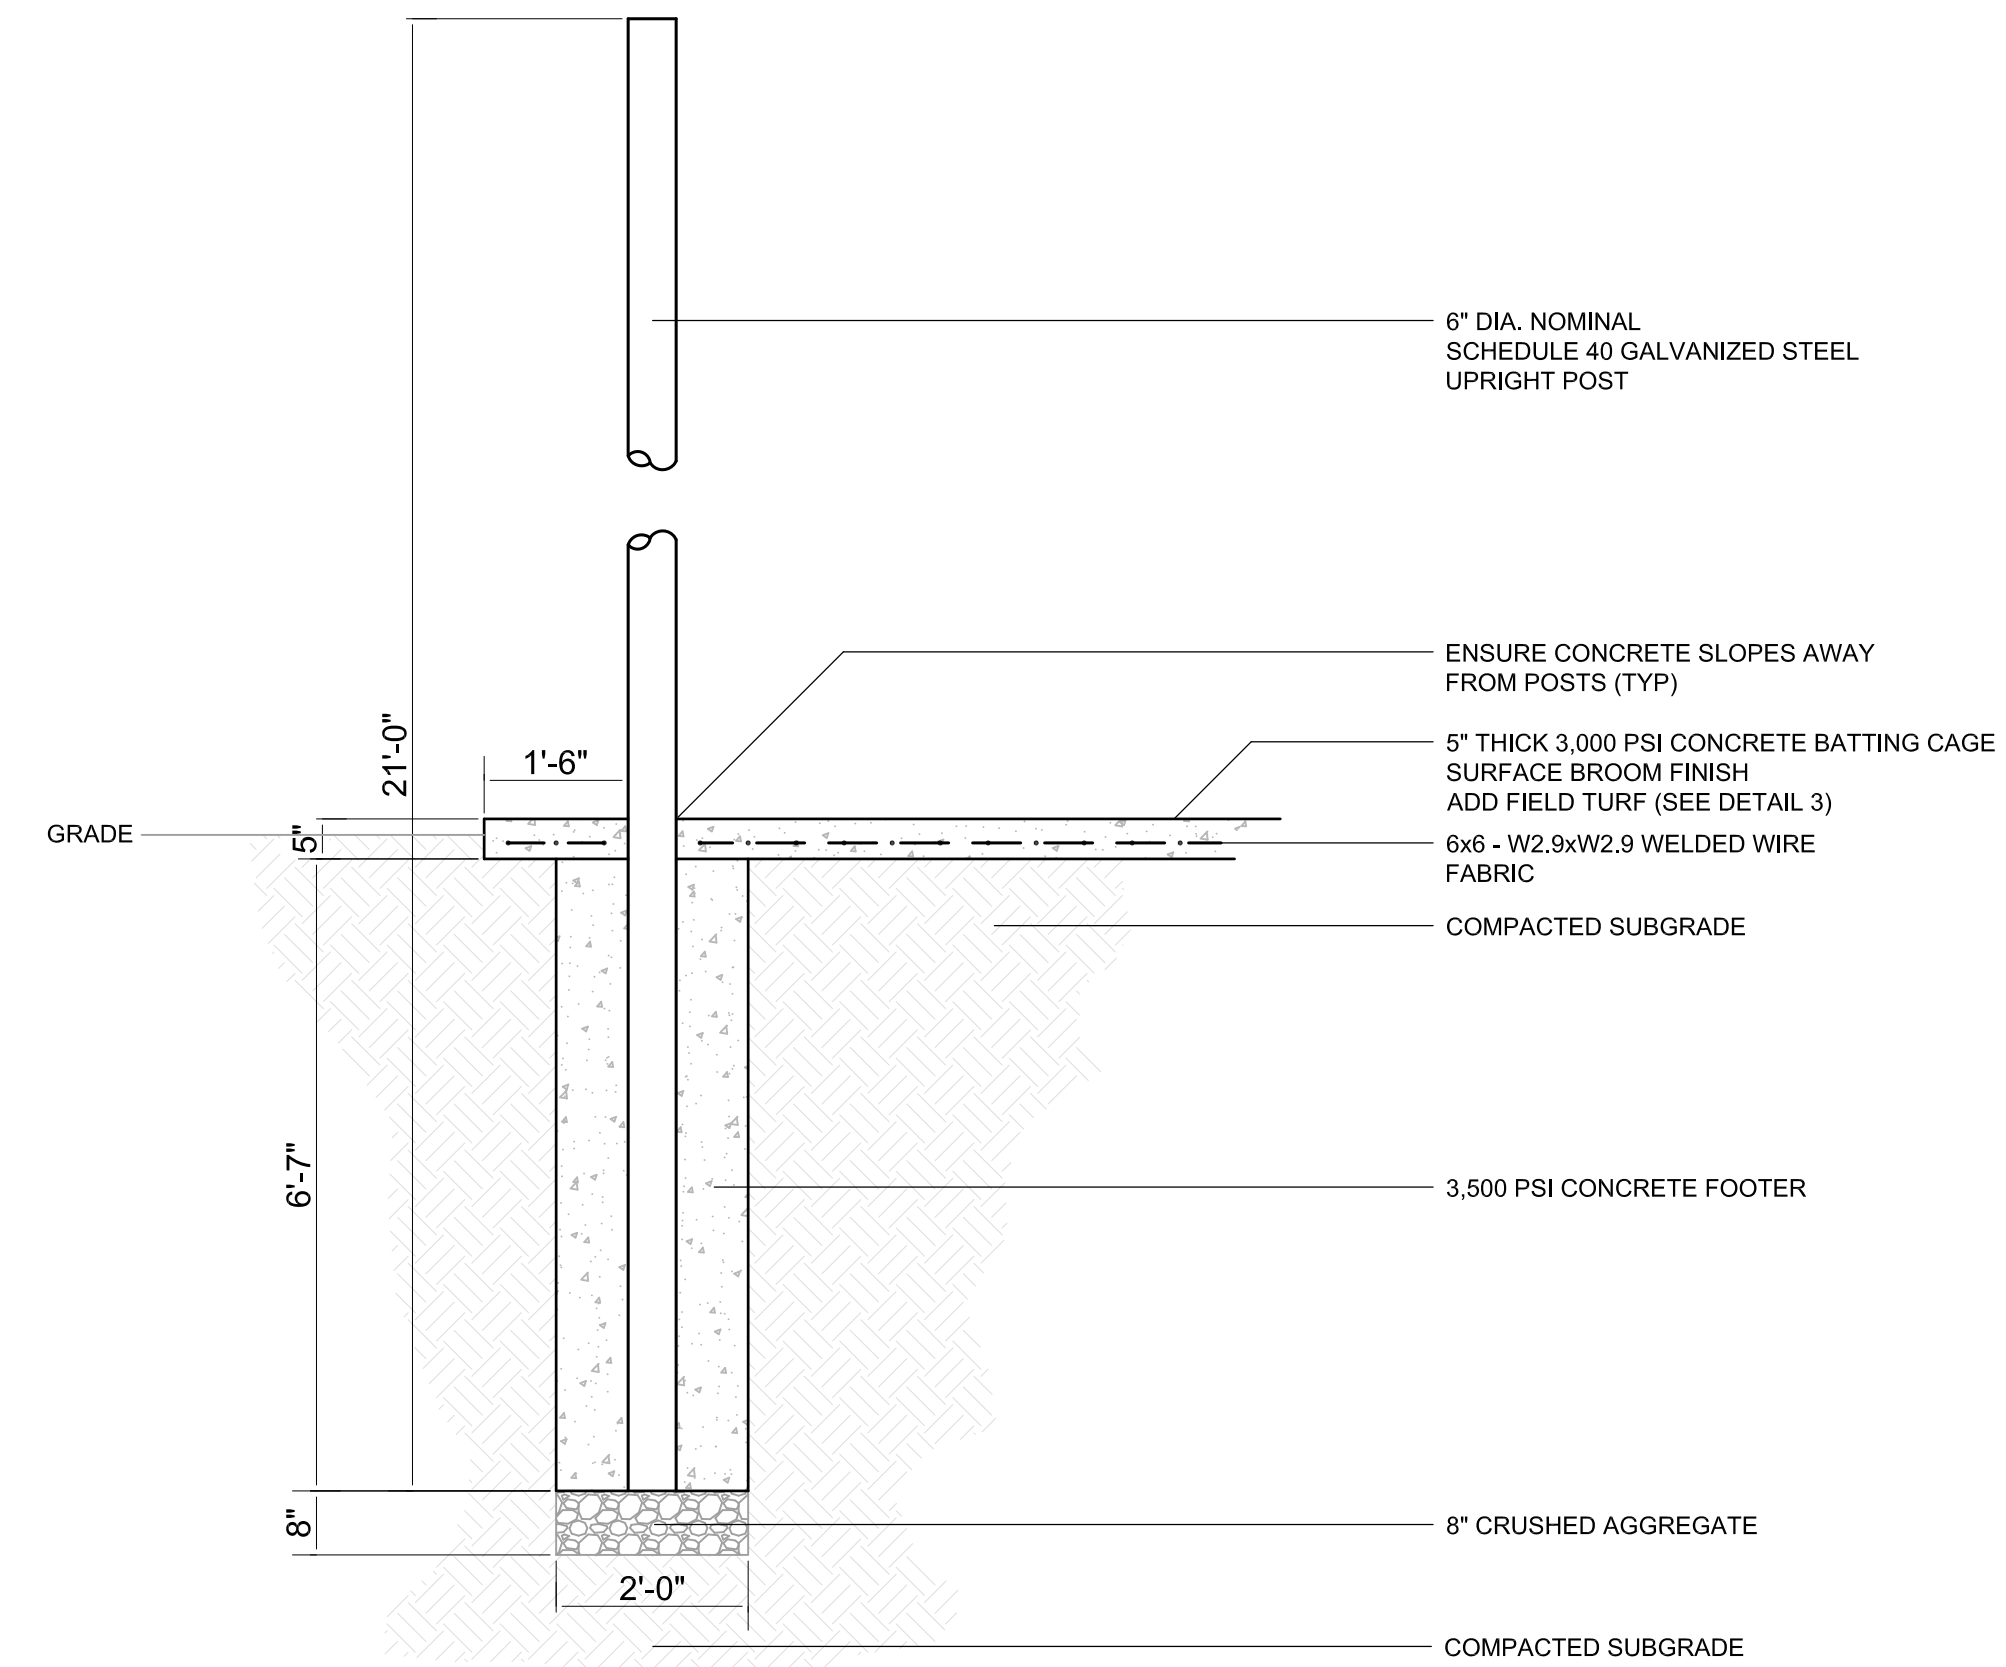

MANUFACTURER: BEACON ATHLETICS
 PRODUCT: TUFF1 BATTING CAGE SYSTEM
 DESCRIPTION: DOUBLE BASEBALL (70' LONG X 28' WIDE)
 MODEL NUMBER: 105-100-770


INSTALL IN ACCORDANCE WITH THE MANUFACTURER'S SPECIFICATIONS

2 TYPICAL BATTING CAGE POST DETAIL
 1/2" = 1'-0"

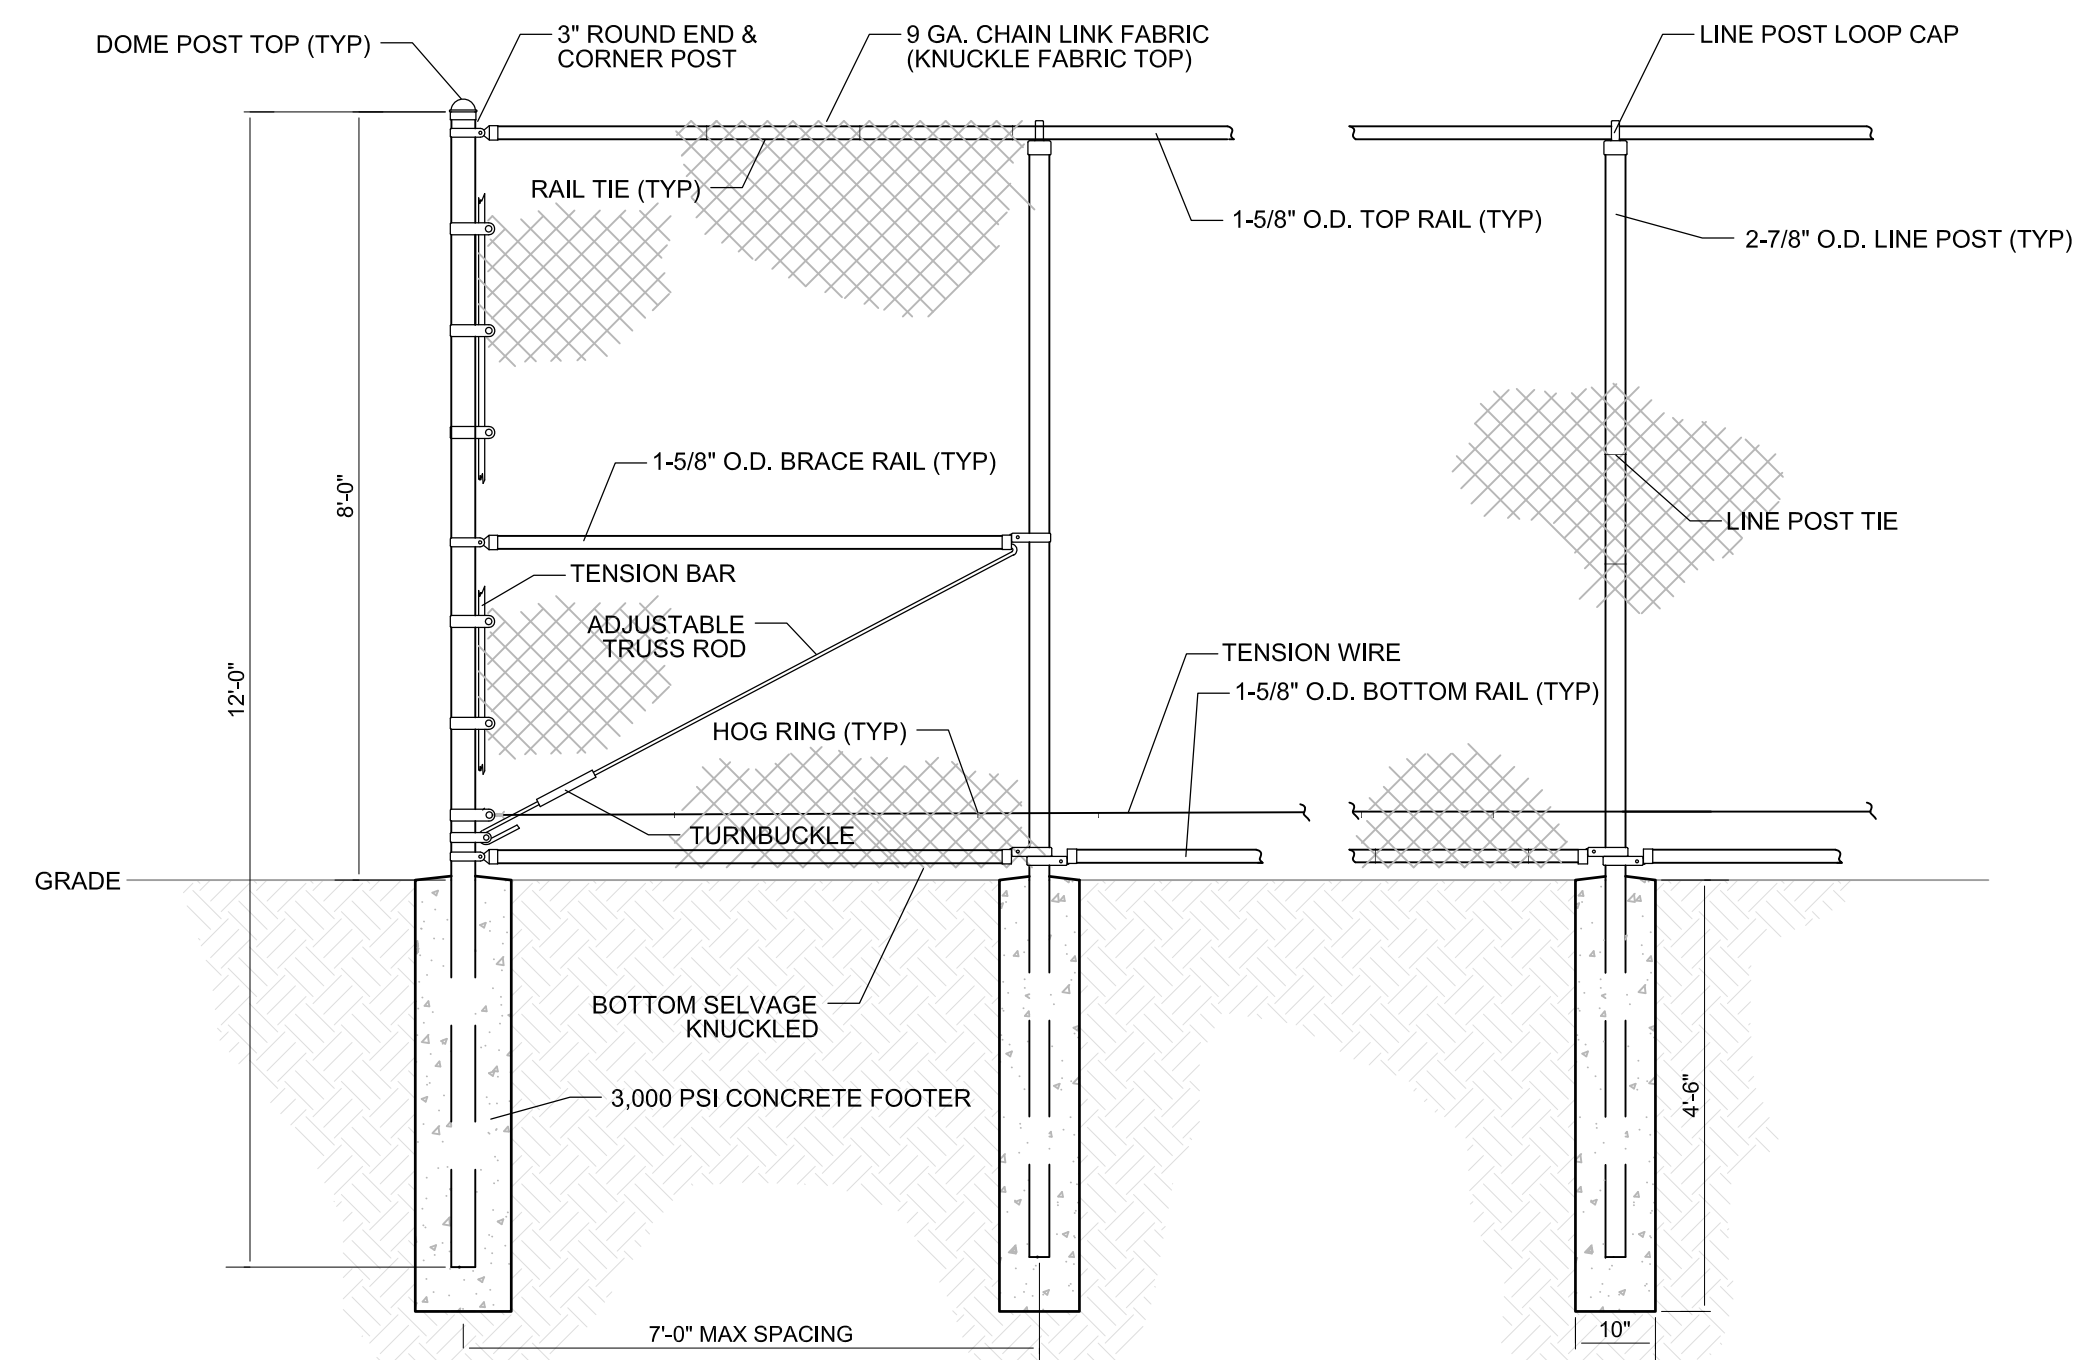

4 8' CHAIN LINK FENCE DETAIL
 N.T.S.

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 Metairie, Louisiana 70002

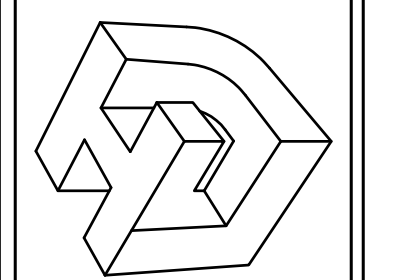

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KENILWORTH PLAYGROUND
 NEW ORLEANS, LOUISIANA
BATTING CAGE & FENCE DETAILS
 DRAWN BY: LHJ
 CHECKED BY: LHJ
 APPROVED BY: LHJ

PROJ. NO. 15-190
 DATE 03-29-2017
 SHEET NO.


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OF 17 SHEETS

TIME: 4:13 PM


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FILE: H:\Project Files\2015\15-190 Multiple NORDD Playgrounds\Kenilworth\15-190 Kenilworth-04.dwg




NOTES:
 1. FLEXI-PAVE COLOR SHALL BE SELECTED BY THE OWNER FROM THE MANUFACTURER'S COLOR SAMPLES.
 2. FLEXI-PAVE SHALL BE POURED AT A CONSISTENT 1-1/2" THICKNESS. ALL GRADE ADJUSTMENTS SHALL BE MADE WITH THE LIMESTONE BASE INSTALLATION.

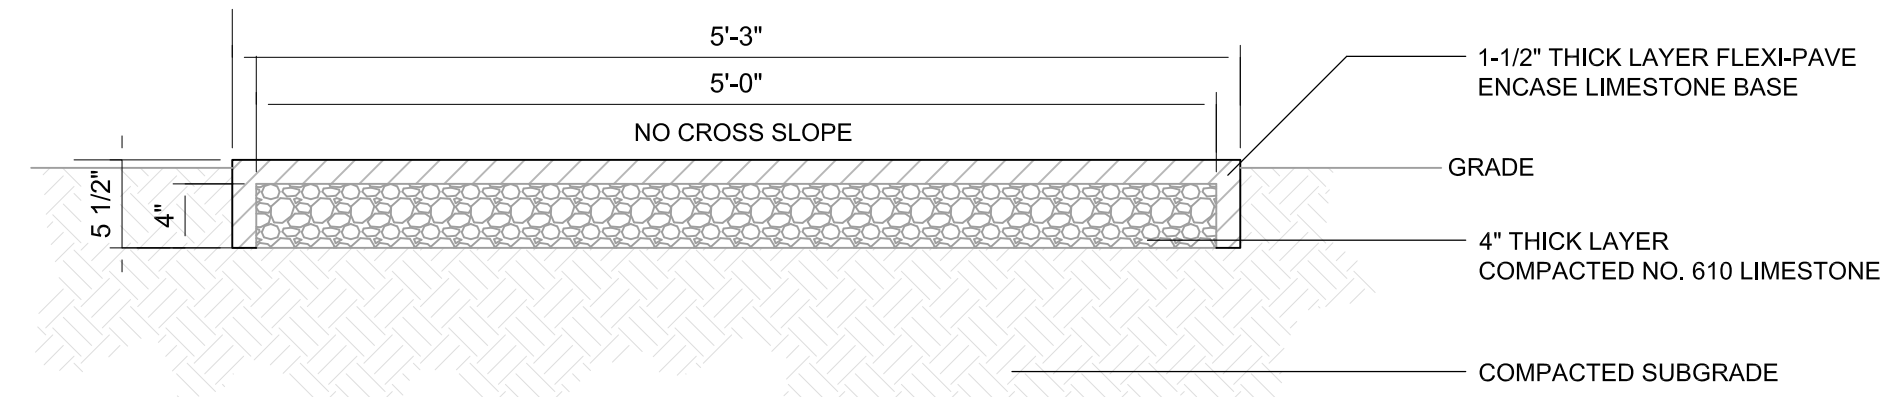
1
8 FLEXI-PAVE SECTION
 1" = 1'-0"

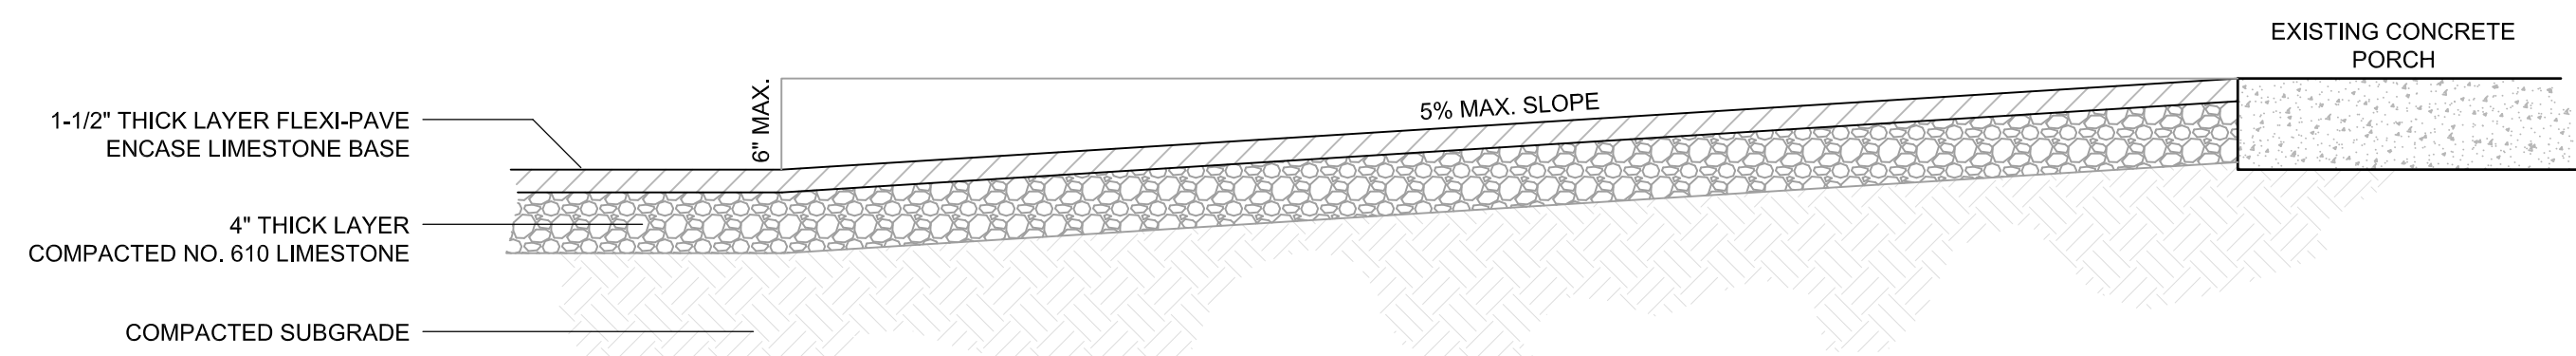


2
8 FLEXI-PAVE SIDEWALK RAMP
 1" = 1'-0"

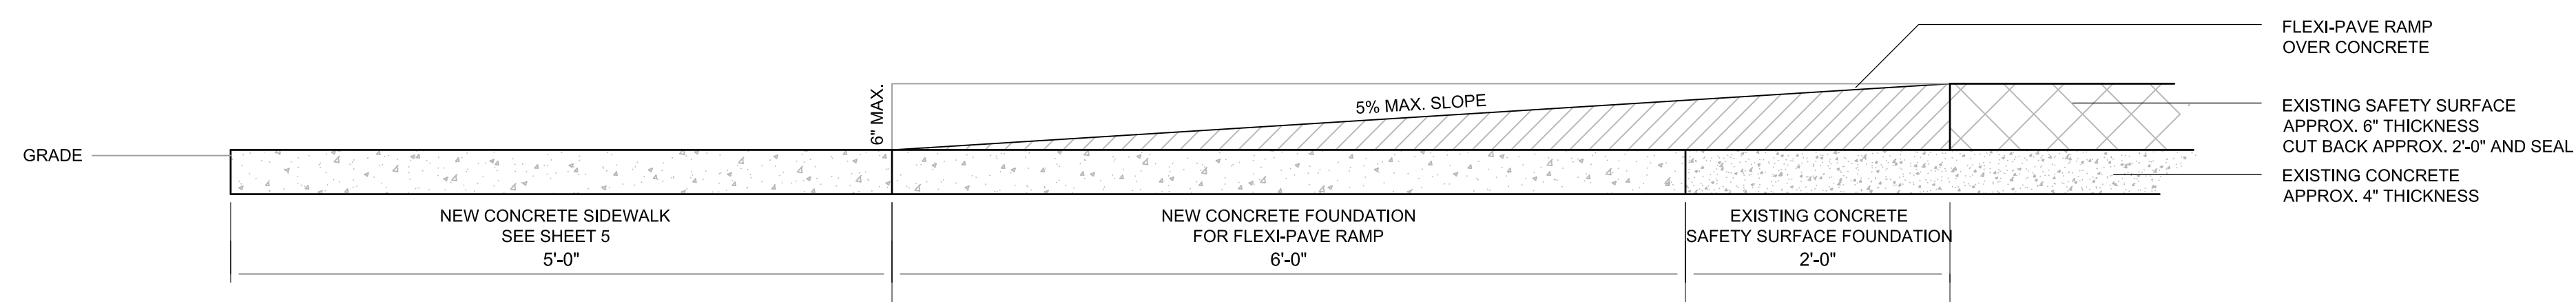

3
8 FLEXI-PAVE PLAYGROUND RAMP
 1" = 1'-0"

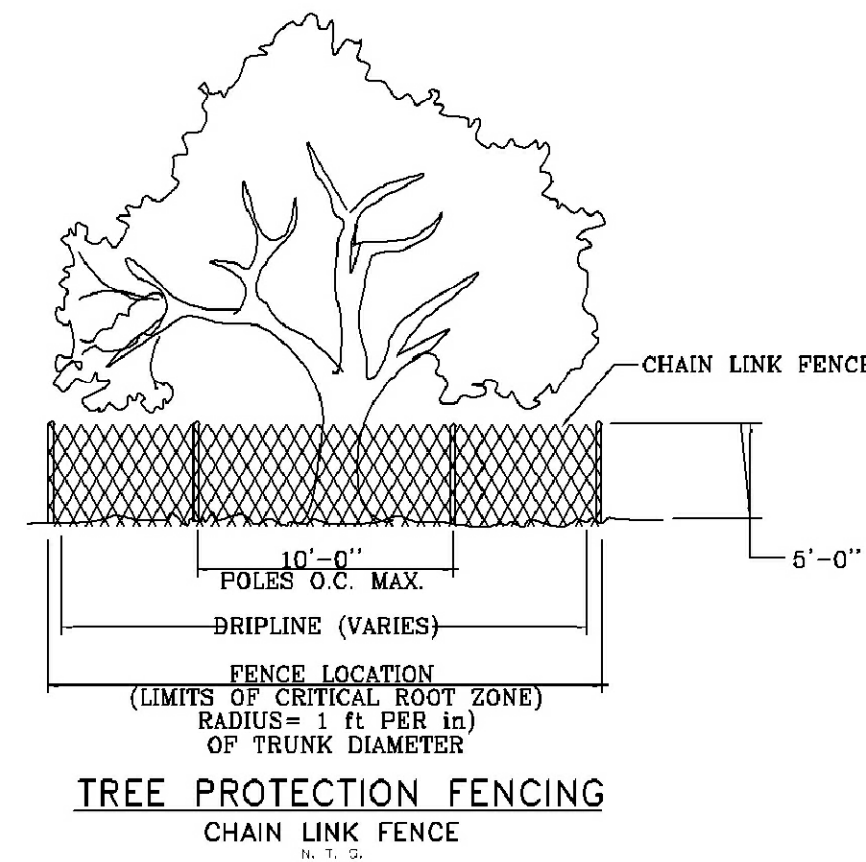


TREE PROTECTION FENCING
 CHAIN LINK FENCE
 N.T.S.

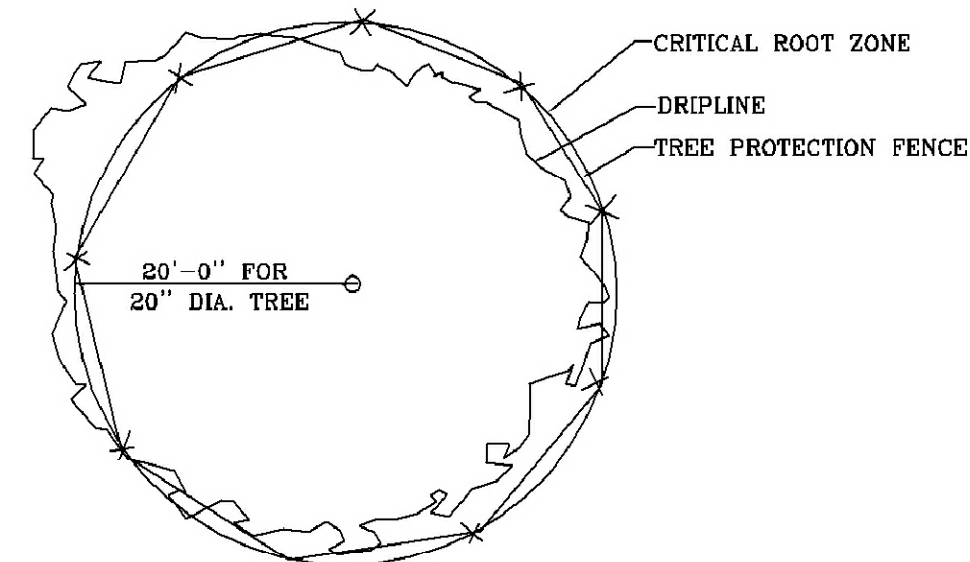


TREE PROTECTION FENCING
 CHAIN LINK FENCE
 N.T.S.

NOTES:
 NOTICE IS TO BE POSTED ON FENCING - 15' O.C. - AND SHALL READ
 "<<<WARNING>>>PROTECTIVE TREE FENCING. DO NOT ENTER, MOVE OR REMOVE"

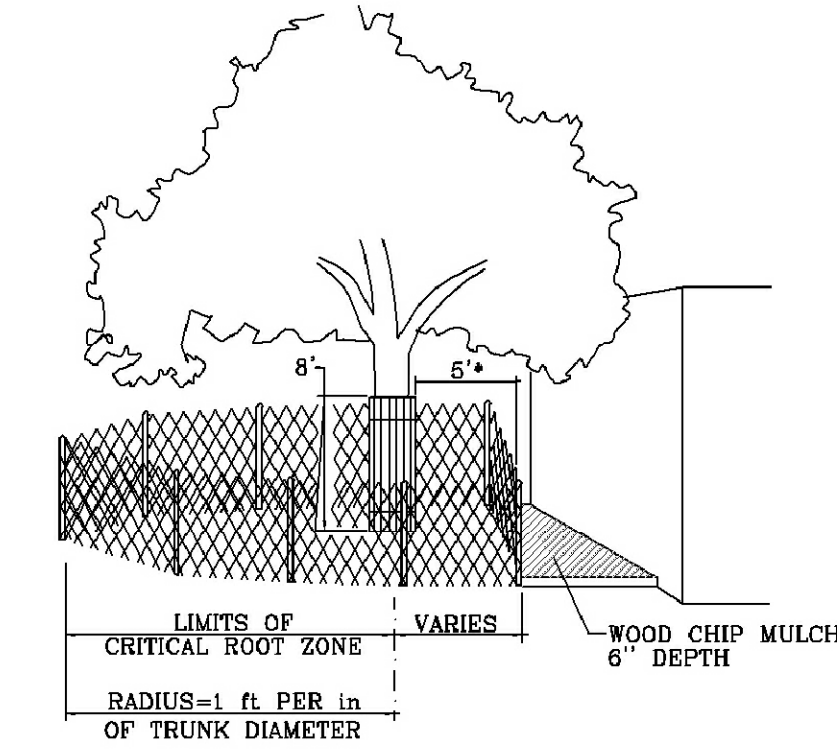


MODIFIED TREE PROTECTION FENCING
 CHAIN LINK FENCE
 N.T.S.

*AS NEEDED TO PROVIDE MINIMUM NECESSARY WORK SPACE. IF LESS THAN 6', THEN ADD BOARDS STRAPPED TO TRUNK.

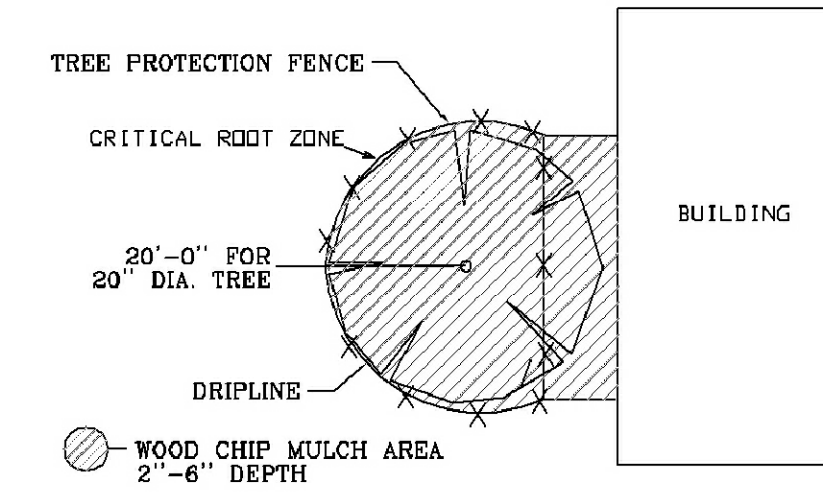

MODIFIED TREE PROTECTION FENCING
 CHAIN LINK FENCE
 N.T.S.

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 Metairie, Louisiana 70002

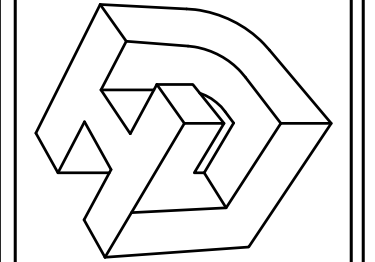

SEAL


REV. NO.	DATE

KENILWORTH PLAYGROUND
NEW ORLEANS, LOUISIANA
TREE PROTECTION DETAILS


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 CHECKED BY: LHJ
 APPROVED BY: LHJ

PROJ. NO. 15-190
 DATE 03-29-2017
 SHEET NO.




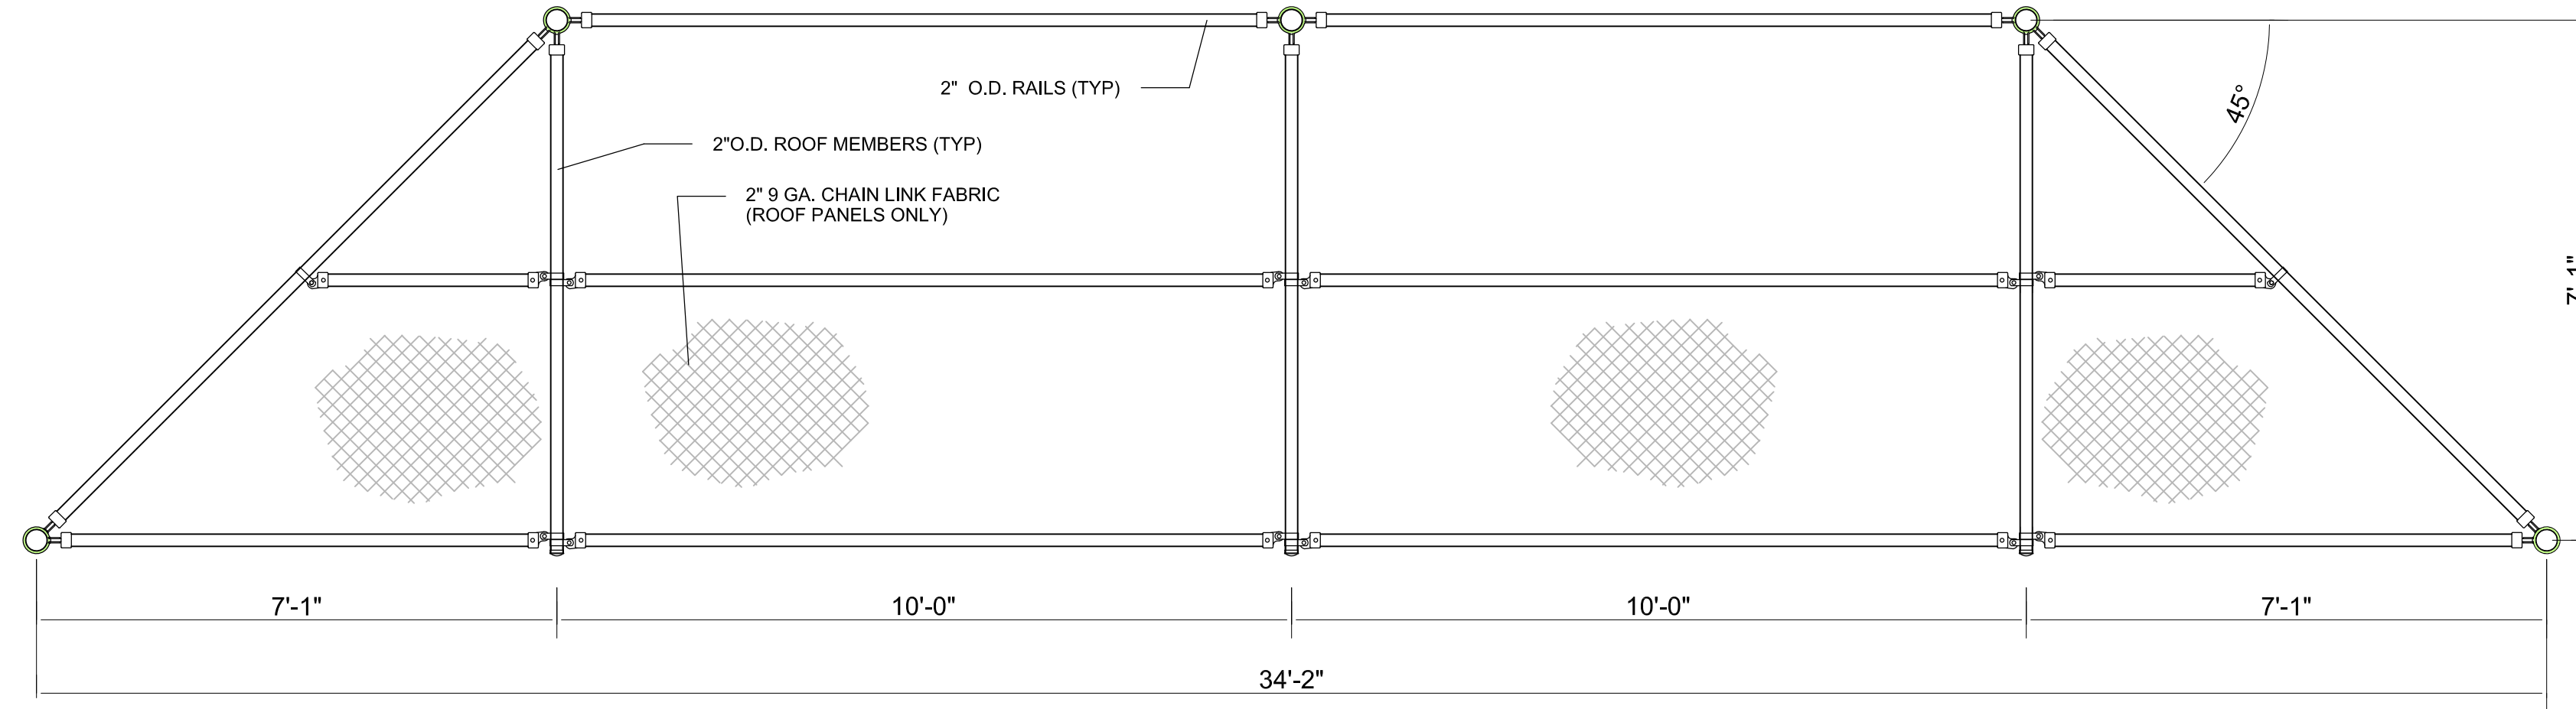

1
8 CHAIN LINK BACKSTOP (PLAN)
1/2" = 1'-0"

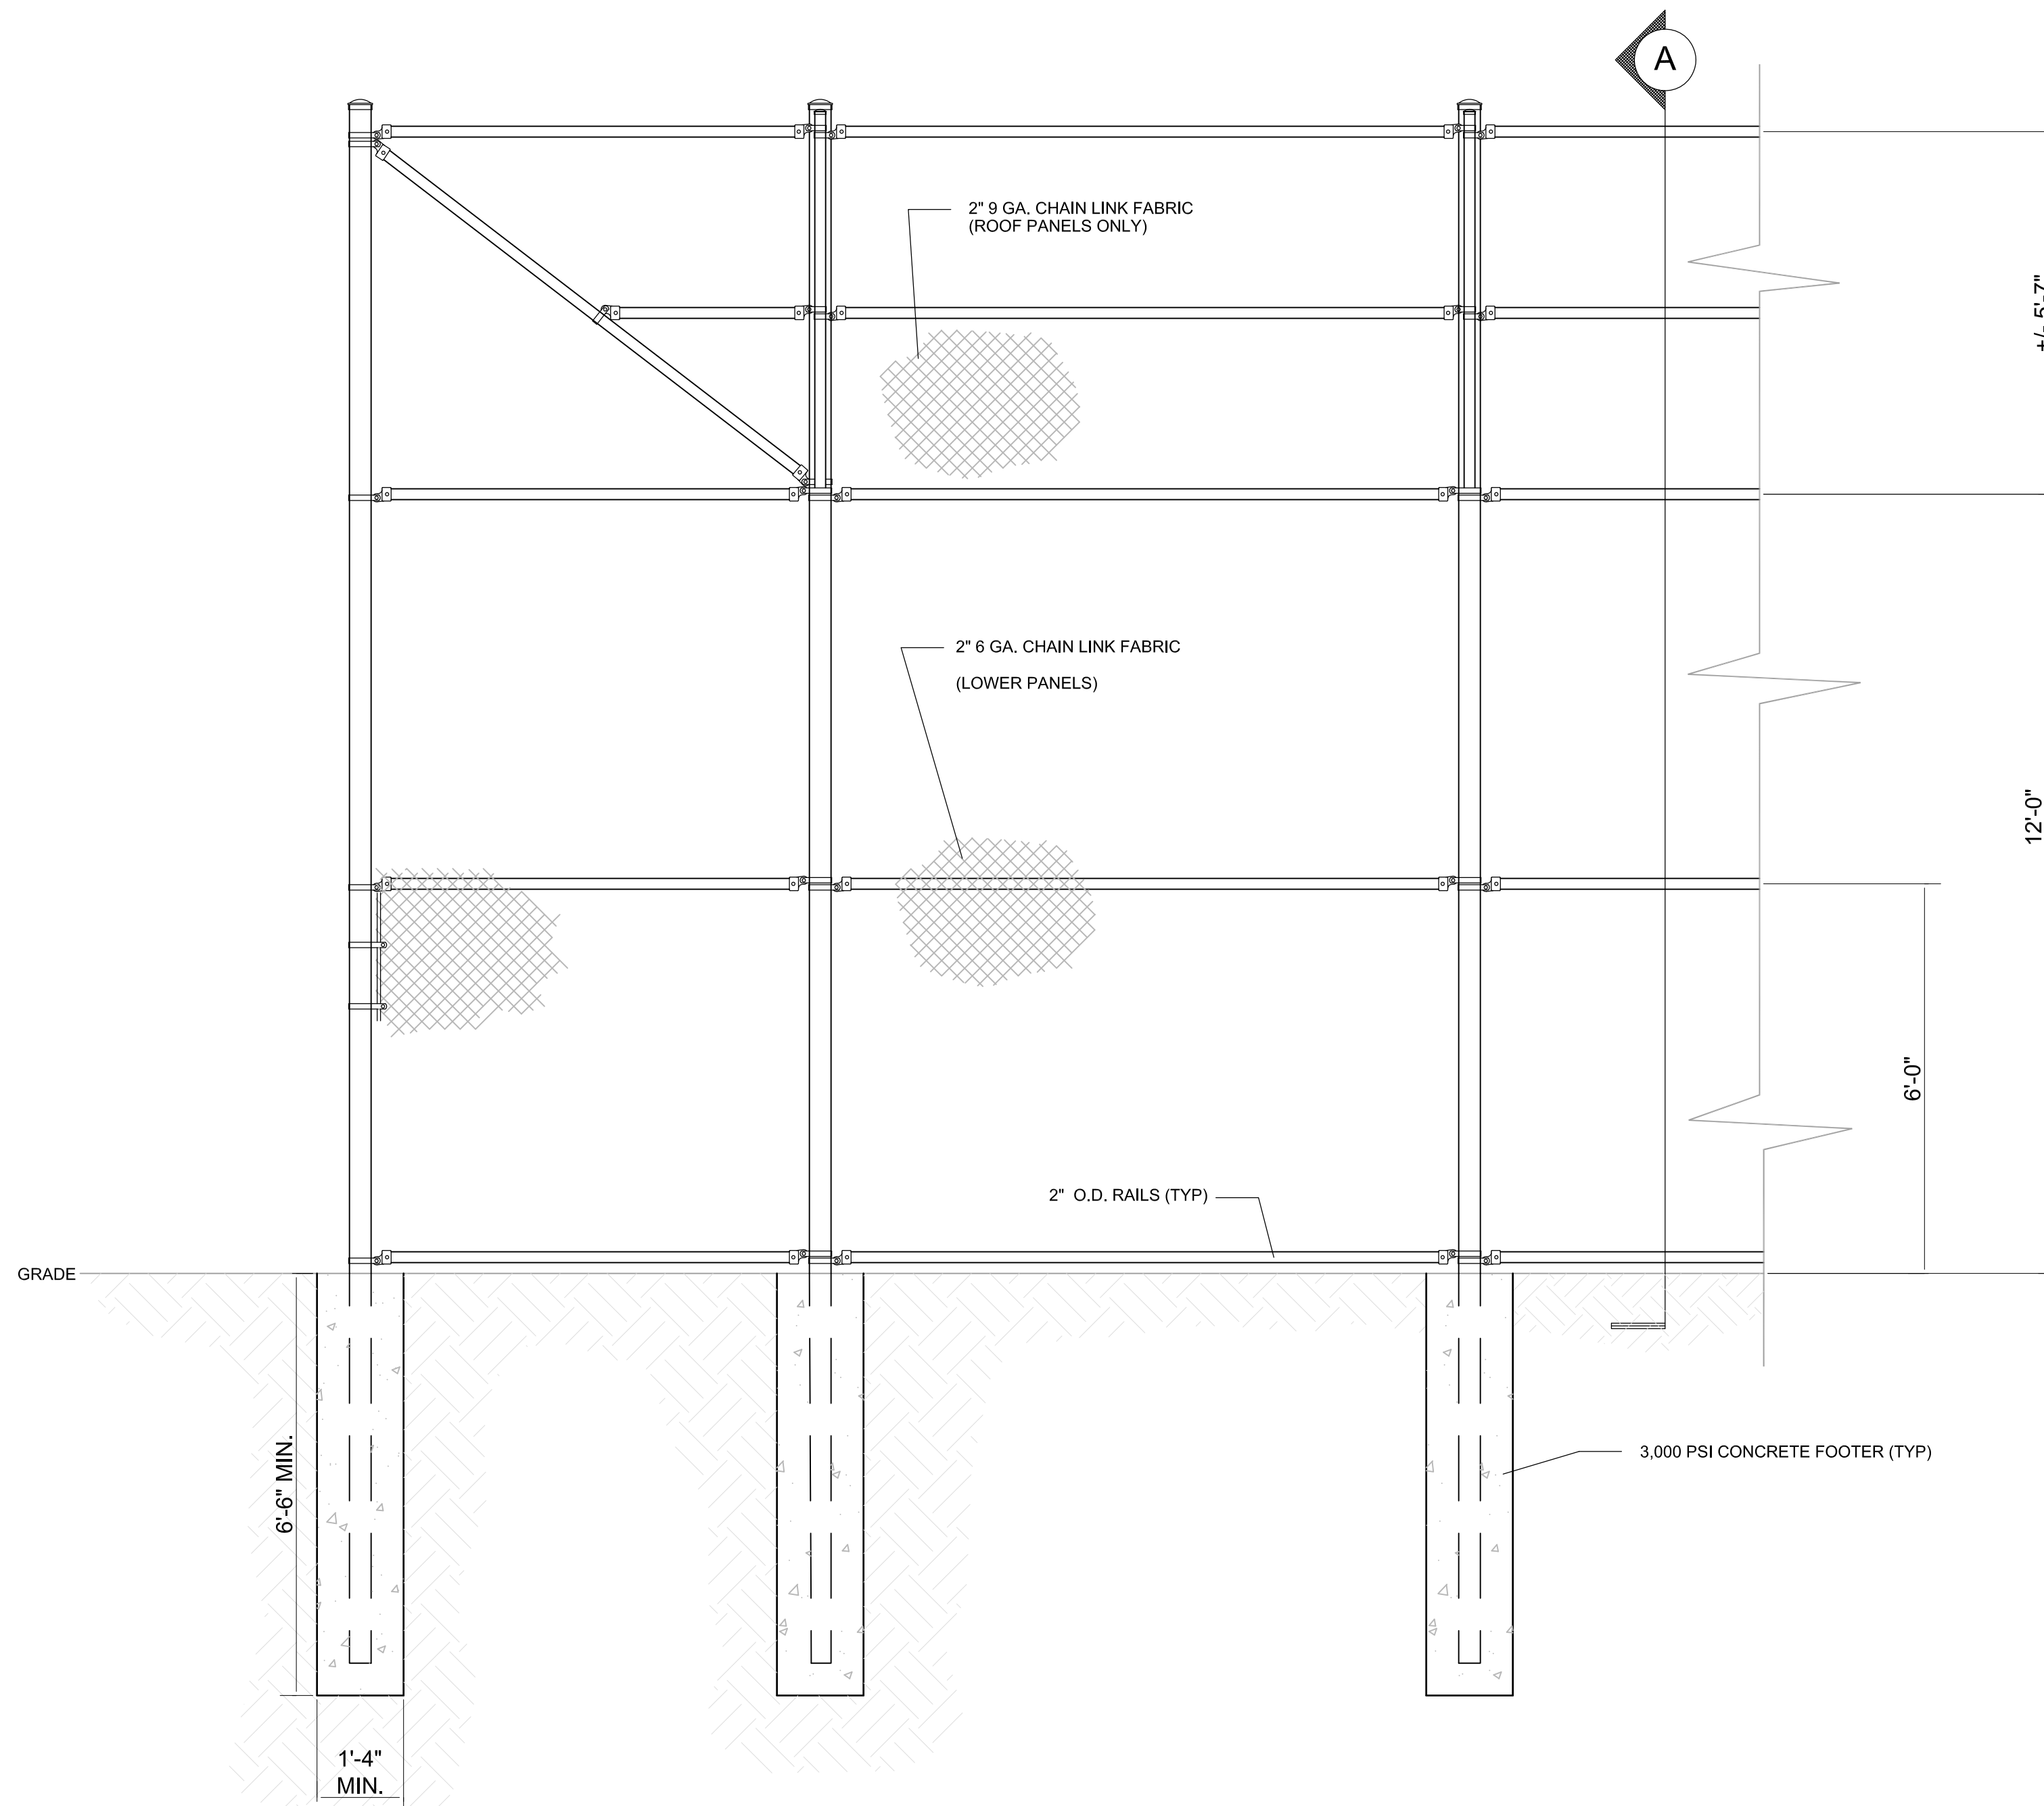


2
8 CHAIN LINK BACKSTOP (ELEVATION)
1/2" = 1'-0"

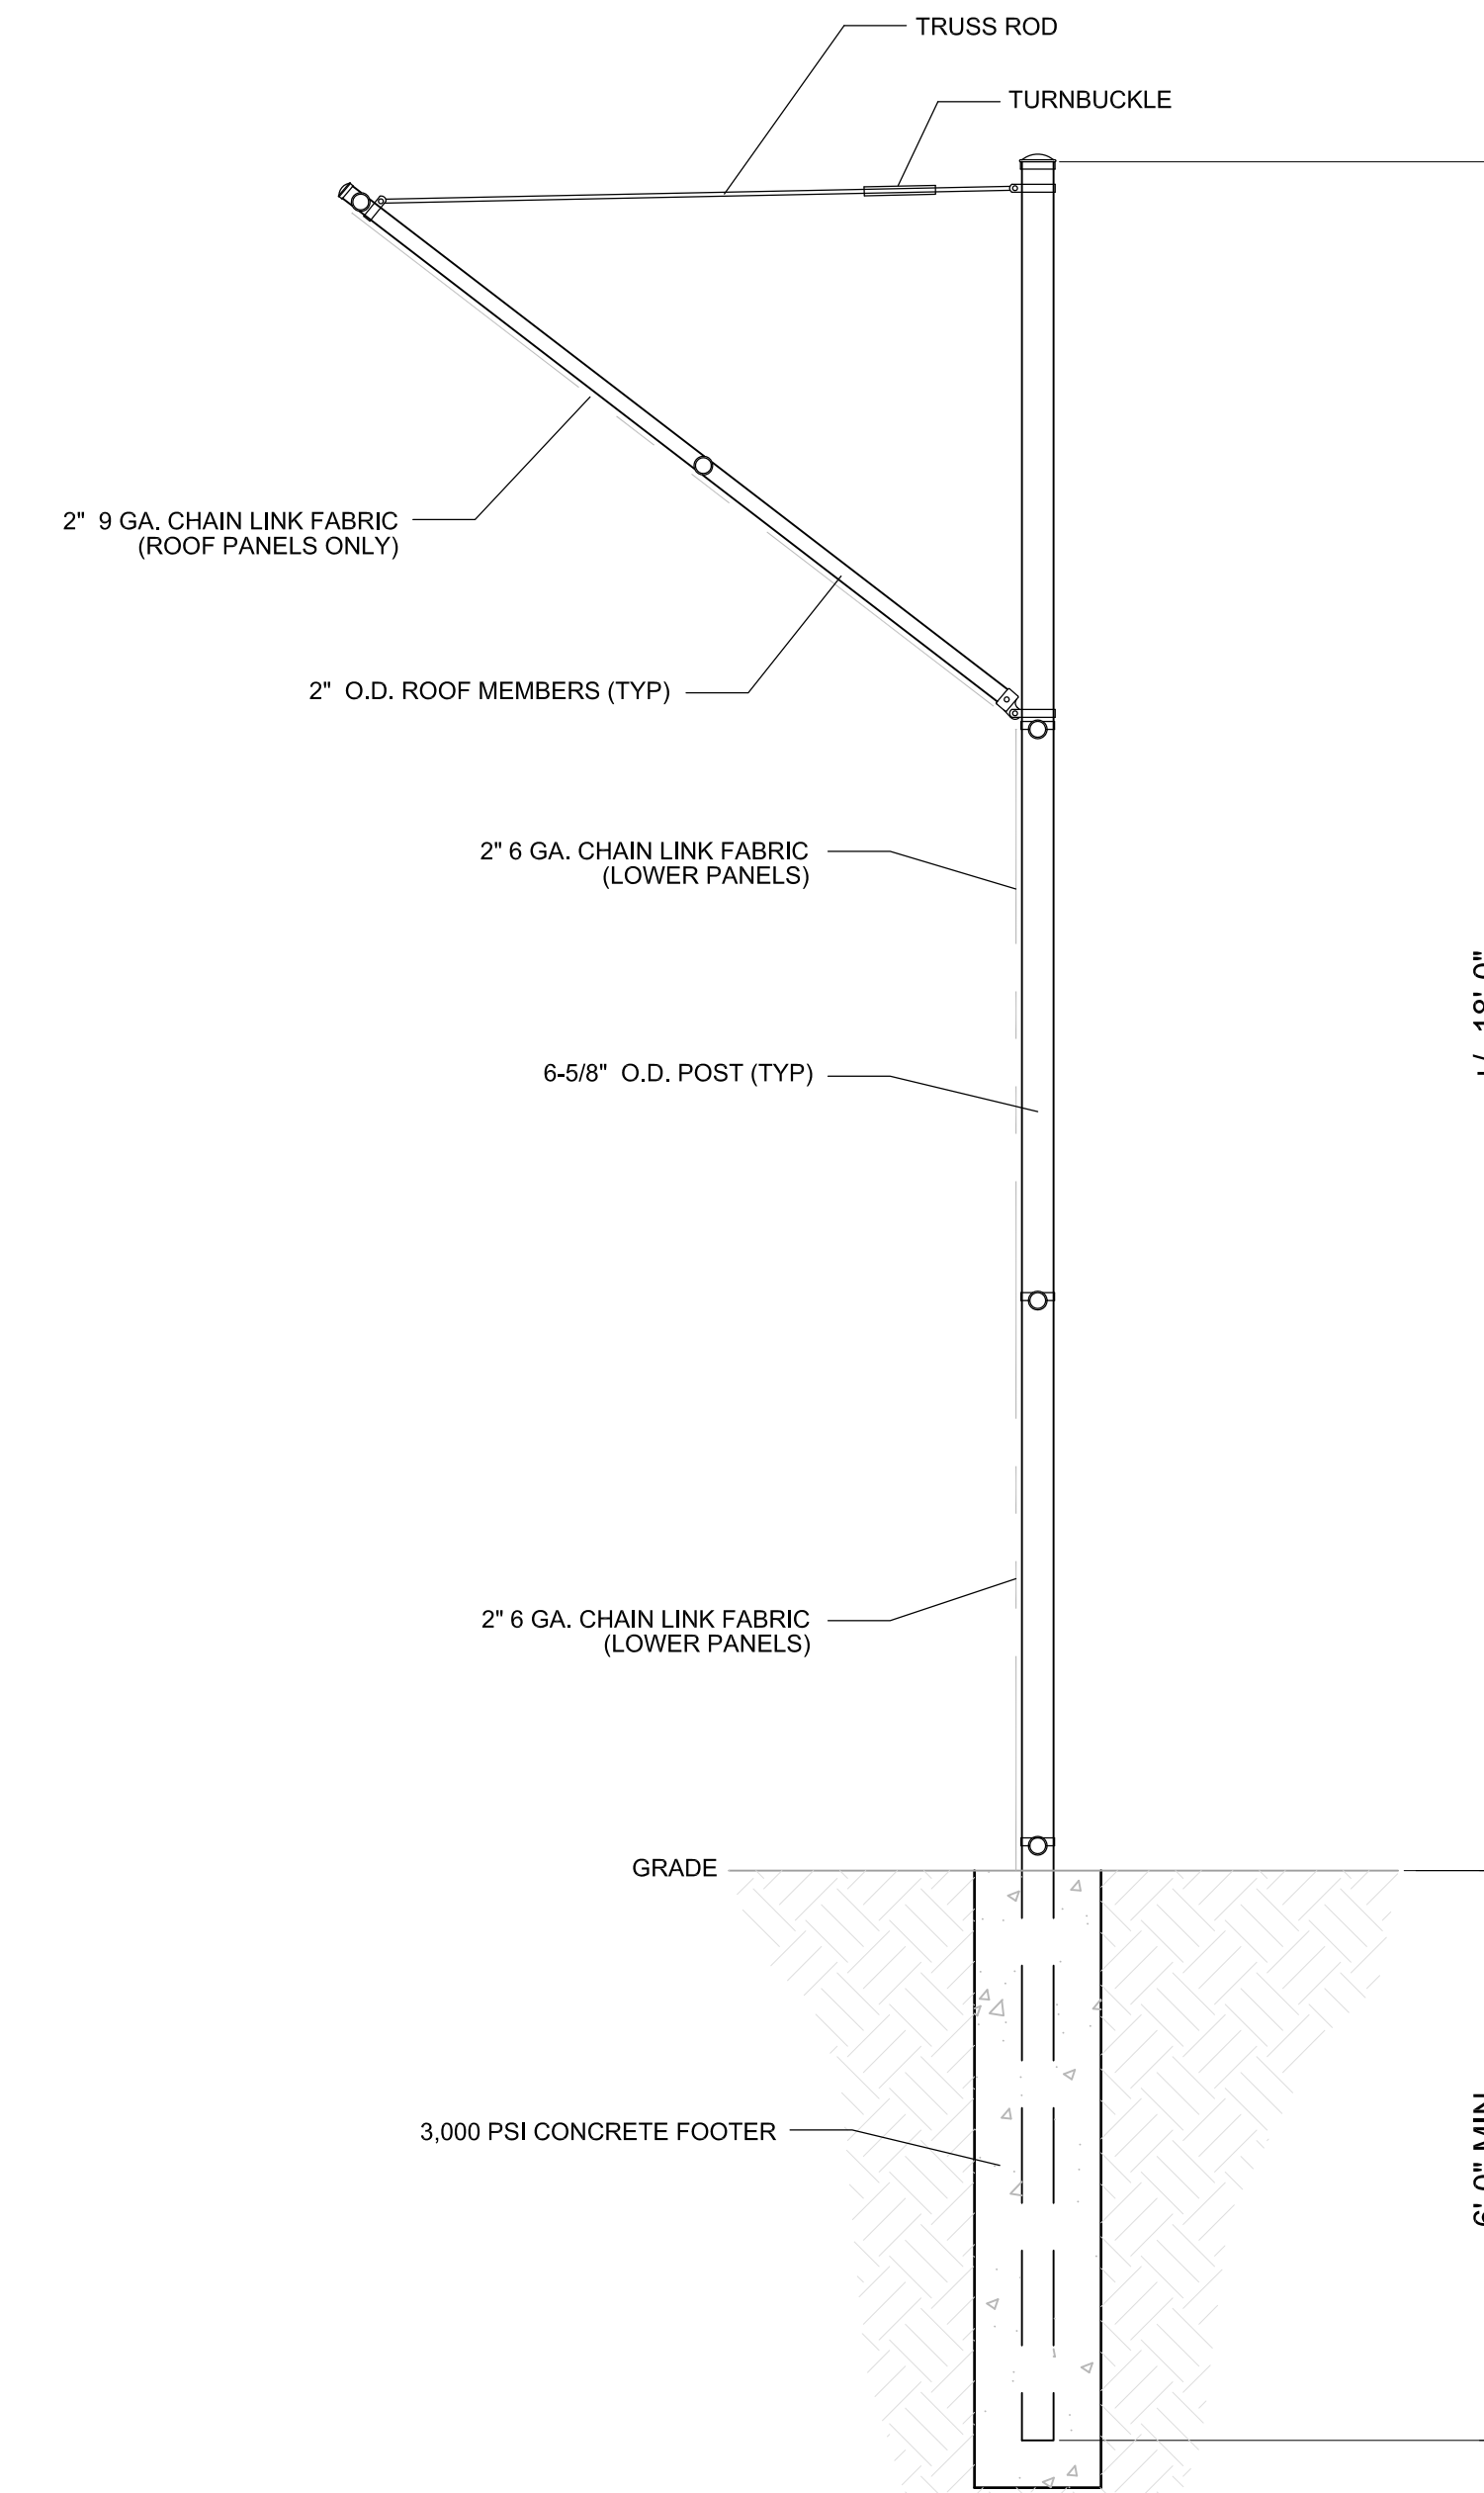

3
8 CHAIN LINK BACKSTOP (SECTION A)
1/2" = 1'-0"

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Metairie, Louisiana 70002

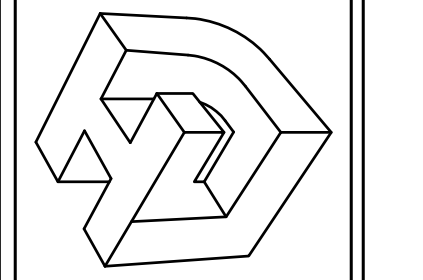

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KENILWORTH PLAYGROUND
NEW ORLEANS, LOUISIANA

THIS SHEET
CHAIN LINK BACKSTOP
DRAWN BY: LHJ
CHECKED BY: LHJ
APPROVED BY: LHJ










PROJ. NO. 15-190
DATE 03-29-2017
SHEET NO.



TIME: 4:15 PM

DATE: 4/10/2017

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- GENERAL DEMOLITION NOTES:**
- REMOVE ALL ITEMS SHOWN WITH DASHED LINES COMPLETELY. PREPARE ALL AREAS WHERE ITEMS WERE REMOVED TO BE PATCHED AND REPAIRED. (TYP.)
 - AFTER DEMOLITION IS COMPLETE CLEAN ALL WALL AND CEILING SURFACES. (TYP.)
 - REMOVE EXISTING PLUMBING LINES AS REQUIRED TO INSTALL NEW FIXTURES.
 - REMOVE ALL SUB-FLOOR SHEATHING IN ATTIC AND PREPARE JOISTS TO RECEIVE NEW SUB FLOOR SHEATHING. (TYP.)
 - ALL EXISTING WALL MOUNTED ITEMS AND SYSTEMS NOT NOTED FOR DEMOLITION AND REMOVAL ARE TO REMAIN.
 - PROTECT ALL EXISTING ITEMS, EQUIPMENT, AND SYSTEMS FROM DAMAGE DURING CONSTRUCTION.
 - CONTRACTOR WILL BE RESPONSIBLE FOR REPLACING ANY REMAINING ITEMS OR SYSTEMS DAMAGED DURING CONSTRUCTION AT CONTRACTORS COST.
 - FULLY WASH AND CLEAN ALL WALL EXISTING INTERIOR SURFACES PRIOR TO SUBSTANTIAL COMPLETION.
 - CONTRACTOR TO MAINTAIN A CLEAN JOB SITE DURING CONSTRUCTION REMOVING DEBRIS AND RUBBISH TO BIN DAILY.
 - PROTECT EXISTING SURFACES FROM DAMAGE DURING CONSTRUCTION. ANY SURFACES THAT ARE DAMAGED DURING CONSTRUCTION ARE TO BE PATCHED AND REPAIRED TO MATCH ADJACENT SURFACES LIKE AND KIND.
 - CONTRACTOR TO REMOVE ALL EXISTING FLUORESCENT LIGHT FIXTURES AND COIL EXISTING POWER SUPPLY WIRING AND CONTROLS FOR REUSE.
 - PROTECT EXISTING HVAC SYSTEM AND DUCTWORK FROM DAMAGE DURING CONSTRUCTION. PRIOR TO SUBSTANTIAL COMPLETION CLEAN ALL DUCTWORK, GRILLES, AND SUPPORTS COMPLETELY.
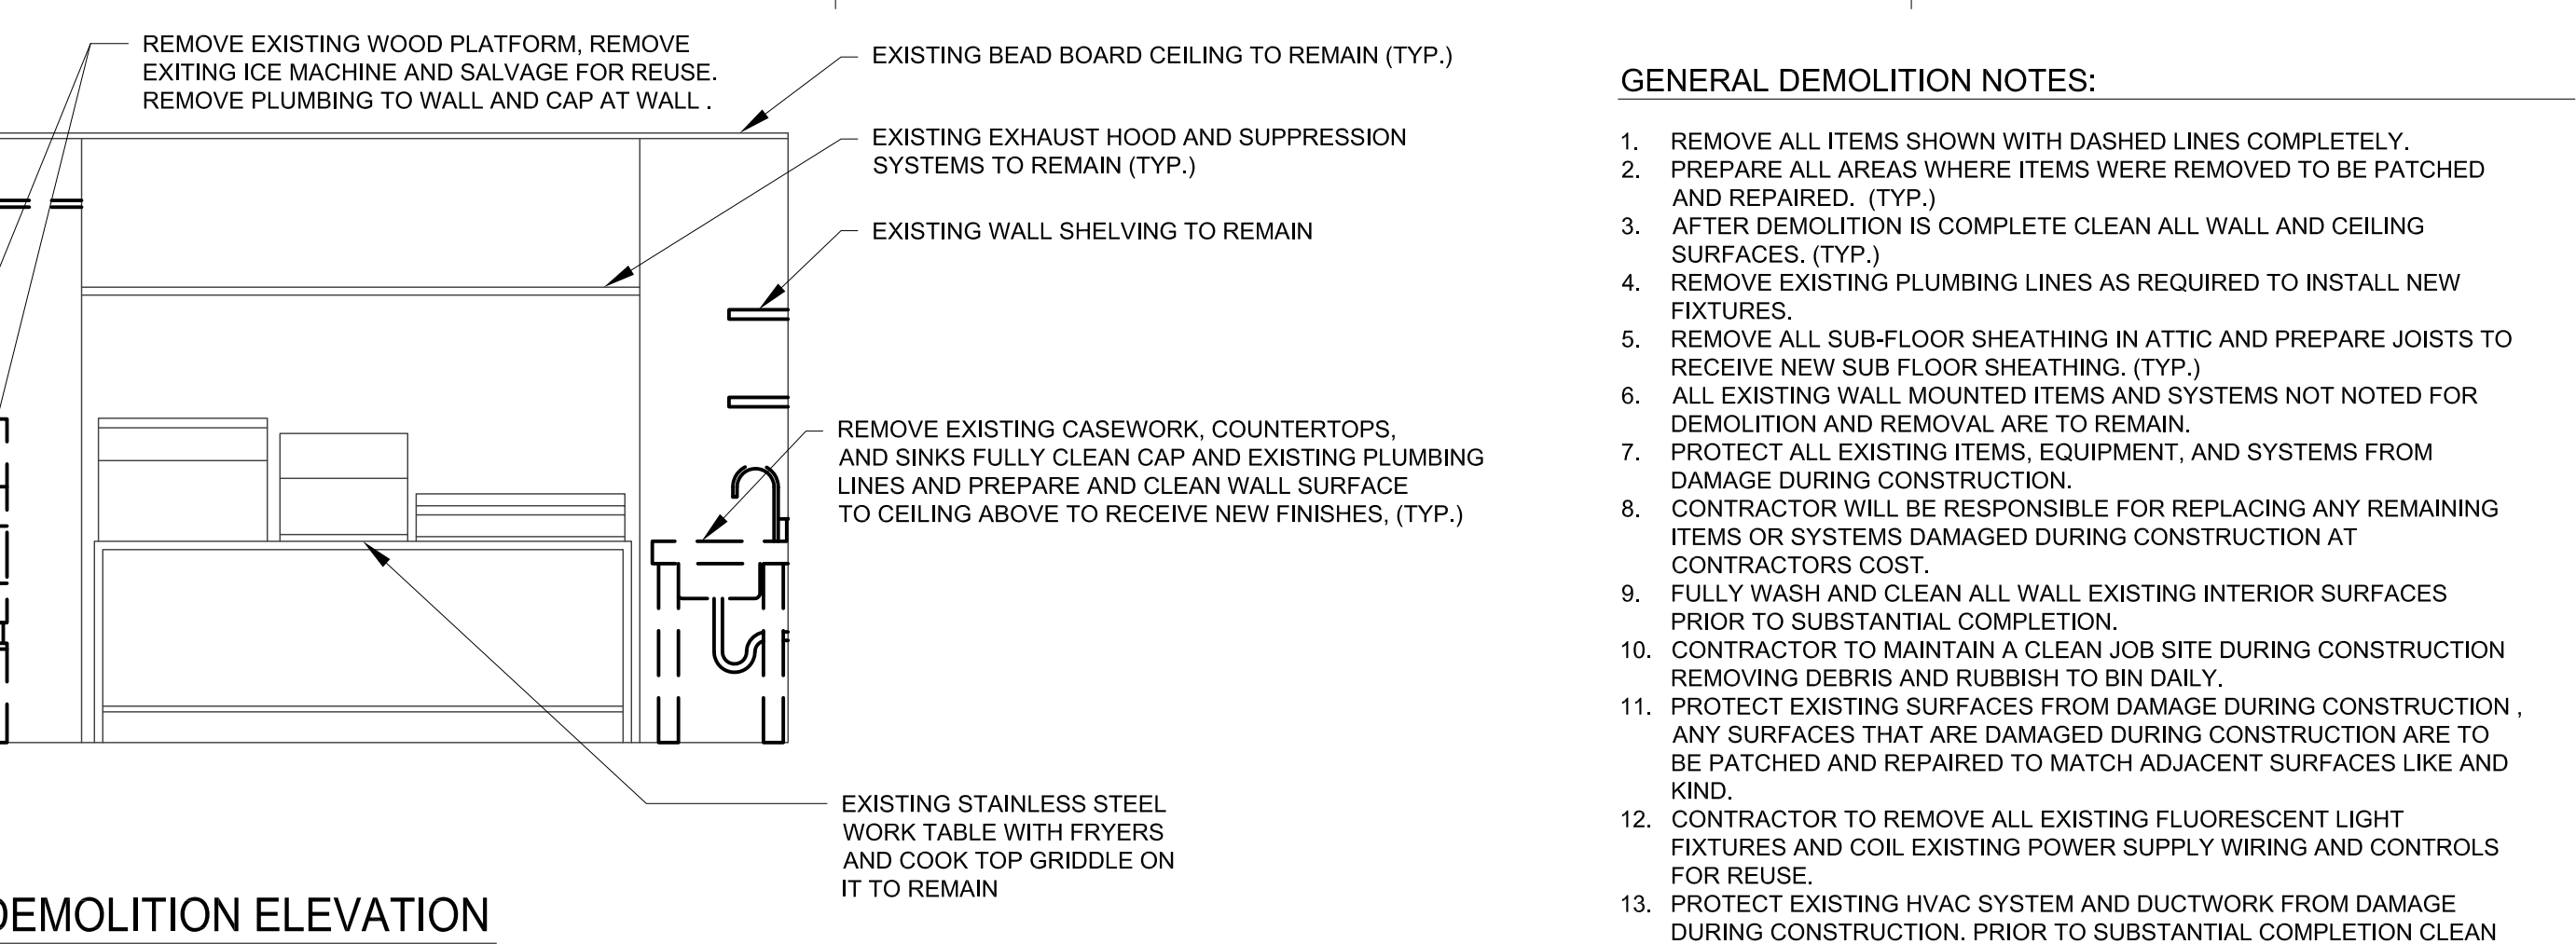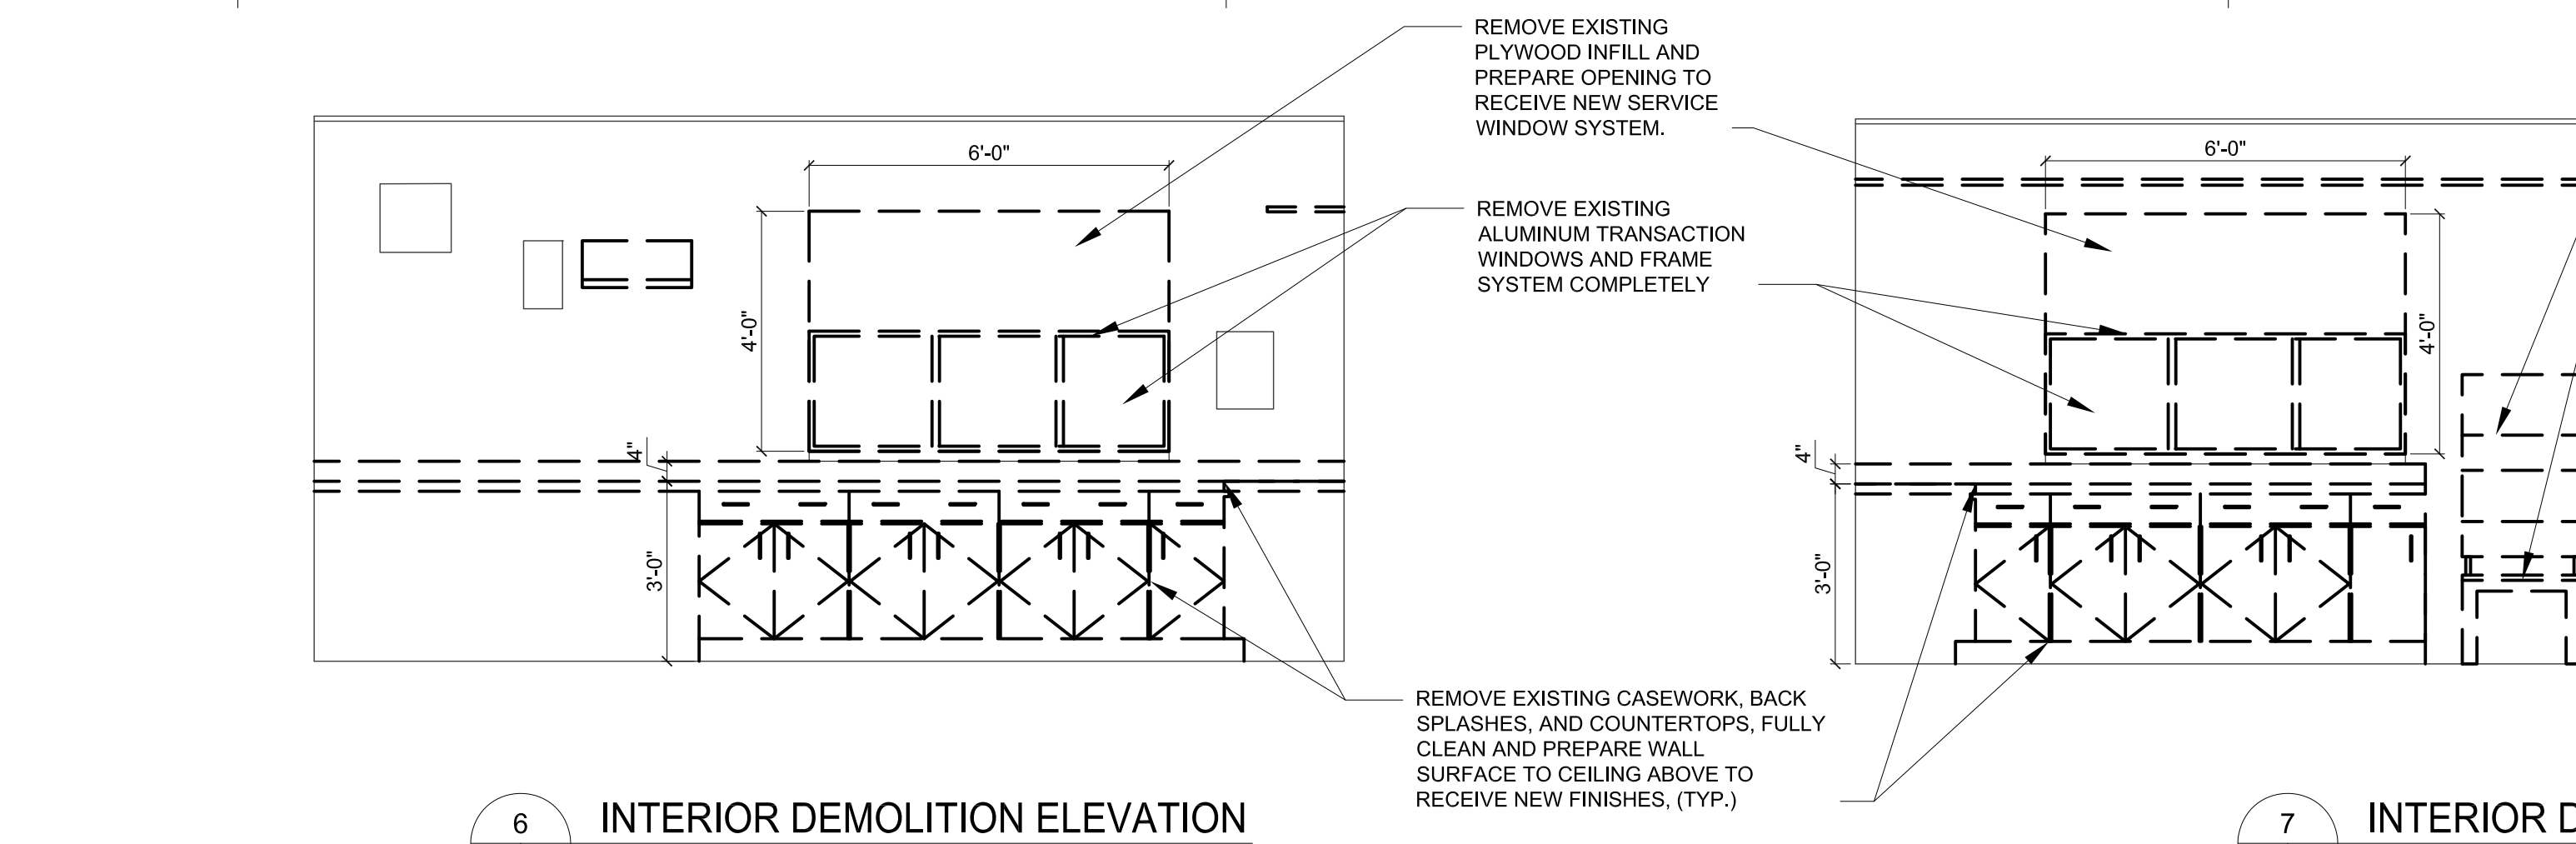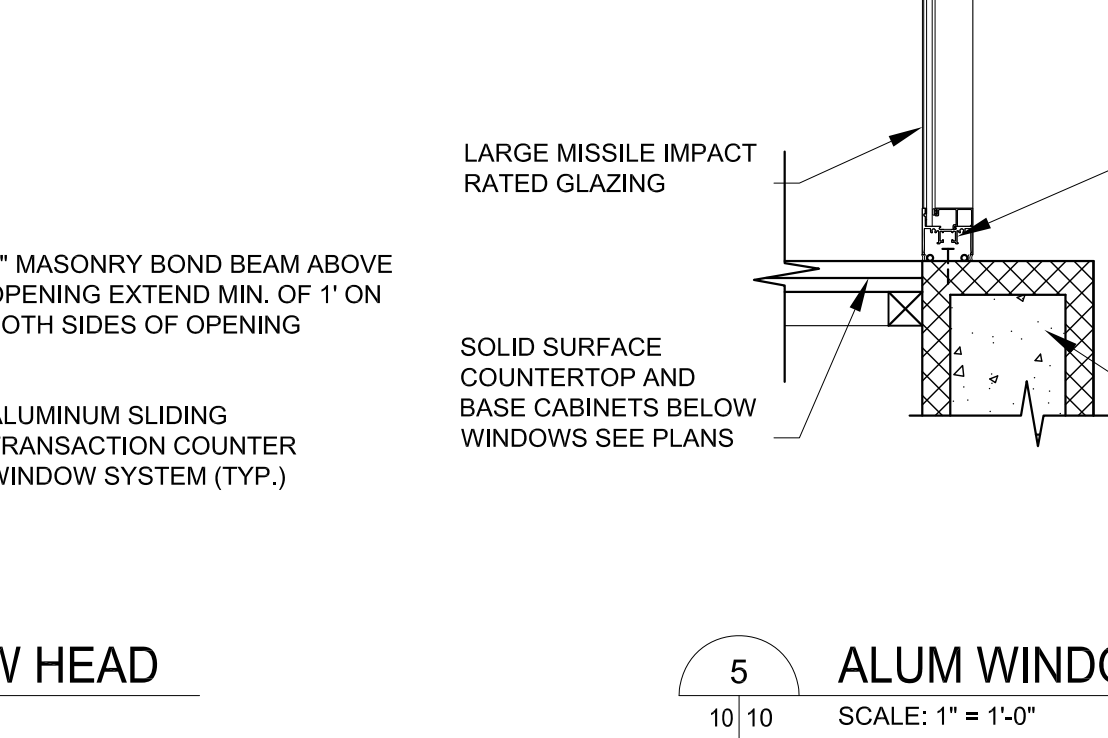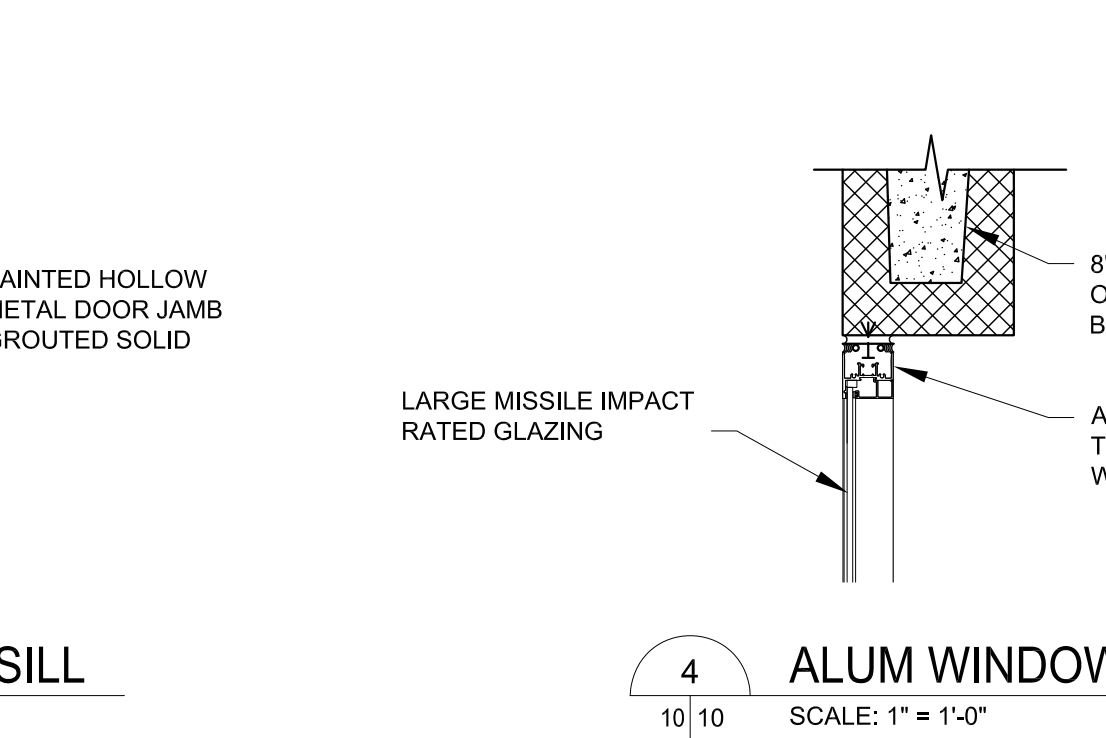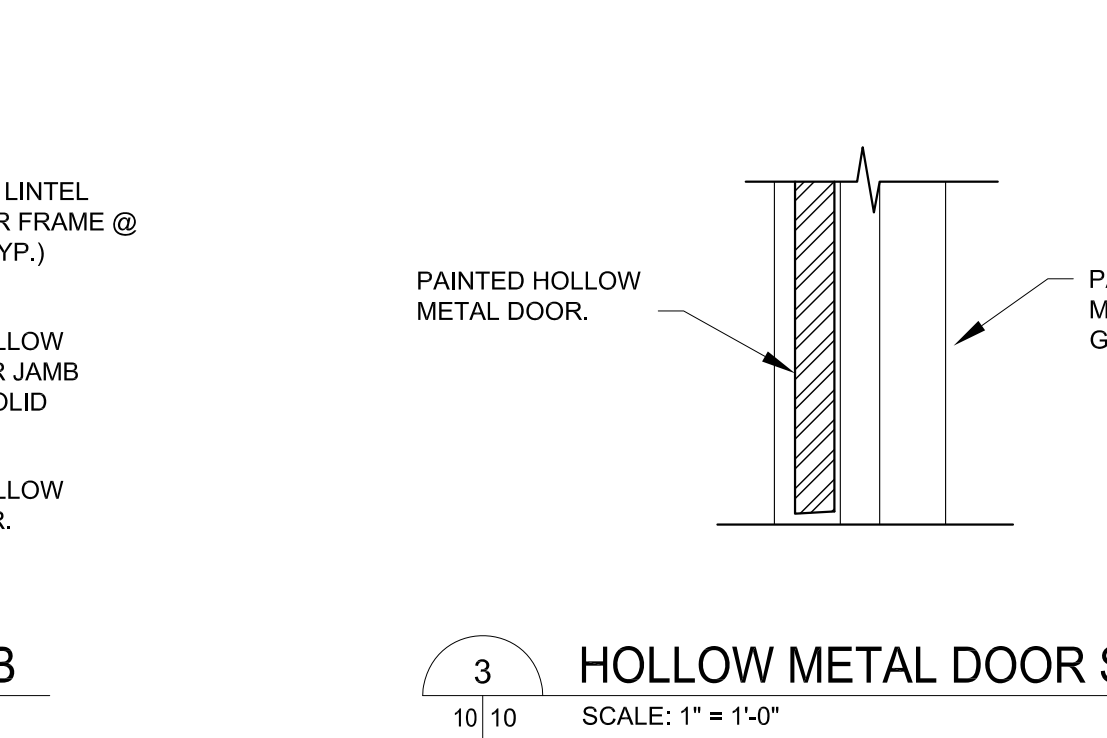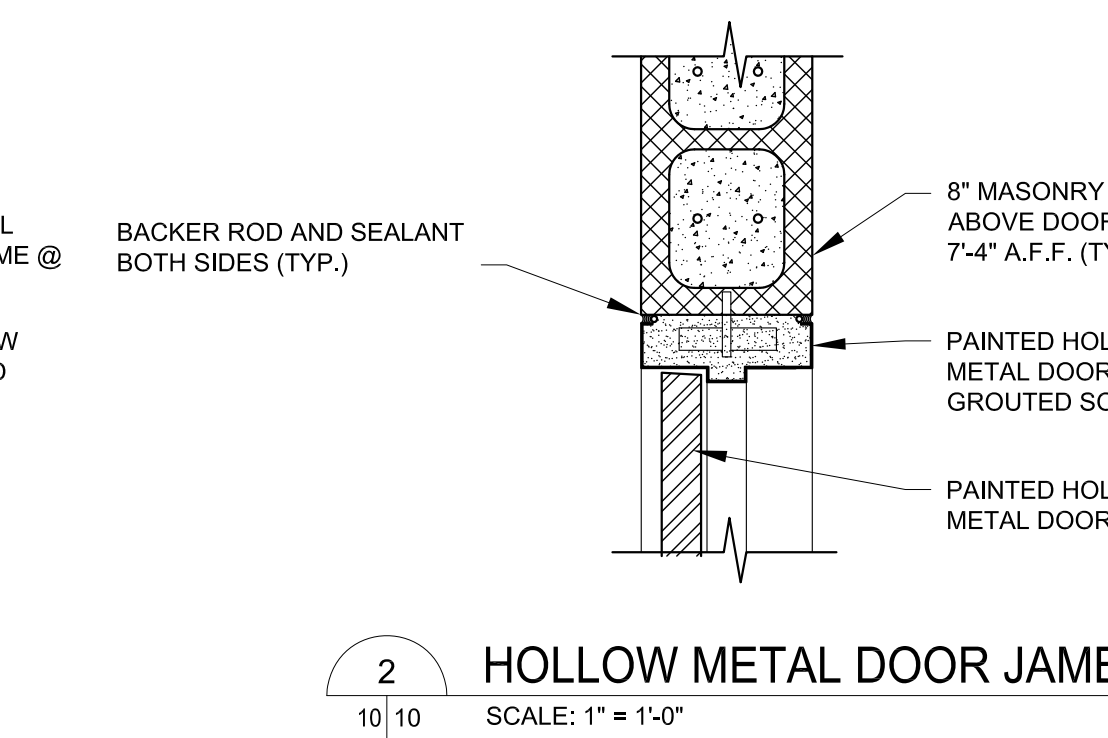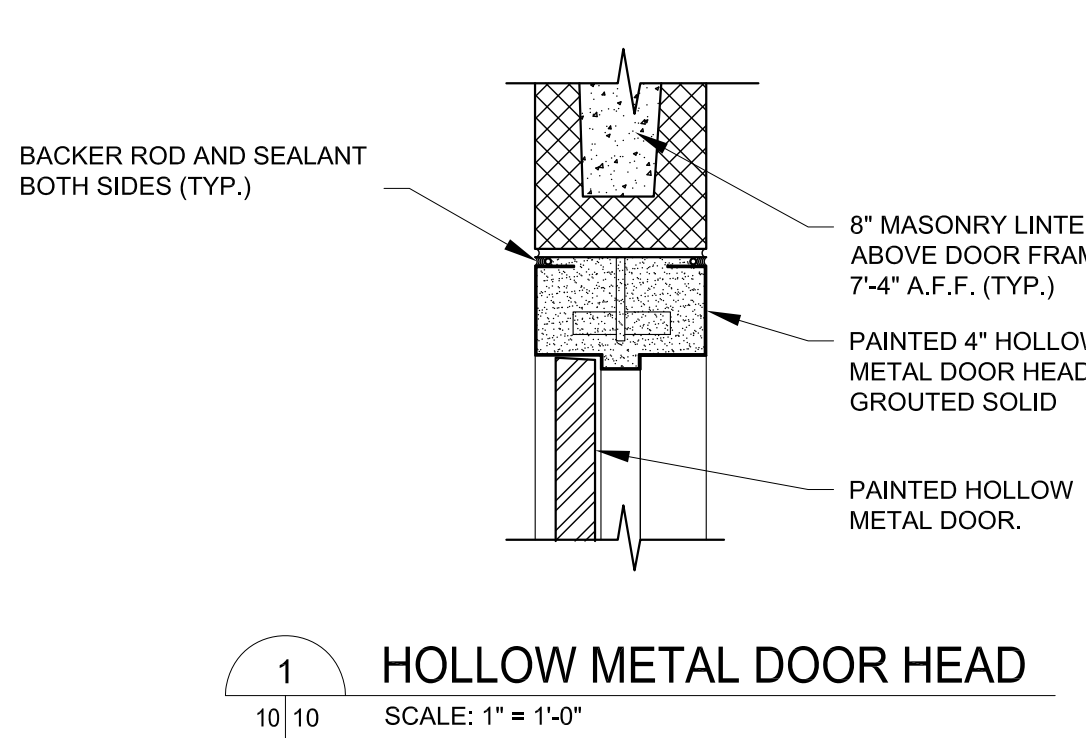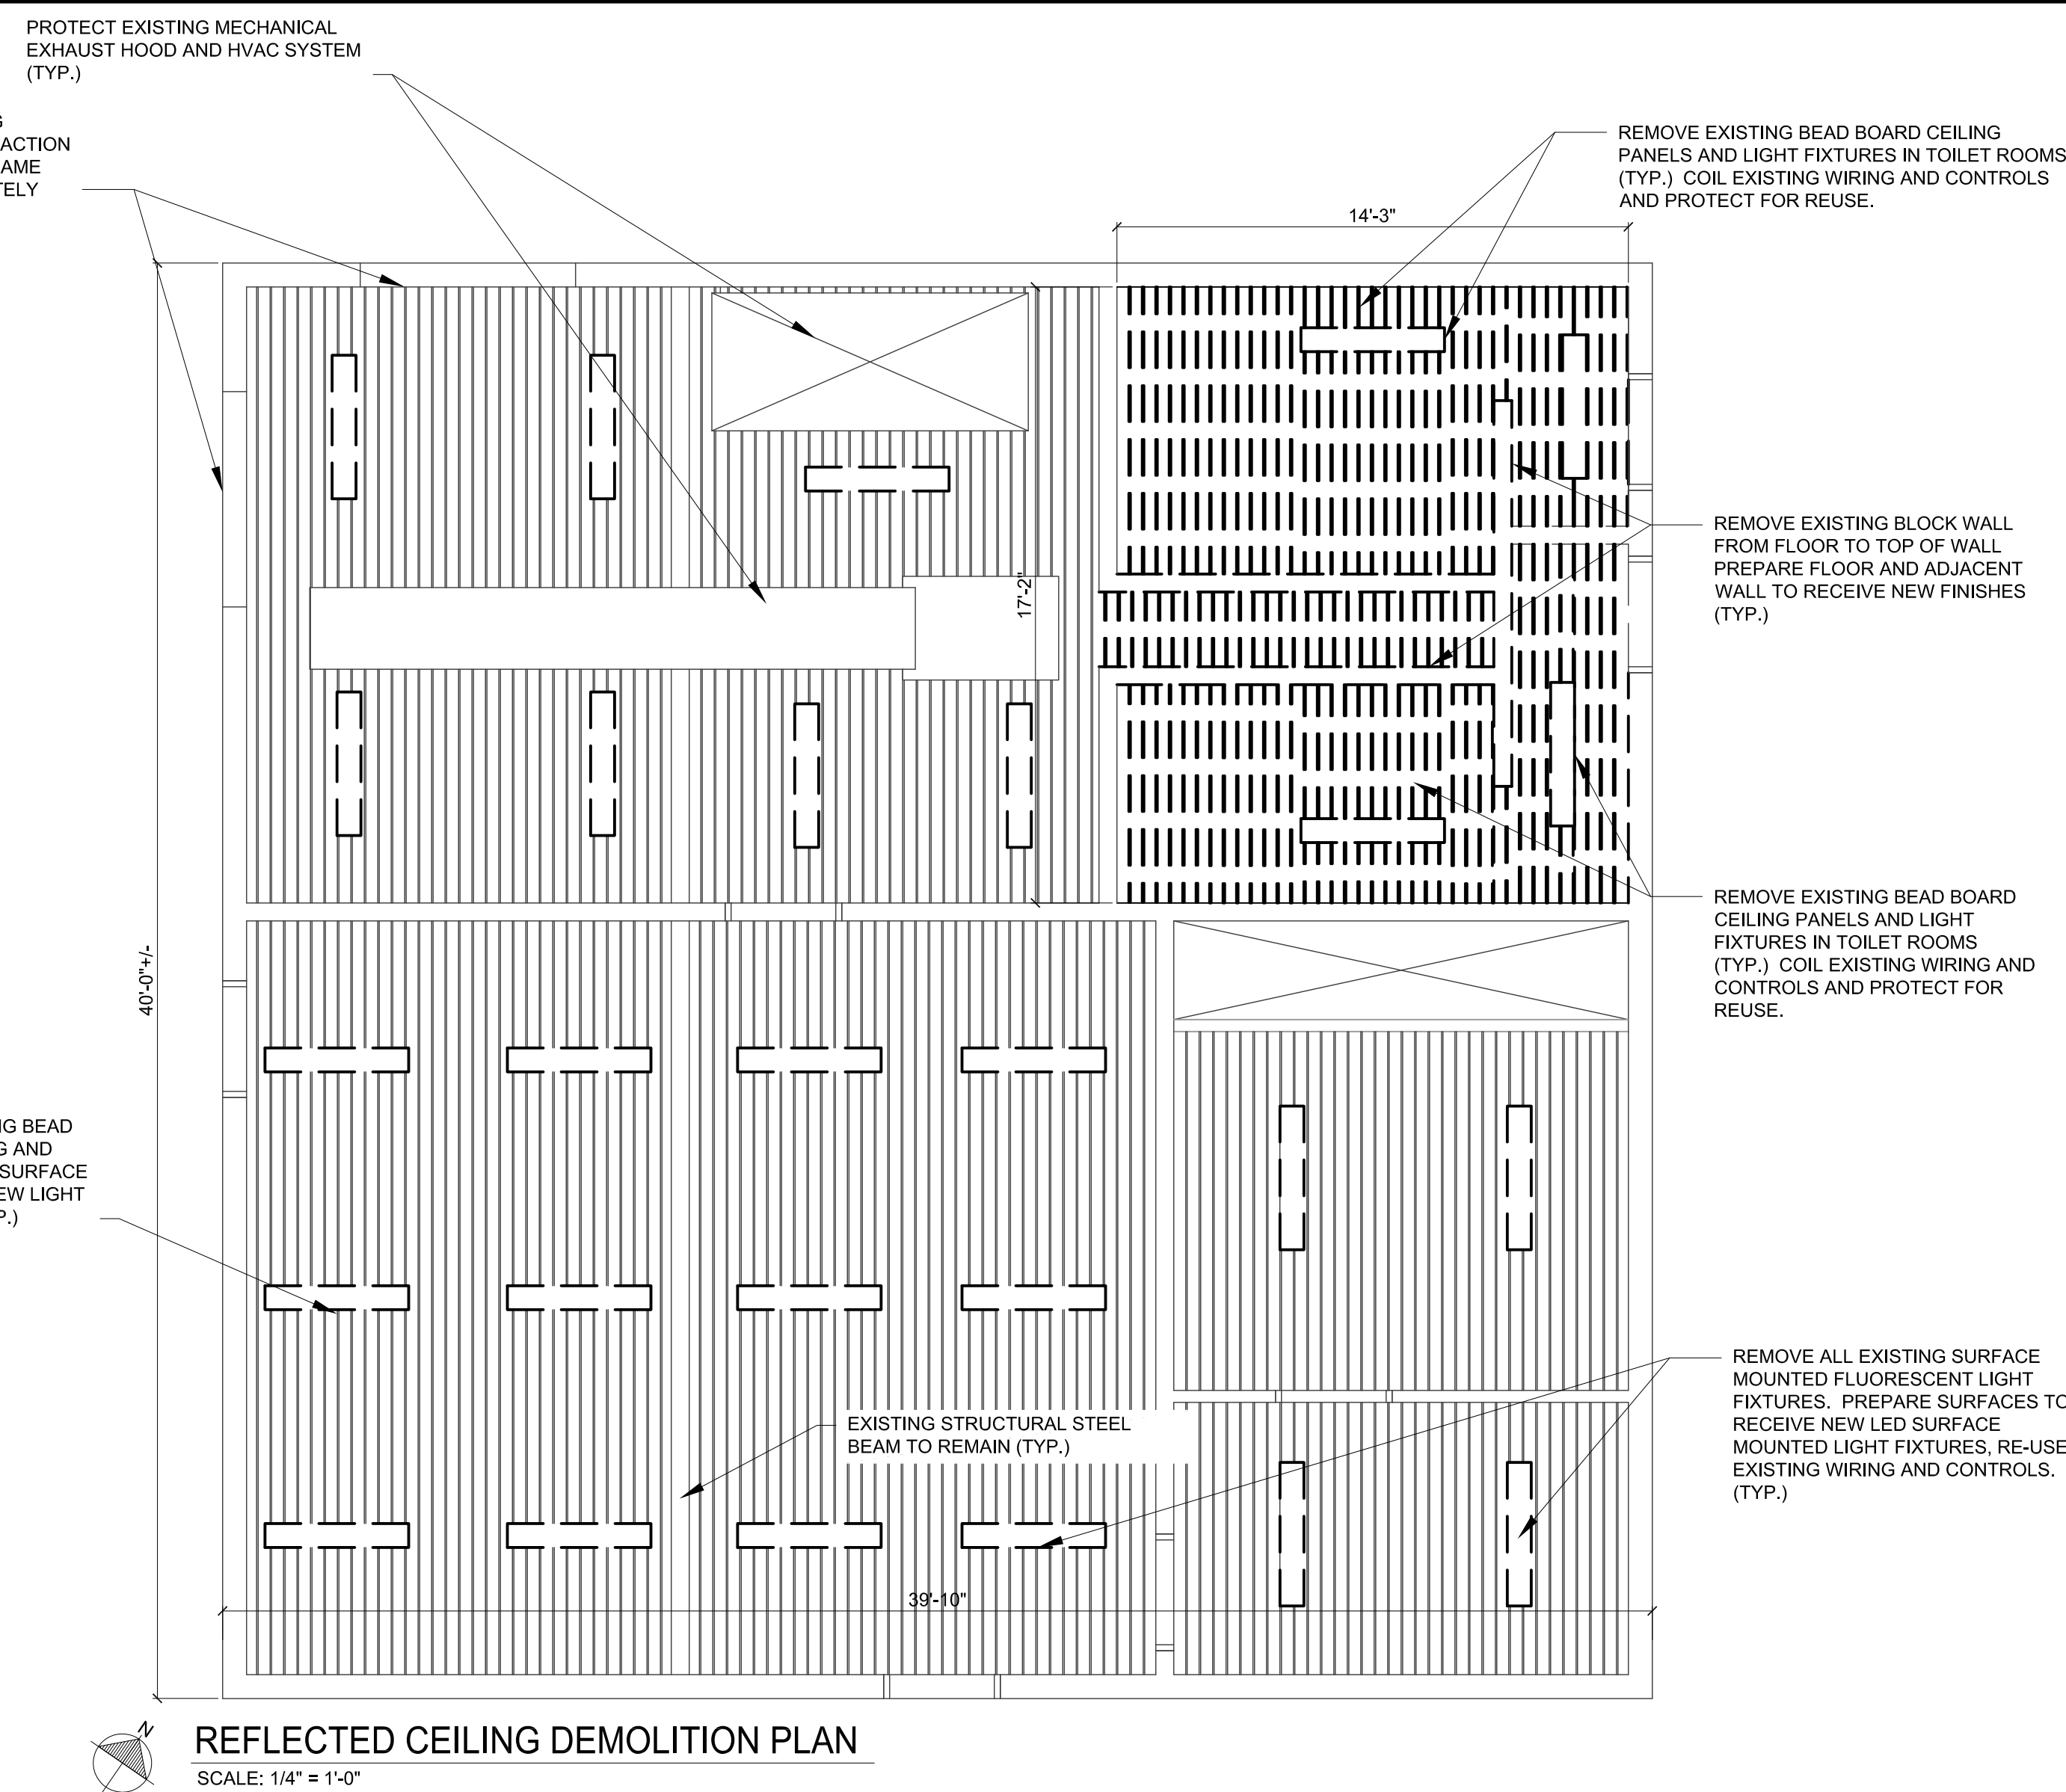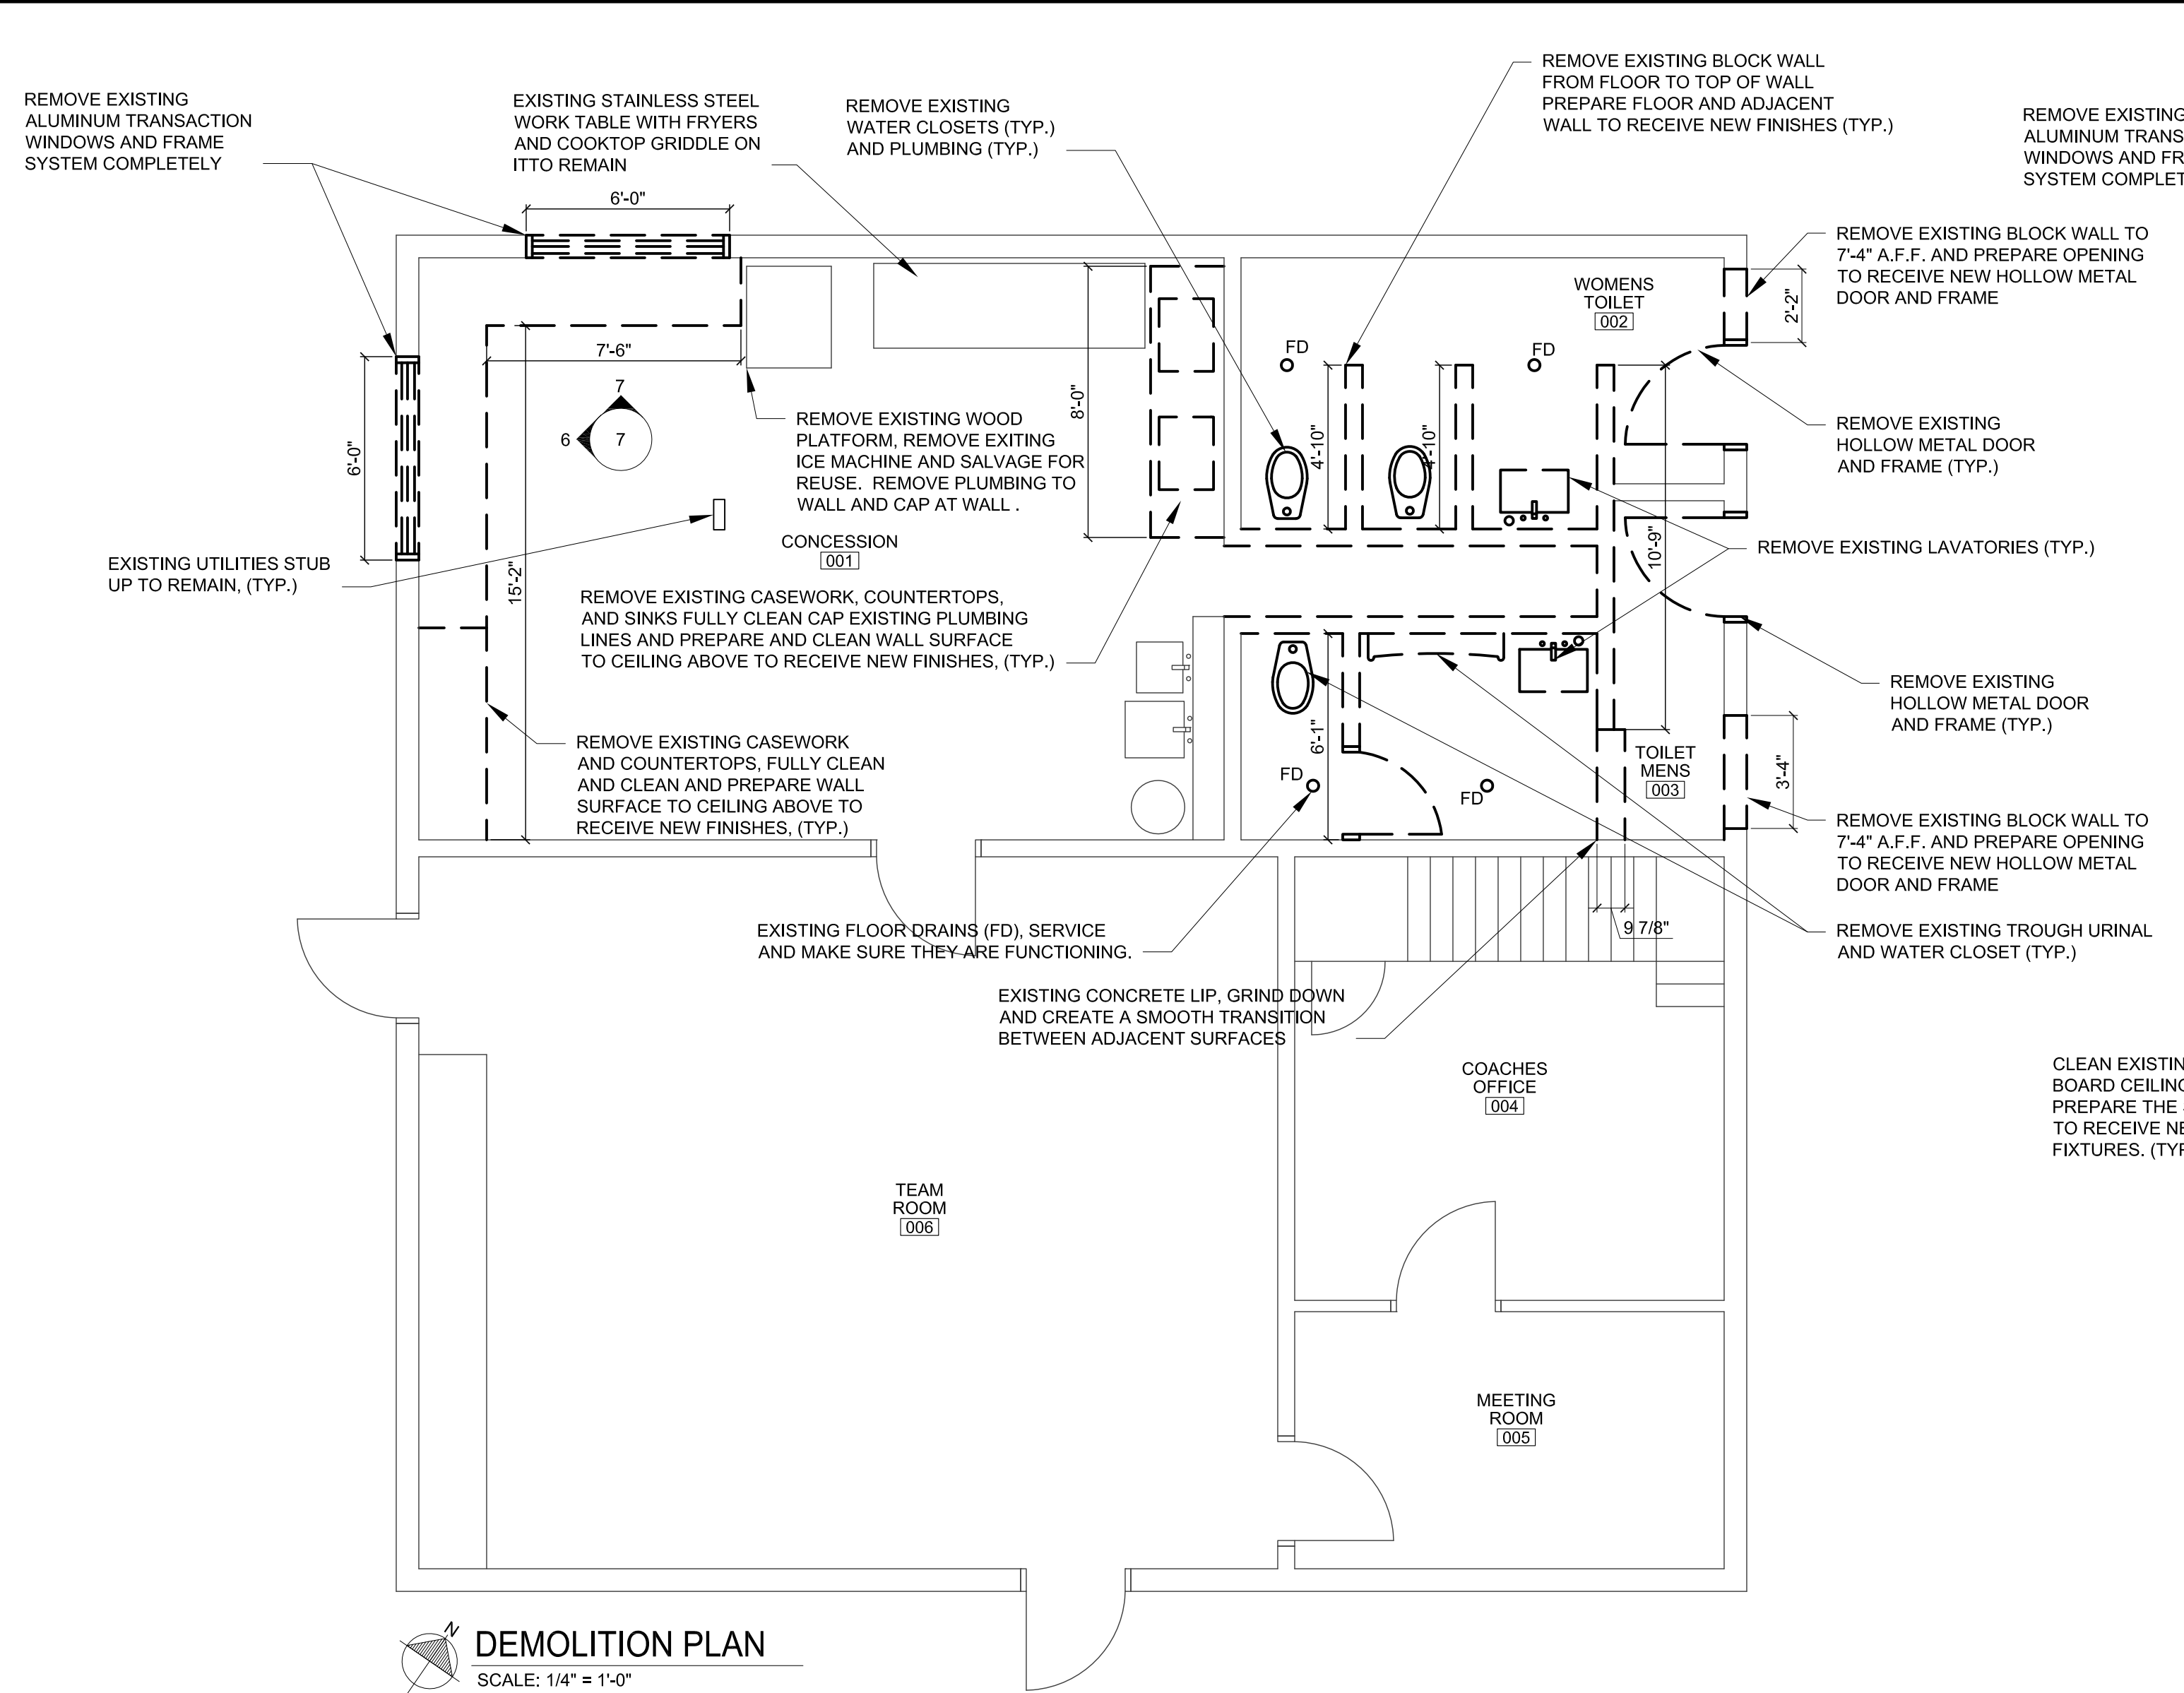
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Metairie, Louisiana 70002

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KENILWORTH PLAYGROUND
NEW ORLEANS, LOUISIANA

BUILDING DEMOLITION PLAN





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CHECKED BY: LHJ
DRAWN BY: LHJ

PROJ. NO. 15-190
DATE 03-29-2017
SHEET NO. **10**
OF 17 SHEETS

TIME: 4:20 PM

DATE: 4/14/2017


FILE: H:\Project Files\2015\15-190 Multiple NORDD Playgrounds\Kenilworth\Kenilworth Toilet room plans.dwg

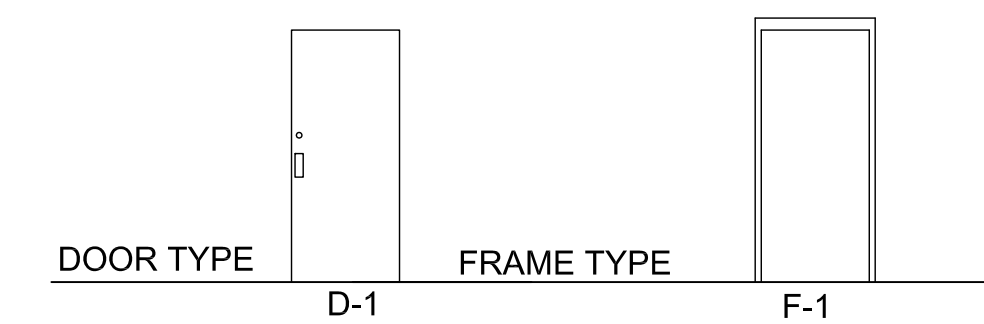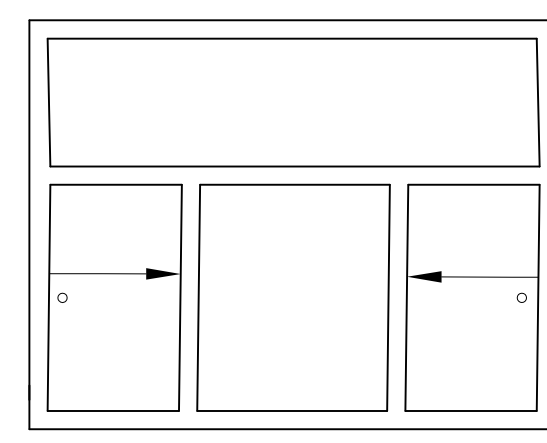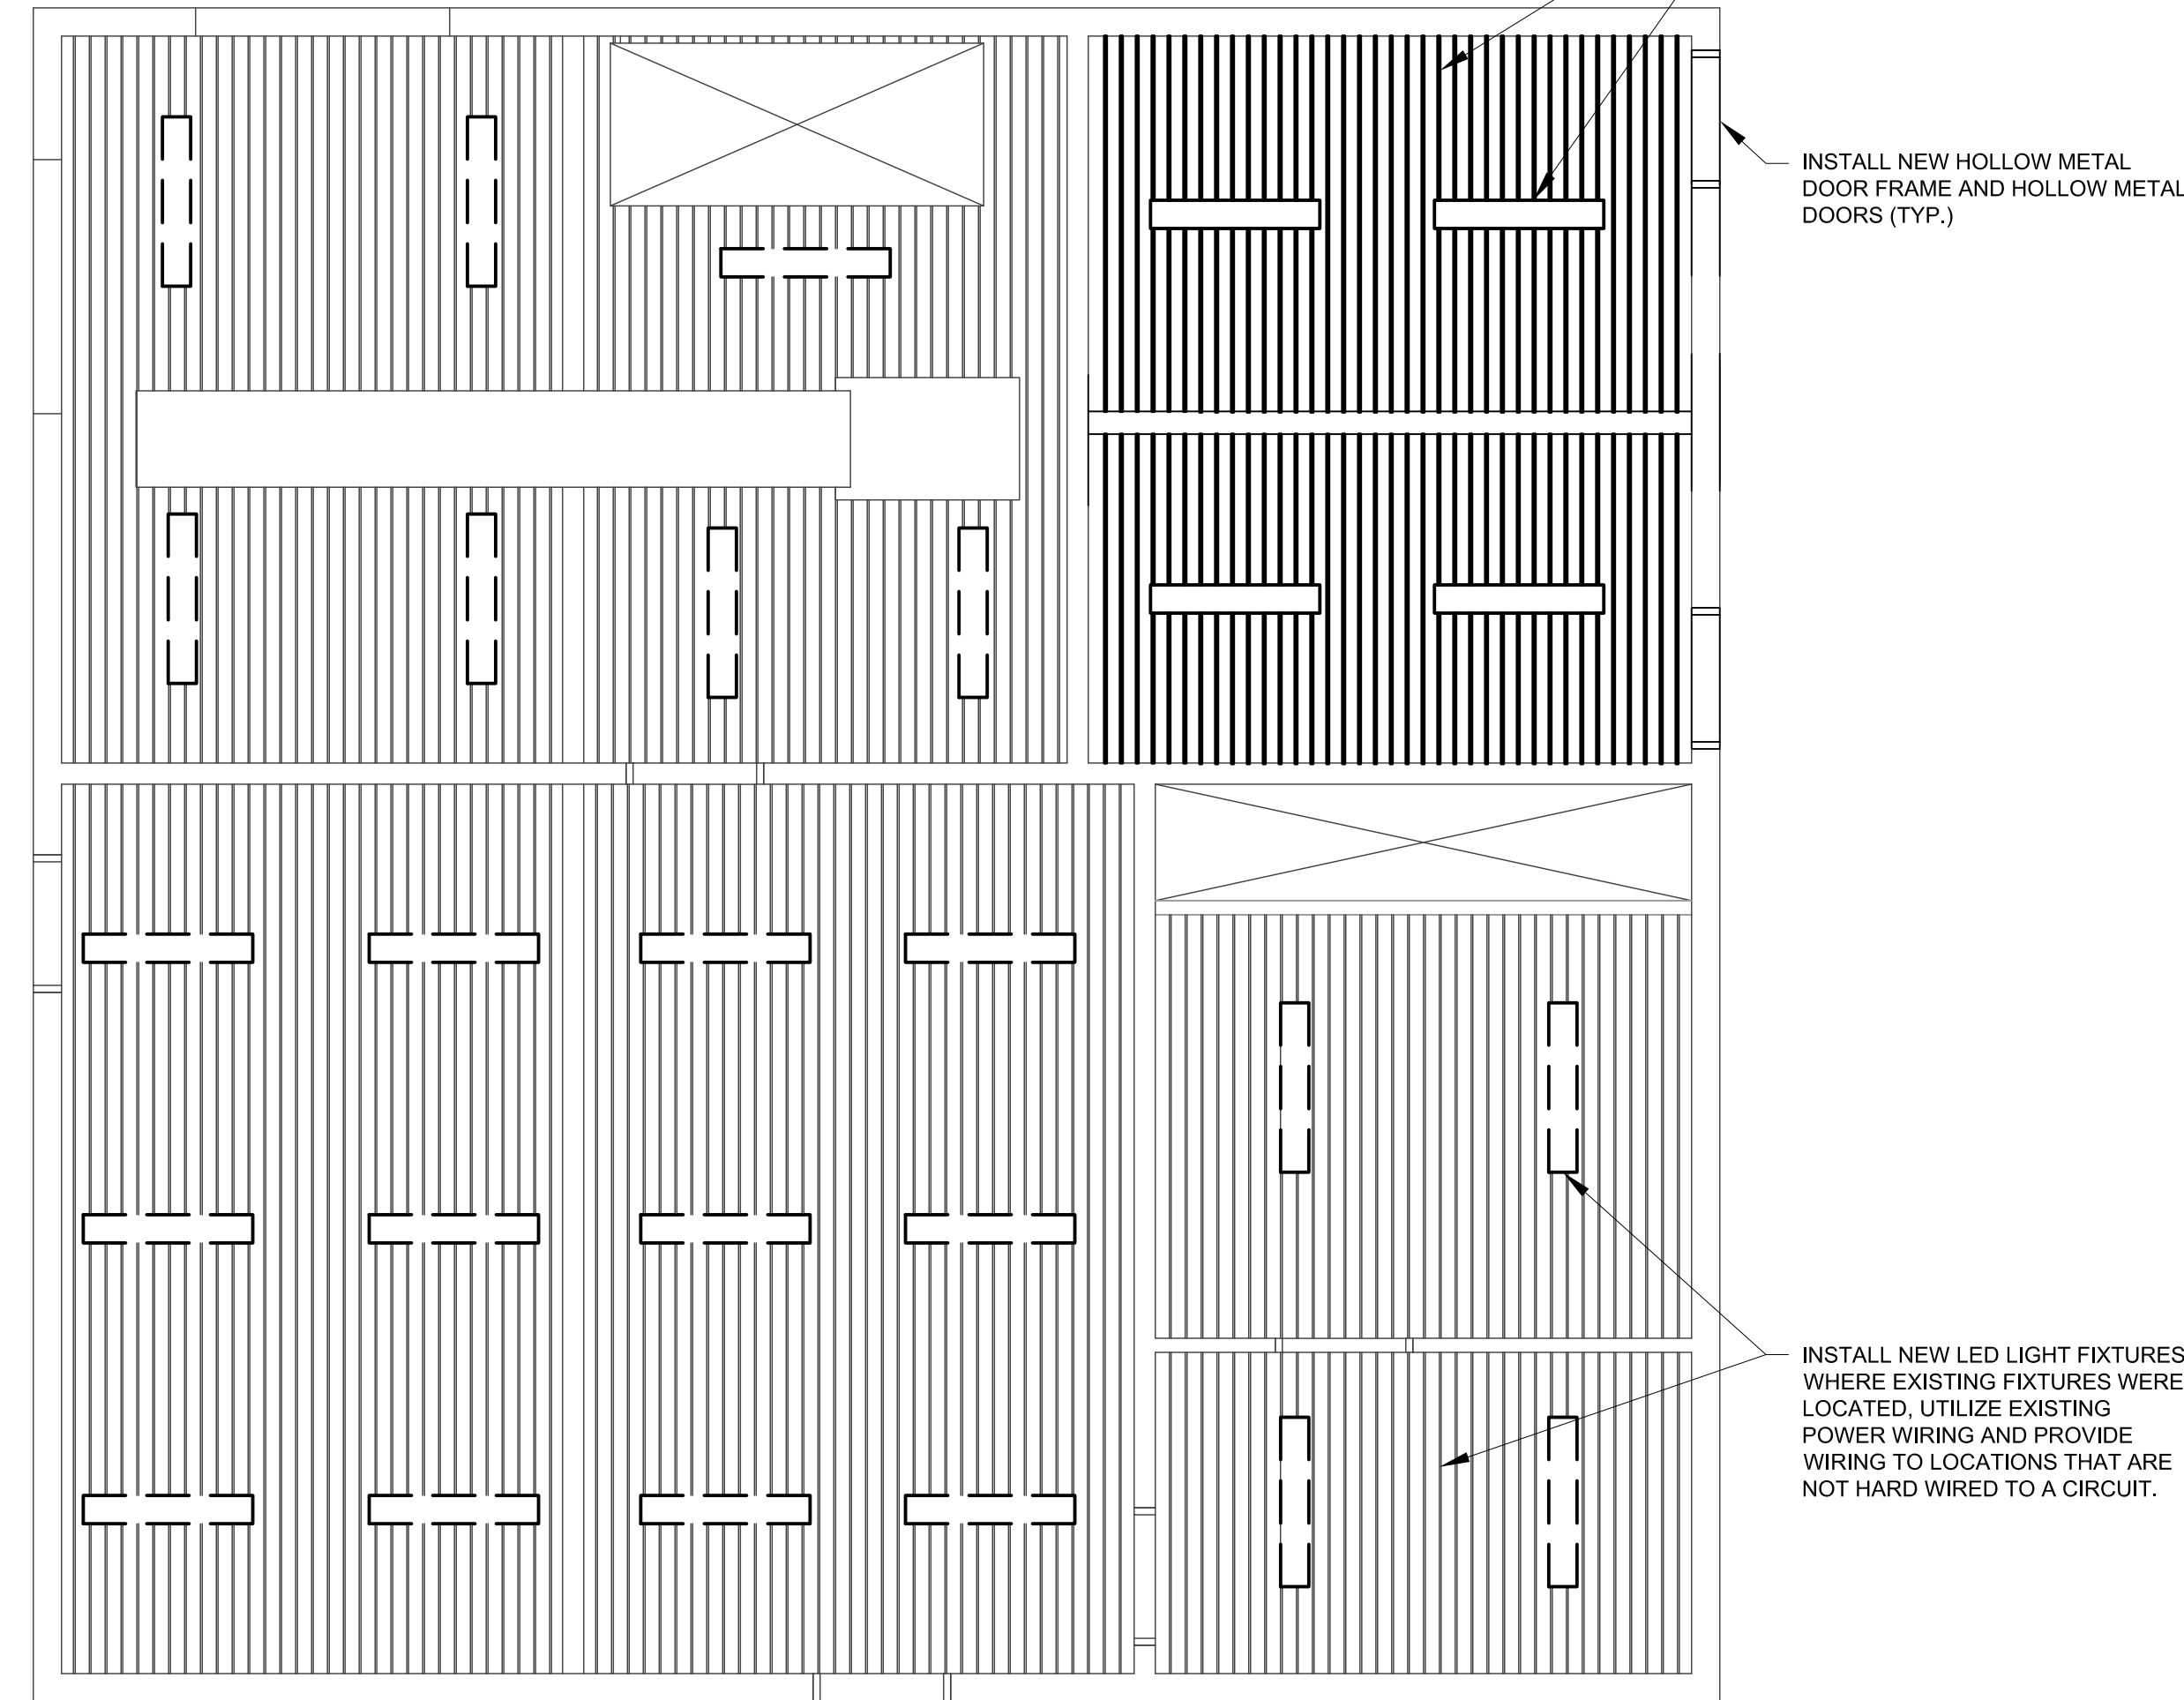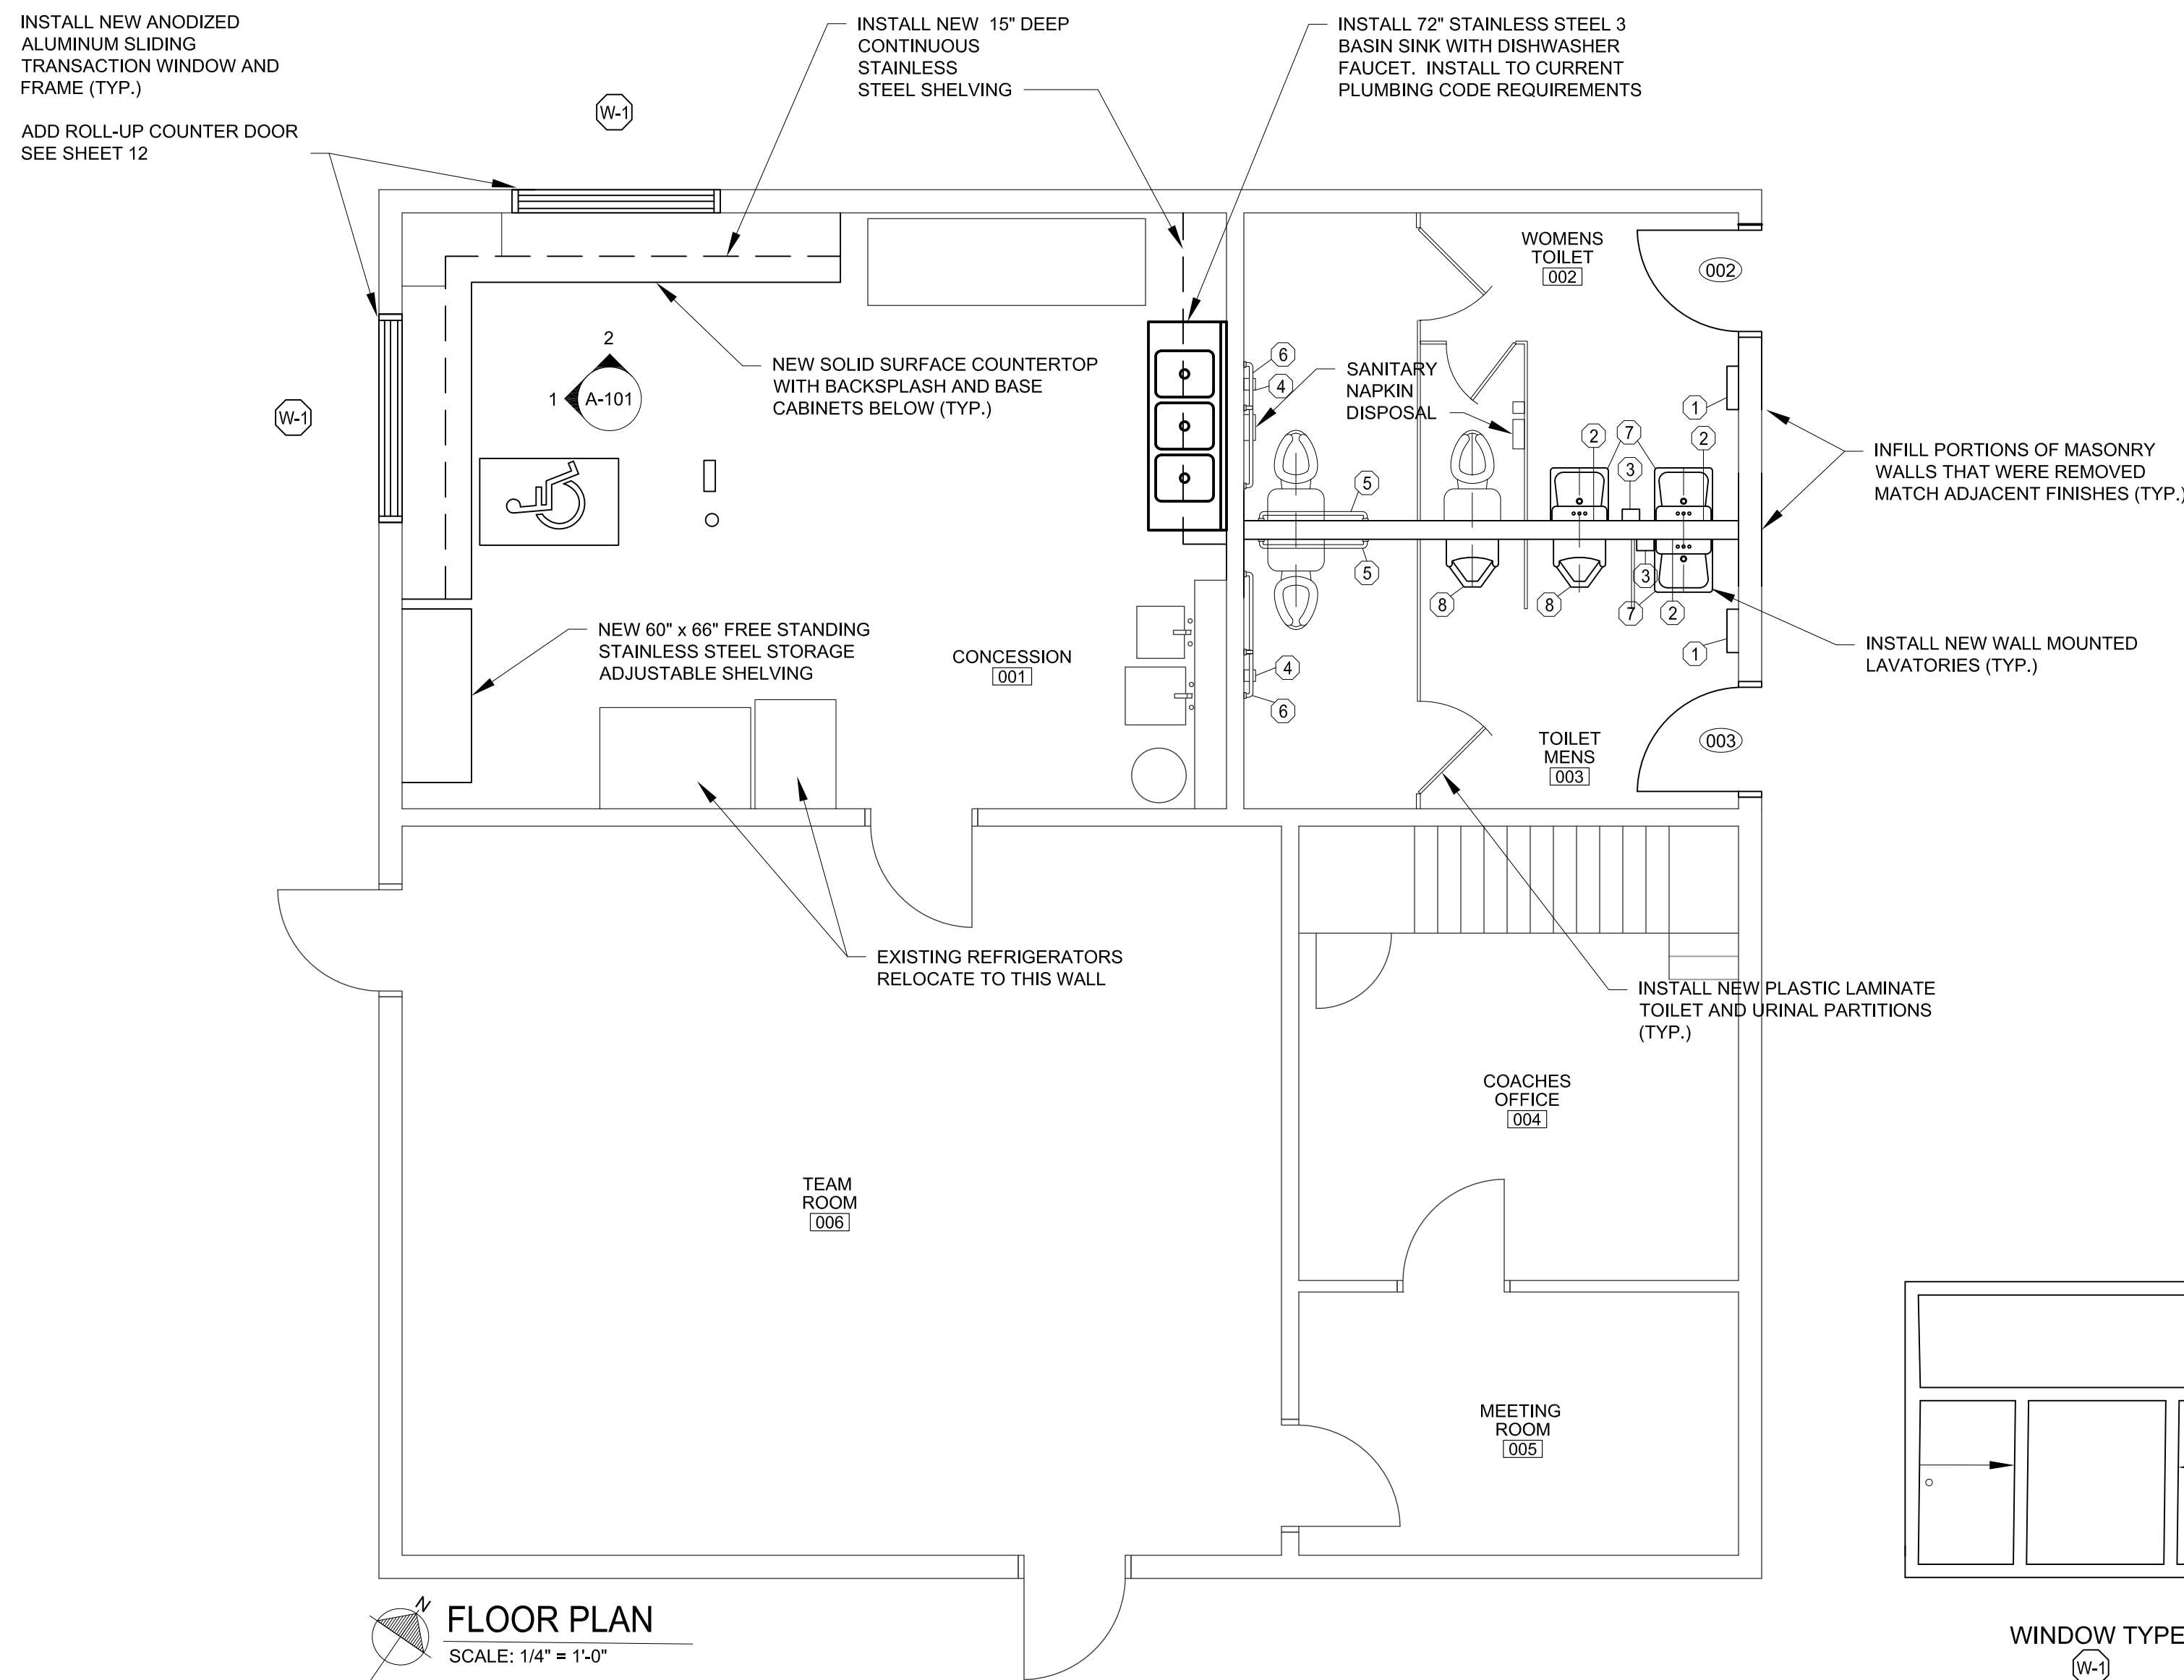

TOILET AND TOILET ACCESSORY MOUNTING HEIGHTS

FINISH FLOOR LINE	1	2	3	4	TYPICAL	5	6	7	8
	PAPER TOWEL DISPENSER AND WASTE RECEPTACLE	FRAMED MIRROR	SOAP DISPENSER	TOILET PAPER DISPENSER	WATER CLOSET	36" ADA GRAB BAR	42" ADA GRAB BAR	ADA LAVATORY	ADA URINAL
		HEIGHT OF MIRROR TO BE REFLECTIVE SURFACE			SEAT HEIGHT			MIN	MAX

NOTE: INSULATE PIPES BELOW ALL ACCESSIBLE LAVATORIES

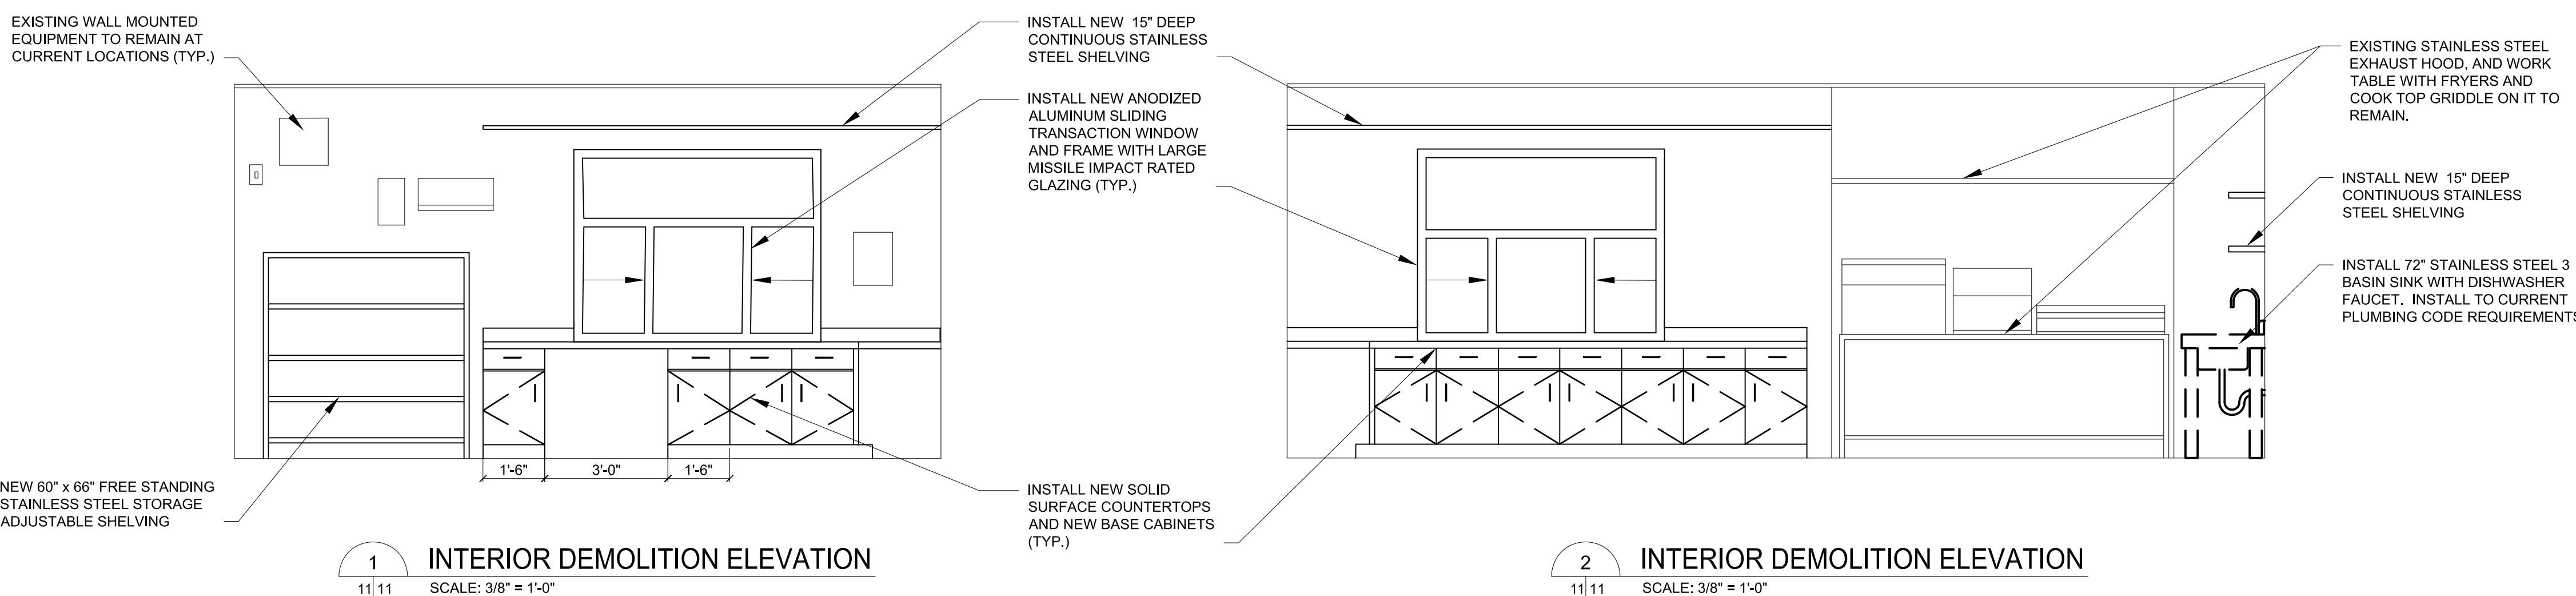

GENERAL CONSTRUCTION NOTES:

- THESE DRAWINGS ARE INTENDED TO OUTLINE THE SCOPE OF WORK REQUIRED TO PROVIDE A COMPLETE AND OPERABLE PROJECT CONCLUSION. ALL MISCELLANEOUS COMPONENTS, PARTS, PIECES, AND OTHER INCIDENTAL ITEMS NECESSARY TO PROVIDE A COMPLETED AND FUNCTIONAL SYSTEM AND PROJECT ARE TO BE PROVIDED WHETHER OR NOT SPECIFICALLY NOTED.
- THE CONTRACTOR SHALL REVIEW FOR COMPLIANCE WITH THE CONTRACT DOCUMENTS, APPROVE AND SUBMIT TO THE ARCHITECT SHOP DRAWINGS, PRODUCT DATA, SAMPLES, AND SIMILAR SUBMITTALS REQUIRED BY THE CONTRACT DOCUMENTS PRIOR TO SHIPPING TO THE ARCHITECT. THE CONTRACTOR'S REVIEW STAMP CONFIRMS COMPLIANCE WITH THE CONTRACT DOCUMENTS. ANY DEVIATIONS FROM THE CONTRACT DOCUMENTS ARE TO BE CLEARLY AND VISIBLY NOTED.
- CONTRACTOR IS NOT TO DEVIATE FROM THE CONTRACT DOCUMENTS, INDUSTRY STANDARDS, OR EXPLICIT INSTRUCTIONS, DUE TO CONTRACTOR OMISSIONS DURING THE CONSTRUCTION PROCESS, WITHOUT AUTHORIZATION FROM THE ARCHITECT AND/OR ENGINEER. CONTRACTOR IS RESPONSIBLE TO FURNISH THE COMPLETE PROJECT AS ORIGINALLY INTENDED WITHIN THE CONTRACT DOCUMENTS.
- ALL CONSTRUCTION SHALL APPLY TO MOST STRINGENT REQUIREMENTS OF ALL CURRENT APPLICABLE CITY/STATE/AND FEDERAL LAWS, CODES, AND REGULATIONS. IF GENERAL CONTRACTOR OR ANY SUBCONTRACTOR PERFORMS ANY WORK IN CONFLICT WITH AFOREMENTIONED LAWS, CODES, AND REGULATIONS, THEN THE CONTRACTOR IN VIOLATION SHALL BEAR ALL COSTS OF REPAIR ARISING FROM THE NON-CONFORMING WORK.
- ALL AREAS WHERE ITEMS WERE REMOVED ARE TO BE PATCHED AND REPAIRED, MATCH EXISTING ADJACENT FINISHES LIKE IN KIND. (TYP.)
- PRIOR TO SUBSTANTIAL COMPLETION CONTRACTOR IS TO CLEAN ALL WALL, FLOOR, COOKING EQUIPMENT, AND CEILING SURFACES. (TYP.)
- REMOVE EXISTING PLUMBING LINES AS REQUIRED TO INSTALL NEW FIXTURES. REMOVE ANY UNUSED PORTIONS OF EXISTING PLUMBING LINES NO LONGER REQUIRED. PROVIDE NEW CONDENSATE DRAINAGE PLUMBING FROM HVAC SYSTEM TO NEW DRAIN LINES.
- INSTALL NEW 3/4" FLOOR SHEATHING IN ATTIC. SHEATHING SHALL COVER ENTIRE ATTIC FLOOR SURFACE.
- UTILIZE EXISTING ROOF PENETRATIONS AS REQUIRED FOR NEW CONSTRUCTION.
- PROTECT ALL EXISTING ITEMS, EQUIPMENT, AND SYSTEMS FROM DAMAGE DURING CONSTRUCTION. CONTRACTOR WILL BE RESPONSIBLE FOR REPLACING ANY REMAINING ITEMS OR SYSTEMS DAMAGED DURING CONSTRUCTION AT CONTRACTORS COST.
- CONTRACTOR TO MAINTAIN A CLEAN JOB SITE DURING CONSTRUCTION REMOVING DEBRIS AND RUBBISH TO BIN DAILY.
- PROTECT EXISTING SURFACES FROM DAMAGE DURING CONSTRUCTION. ANY SURFACES THAT ARE DAMAGED DURING CONSTRUCTION ARE TO BE PATCHED AND REPAIRED TO MATCH ADJACENT SURFACES LIKE AND KIND.
- CONTRACTOR TO PROVIDE AND INSTALL NEW LED UTILITY STRIP LIGHT FIXTURES USING EXISTING WIRING AND CONTROLS.
- PROTECT EXISTING HVAC SYSTEM AND DUCTWORK FROM DAMAGE DURING CONSTRUCTION. PRIOR TO SUBSTANTIAL COMPLETION CLEAN ALL DUCTWORK, GRILLES, AND SUPPORTS COMPLETELY.
- CLEAN AND PAINT ALL INTERIOR WALLS AND CEILING.
- PROVIDE AND INSTALL NEW STAINLESS STEEL COMMERCIAL SHELVING.
- PROVIDE AND INSTALL NEW STAINLESS STEEL COMMERCIAL STORAGE RACK.
- RELOCATE EXISTING REFRIGERATORS TO NEW LOCATIONS AS SHOWN, PROVIDE UTILITIES AT THESE LOCATIONS AS REQUIRED.
- PROVIDE AND INSTALL NEW COMMERCIAL GRADE ICE MAKER AT LOCATION AS SHOWN. UTILIZE EXISTING UTILITIES AT THOSE LOCATIONS.
- PROVIDE AND INSTALL 34" SOLID SURFACE COUNTERTOPS AND 4" SOLID SURFACE BACK SPLASH, WITH PLASTIC LAMINATE VENEERED BASE CABINETS AS SHOWN IN THESE DRAWINGS.
- INSTALL NEW CMU WALLS AS SHOWN IN THE PLANS, PROVIDE NEW PLUMBING AND FIXTURES AS SHOWN IN DRAWINGS.


DOOR SCHEDULE

DOOR NO.	DOOR SIZE	DOOR				DOOR FRAME				FIRE RATING	HARDWARE SET	REMARKS	
		MAT.	TYPE	FIN.		MAT.	TYPE	FIN.	HEAD				JAMB
002	3'-0"x7'-0"x1 3/4"	HM	D-1	PNT.	HM	F-1	PNT.	1/7	2/7	3/7		XX	HEAVY DUTY TOILET ROOM DOORS TO PARK TOILET ROOMS
003	3'-0"x7'-0"x1 3/4"	HM	D-1	PNT.	HM	F-1	PNT.	1/7	2/7	3/7		XX	HEAVY DUTY TOILET ROOM DOORS TO PARK TOILET ROOMS

OPENING SCHEDULE

WINDOW NO.	WINDOW SIZE	FRAME				FIRE RATING	REMARKS		
		MAT.	TYPE	FIN.	HEAD			JAMB	SILL
W-1	4'-8"x6'-0"	ALUM.	W-1	ANOD.	4/7	5/7	5/7	N/A	SLIDING LOCKABLE TRANSACTION WINDOW SEE ELEVATION

LINFIELD, HUNTER & JUNIUS, INC.
PROFESSIONAL ENGINEERS, ARCHITECTS
AND SURVEYORS
3608 18th Street, Suite 200
Metairie, Louisiana 70002

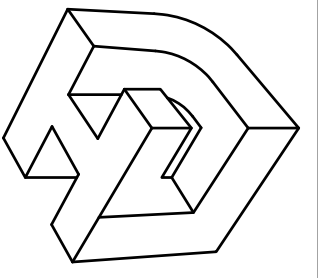

SEAL

REV. NO.	DATE

KENILWORTH PLAYGROUND
NEW ORLEANS, LOUISIANA

APPROVED BY: LHJ
CHECKED BY: LHJ
DRAWN BY: LHJ

PROJ. NO. 15-190

DATE 03-29-2017


SHEET NO.

1 1


OF 17 SHEETS




1 EXTERIOR ROOF PICTURE
12 12 SCALE: N/A

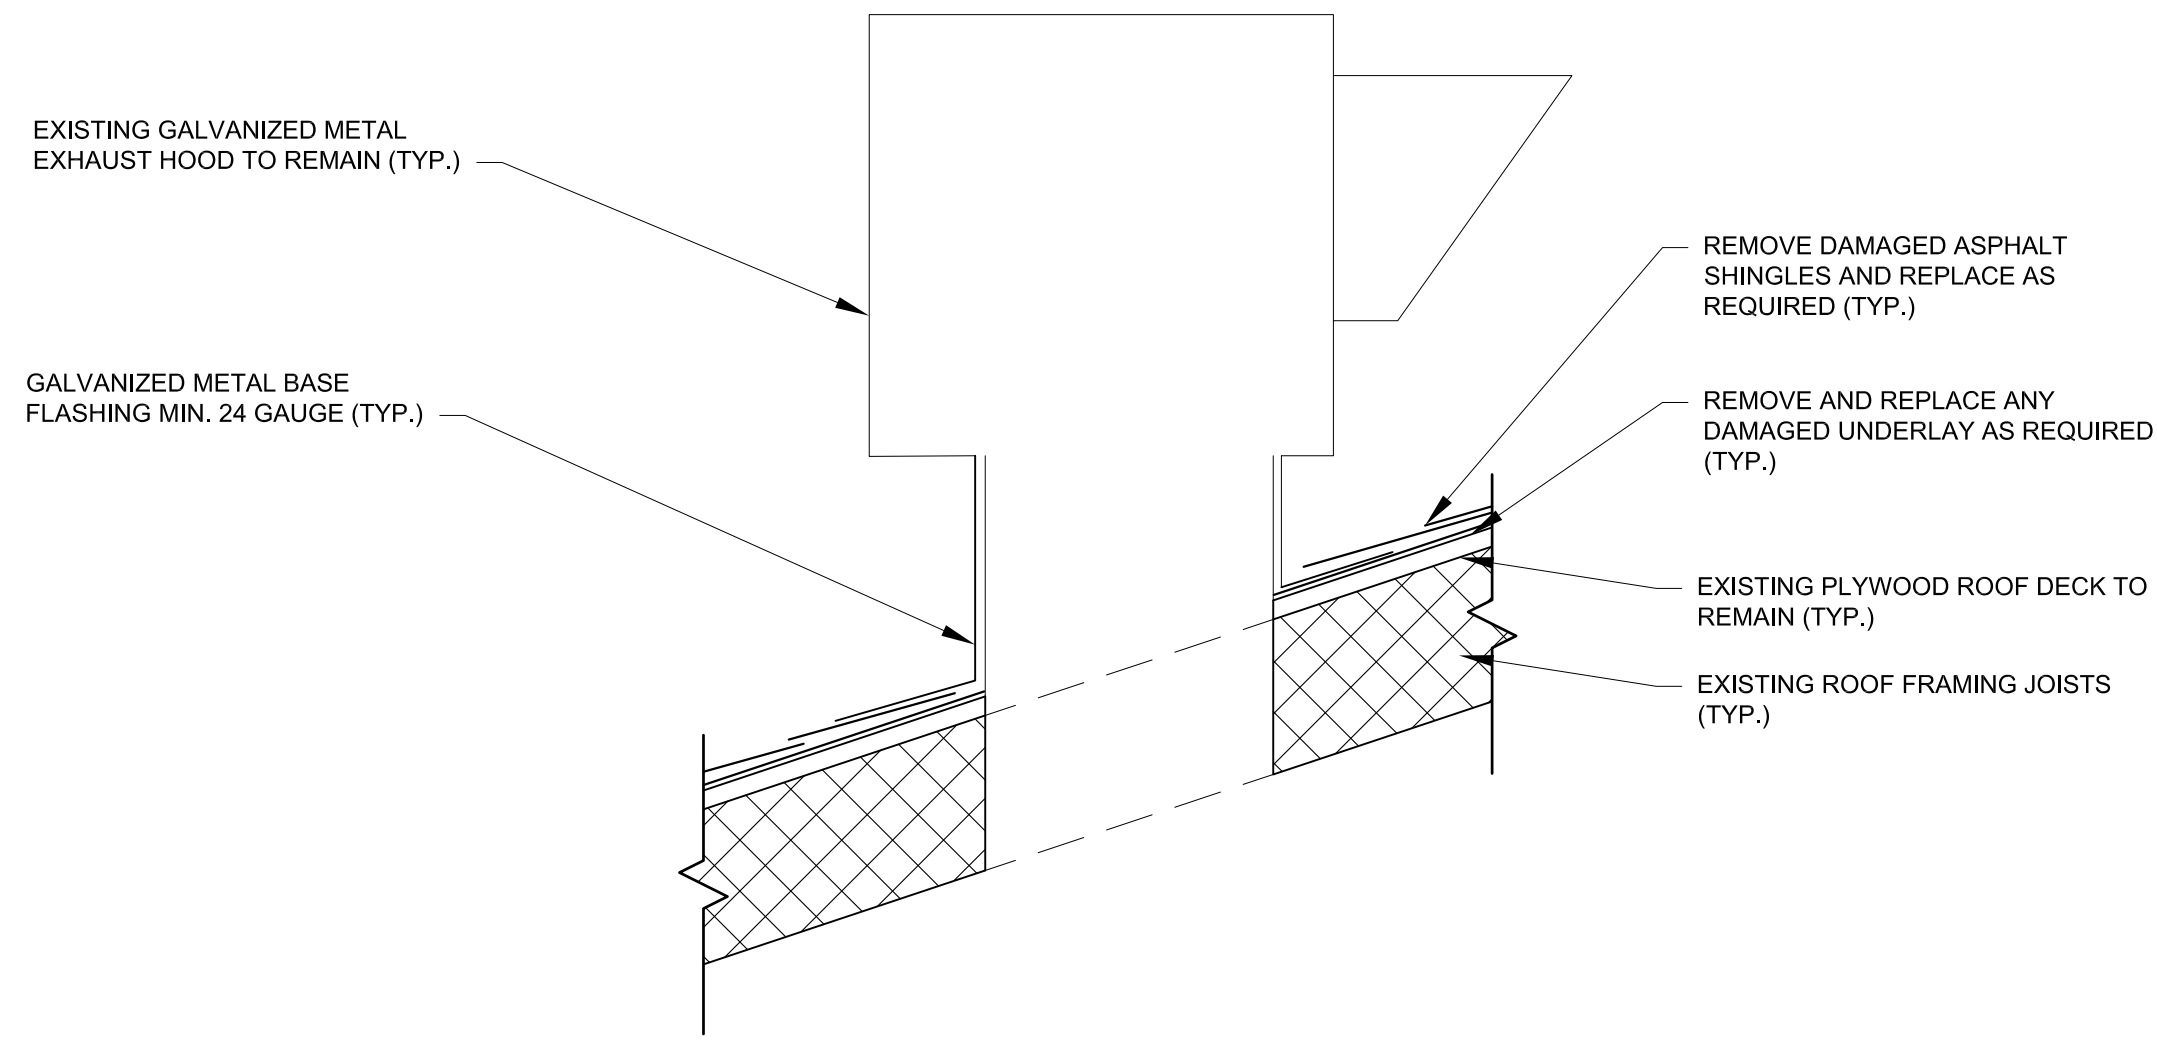

2 ROOF REPAIR DETAIL
12 12 SCALE: 3/8" = 1'-0"

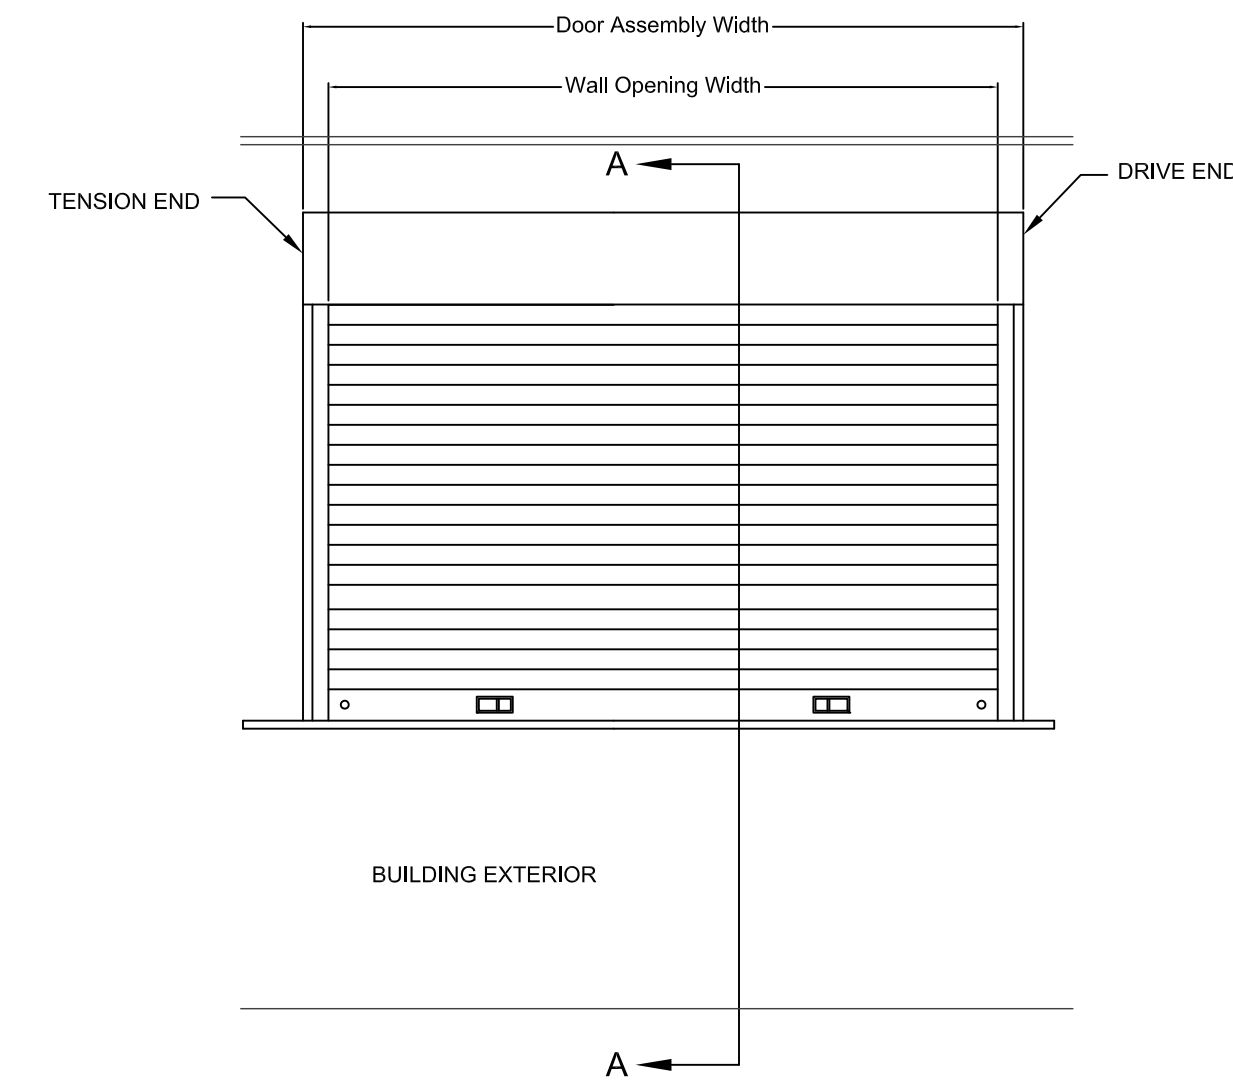


3 ROLL-UP COUNTER DOOR
12 12 SCALE: 1/2" = 1'-0"

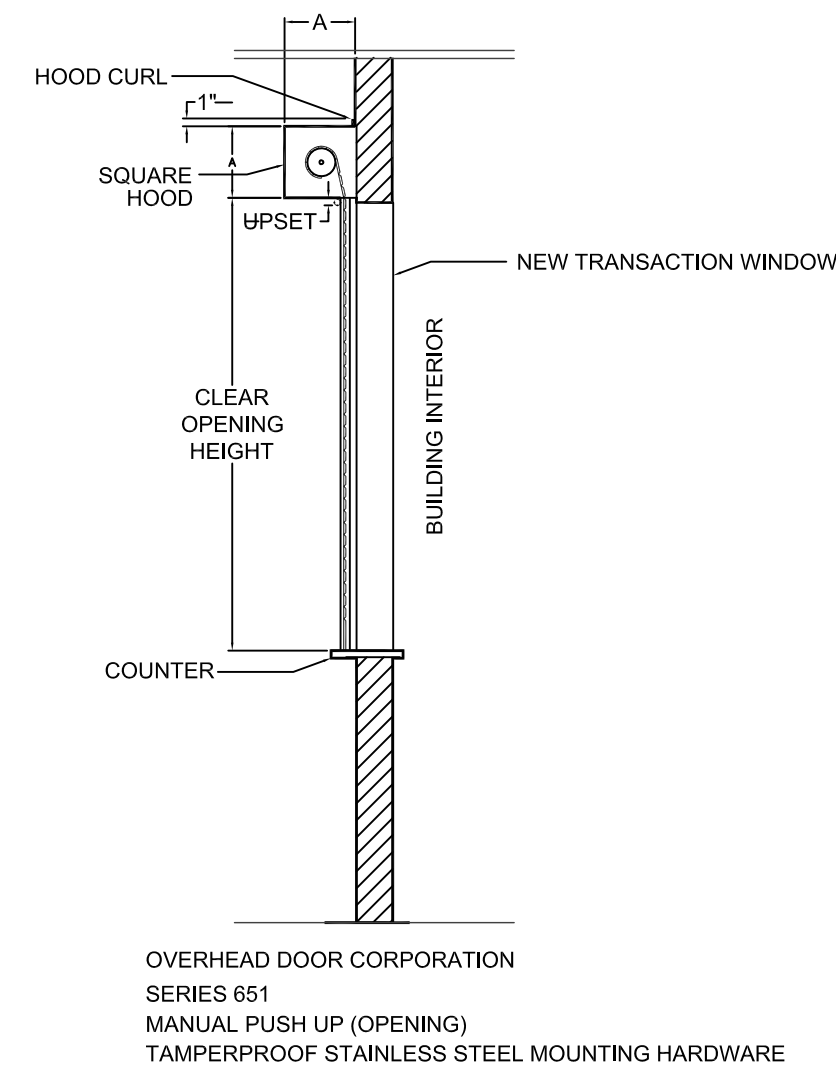

4 SECTION A-A ROLL-UP COUNTER DOOR
12 12 SCALE: 1/2" = 1'-0"

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SEAL

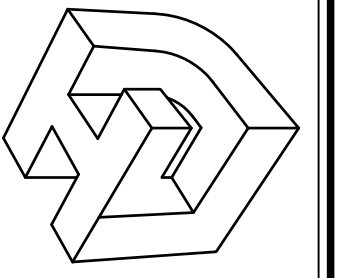REV. NO.	DATE

KENILWORTH PLAYGROUND
NEW ORLEANS, LOUISIANA

THIS SHEET
ROOF REPAIR
DRAWN BY L.H.J.
CHECKED BY L.H.J.
APPROVED BY L.H.J.

PROJ. NO. 15-190
DATE 03-29-2017


SHEET NO.
12
OF 17 SHEETS

MARTIN DRIVE

WALES STREET

REDFISH STREET

CURRAN BOULEVARD

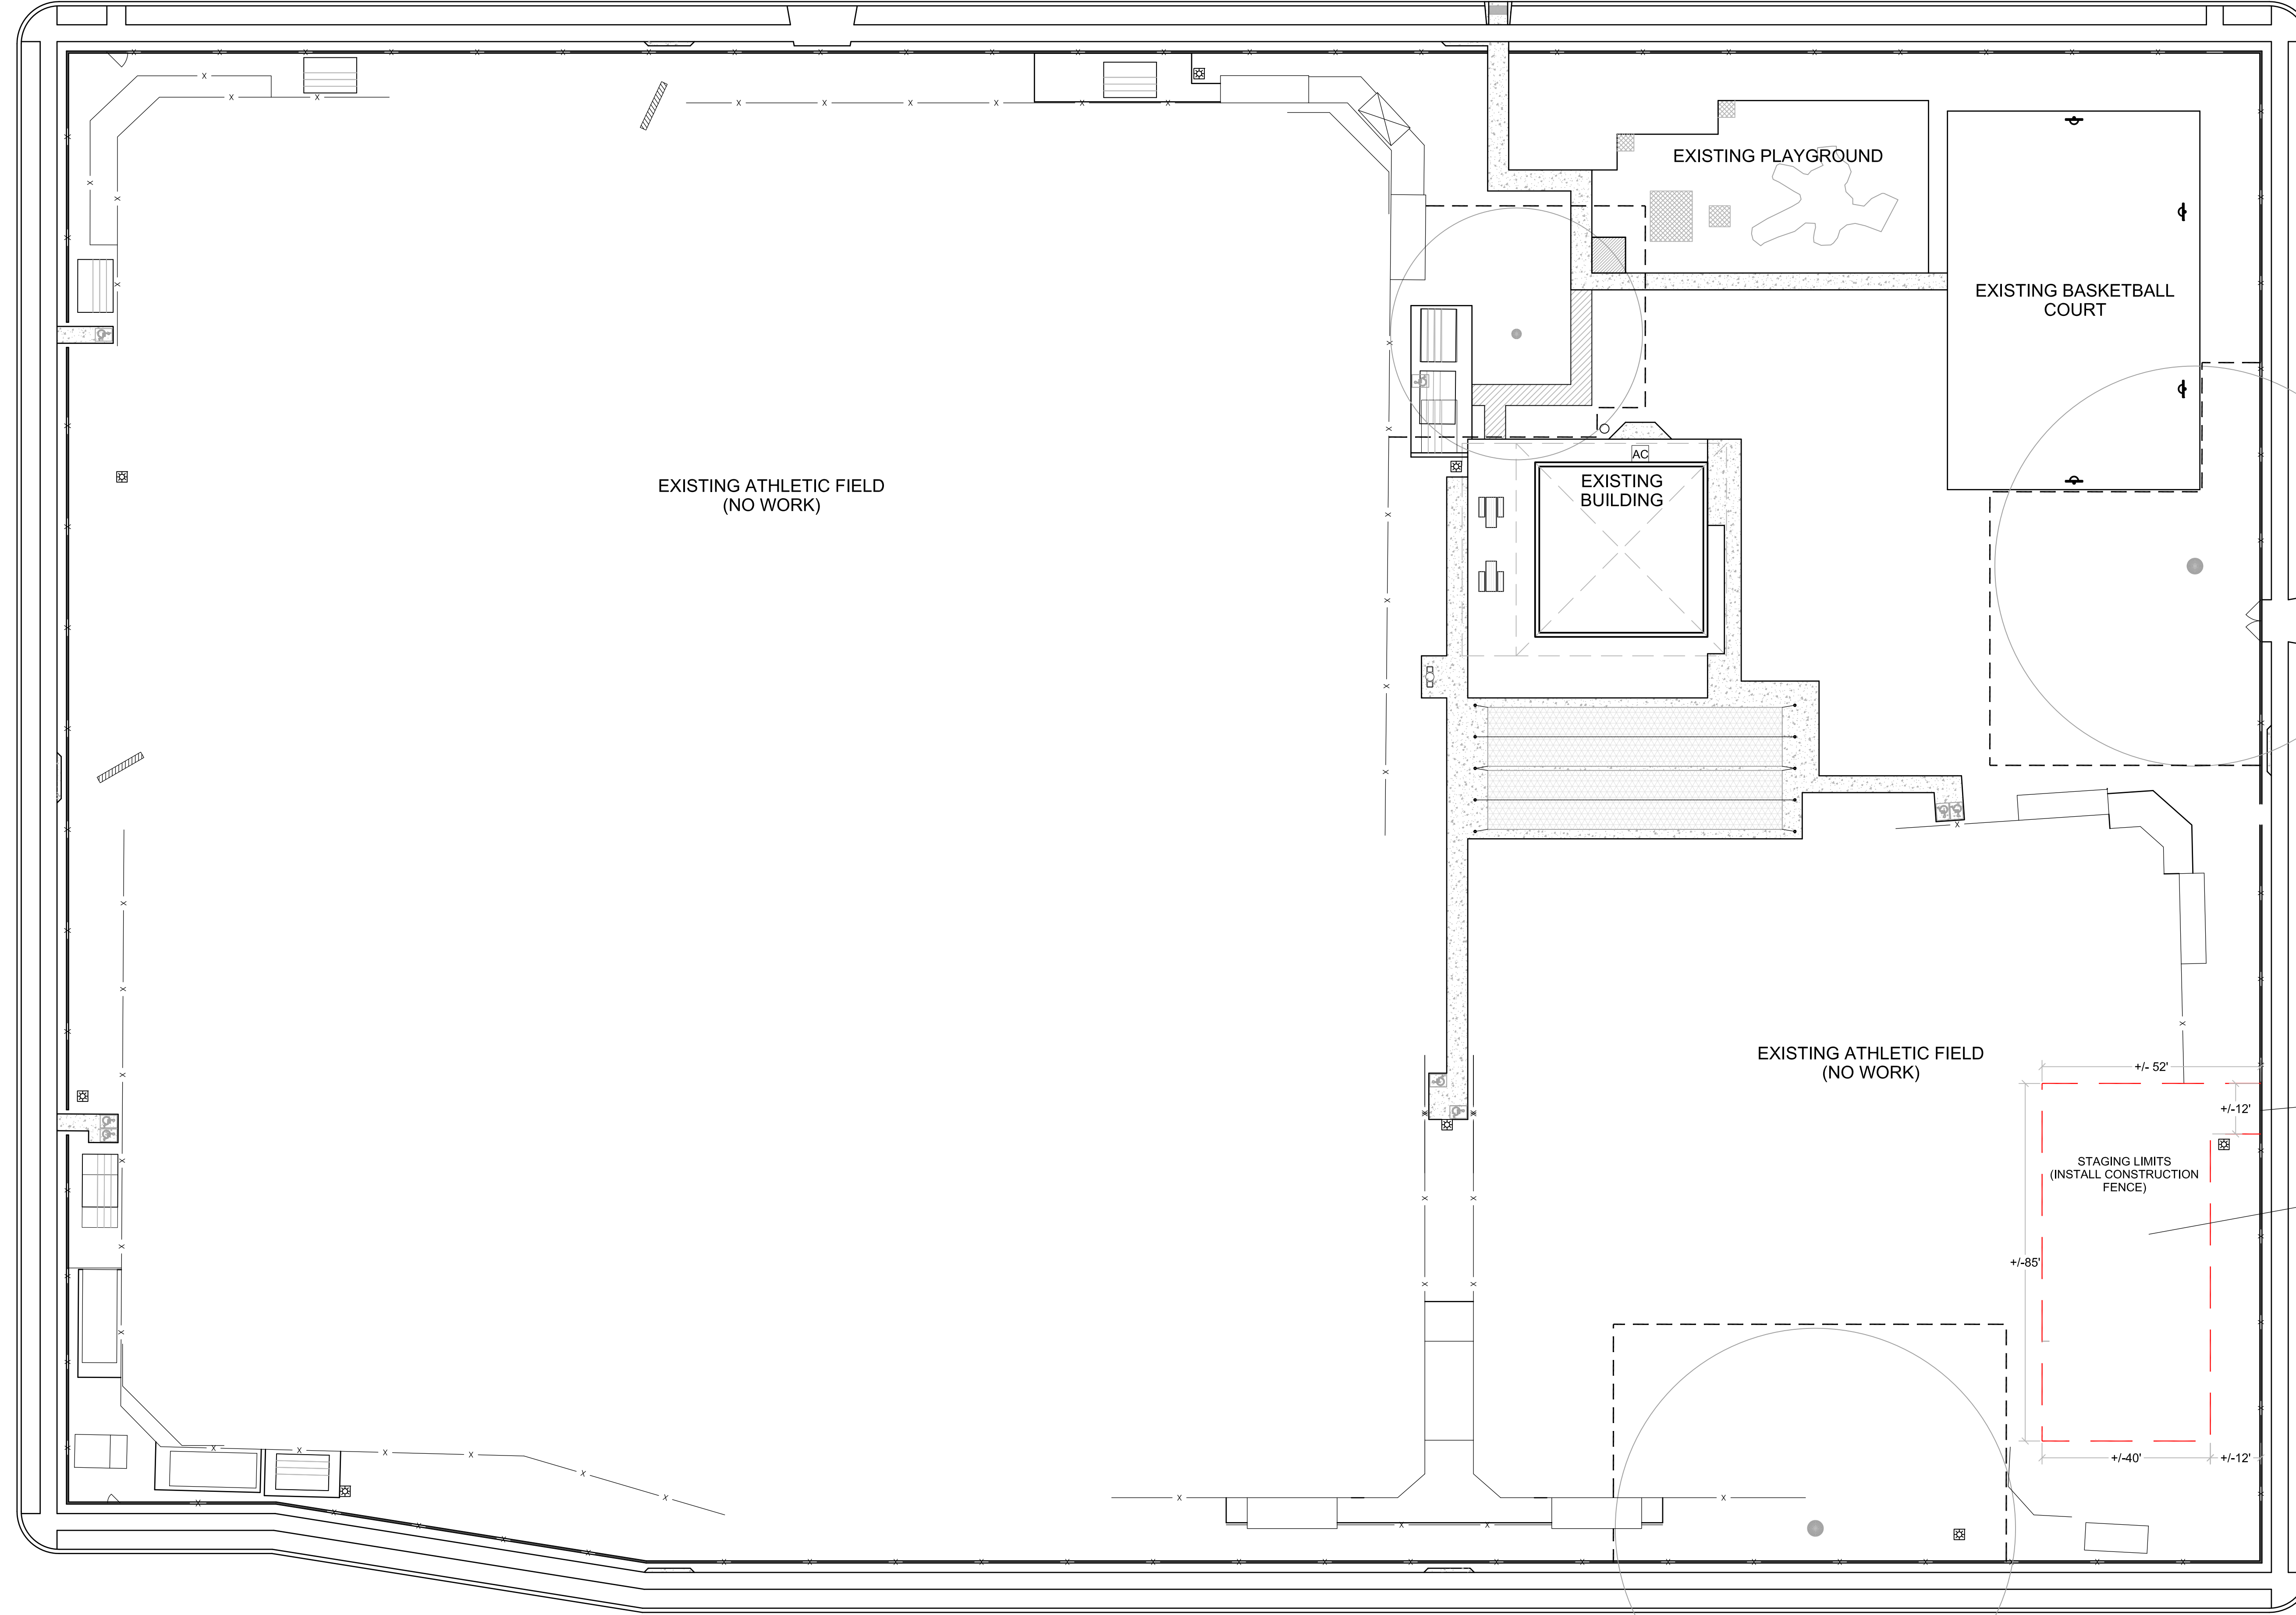

EXISTING ATHLETIC FIELD
(NO WORK)

EXISTING PLAYGROUND

EXISTING BASKETBALL COURT

EXISTING BUILDING


EXISTING ATHLETIC FIELD
(NO WORK)

STAGING LIMITS
(INSTALL CONSTRUCTION FENCE)


REMOVE CHAIN LINK FENCE
ADD TEMPORARY GATES
REPAIR FENCE ONCE
CONSTRUCTION IS COMPLETE

FILL, GRADE AND SEED
STAGING AREA ONCE
CONSTRUCTION IS COMPLETE

1 STAGING LIMITS PLAN
12 1" = 20'-0"

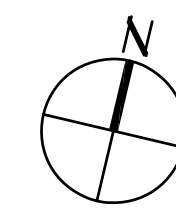

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SEAL

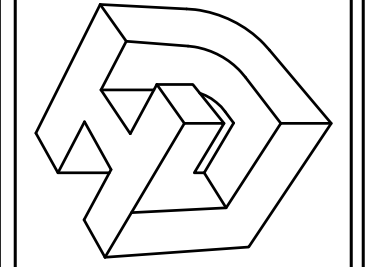REV. NO.	DATE

**KENILWORTH PLAYGROUND
NEW ORLEANS, LOUISIANA**


THIS SHEET
STAGING LIMITS PLAN
DRAWN BY
LHU

APPROVED BY
LHU

PROJ. NO. 15-190
DATE 03-29-2017
SHEET NO.

1 3

OF 17 SHEETS

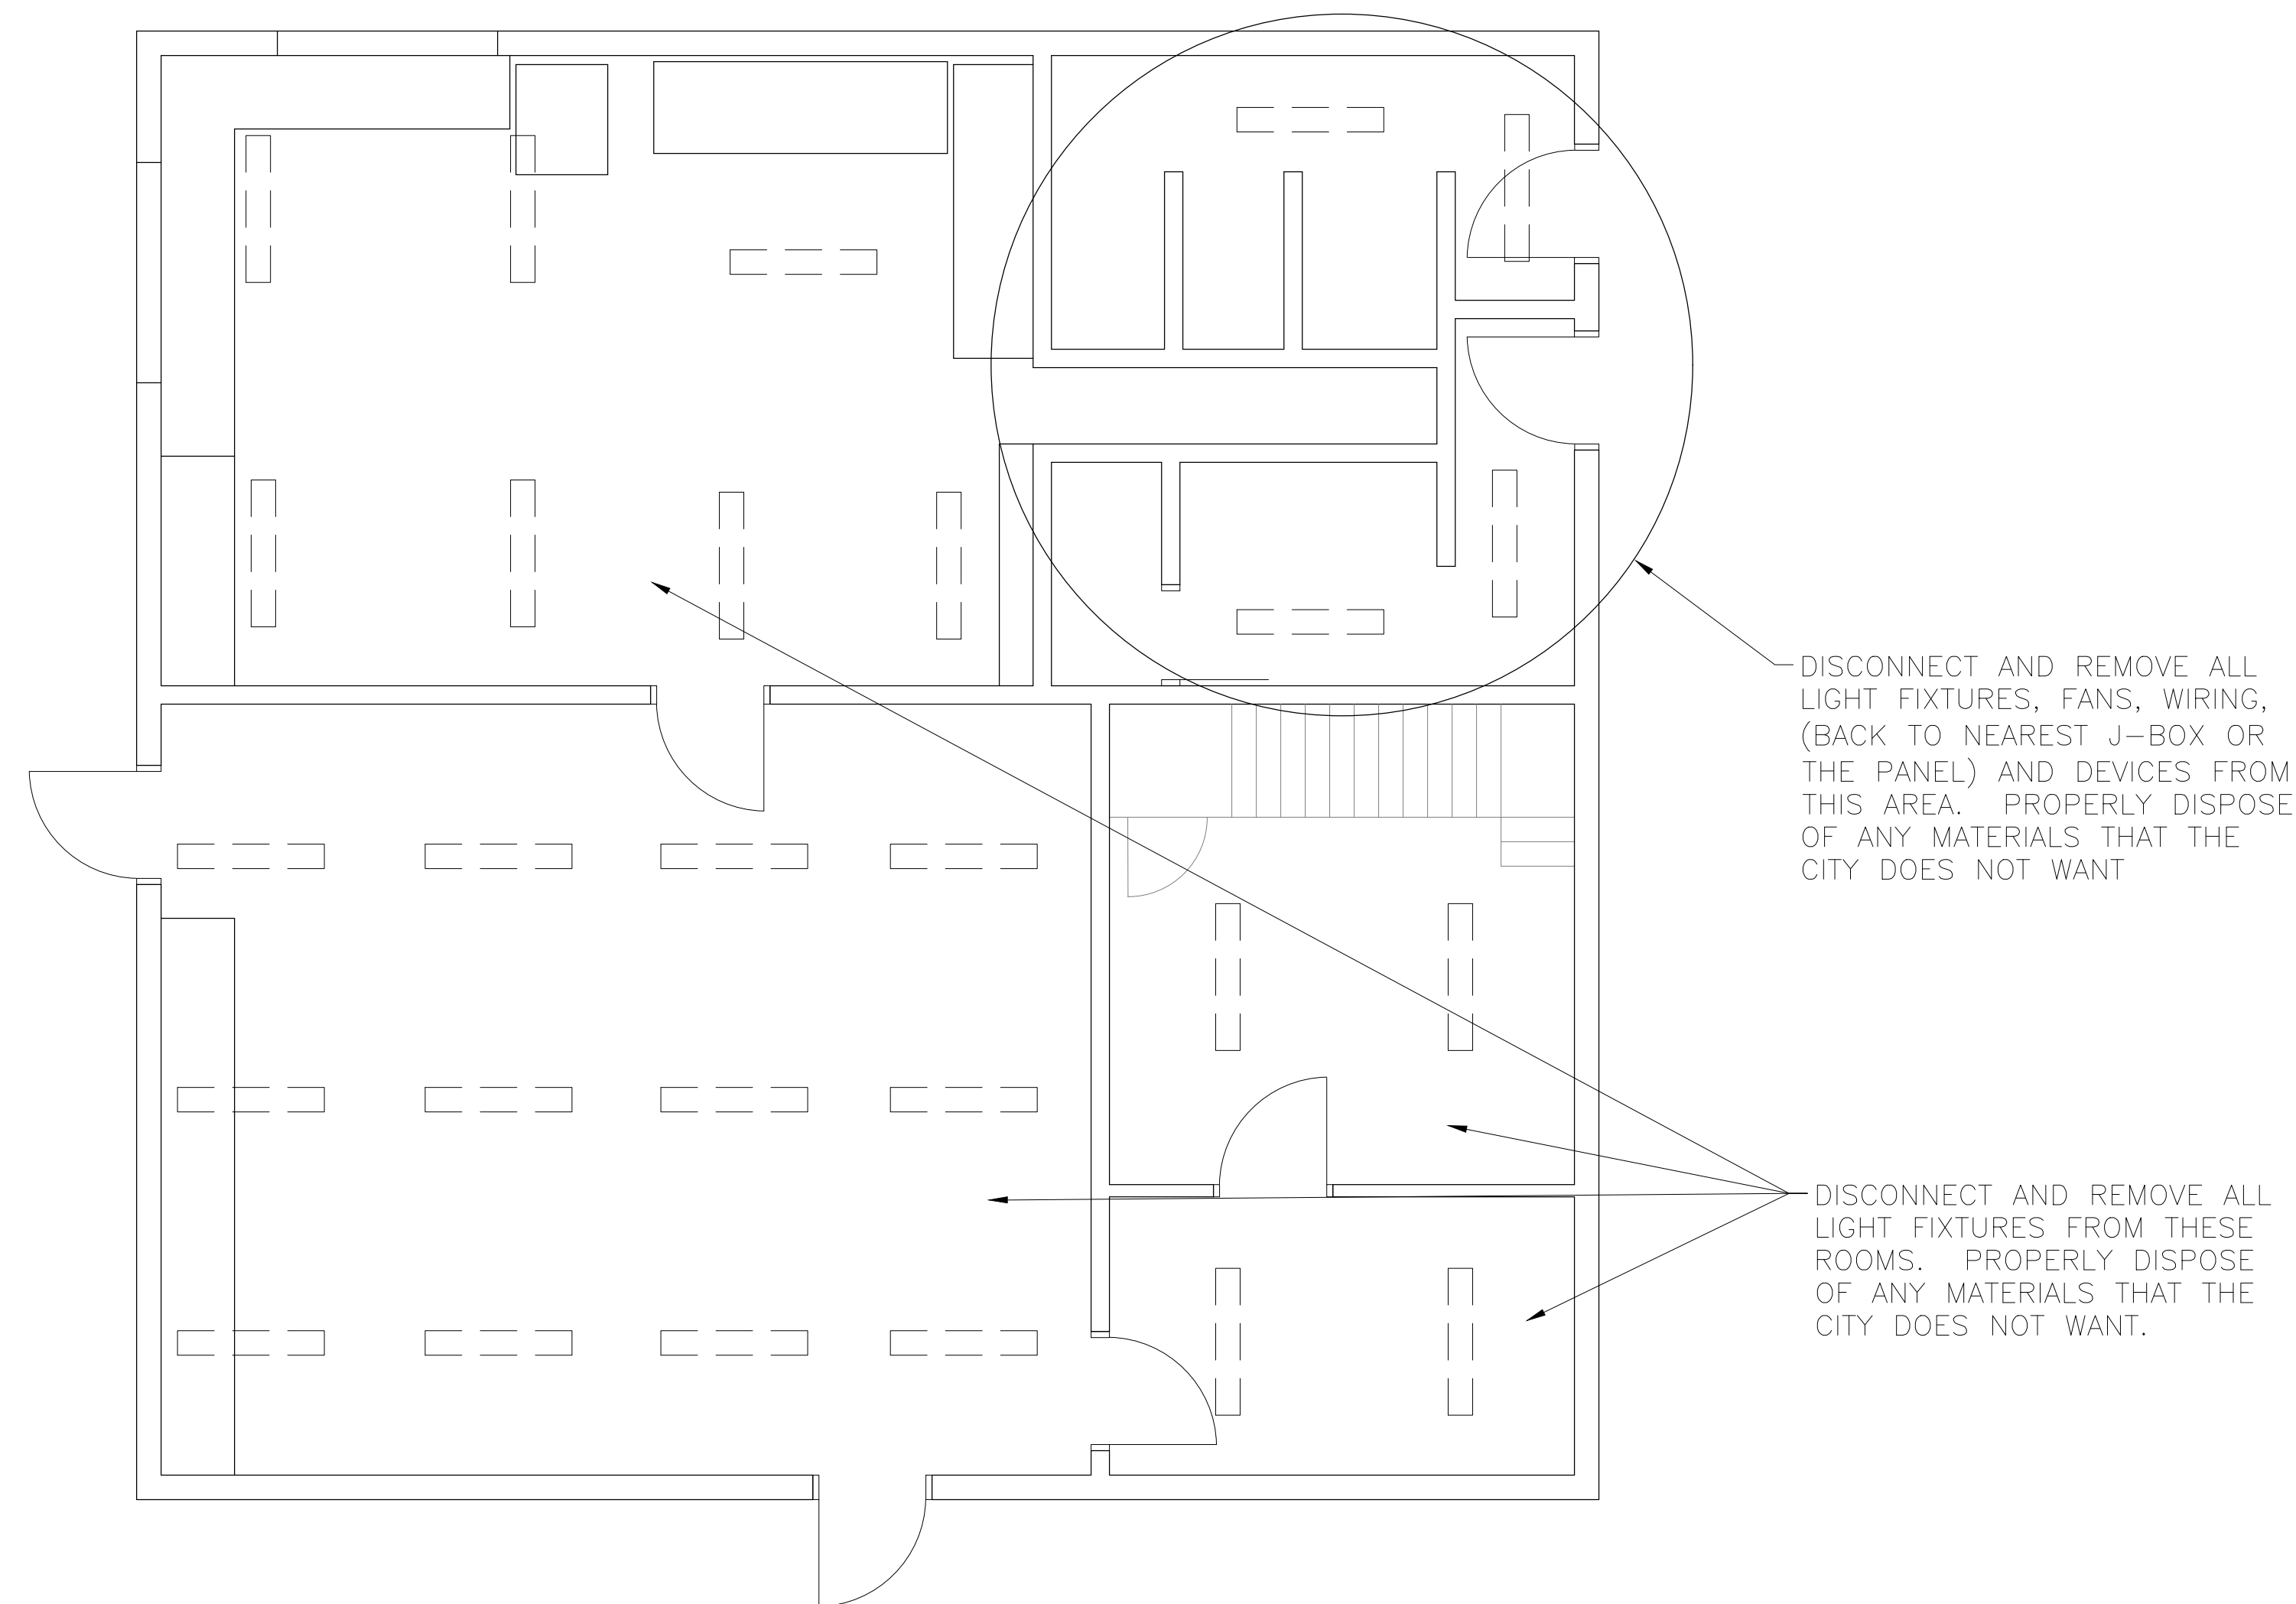

LIGHTING DEMO PLAN
NTS



GENERAL NOTES

1. ALL EQUIPMENT FURNISHED AND ALL WORK SHALL BE IN STRICT CONFORMITY WITH ELECTRICAL SECTION OF REGULATORY INSPECTIONS FOR ORLEANS PARISH, STATE FIRE MARSHALL, N.E.C. & ALL OTHER APPLICABLE LAWS, ORDINANCES, CODES & RULES OF CONSTRUCTION APPLICABLE IN THE LOCALITY OF WORK.
2. PERMITS, CERTIFICATES OF INSPECTION AND APPROVAL AS APPLICABLE TO THE VARIOUS PORTIONS OF THE WORK SHALL BE OBTAINED FROM THE INSPECTION AGENCY HAVING JURISDICTION THEREON AND SHALL BE DELIVERED TO THE ARCHITECT PRIOR TO ACCEPTANCE OF THE WORK. PAY ALL FEES REQUIRED IN CONNECTION WITH VARIOUS INSPECTIONS AND PERMITS.
3. ELECTRICAL PLANS SHOW GENERAL WORK TO BE PERFORMED AND HAVE BEEN PREPARED TO ASSIST IN DETERMINING PROPOSED COST FOR THE TOTAL PROJECT. IT IS THE RESPONSIBILITY OF THE CONTRACTOR TO VISIT THE JOB SITE AND BECOME FAMILIAR WITH EXISTING CONDITIONS WHICH MAY AFFECT HIS WORK AND FINAL BID PRICE.
4. EACH BRANCH CIRCUIT AND/OR FEEDER SHALL HAVE A GREEN INSULATED EQUIPMENT GROUND CONDUCTOR, SIZED PER NEC.
5. ALL PENETRATIONS THROUGH PARTITIONS AND CEILINGS SHALL BE PROPERLY SEALED TO MAINTAIN FIRE AND OR SMOKE RATING OF CEILINGS AND PARTITION.
6. UPON COMPLETION, FURNISH AS-BUILD SCHEMATIC DRAWING OF ALL VARIATIONS OF EXISTING PLANS TO OWNER.
7. UPON COMPLETION OF THE WORK, TEST THE NEW INDIVIDUAL SYSTEMS, INCLUDING ALL FEEDERS AND BRANCH CIRCUITS TO RECEPTACLES, LIGHTING WITH A 500 VOLT DC INSULATION TESTER (WITH AN 0-200 MEGOHM FULL SCALE.) ALL CONDUCTORS SHALL HAVE INSULATION TESTED WHEN WIRING SYSTEM IS COMPLETE AND A LOG KEPT OF THE CIRCUIT NAME, DATE AND MEGGER READINGS. RECORD FEEDER AND/OR CIRCUIT NAME, READING IN OHMS, AND SUBMIT REPORT TO ARCHITECT. CHECK FOR PROPER PHASE ROTATION. ALL TEST REPORTS SHALL BE TYPED. PROVIDE ALL INSTRUMENTS, LABOR, ETC. REQUIRED FOR TESTING. ALL TESTING SHALL BE OBSERVED BY THE ARCHITECT AND/OR REPRESENTATIVES OF ARCHITECT.
8. UPON COMPLETION OF ALL TESTS AND ACCEPTANCE, FURNISH THE OWNER A WRITTEN GUARANTEE COVERING THE ELECTRICAL WORK DONE AND EQUIPMENT INSTALLED FOR A PERIOD OF ONE YEAR FROM THE DATE OF ACCEPTANCE. DURING THE GUARANTEE PERIOD, RECTIFY AND REPLACE ANY DEFECTIVE MATERIAL OR WORKMANSHIP AND REPAIR DAMAGE CAUSED THEREBY WITHOUT ANY ADDITIONAL COST TO THE OWNER.
9. COORDINATE ALL LOCATIONS OF EQUIPMENT AND FINAL TERMINATION POINTS OF HVAC, PLUMBING, EXISTING EQUIPMENT, OWNER SUPPLIED EQUIPMENT, ETC., WITH APPROVED SHOP DRAWINGS OR OWNERS EQUIPMENT VENDOR PRIOR TO START OF ROUGHIN. WHERE REQUIRED, FIELD MOUNT U.L. LISTED AND APPROVED LUGS FOR OVERSIZED CONDUCTORS SPECIFIED.
10. THE EXACT LOCATION OF ALL WALL MOUNTED RECEPTACLES, DATA/TELEPHONE OUTLETS, ETC., SHALL BE FIELD VERIFIED WITH OWNER PRIOR TO START OF ROUGHIN.
11. COORDINATE MOUNTING HEIGHTS OF ALL WALL MOUNTED EQUIPMENT, WIRING DEVICES, ETC., WITH ARCHITECTURAL DRAWINGS PRIOR TO START OF ROUGH IN.
12. CONNECT ALL EXIT AND WALL MOUNTED BATTERY LIGHT FIXTURES TO UNSWITCHED PORTION OF LIGHTING CIRCUIT SERVING AREA.
13. NOT USED
14. IN EVENT OF CONFLICT OF INFORMATION IN THE SPECS AND/OR PLANS, CONTRACTOR SHALL BID ON THE MOST EXPENSIVE OPTION. IF SPECS MENTION THAT A CERTAIN COMPONENT IS NEEDED, CONTRACTOR IS RESPONSIBLE TO PROVIDE SUCH, EVEN IF IT IS NOT SHOWN ON PLANS OR DETAILS.
15. CONTRACTOR SHALL PROVIDE SCALE COORDINATION DRAWINGS FOR ENGINEER TO REVIEW PRIOR TO ANY ROUGH-IN OR ORDERING ANY EQUIPMENT IN ORDER TO AVOID ANY CONFLICTS ESPECIALLY IN TIGHT AREAS AND AT PENETRATIONS


PIVOTAL ENGINEERING
ARCHITECTURAL, CIVIL, ELECTRICAL
ENVIRONMENTAL & MECHANICAL ENGINEERING
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**KENILWORTH PLAYGROUND
LIGHTING AND BATHRM UPGRADE**
NEW ORLEANS LA.
RENOVATION

revisions	
no.	date & description
1	
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phase PRELIMINARY
drawing number E-1.0



SYMBOLS

- SURFACE MOUNT LED LIGHTING FIXTURE WILLIAMS - AVX-4-L62/840-CPC-DRV-UNV OR APPROVED EQUAL.
- 4" OCTAGON BOX 2-1/8" DEEP WITH BAR HANGER AS NEEDED
- SINGLE POLE SPEC GRADE 120/277V TOGGLE SWITCH. MOUNT IN 3-1/2" DEEP METAL MASONRY SWITCH BOX COVER PLATE TO BE STAINLESS STEEL
- WIRING RUN - 1/2" CONDUIT WITH 2-#12 AND 1 #12 GROUND UNLESS SHOWN OTHERWISE

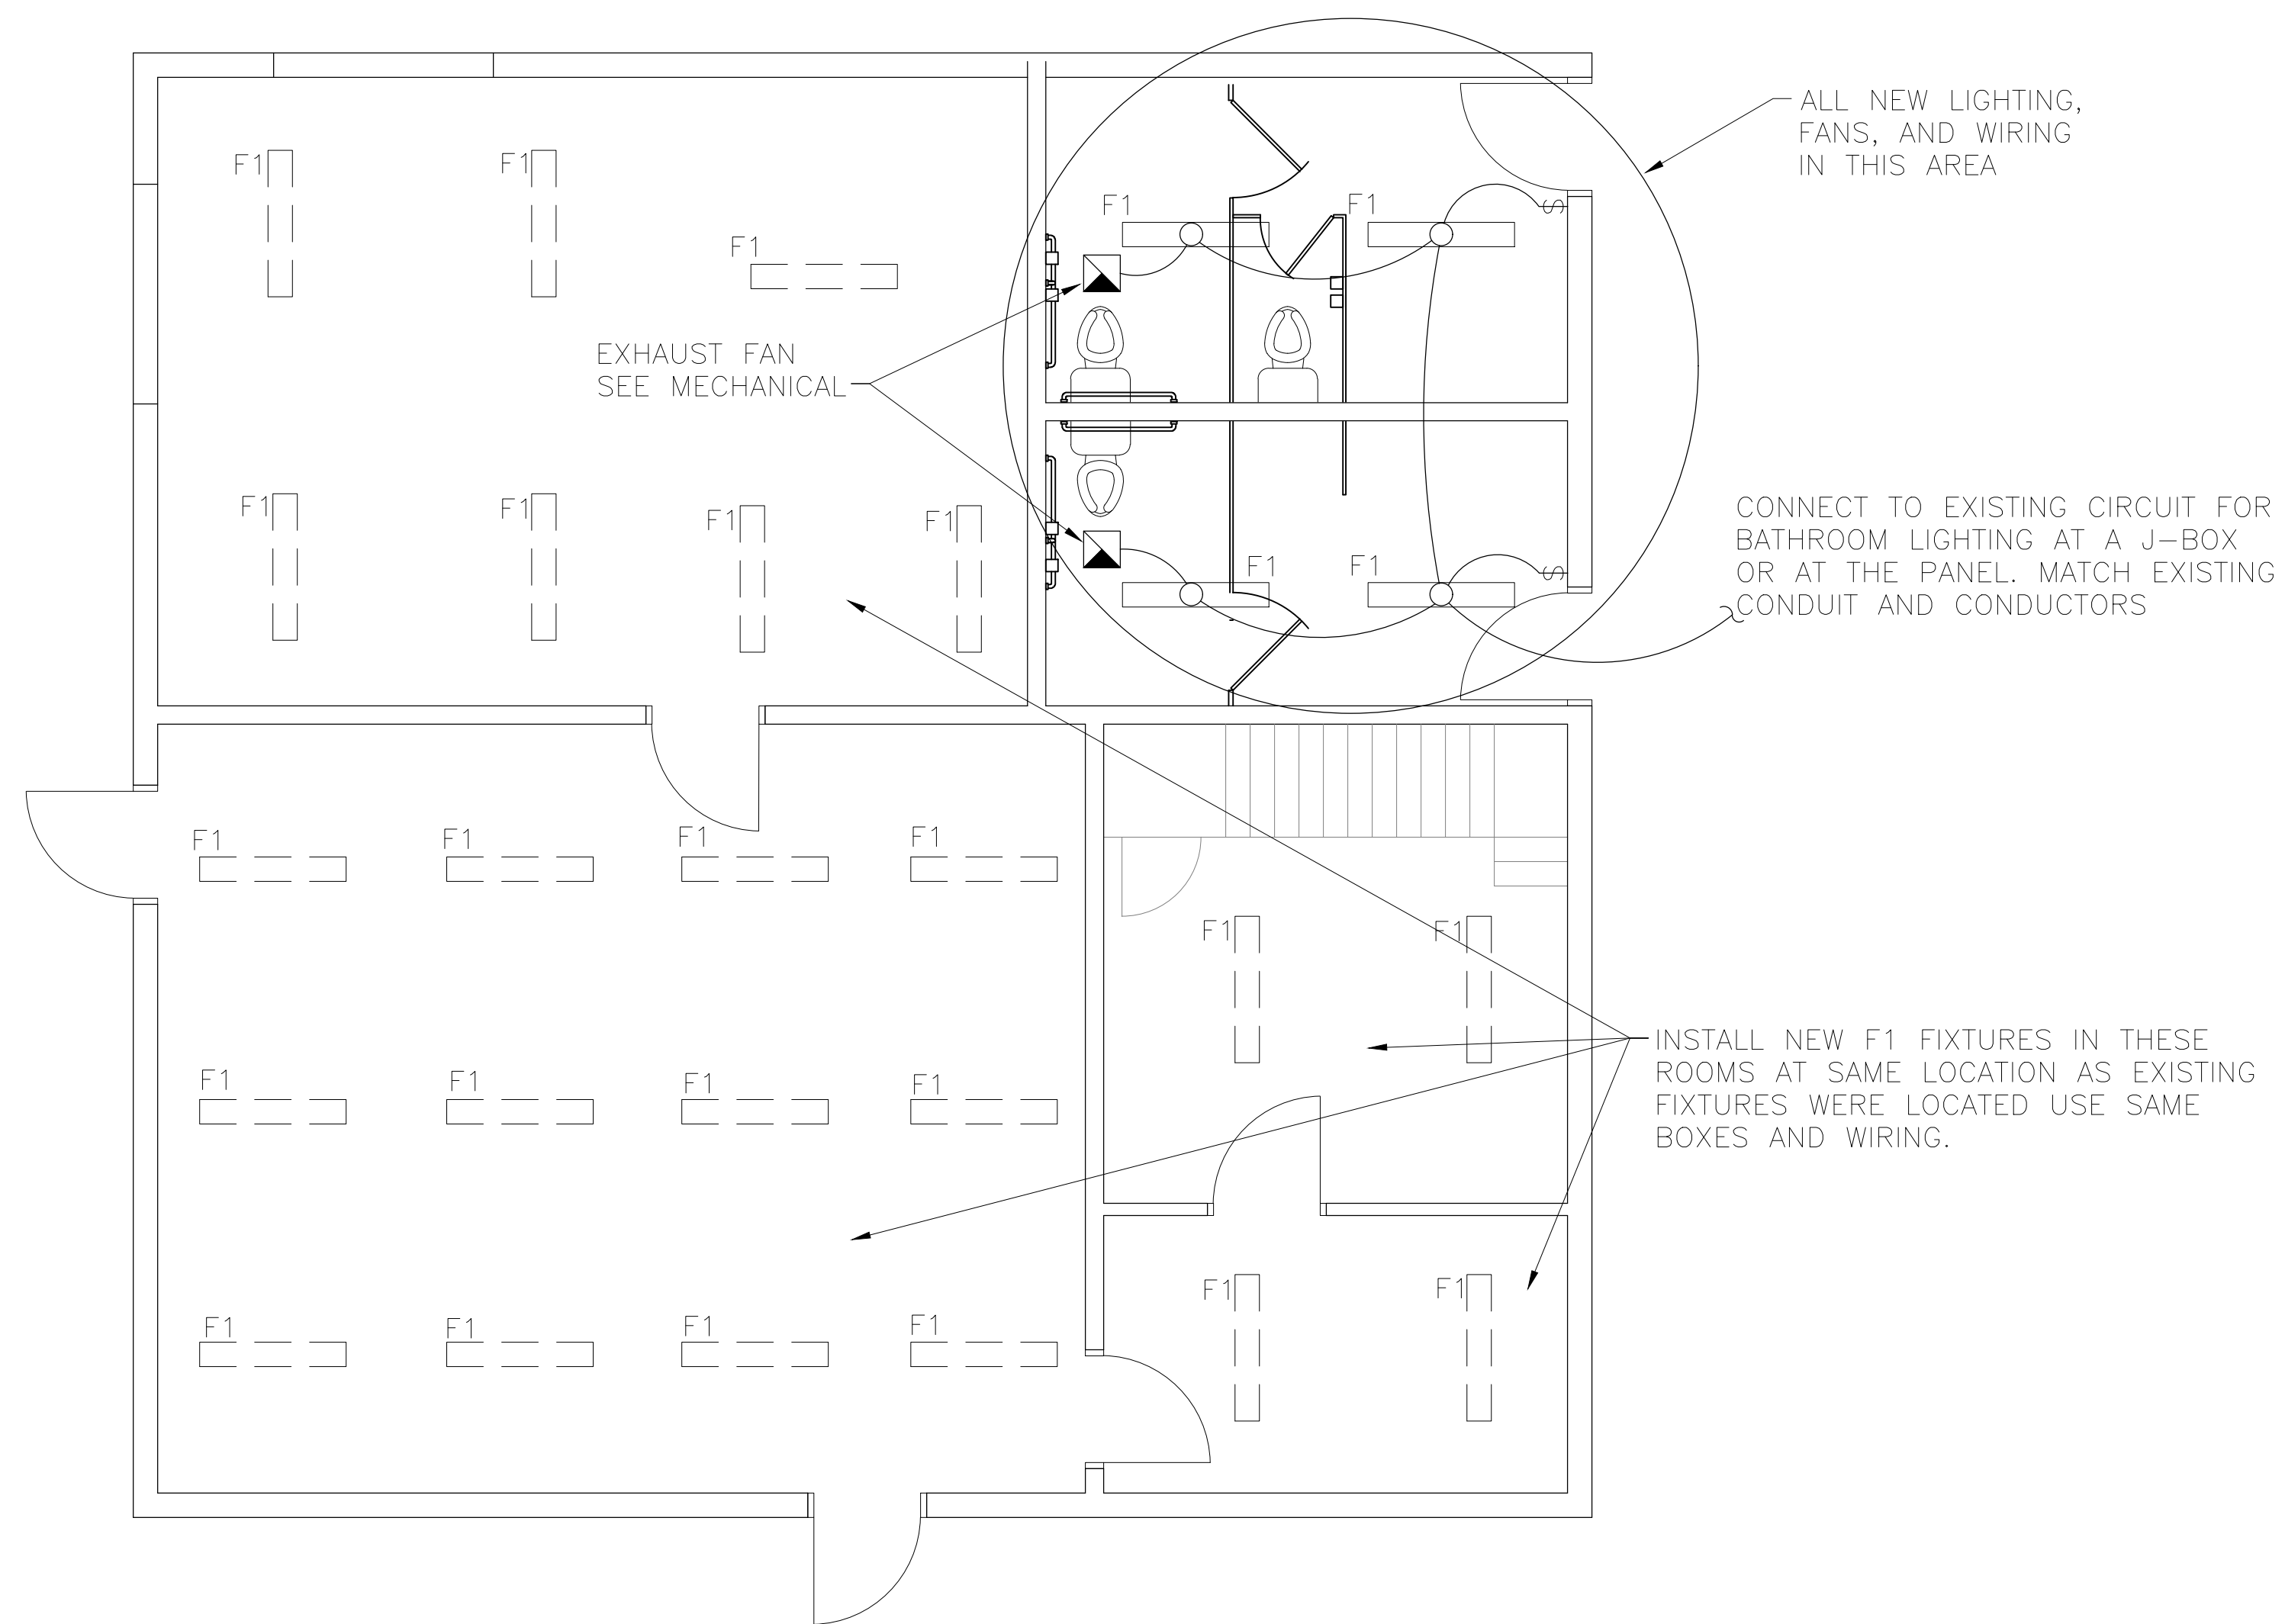LIGHTING PLAN
NTS



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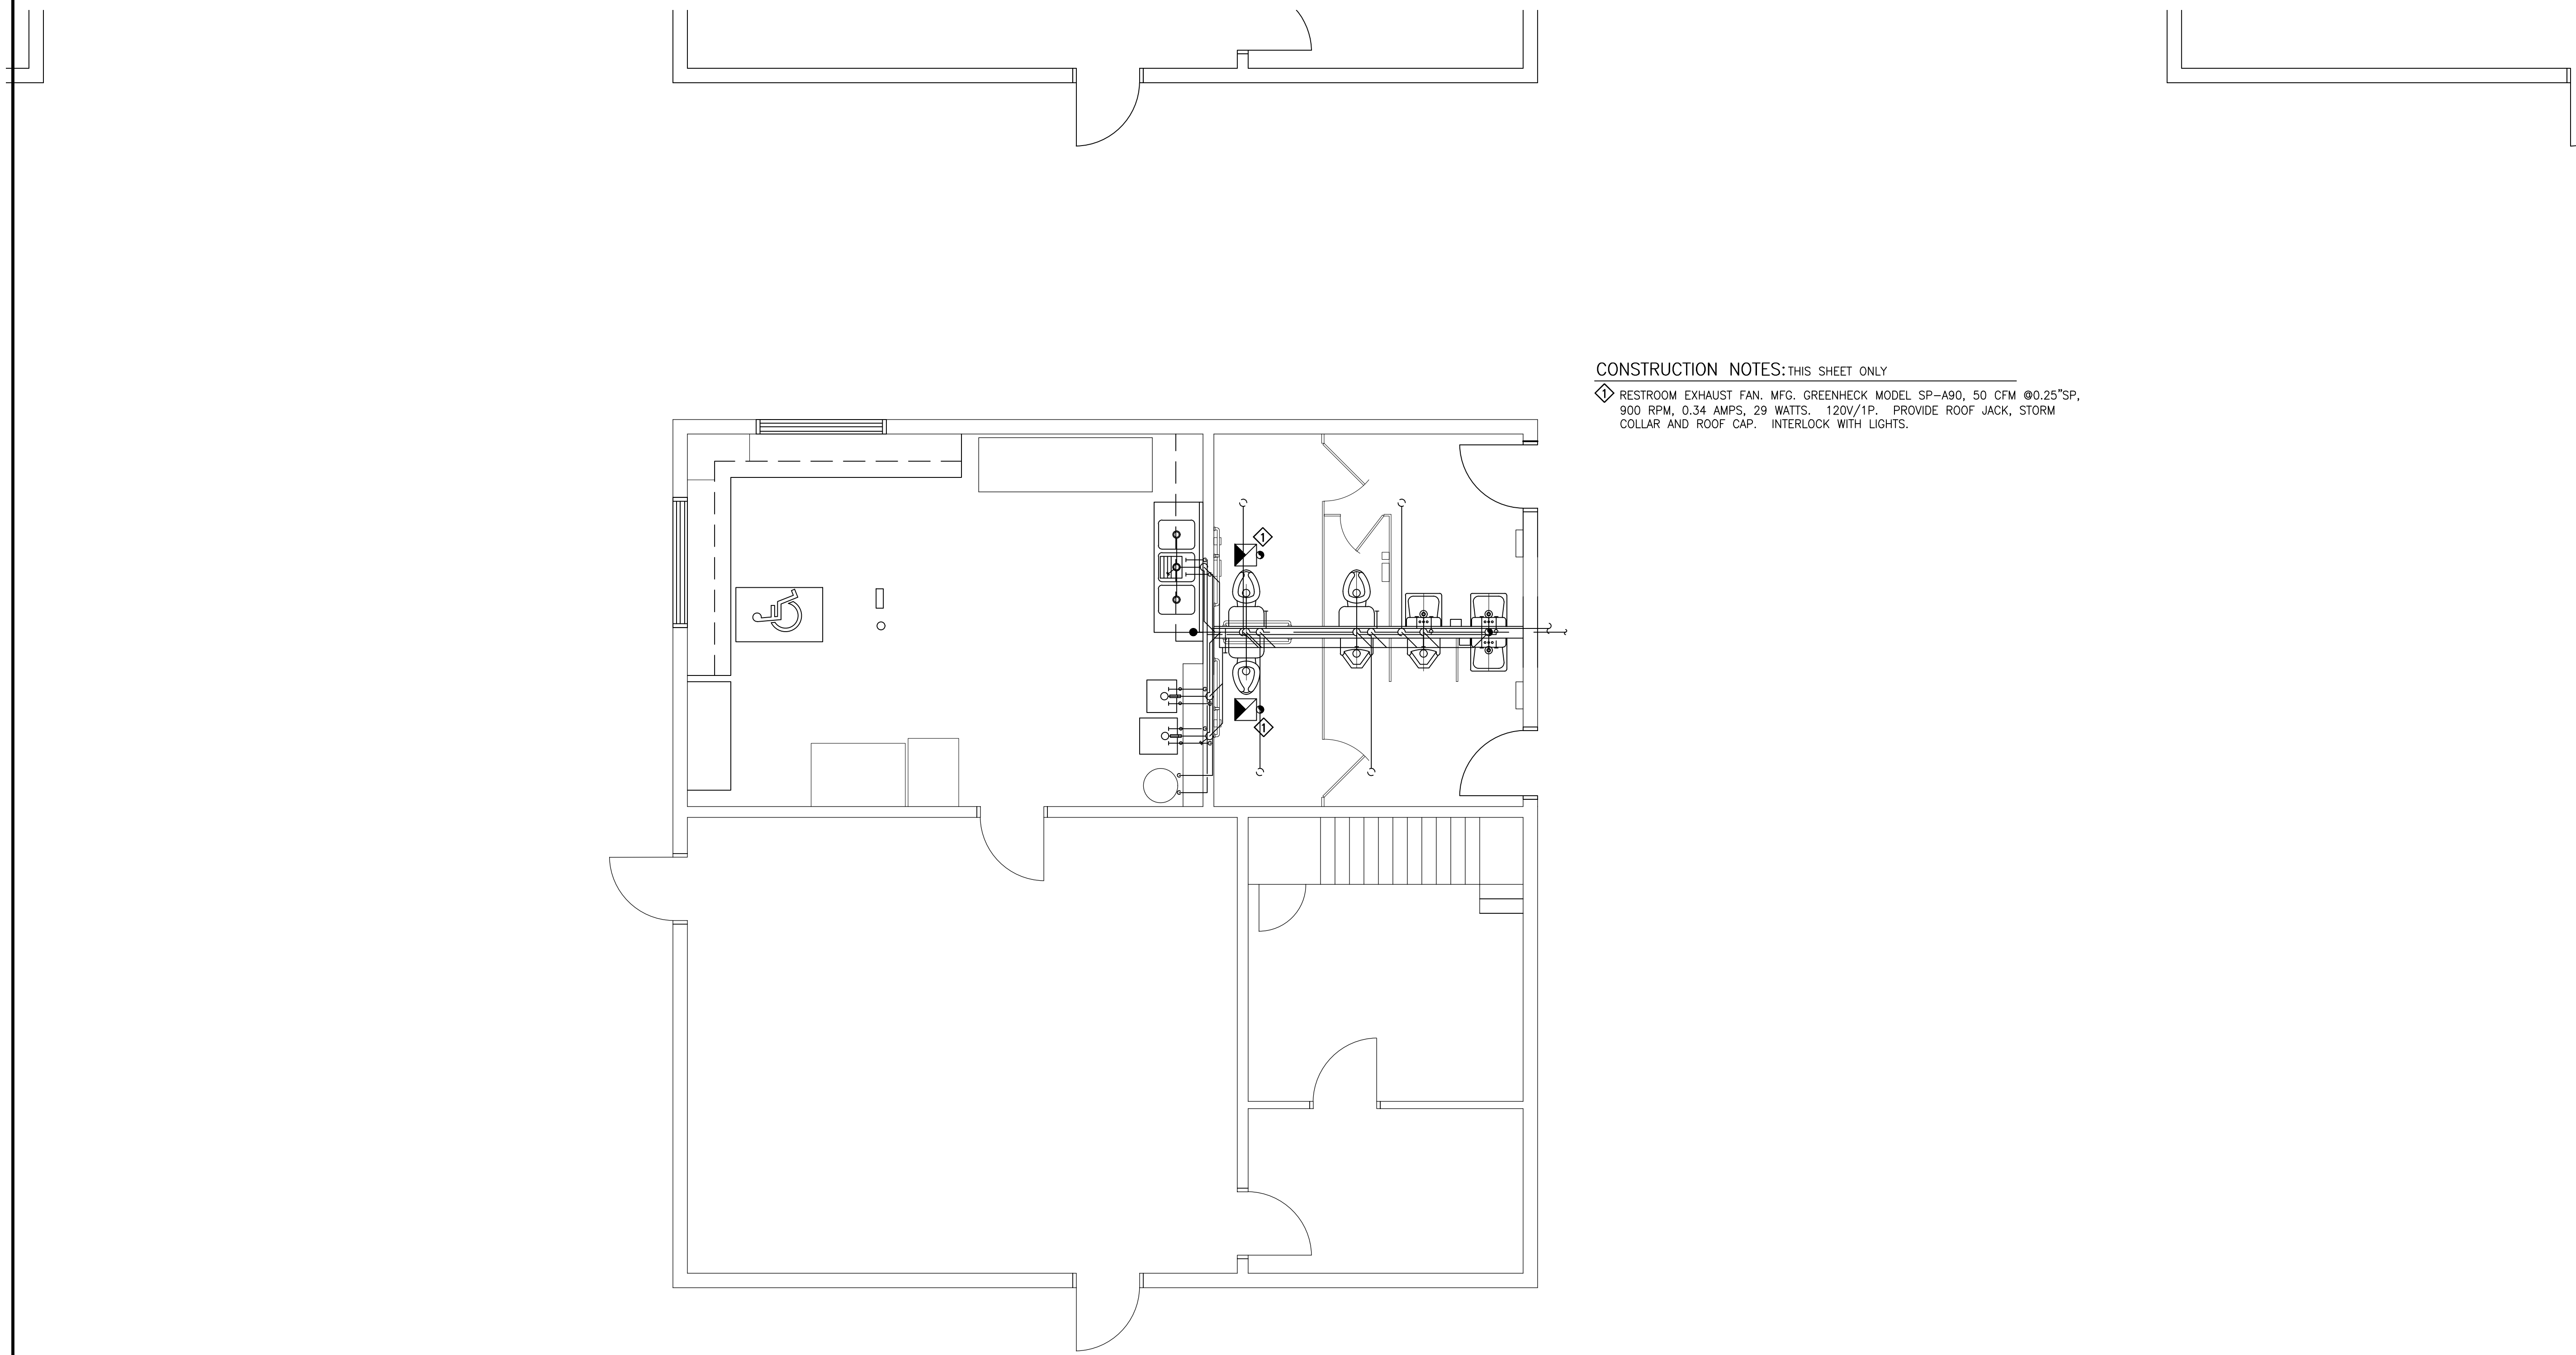
PROFESSIONAL OF RECORD
DATE

**KENILWORTH PLAYGROUND
LIGHTING AND BATHRM UPGRADE**
NEW ORLEANS LA.

RENOVATION

revisions	
no.	date & description
1	
2	
3	
4	
job number	17-XXX
drawn by	IHL
checked by	BRM
date	04/10/2017
phase	PRELIMINARY


drawing number
E-1.1



CONSTRUCTION NOTES: THIS SHEET ONLY

◊ RESTROOM EXHAUST FAN. MFG. GREENHECK MODEL SP-A90, 50 CFM @0.25"SP, 900 RPM, 0.34 AMPS, 29 WATTS. 120V/1P. PROVIDE ROOF JACK, STORM COLLAR AND ROOF CAP. INTERLOCK WITH LIGHTS.

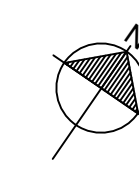

 **NEW HVAC PLAN**
SCALE: 1/4" = 1'-0"

DATE: _____
PROFESSIONAL OF RECORD: _____
LIC. NO.: _____


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**KENILWORTH PLAYGROUND
LIGHTING AND BATHRM UPGRADE**
NEW ORLEANS LA.
RENOVATION

revisions	
no.	date & description
1	
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3	
4	
job number	17-XXX
drawn by	JE
checked by	BRM
date	04/10/2017
phase	PRELIMINARY


drawing number
P-3



CONSTRUCTION NOTES: THIS SHEET ONLY

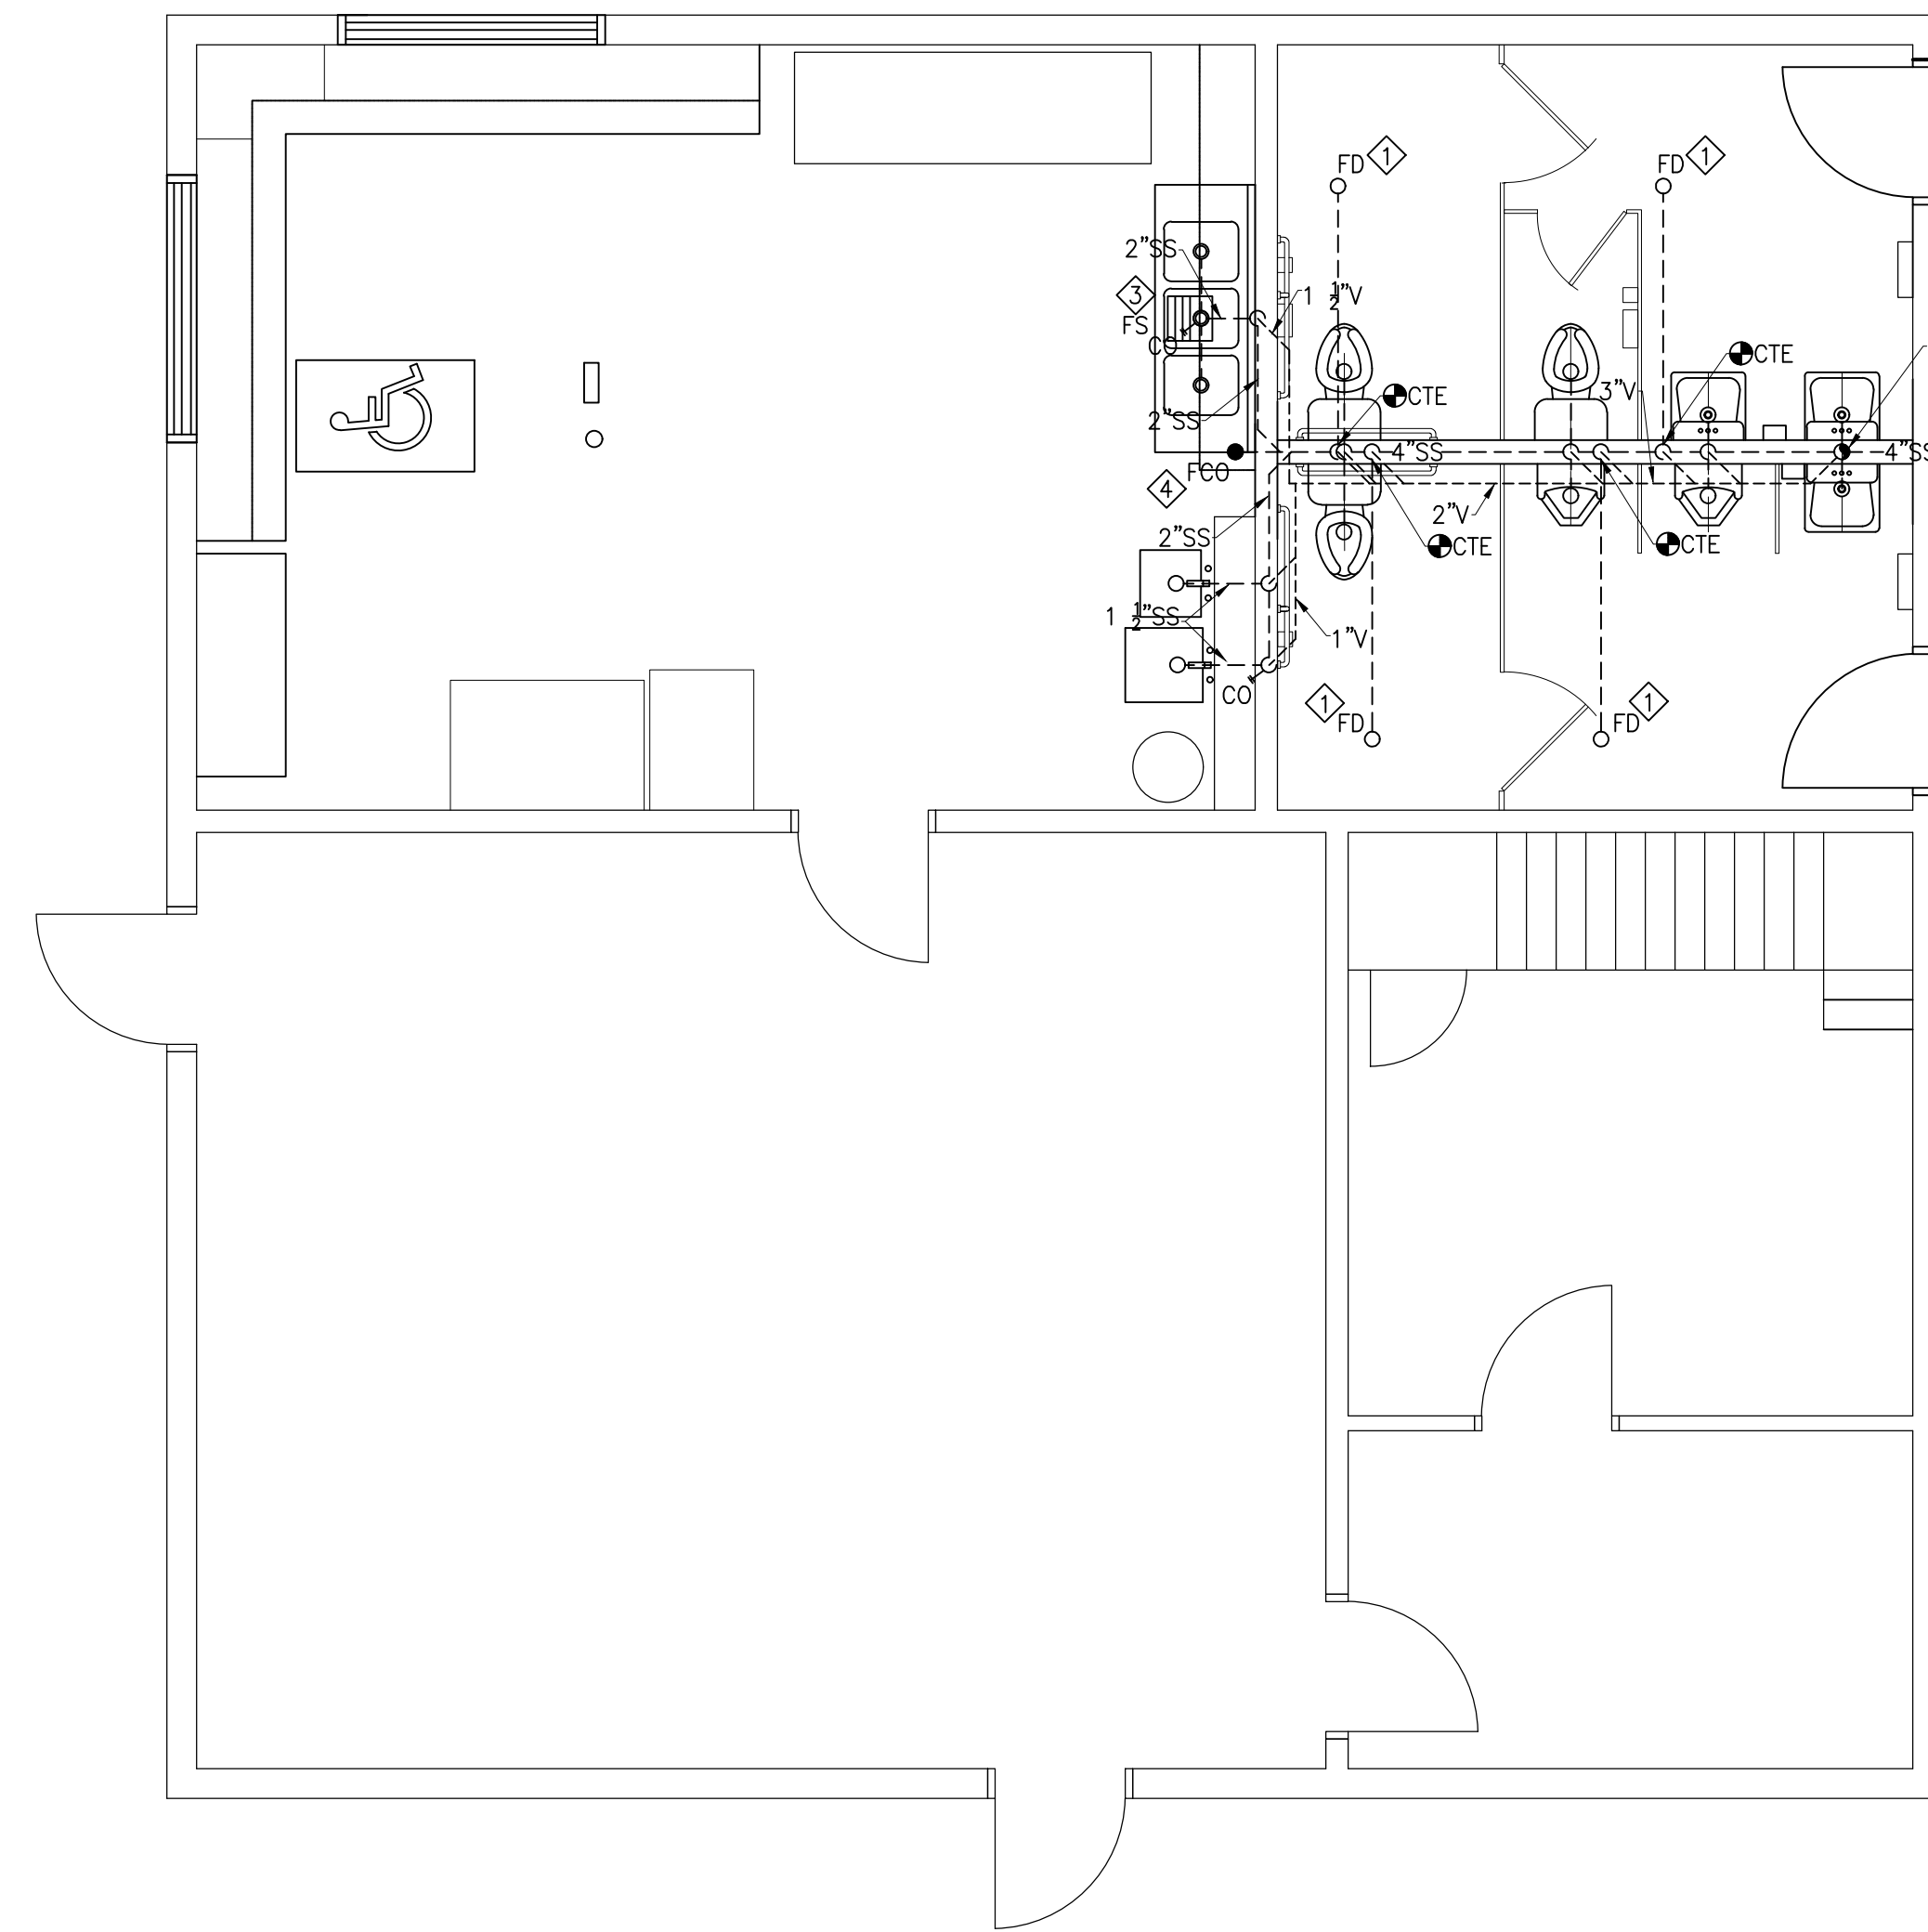- ◇ EXISTING FLOOR DRAINS AND BRANCH PIPING TO BE RE-USED. VERIFY DRAINS AND BRANCH PIPING ARE FUNCTIONAL, LEAK-FREE AND UNOBSTRUCTED.
- ◇ CONNECT NEW 4" SANITARY SEWER (SS) TO EXISTING SANITARY SEWER IN THIS AREA. VERIFY THAT EXISTING SANITARY SEWER AND LEAK-FREE AND UNOBSTRUCTED.
- ◇ FLOOR SINK. MFG. JOSAM MODEL 49320A-NB FLOOR SINK. 6-1/4" DEEP CAST IRON BODY WITH NON-CLOG ALUMINUM DOME STRAINER, WITH NIKALOY 1/2" GRATE TOP AND 3" NO HUB CONNECTION.
- ◇ FLOOR CLEAN OUT. MFG. ZURN MODEL ZS-1400, DURA COATED CAST IRON BODY WITH GAS AND WATERTIGHT ABS PLUG. ADJUSTABLE

CONNECT NEW 4" SS TO CLOSEST EXISTING SS.

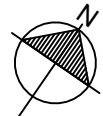 **SANITARY SEWER PLAN**
SCALE: 1/4" = 1'-0"



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DATE: _____


PROFESSIONAL OF RECORD: _____

SCALE: _____

**KENILWORTH PLAYGROUND
LIGHTING AND BATHRM UPGRADE**
NEW ORLEANS LA.
RENOVATION

revisions	
no.	date & description
1	
2	
3	
4	
job number	17-XXX
drawn by	JEA
checked by	BRM
date	04/10/2017
phase	PRELIMINARY

drawing number
P-1

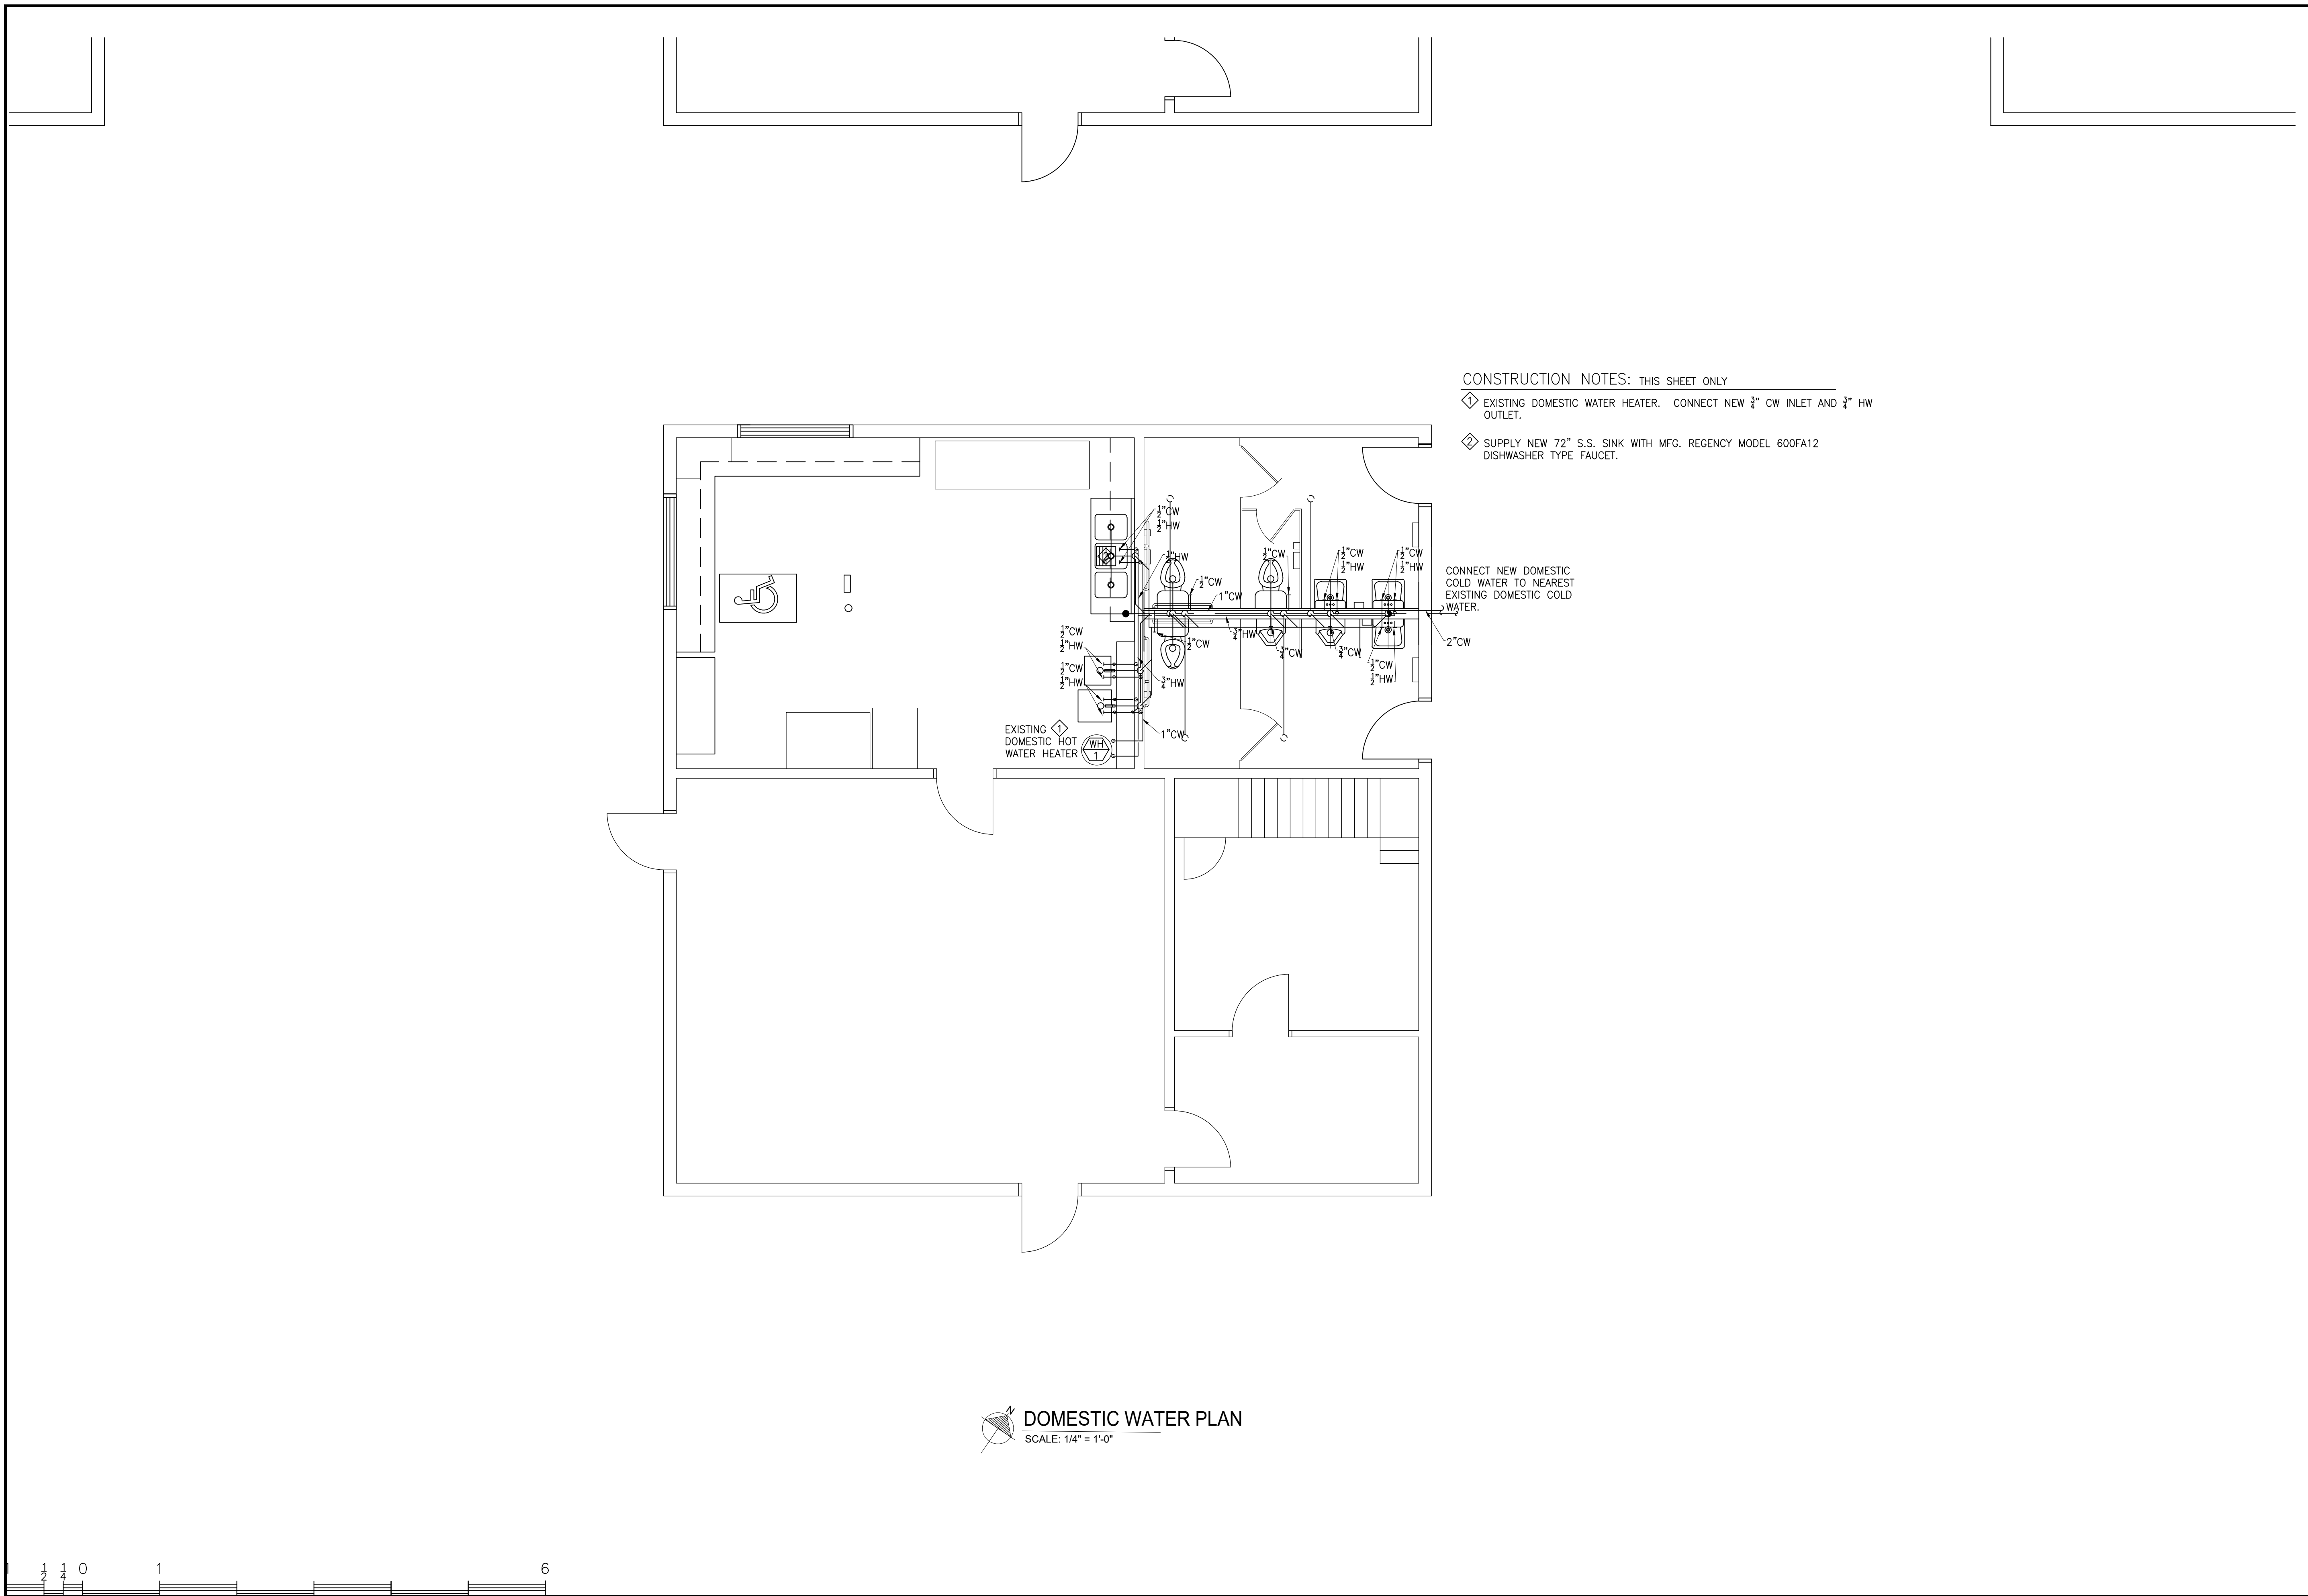

CONSTRUCTION NOTES: THIS SHEET ONLY

- ◊ EXISTING DOMESTIC WATER HEATER. CONNECT NEW 3/4" CW INLET AND 3/4" HW OUTLET.
- ◊ SUPPLY NEW 72" S.S. SINK WITH MFG. REGENCY MODEL 600FA12 DISHWASHER TYPE FAUCET.

CONNECT NEW DOMESTIC COLD WATER TO NEAREST EXISTING DOMESTIC COLD WATER.

DOMESTIC WATER PLAN
SCALE: 1/4" = 1'-0"



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USE THESE NOTES WITH THE DRAWING.
UNLESS MY DIRECT SUPERVISION AND
TO THE BEST OF MY KNOWLEDGE AND
BELIEF, THIS DESIGN COMPLIES WITH ALL
STATE AND FEDERAL REQUIREMENTS,
ORDINANCES AND REGULATIONS. MY
OBSERVATION OF THE WORK WILL BE
FOUNDED BY OUR OFFICE.
PROFESSIONAL OF RECORD
DATE: _____

**KENILWORTH PLAYGROUND
LIGHTING AND BATHRM UPGRADE**
NEW ORLEANS LA.
RENOVATION

revisions	
no.	date & description
1	
2	
3	
4	
job number	17-XXX
drawn by	JEA
checked by	BRM
date	04/10/2017
phase	PRELIMINARY

drawing number
P-2