# ORLEANS PARISH, LOUISIANA KENILWORTH PLAYGROUND


7820 REDFISH STREET NEW ORLEANS, LA 70126 **MARCH 2017** 

# **INDEX TO SHEETS**

SHEET NO. DESCRIPTION



IMAGE: EXISTING SITE CLUB HOUSE

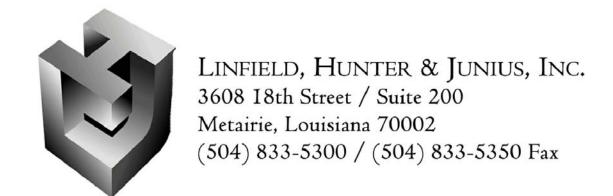



MITCHELL J. LANDRIEU **MAYOR** 

STACY HEAD COUNCILMEMBER-AT-LARGE

JASON ROGERS WILLIAMS COUNCILMEMBER-AT-LARGE

### COUNCIL


SUSAN G. GUIDRY	DISTRICT "A
LATOYA CANTRELL	DISTRICT "E
NADINE M. RAMSEY	DISTRICT "C
JARED C. BROSSETT	DISTRICT "E
JAMES AUSTIN GRAY II	DISTRICT "F

FINAL PLANS

REV. NO. DATE

TYPE OF CONSTRUCTION

DEMOLITION, CONCRETE, FENCING, BATTING CAGES AND BUILDING RENOVATIONS

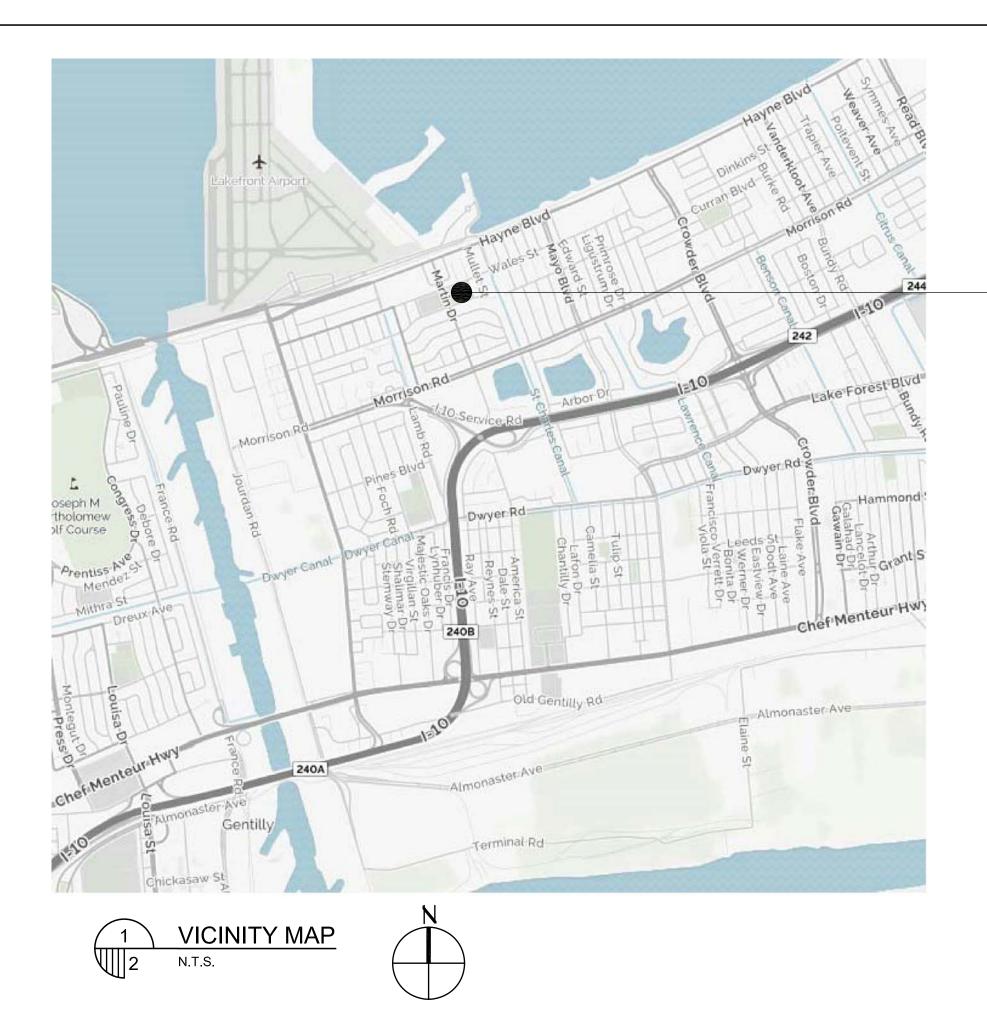

### **GENERAL NOTES:**

- 1 DRAWINGS ARE GENERALLY TO SCALE, BUT SHOULD NOT BE SCALED.
- 3 DIMENSIONS AND/OR ELEVATIONS MARKED THUS (+/-) ARE APPROXIMATE. CONTRACTOR SHALL VERIFY ACTUAL DIMENSIONS IN THE FIELD.
- 4 CONTRACTOR SHALL BE RESPONSIBLE FOR LAYING OUT THE WORK AND VERIFYING ALL MEASUREMENTS AND GRADES PRIOR TO BEGINNING OF CONSTRUCTION. ANY POTENTIAL CONFLICTS SHALL BE BROUGHT TO LANDSCAPE ARCHITECT'S ATTENTION PRIOR TO
- 5 THE CONTRACTOR SHALL BE RESPONSIBLE TO ESTABLISH AND MAINTAIN TEMPORARY BENCH MARKS DURING CONSTRUCTION AS NEEDED.
- 6 LOCATION OF EXISTING UTILITIES INDICATED ON THE PLAN SHEETS ARE SHOWN FOR INFORMATIONAL PURPOSES ONLY AND ARE BASED, IN PART, ON INFORMATION PROVIDED BY THE RESPECTIVE UTILITY COMPANIES. IT IS THE CONTRACTOR'S RESPONSIBILITY TO LOCATE AND VERIFY ALL EXISTING PRIVATE AND PUBLIC UTILITY LOCATIONS PRIOR TO CONSTRUCTION.
- 7 ALL UTILITIES ARE TO REMAIN UNLESS OTHERWISE NOTED.
- 8 IT IS THE CONTRACTOR'S RESPONSIBILITY TO HAVE ANY NECESSARY UTILITIES TEMPORARILY SHUT DOWN DURING CONSTRUCTION.
- 9 ALL WORK AROUND HIGH VOLTAGE POWER LINES SHALL BE IN ACCORDANCE WITH OSHA AND ENTERGY REQUIREMENTS.
- 10 CONTRACTOR SHALL NOTIFY THOSE AFFECTED BY CONSTRUCTION 48 HOURS PRIOR TO DISRUPTION OF WATER, SEWER OR OTHER UTILITY SERVICE. THESE SERVICES SHALL BE PROMPTLY REPAIRED AND NOT REMAIN OUT OF SERVICE OVERNIGHT, UNLESS OTHERWISE
- 11 THE CONTRACTOR IS RESPONSIBLE FOR ANY DAMAGE TO EXISTING UTILITIES CAUSED BY CONSTRUCTION OPERATIONS. THE DAMAGE SHALL BE REPAIRED AT THE CONTRACTOR'S
- 12 CONTRACTOR SHALL NOT IMPEDE THE EXISTING DRAINAGE DURING THE CONSTRUCTION. CONTRACTOR SHALL BE RESPONSIBLE TO TAKE NECESSARY STEPS TO FACILITATE THE DRAINAGE AT ALL TIMES. EROSION CONTROL METHODS SHALL BE IMPLEMENTED AROUND ALL CATCH BASINS THROUGHOUT CONSTRUCTION.
- 13 CONTRACTOR SHALL NOT BE ALLOWED TO IMPEDE EXISTING OR NEW DRAINAGE DURING RAINSTORM OR WHEN A STORM IS IMMINENT.
- 14 CONTRACTOR SHALL TAKE REASONABLE MEASURES TO AVOID UNNECESSARY NOISE APPROPRIATE FOR THE AMBIENT SOUND LEVELS IN THE AREA DURING WORKING HOURS. ALL CONSTRUCTION MACHINERY AND VEHICLES SHALL BE EQUIPPED WITH PRACTICAL SOUND MUFFLING DEVICES, AND OPERATED IN A MANNER TO CAUSE THE LEAST NOISE, CONSISTENT WITH EFFICIENT PERFORMANCE OF THE WORK.
- 15 CONTRACTOR SHALL TAKE REASONABLE MEASURES TO PREVENT UNNECESSARY DUST. EACH SURFACE SUBJECT TO DUSTING SHALL BE KEPT MOIST WITH WATER OR BY APPLICATION OF CHEMICAL DUST SUPPRESSANT. DUSTY MATERIALS IN PILES OR IN TRANSIT SHALL BE COVERED TO PREVENT BLOWING.
- 16 CONTRACTOR SHALL BE REQUIRED TO ADEQUATELY FENCE HIS CONSTRUCTION OPERATIONS. THE CONTRACTOR SHALL KEEP THE SITE SECURED AS TO NOT AFFECT THE HEALTH, SAFETY AND WELFARE OF THE GENERAL PUBLIC.
- 17 CONTRACTOR TO KEEP VEHICULAR SIGHT LINES CLEAR AT ALL TIMES, UNLESS PROPER LANE RESTRICTIONS ARE IN PLACE. NO STOCKPILING OR STORAGE OF MATERIAL OR EQUIPMENT WITHIN VEHICULAR SIGHT LINES.

### GENERAL NOTES: (CONTINUED)

18 ALL EQUIPMENT, AND MATERIALS, REQUIRED FOR CONSTRUCTION OF THE PROJECT IS TO REMAIN INSIDE THE LIMITS OF WORK AT ALL TIMES. CONTRACTOR IS RESPONSIBLE FOR ANY DAMAGE CAUSED BY HIS EQUIPMENT OR MATERIALS THAT OCCURS OUTSIDE OF THE LIMITS


PROJECT SITE

PROJECT SITE

- IS THE CONTRACTOR'S RESPONSIBILITY. NO STORAGE OF EQUIPMENT OR MATERIALS CAN BLOCK ANY TRAFFIC SIGHT LINES.
- 20 CONTRACTOR IS RESPONSIBLE TO OBTAIN ANY AND ALL REQUIRED PERMITS, INSPECTIONS, APPROVALS, AND APPLICABLE FEES INVOLVED WITH THIS PROJECT.
- 21 THE CONTRACTOR SHALL COOPERATE WITH ANY CITY OF NEW ORLEANS EMPLOYEES OR CONTRACTORS THAT MAY BE WORKING WITHIN THE LIMITS OF WORK AT THE SAME TIME AS THIS
- 22 ALL ITEMS SCHEDULED FOR REMOVAL SHALL BE HAULED OFF FROM THE SITE THE SAME DAY IN IN WHICH IT IS REMOVED. NO STOCKPILING OF REMOVED MATERIAL SHALL BE ALLOWED.
- 23 THE CONTRACTOR SHALL BE REQUIRED TO FENCE AROUND THE EXISTING TREES. THE CONTRACTOR SHALL NOT STOCKPILE ANY EQUIPMENT, MATERIAL OR DEBRIS UNDER THE CANOPY OF ANY EXISTING TREES. THE CONTRACTOR SHALL NOT CHANGE THE GRADE, UNLESS SHOWN ON THE PLANS, UNDER THE CANOPY OF ANY EXISTING TREES. ANY DAMAGE OCCURRING TO THE EXISTING TREES SHALL BE ASSESSED BY A CONTRACTOR PROVIDED LICENSED ARBORIST. THE ARBORIST SHALL SUPPLY THE OWNER WITH A WRITTEN REPORT OF THE DAMAGE AND OUTLINE THE PROPOSED WORK TO REMEDY THE DAMAGE FOR APPROVAL BY THE OWNER. THE CONTRACTOR SHALL BE RESPONSIBLE FOR FOLLOWING THE ARBORIST'S RECOMMENDATION FOR TREE REMEDIATION. ANY TREES DAMAGED BEYOND THE ARBORIST'S REMEDIATION REPORT SHALL BE REPLACE WITH A TREE(S) OF EQUAL SIZE


### CONTACT INFORMATION:

LANDSCAPE ARCHITECT: LINFIELD, HUNTER & JUNIUS, INC. 3608 18th STREET METAIRIE, LOUISIANA 70002	(504) 833-5300
OWNER: NEW ORLEANS CAPITAL PROJECTS ADMINISTRATION 1300 PERDIDO STREET NEW ORLEANS, LOUISIANA 70112	(504) 658-8666
NEW ORLEANS RECREATION DEVELOPMENT COMMISSION NEW ORLEANS DEPT. OF PUBLIC WORKS: SEWERAGE & WATER BOARD OF NEW ORLEANS: ENTERGY NEW ORLEANS: ATMOS ENERGY SERVICES, LLC: LA ONE CALL:	(504) 658-3052 (504) 658-8000 (504) 529-2837 (800) 368-3749 (504) 681-3100 811

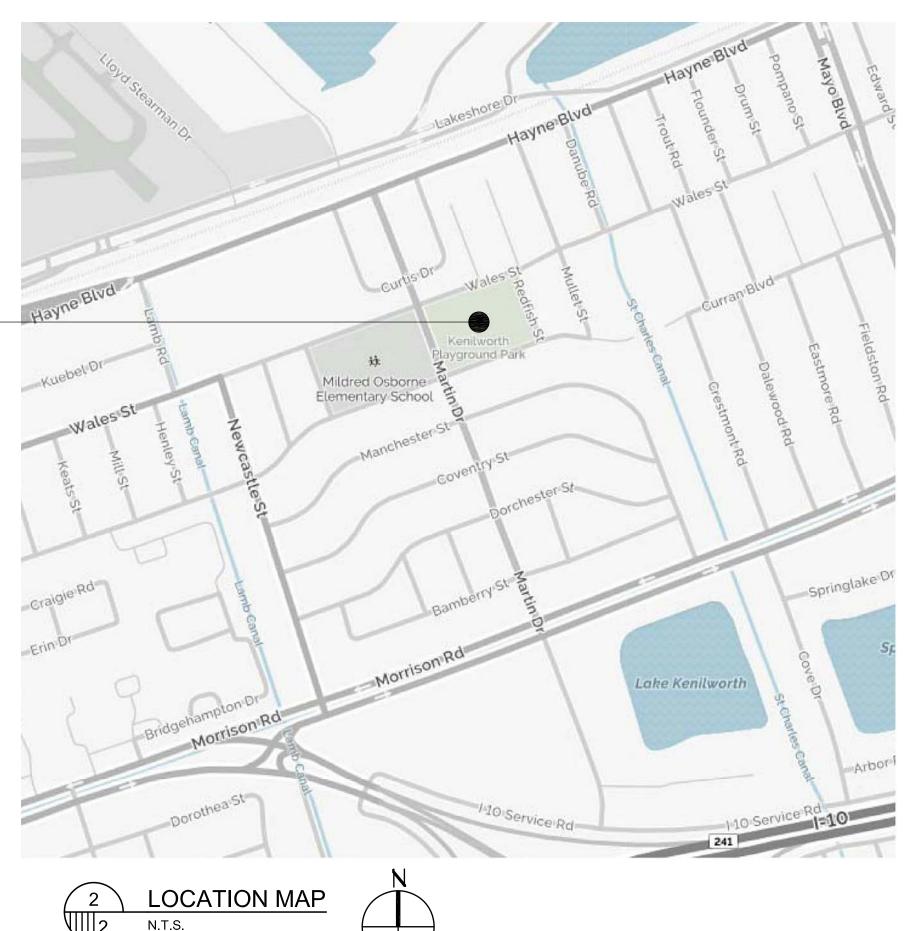



## GENERAL LEGEND:

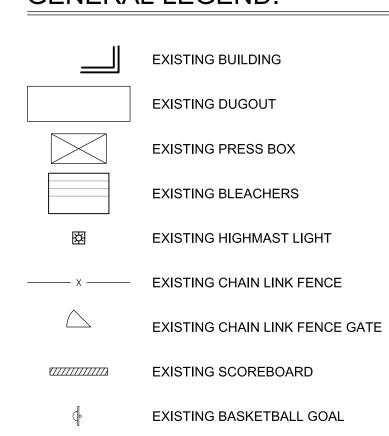


EXISTING CONCRETE


—— —— EXISTING CHAIN LINK BATTING CAGE


— — — REQUIRED TREE PROTECTION FENCE


EXISTING OAK TREE (TO REMAIN)




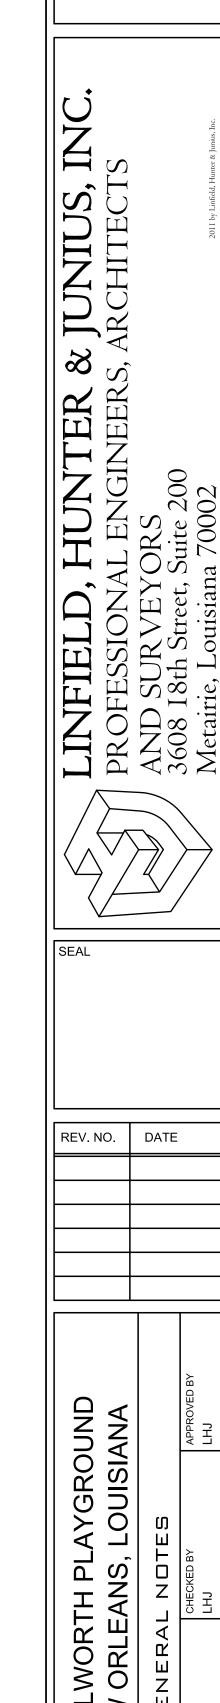

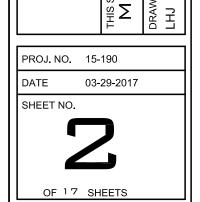

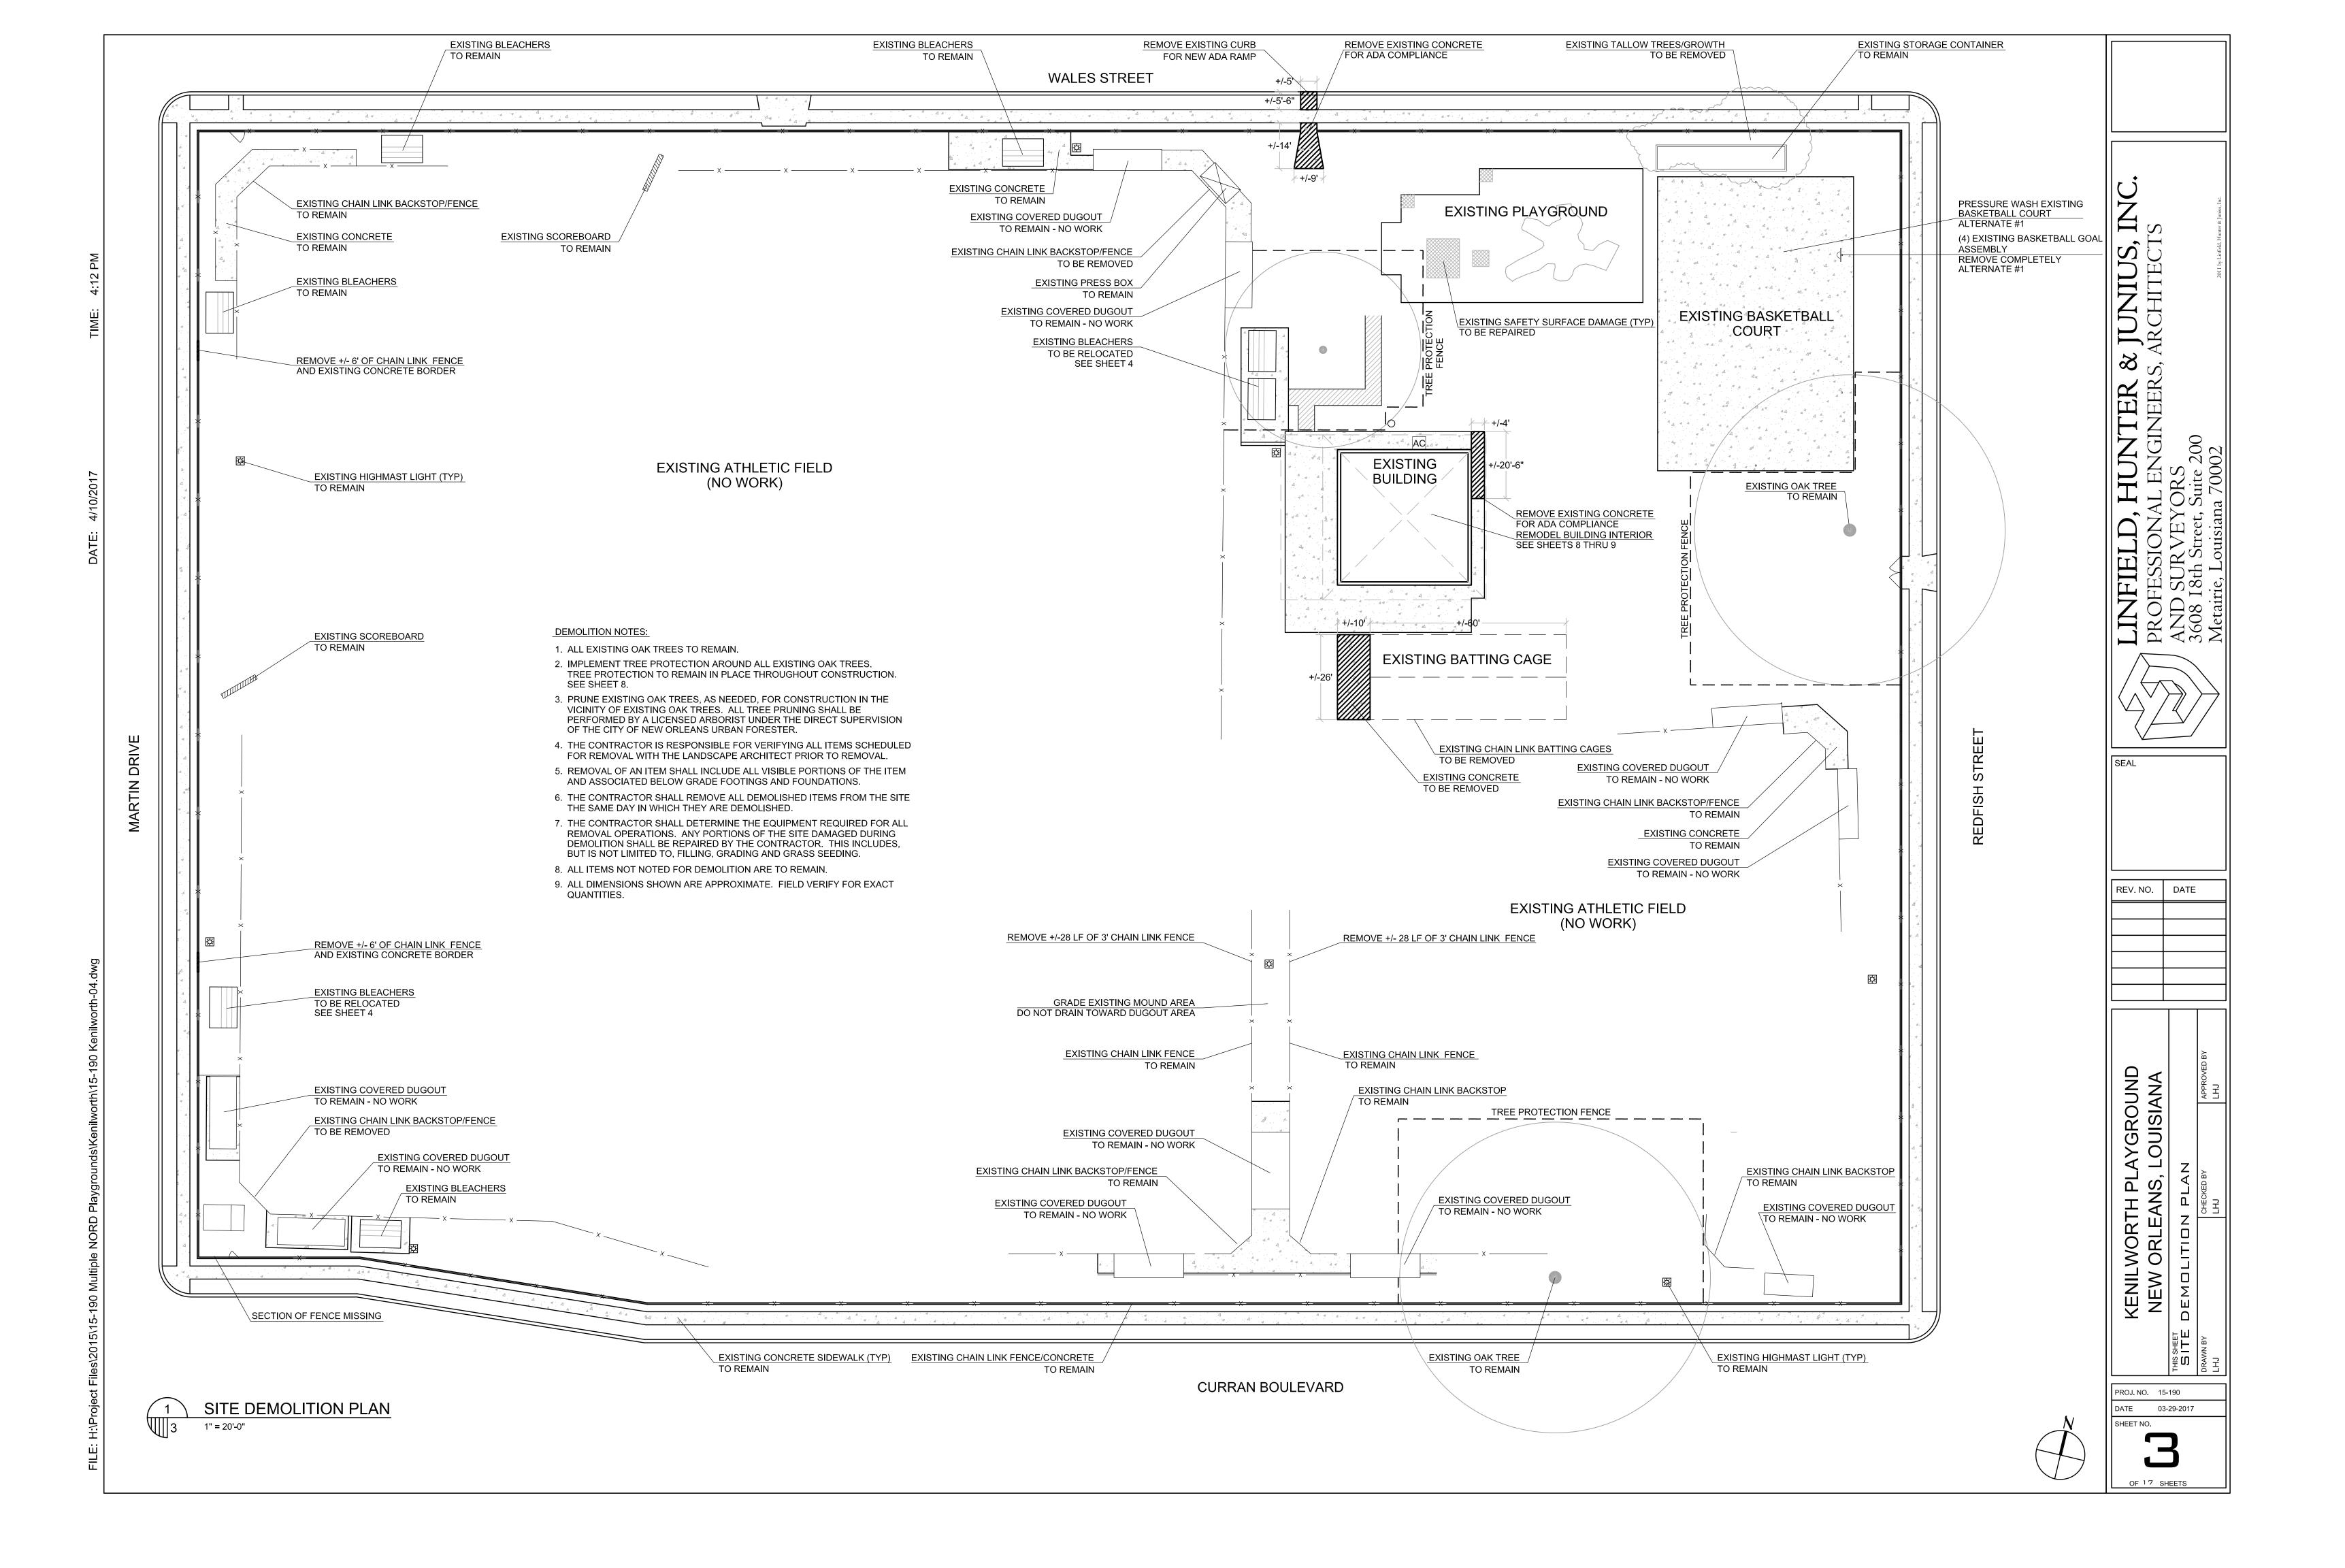

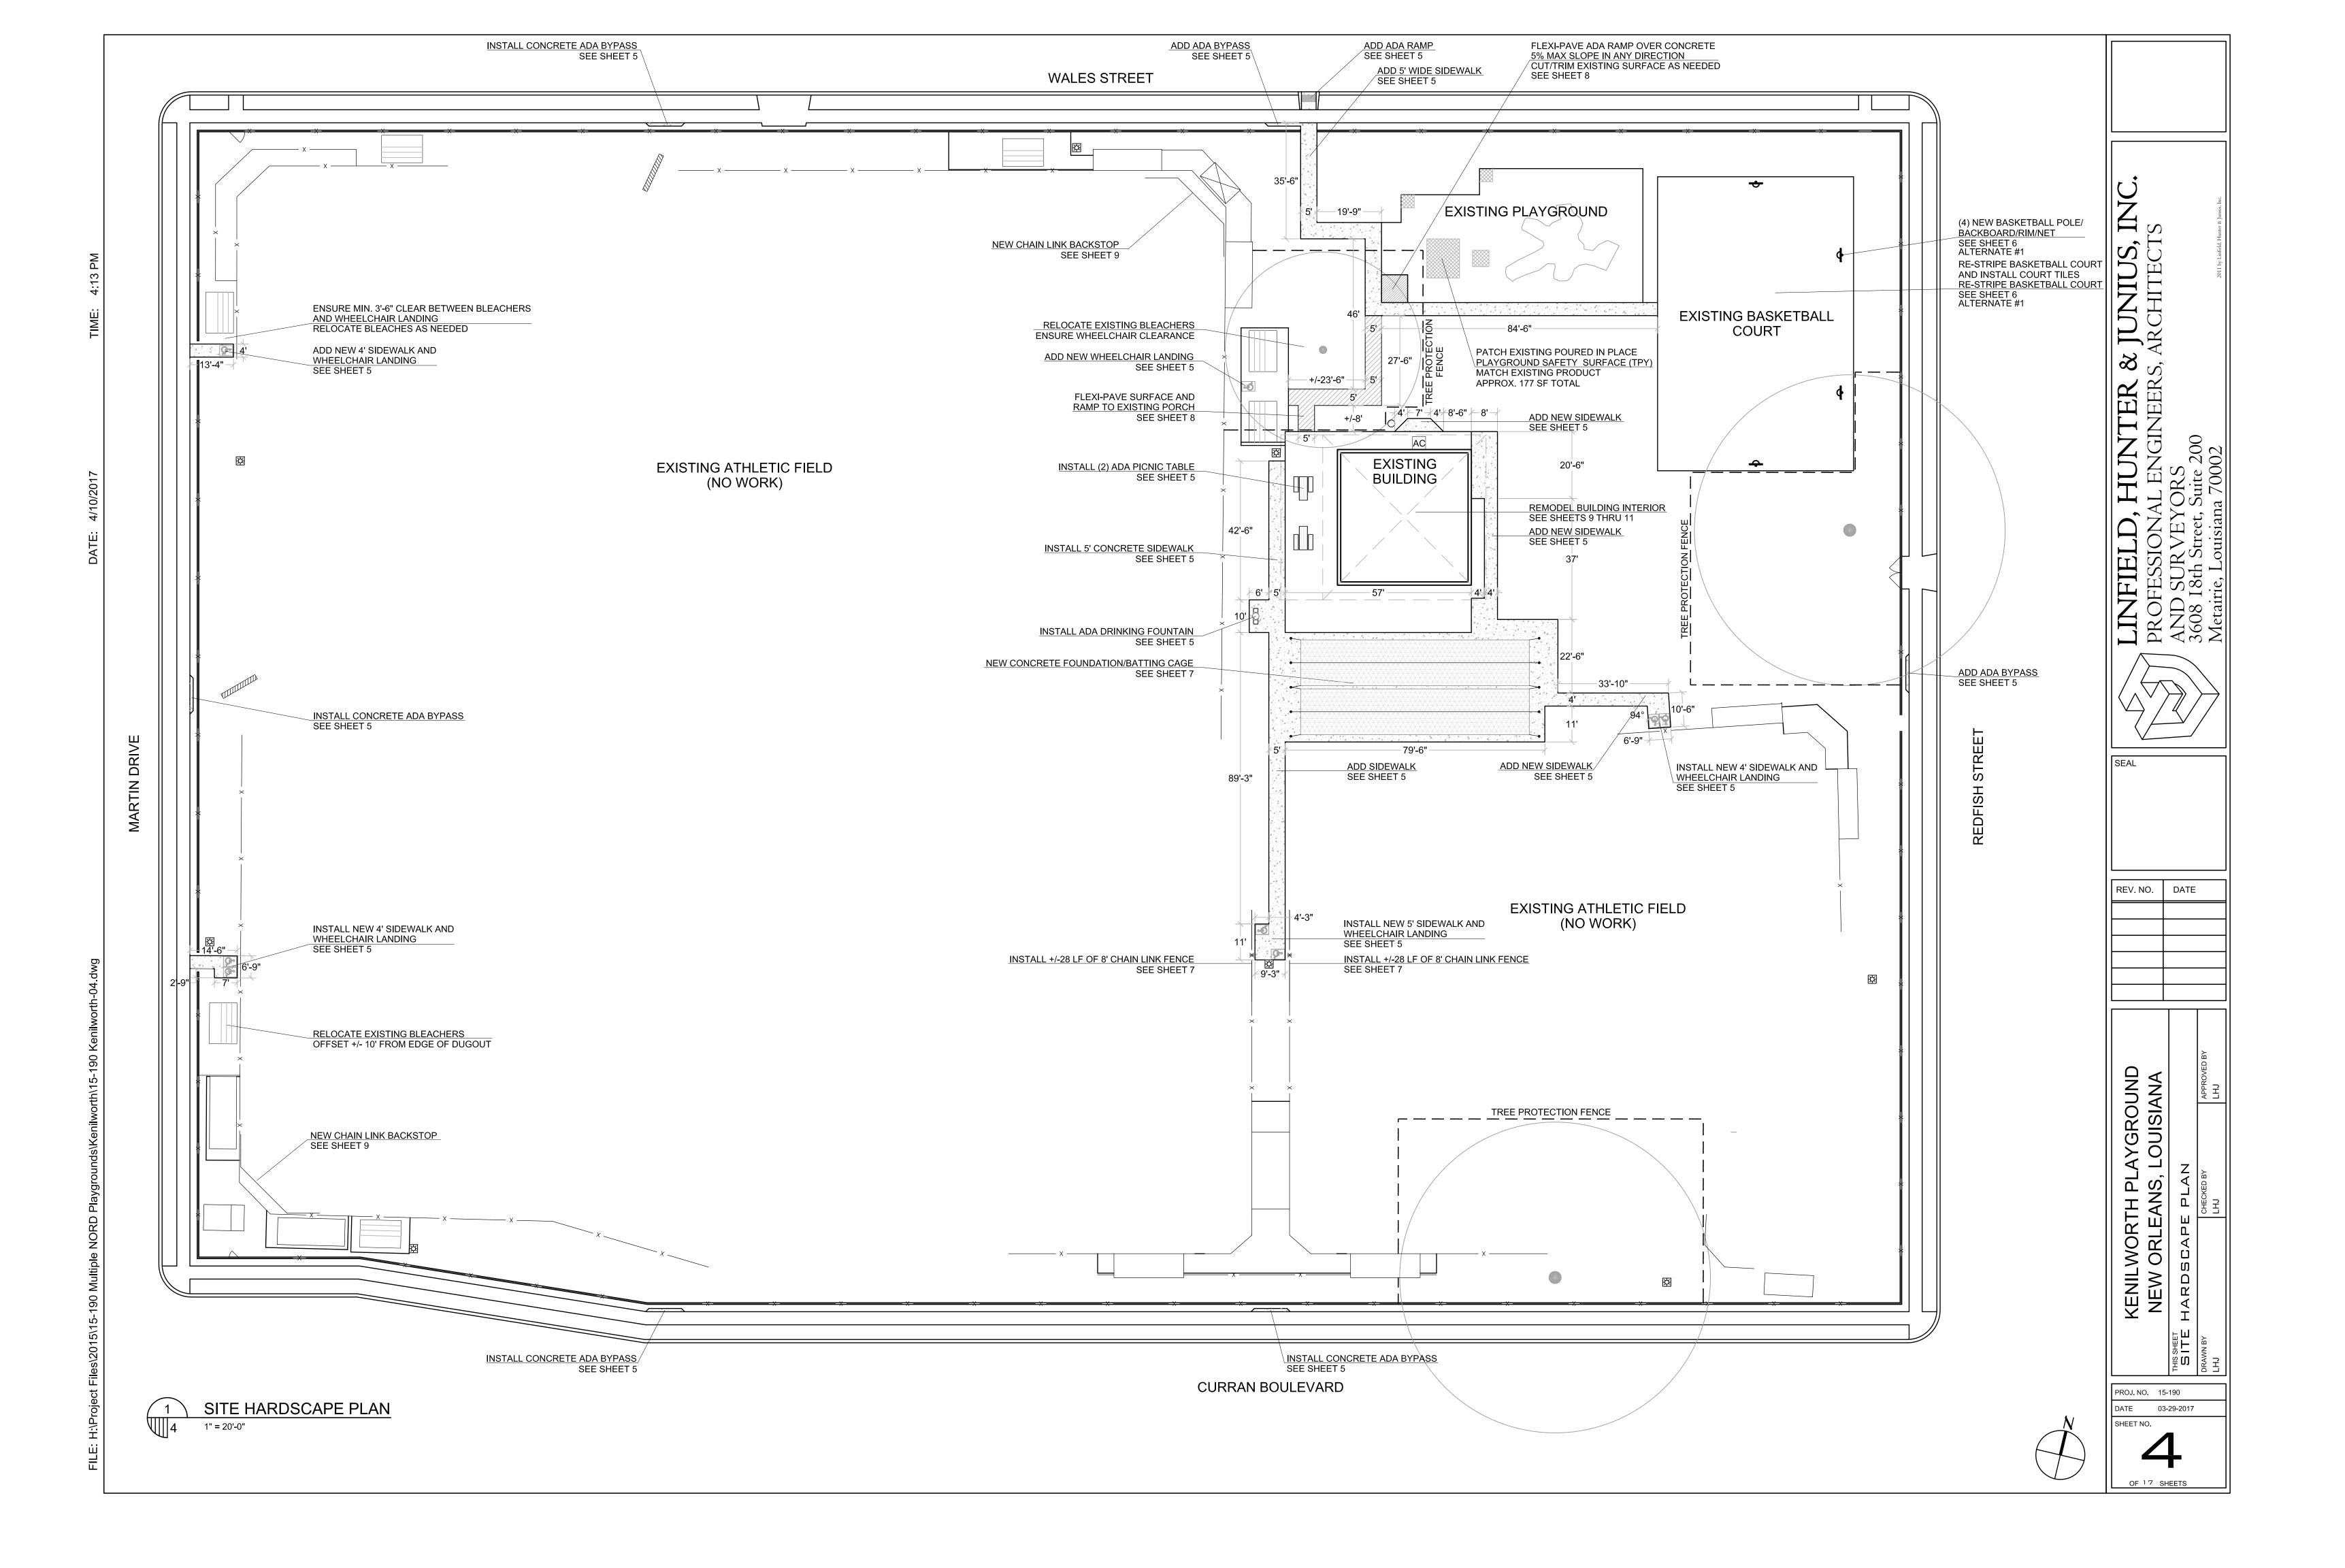

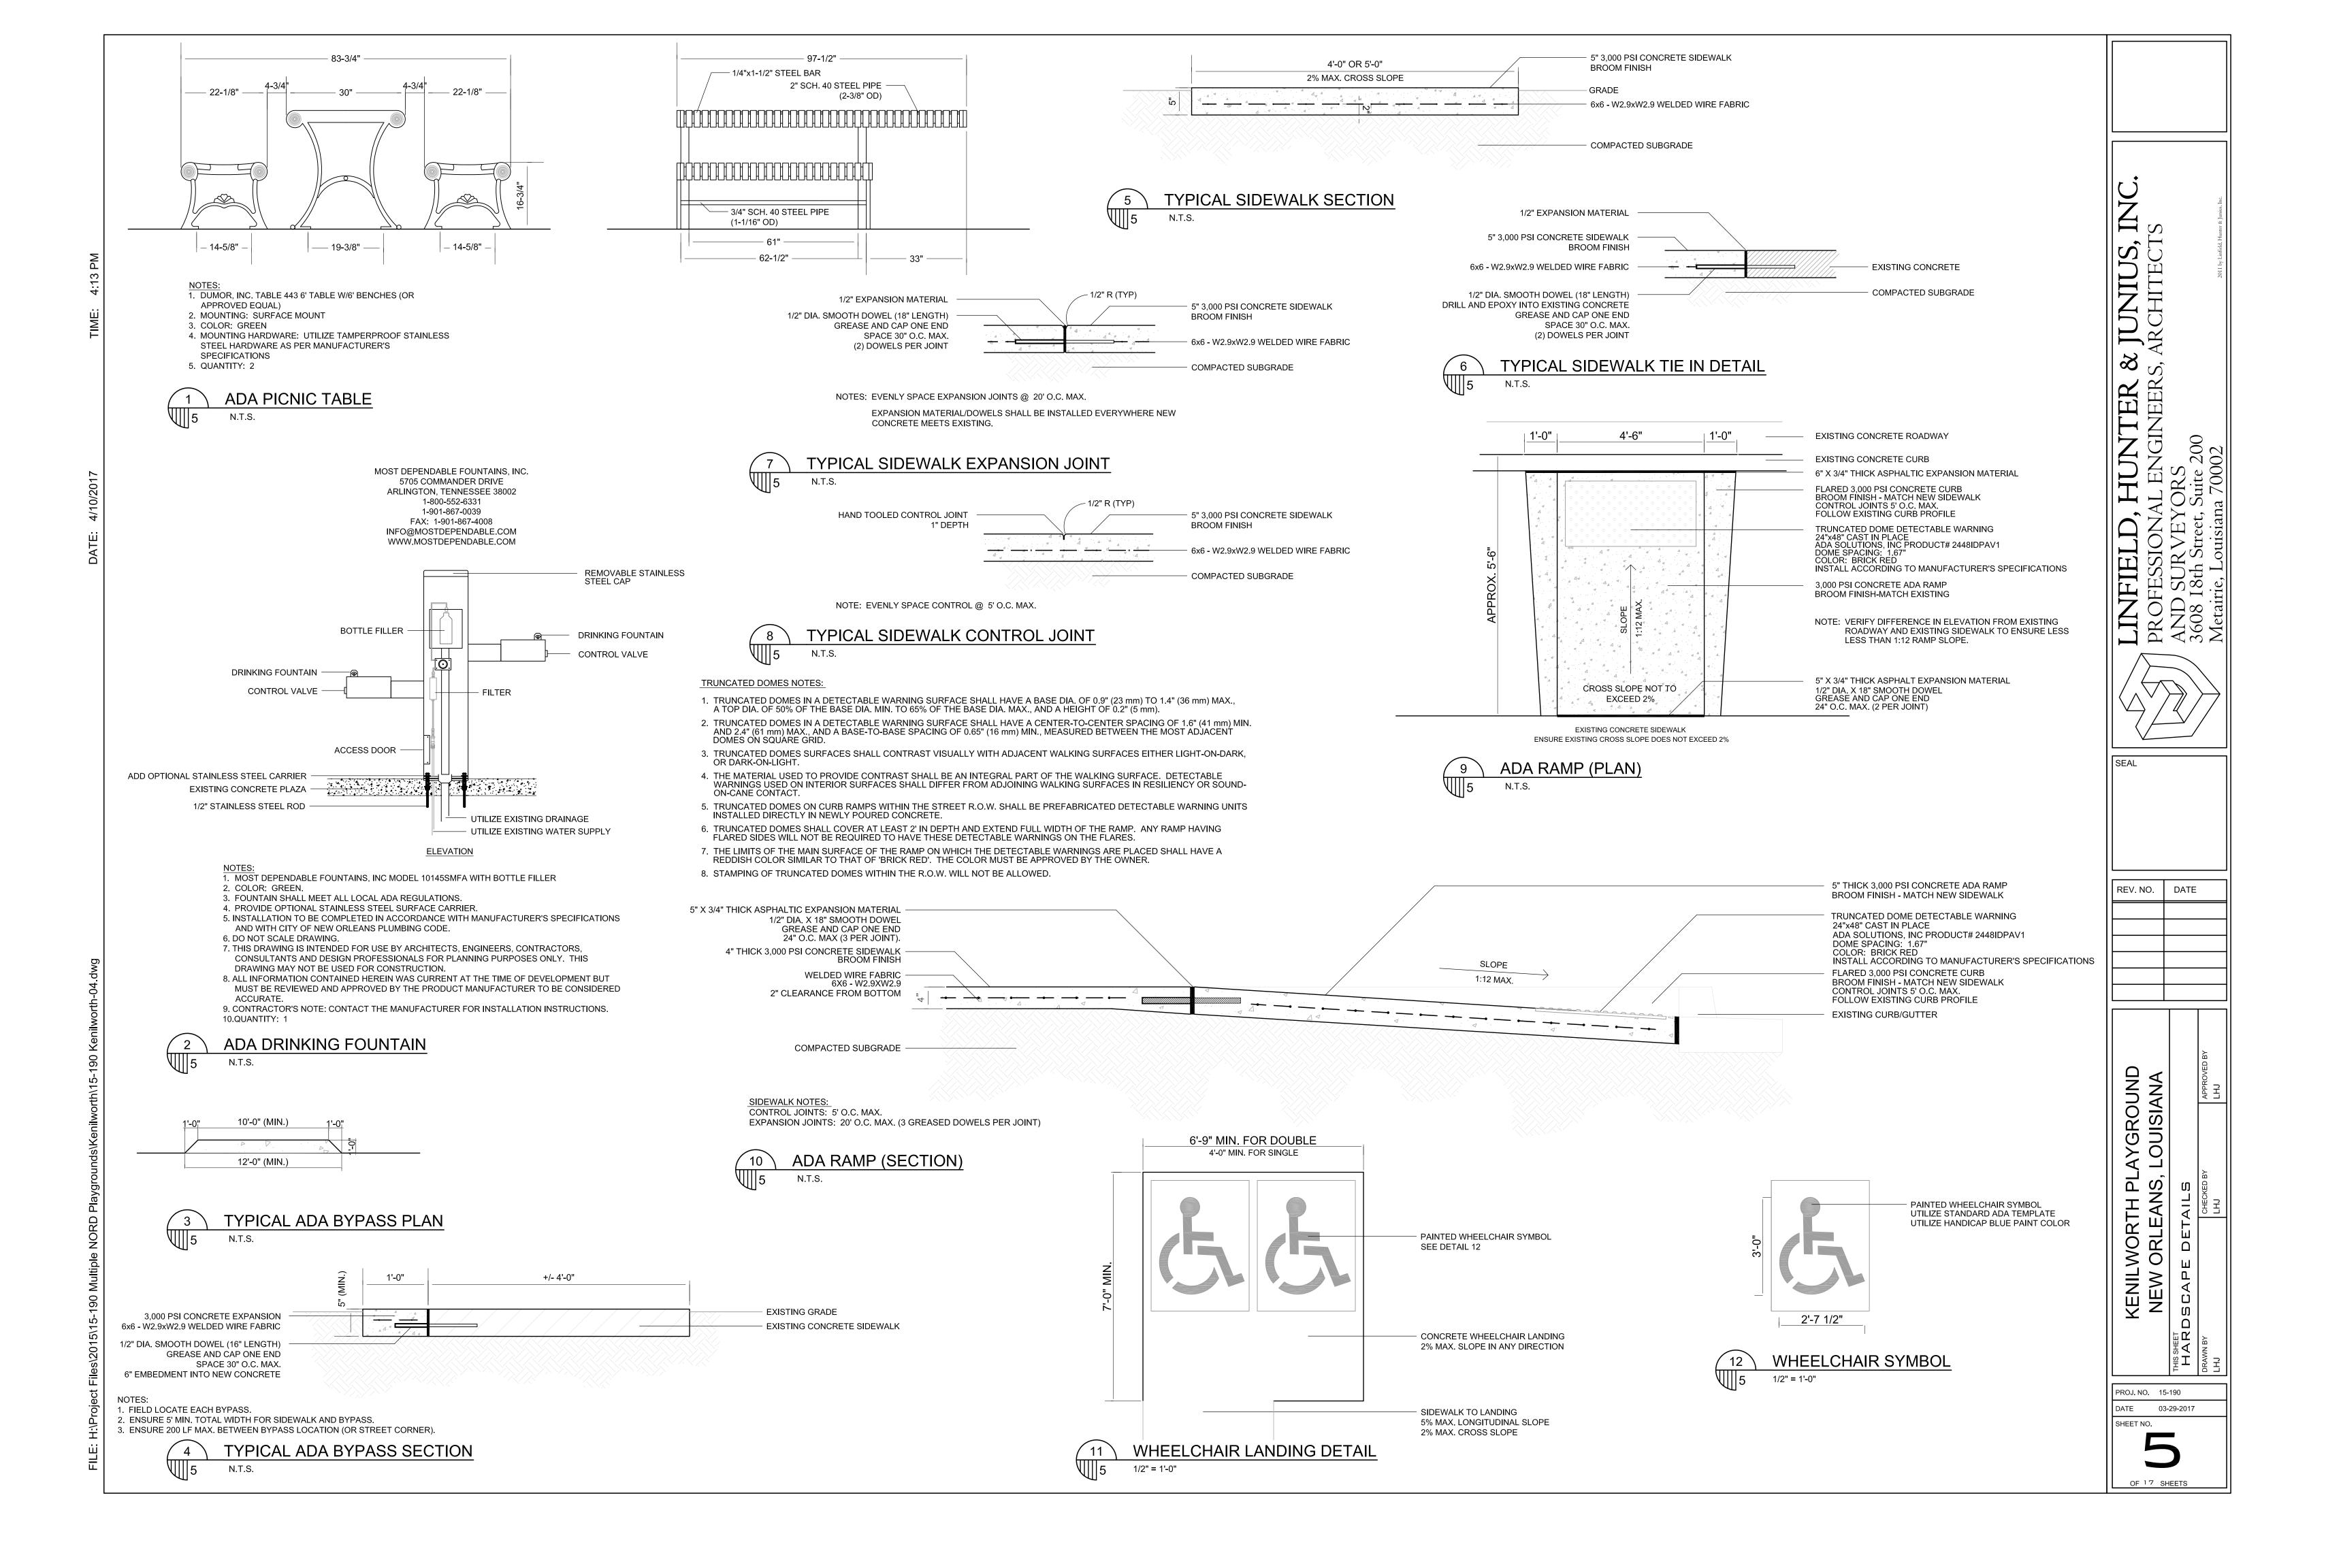


1. REMOVE ALL EXISTING BACKBOARDS, GOALS AND NETS AND DISPOSE OF OFF SITE. ALL POLES WILL BE USED FOR MOUNTING


2. INSTALL TWO (2) NEW BASKETBALL BACKBOARDS/GOALS/NETS ON THE REDFISH STREET SIDE OF THE COURT (ON THE EXISTING BRACKETS). INSTALL DRAPER, INC. PART NUMBER: 503148 (OR APPROVED EQUAL). SEE DETAILS 3 & 4

3. INSTALL TWO (2) NEW BASKETBALL BACKBOARDS/GOALS/NETS ON THE WALES STREET AND CURRAN BOULEVARD ENDS OF THE COURT (ON THE EXISTING RETRACTABLE BRACKETS). INSTALL DRAPER, INC. PART NUMBER: 503167 (OR APPROVED EQUAL). SEE DETAILS 2 & 4

### REDFISH STREET SIDE

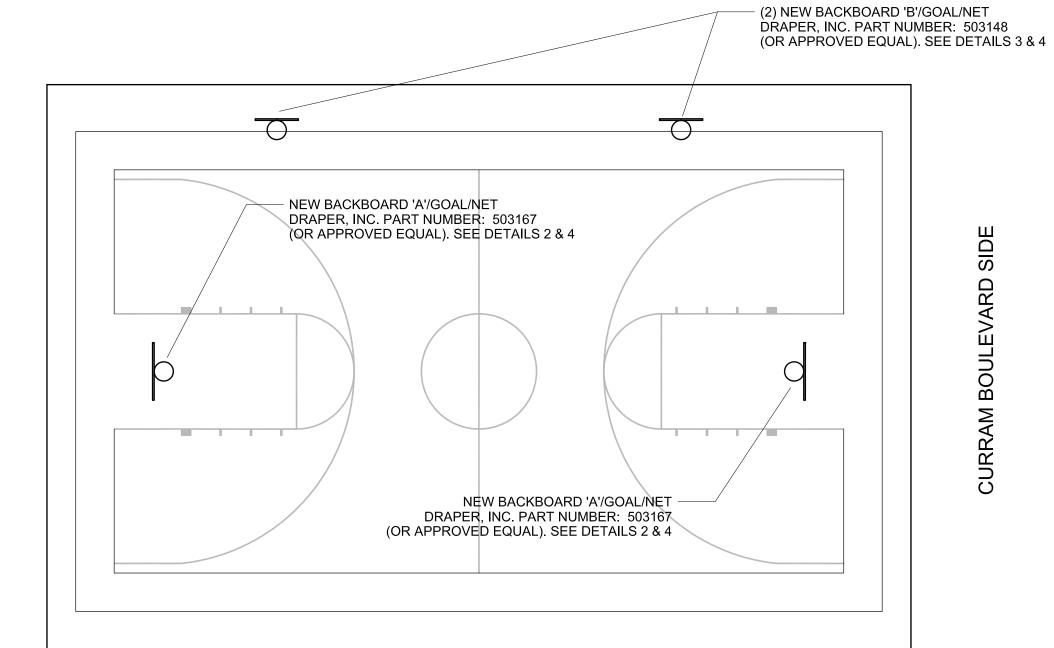

BASKETBALL COURT TILE PLAN (ALTERNATE #1)

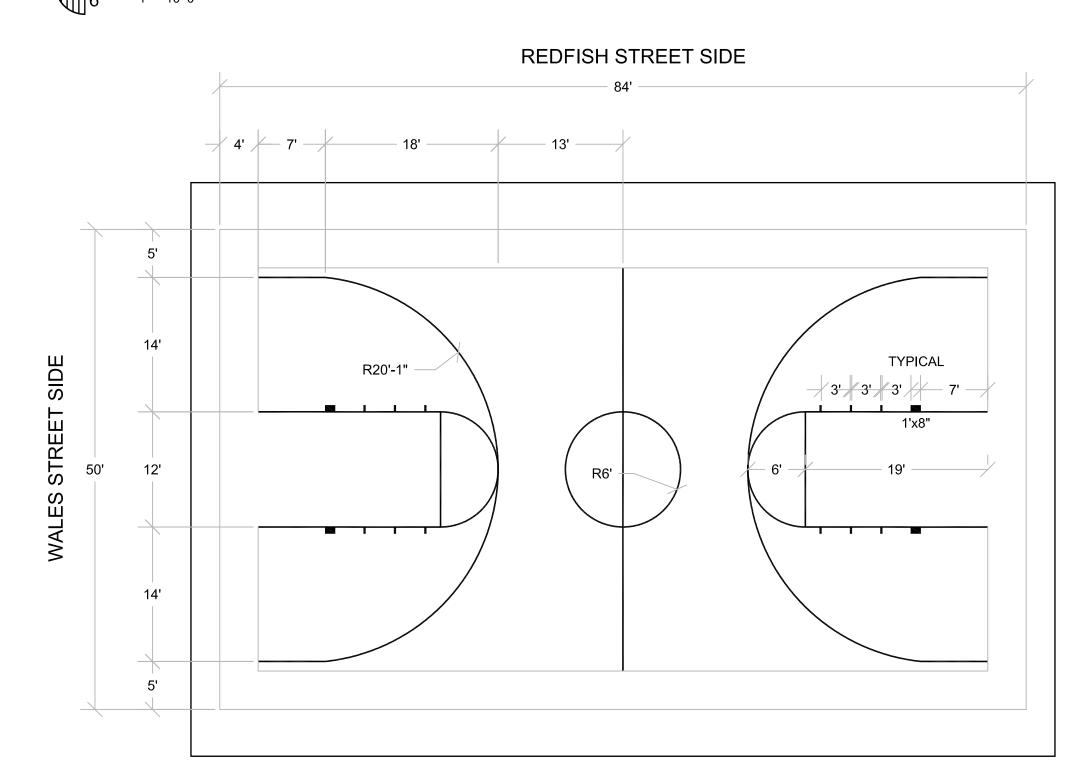

**COURT STRIPING NOTES:** 

1. PRESSURE WASH EXISTING COURT. FILL ALL CRACKS WITH SELF LEVELING SEALANT.


2. PRIME ALL COURT LINES WITH A CONCRETE PRIMER INTENDED FOR COURT STRIPING. 3. AFTER PRIMING, PAINT COURT LINES WITH A CONCRETE PAINT INTENDED FOR COURT STRIPING.

4. ALL STRIPING SHALL BE WHITE IN COLOR.


5. ALL STRIPES SHALL BE 2" WIDTH (NEUTRAL ZONES EXCLUDED).

**BASKETBALL STRIPING PLAN (ALTERNATE #1)** 

MANUFACTURER: DRAPER, INC. 411 S. PEARL STREET SPICELAND, INDIANA 47385 765-987-7999 (OR APPROVED EQUAL)

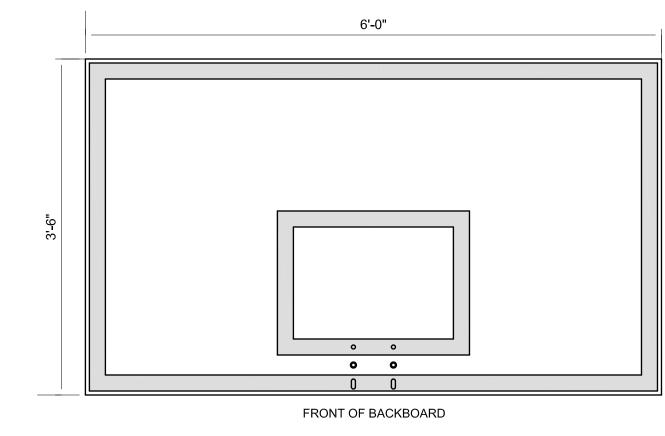

SIDE OF BACKBOARD

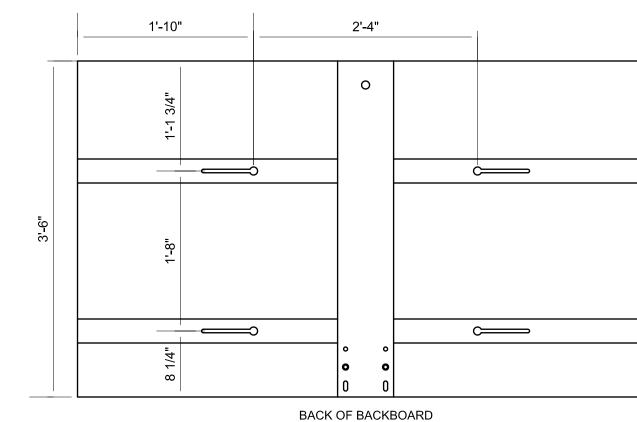

LOCAL DISTRIBUTOR: HAHN ENTERPRISES, INC.

3702 BIENVILLE STREET

504-488-3536

NEW ORLEANS, LOUISIANA 70119


BASKETBALL BACKBOARD 'A' (ALTERNATE #1)


LOCAL DISTRIBUTOR: HAHN ENTERPRISES, INC.


3702 BIENVILLE STREET

NEW ORLEANS, LOUISIANA 70119


504-488-3536

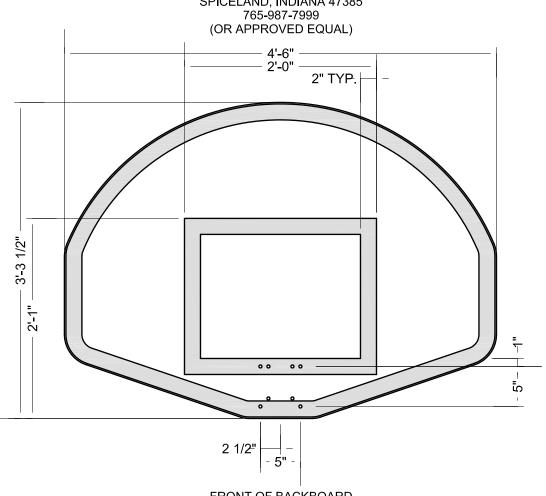


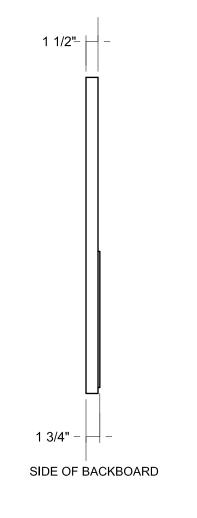


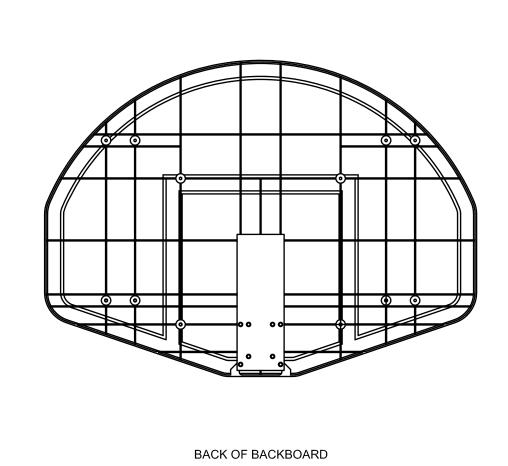



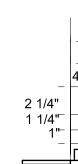


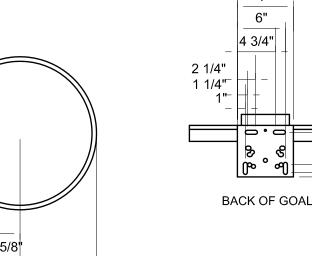


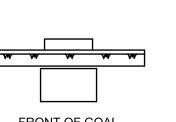

MANUFACTURER:

15 DEG. DOWNWARD DEFLECTION OUTDOOR BREAKAWAY GOAL INSTALL HEAVY-DUTY NYLON NET

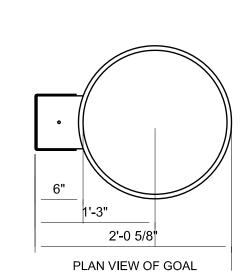

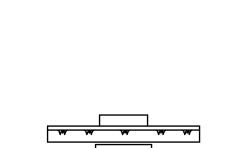

FRONT OF GOAL

Z

& JUNIUS,
ARCHITECT

8

LINFIELD, HUNTER
PROFESSIONAL ENGINEER

SEAL

REV. NO. DATE

DATE 03-29-2017

MATERIAL: 12 GAUGE STEEL WITH BORDER AND TARGET FINISHING: GLOSS WHITE POWDERCOAT FINISH WITH ORANGE SILK-SCREENED PERIMETER AND TARGET AREA QUANTITY: ADDITIONAL:

BACKBOARD 'A'

PART NUMBER:

MANUFACTURER:


ADD (2) GOALS/NETS, SEE DETAIL 4 NOTE: INSTALL IN ACCORDANCE WITH THE MANUFACTURER'S SPECIFICATIONS

REPLACEMENT BASKETBALL BACKBOARD (WALES ST AND CURRAN BLVD SIDES):

DRAPER, INC.

503167 72"x42"

> MANUFACTURER: DRAPER, INC. 411 S. PEARL STREET SPICELAND, INDIANA 47385

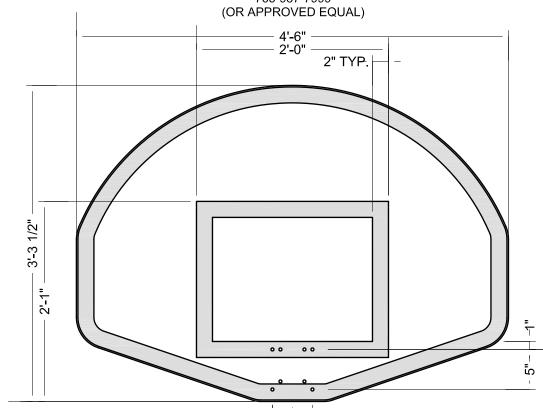

FRONT OF BACKBOARD

BACKBOARD 'B' REPLACEMENT BASKETBALL BACKBOARD (REDFISH ST SIDE):

DRAPER, INC. MANUFACTURER: PART NUMBER: MATERIAL:


HIGH STRENGTH FIBERGLASS FINISHING: GLOSS WHITE POWDERCOAT FINISH WITH ORANGE SILK-SCREENED PERIMETER AND TARGET AREA

QUANTITY: ADDITIONAL: ADD (2) GOALS/NETS, SEE DETAIL 4 NOTE: INSTALL IN ACCORDANCE WITH THE MANUFACTURER'S SPECIFICATIONS

REPLACEMENT BASKETBALL GOAL:


DEFLECTION: DESCRIPTION:

QUANTITY: NOTE: INSTALL IN ACCORDANCE WITH THE MANUFACTURER'S SPECIFICATIONS

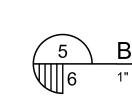

BASKETBALL GOAL (ALTERNATE #1)

1" = 1'-0"

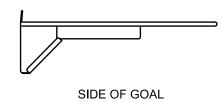

BEACON ATHLETICS
8233 FORSYTHIA STREET
SUITE 120
MIDDLETON, WISCONSON 53562
1-800-747-5985
FAX: 1-608-836-0724
WWW.BEACONATHLETICS.COM

79-6"

BATTING CAGE POST (TYP)
SEE DETAIL 2

BATTING CAGE POST (TYP)
REFER TO MANUFACTURER'S SPECIFICATIONS

GALVANIZED STEEL CABLE AND HARDWARE (TYP)
REFER TO MANUFACTURER'S SPECIFICATIONS

6" THICK 3,000 PSI CONCRETE BATTING CAGE SURFACE
BROOM FINISH
SEE DETAIL 2
ADD FIELD TURF (SEE DETAIL 3)

NOTES:

INSTALL EXPANSION JOINT (EAST/WEST) AT CENTER OF THE BATTING CAGE FOUNDATION INSTALL EXPANSION JOINTS (NORTH/SOUTH) AT 20' O.C. MAX.

1 BATTING CAGE PLAN
1" = 10'-0"

ON DECK SPORTS
150 WOOD ROAD
SUITE 200
BRAINTREE, MA 02184
1-800-365-6171
INFO@ONDECKSPORTS.COM

3/8" HEIGHT OUTDOOR BATTING CAGE TURF
ENSURE COMPLETE COVERAGE INSIDE OF BATTING CAGE

SEE DETAIL 2

CONCRETE FOUNDATION

COMPACTED SUBGRADE


MANUFACTURER:
PRODUCT:
BCT ARTIFICIAL TURF
ITEM NO.:
NTOV1BCT
COLOR:
SOLID GREEN
FACE WEIGHT:
YARN TYPE:
MONO
HEIGHT:
DRAINABLE

BACKING: 15' WIDE

INSTALL IN ACCORDANCE WITH THE MANUFACTURER'S SPECIFICATIONS




LATEX

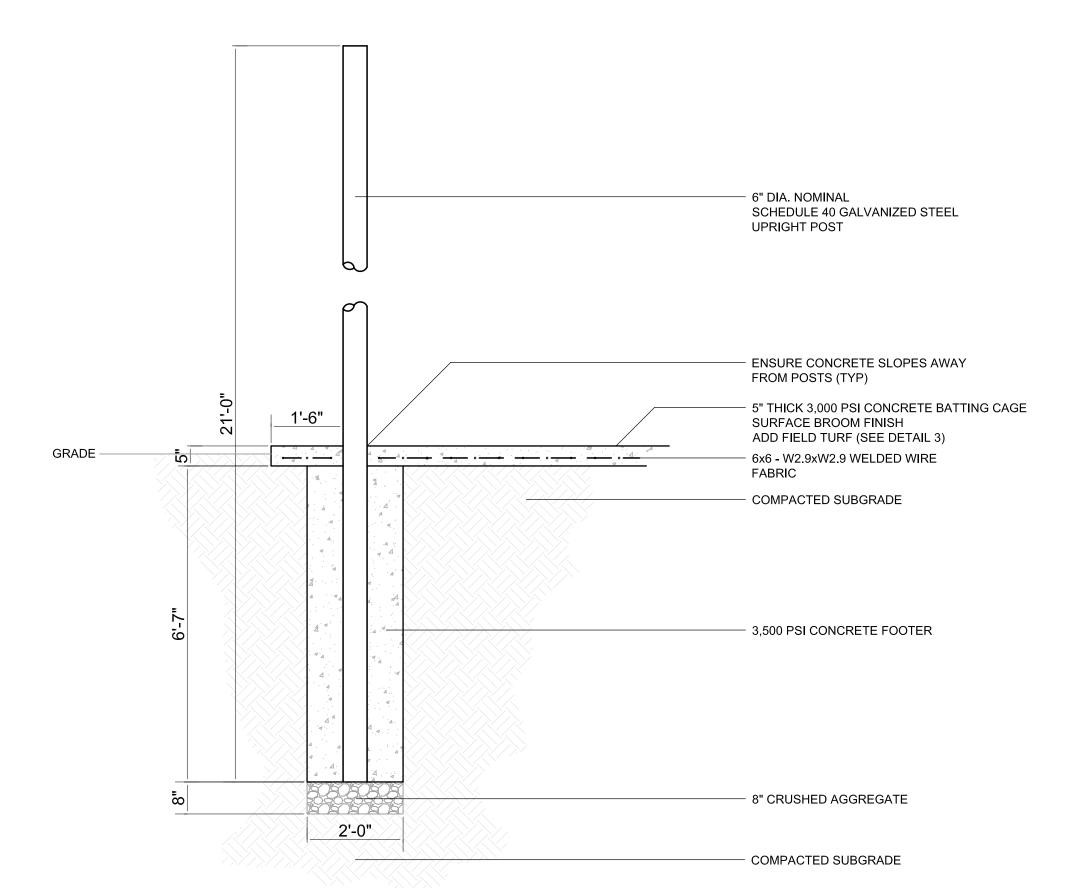


MANUFACTURER: BEACON ATHLETICS
PRODUCT: TUFF1 BATTING CAGE SYSTEM
DESCRIPTION: DOUBLE BASEBALL (70' LONG X 28' WIDE)
MODEL NUMBER: 105-100-770

INSTALL IN ACCORDANCE WITH THE MANUFACTURER'S SPECIFICATIONS



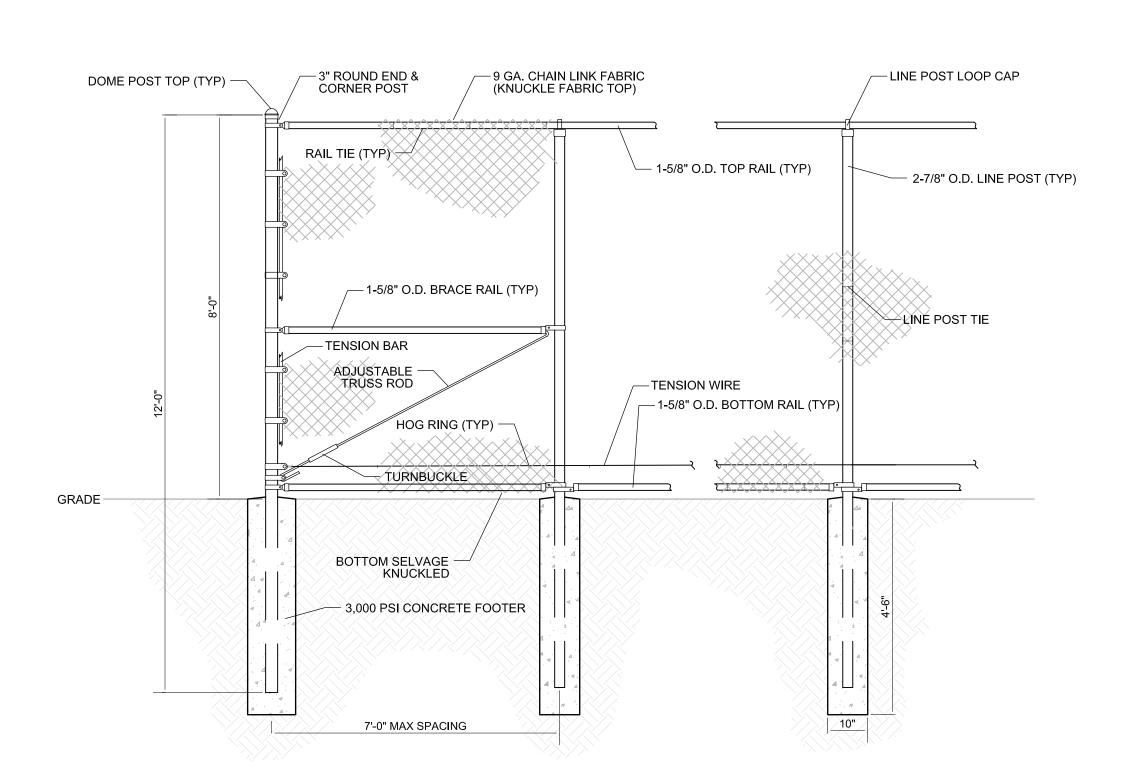



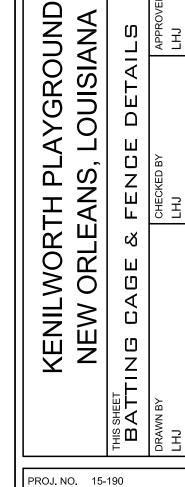

LINFIELD, HUNTER & JUNIUS, INC PROFESSIONAL ENGINEERS, ARCHITECTS AND SURVEYORS 3608 18th Street, Suite 200 Metairie, Louisiana 70002


SEAL

REV. NO. DATE

PROJ. NO. 15-190

DATE 03-29-2017

SHEET NO.

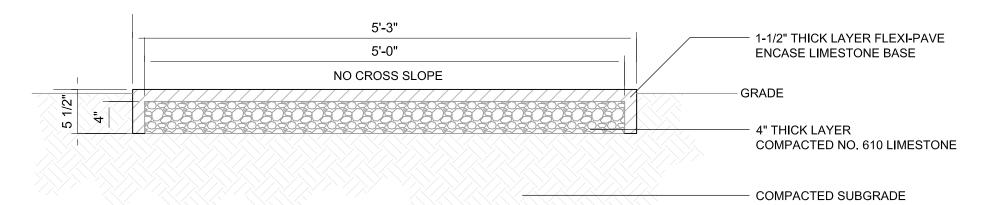


1. FLEXI-PAVE COLOR SHALL BE SELECTED BY THE OWNER FROM THE MANUFACTURER'S COLOR SAMPLES.
2. FLEXI-PAVE SHALL BE POURED AT A CONSISTENT 1-1/2" THICKNESS. ALL GRADE ADJUSTMENTS SHALL BE MADE WITH THE LIMESTONE BASE INSTALLATION.


**FLEXI-PAVE SECTION** 

EXISTING CONCRETE PORCH 5% MAX. SLOPE 1-1/2" THICK LAYER FLEXI-PAVE -ENCASE LIMESTONE BASE 4" THICK LAYER -COMPACTED NO. 610 LIMESTONE COMPACTED SUBGRADE -


FLEXI-PAVE SIDEWALK RAMP

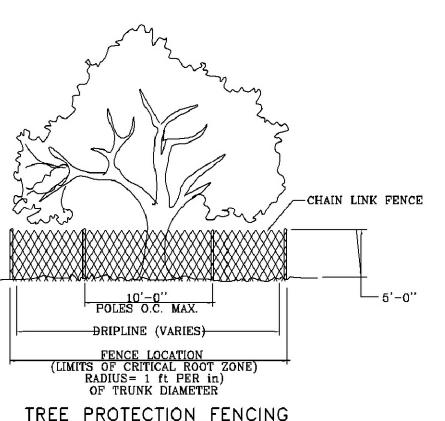


TREE PROTECTION FENCING CHAIN LINK FENCE

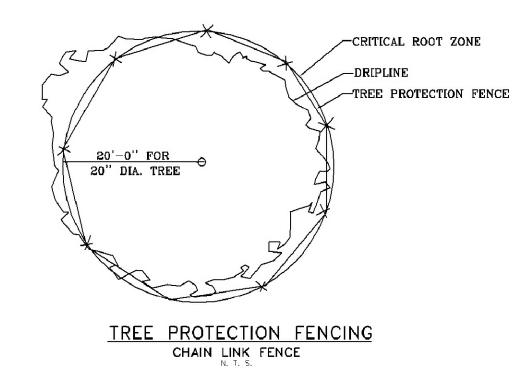


<u>NOTES:</u>
NOTICE IS TO BE POSTED ON FENCING — 15' O.C. — AND SHALL READ
"<<<WARNING>>>PROTECTIVE TREE FENCING. DO NOT ENTER, MOVE OR REMOVE"

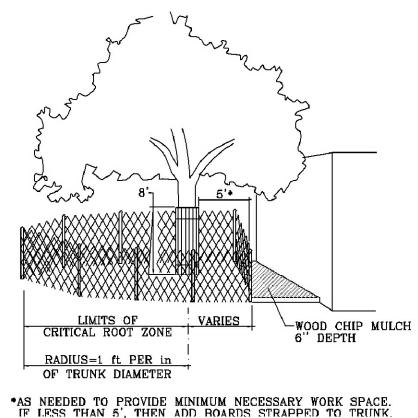


\*AS NEEDED TO PROVIDE MINIMUM NECESSARY WORK SPACE. IF LESS THAN 5', THEN ADD BOARDS STRAPPED TO TRUNK. MODIFIED TREE PROTECTION FENCING CHAIN LINK FENCE

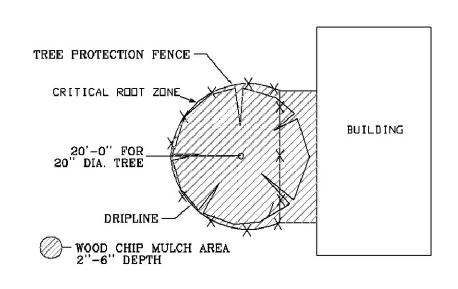

MODIFIED TREE PROTECTION FENCING
CHAIN LINK FENCE

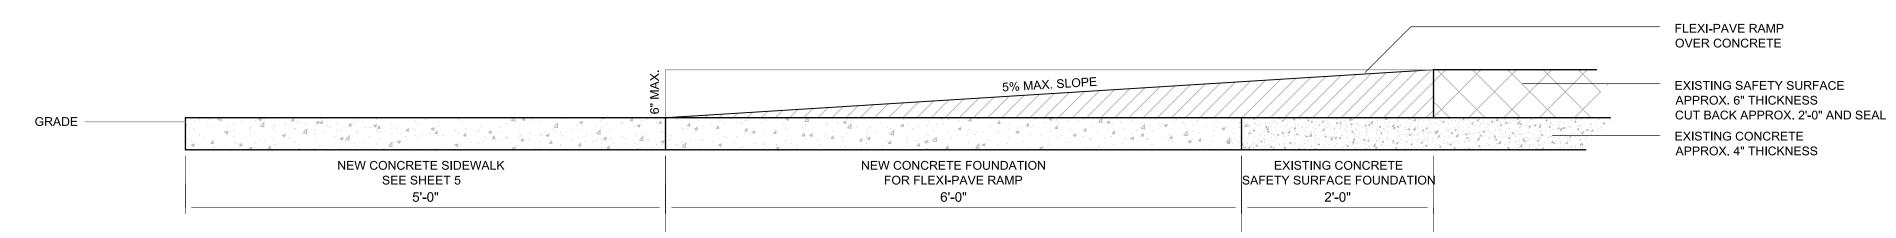



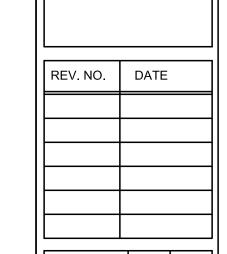


SEAL


& JUNIUS, INC.


8


HUNTER AND HAL ENGINEERS

PROJ. NO. 15-190 DATE 03-29-2017 SHEET NO.

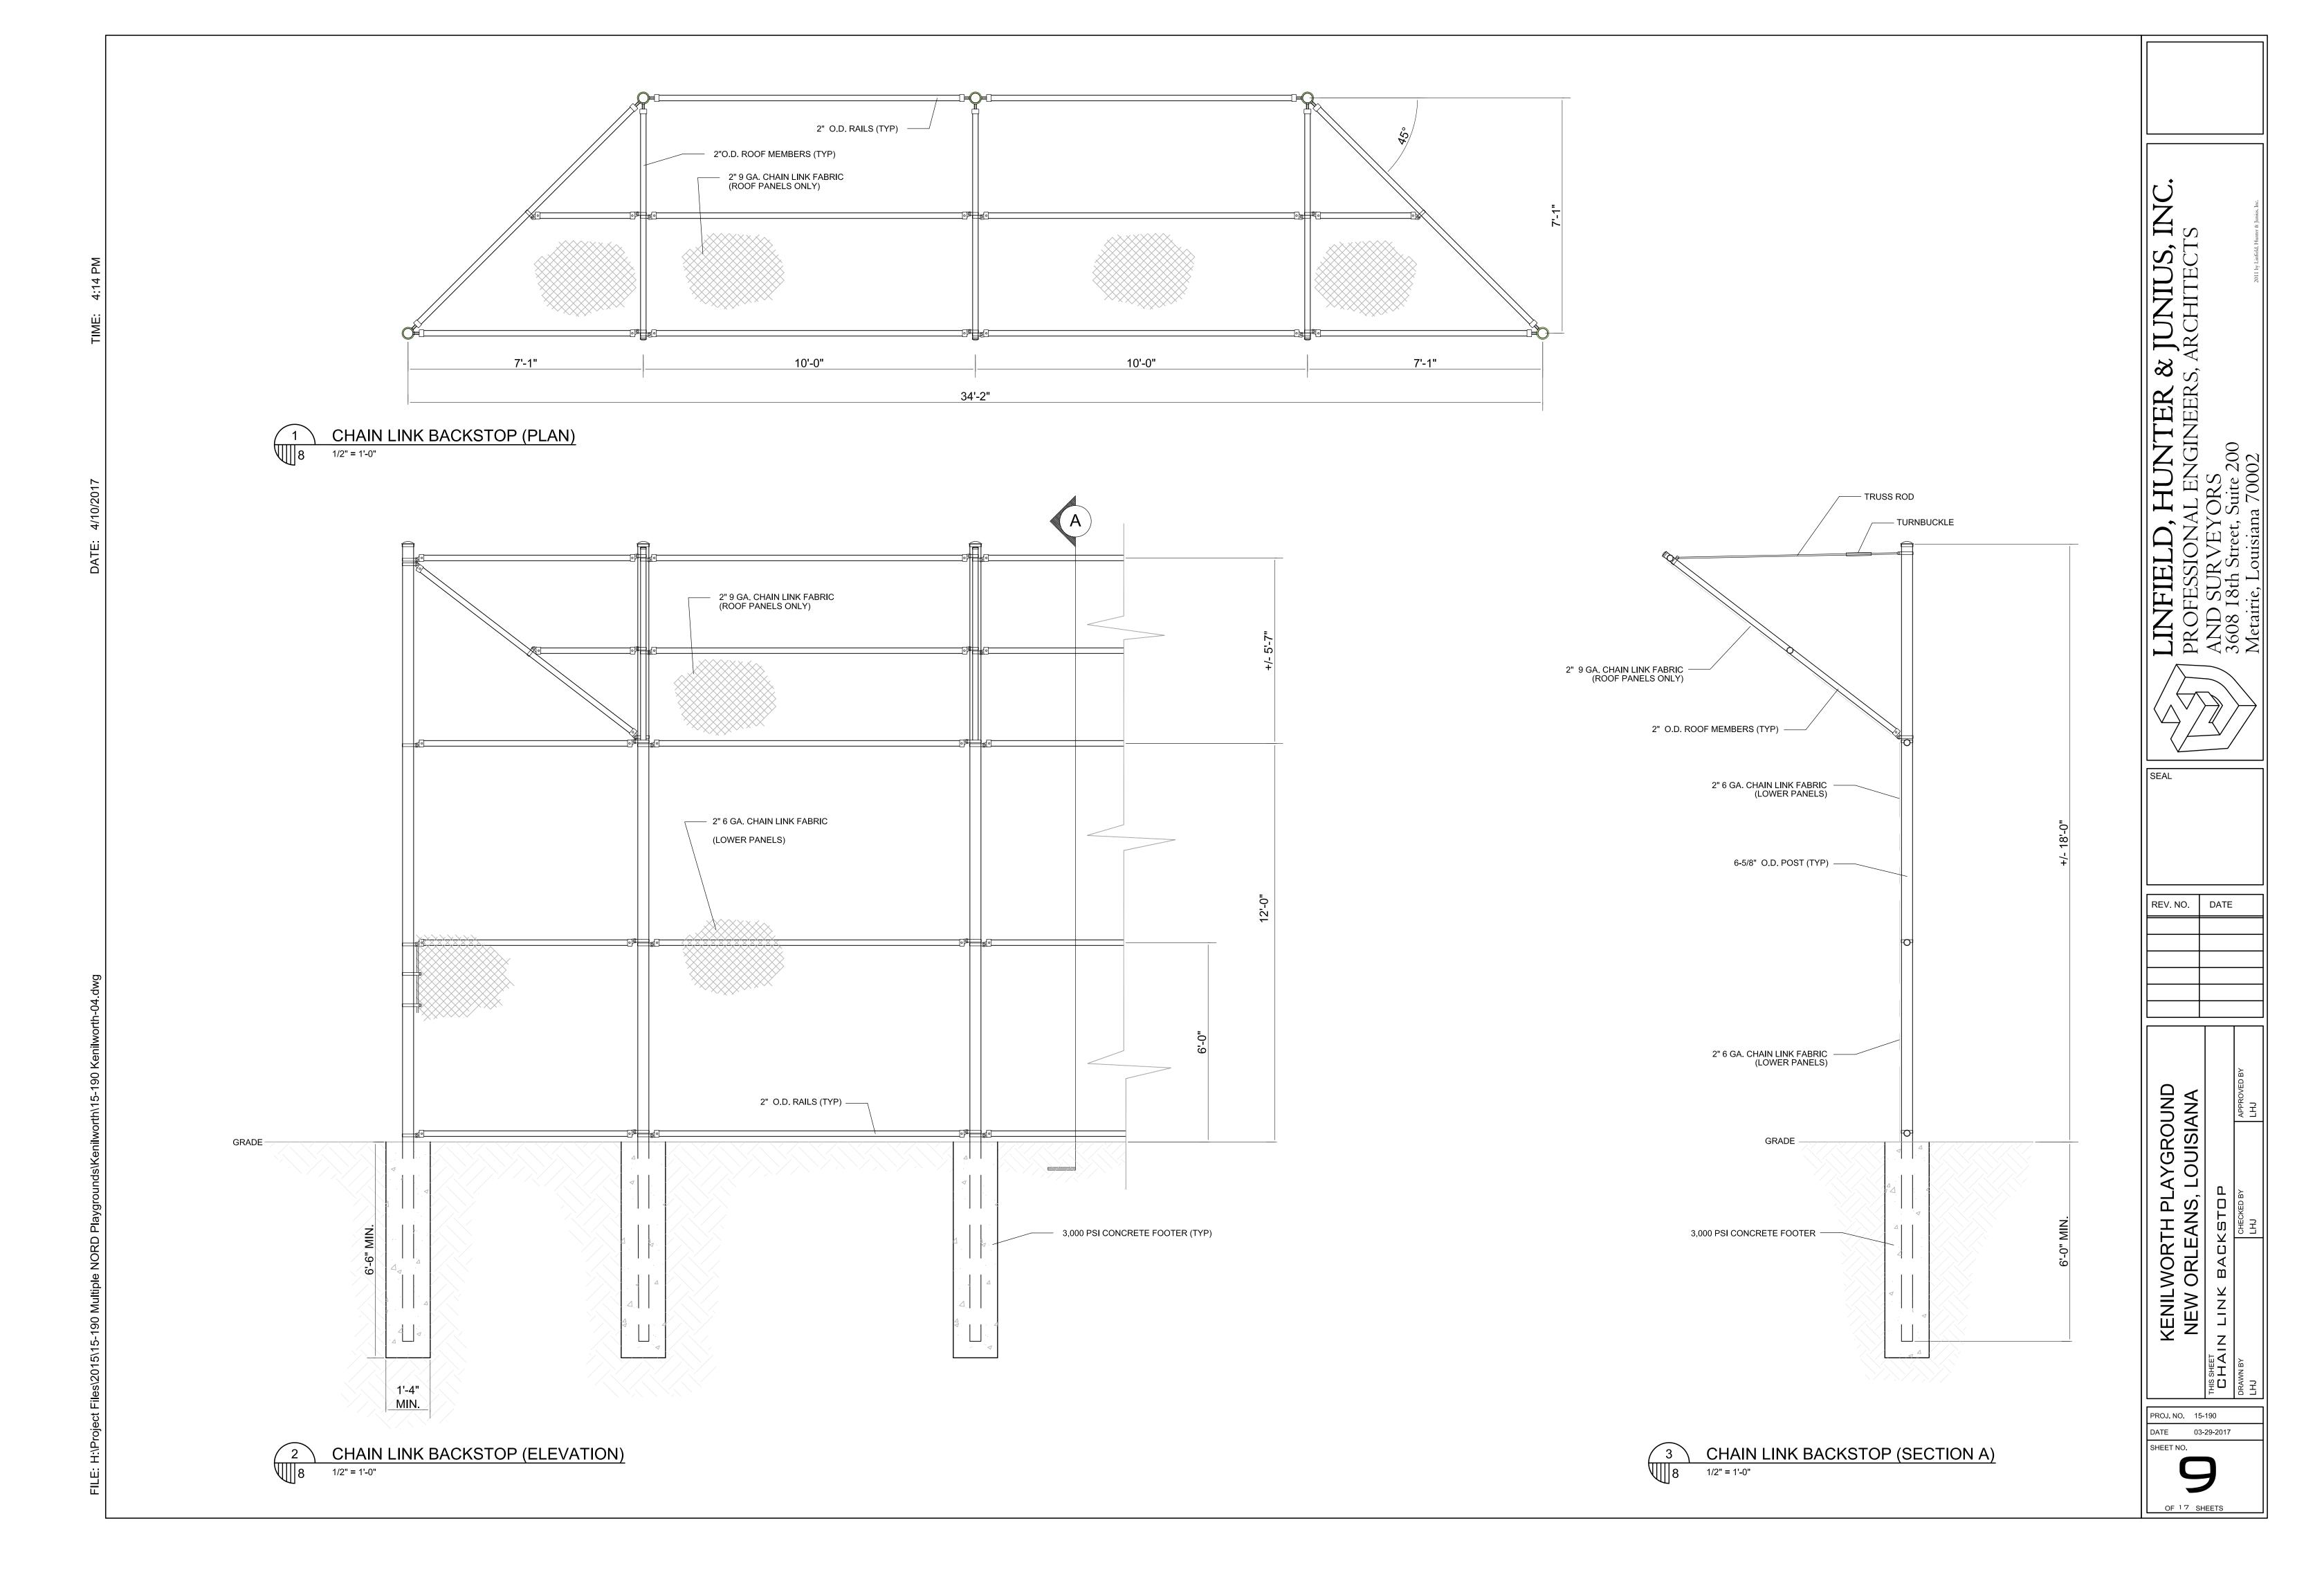

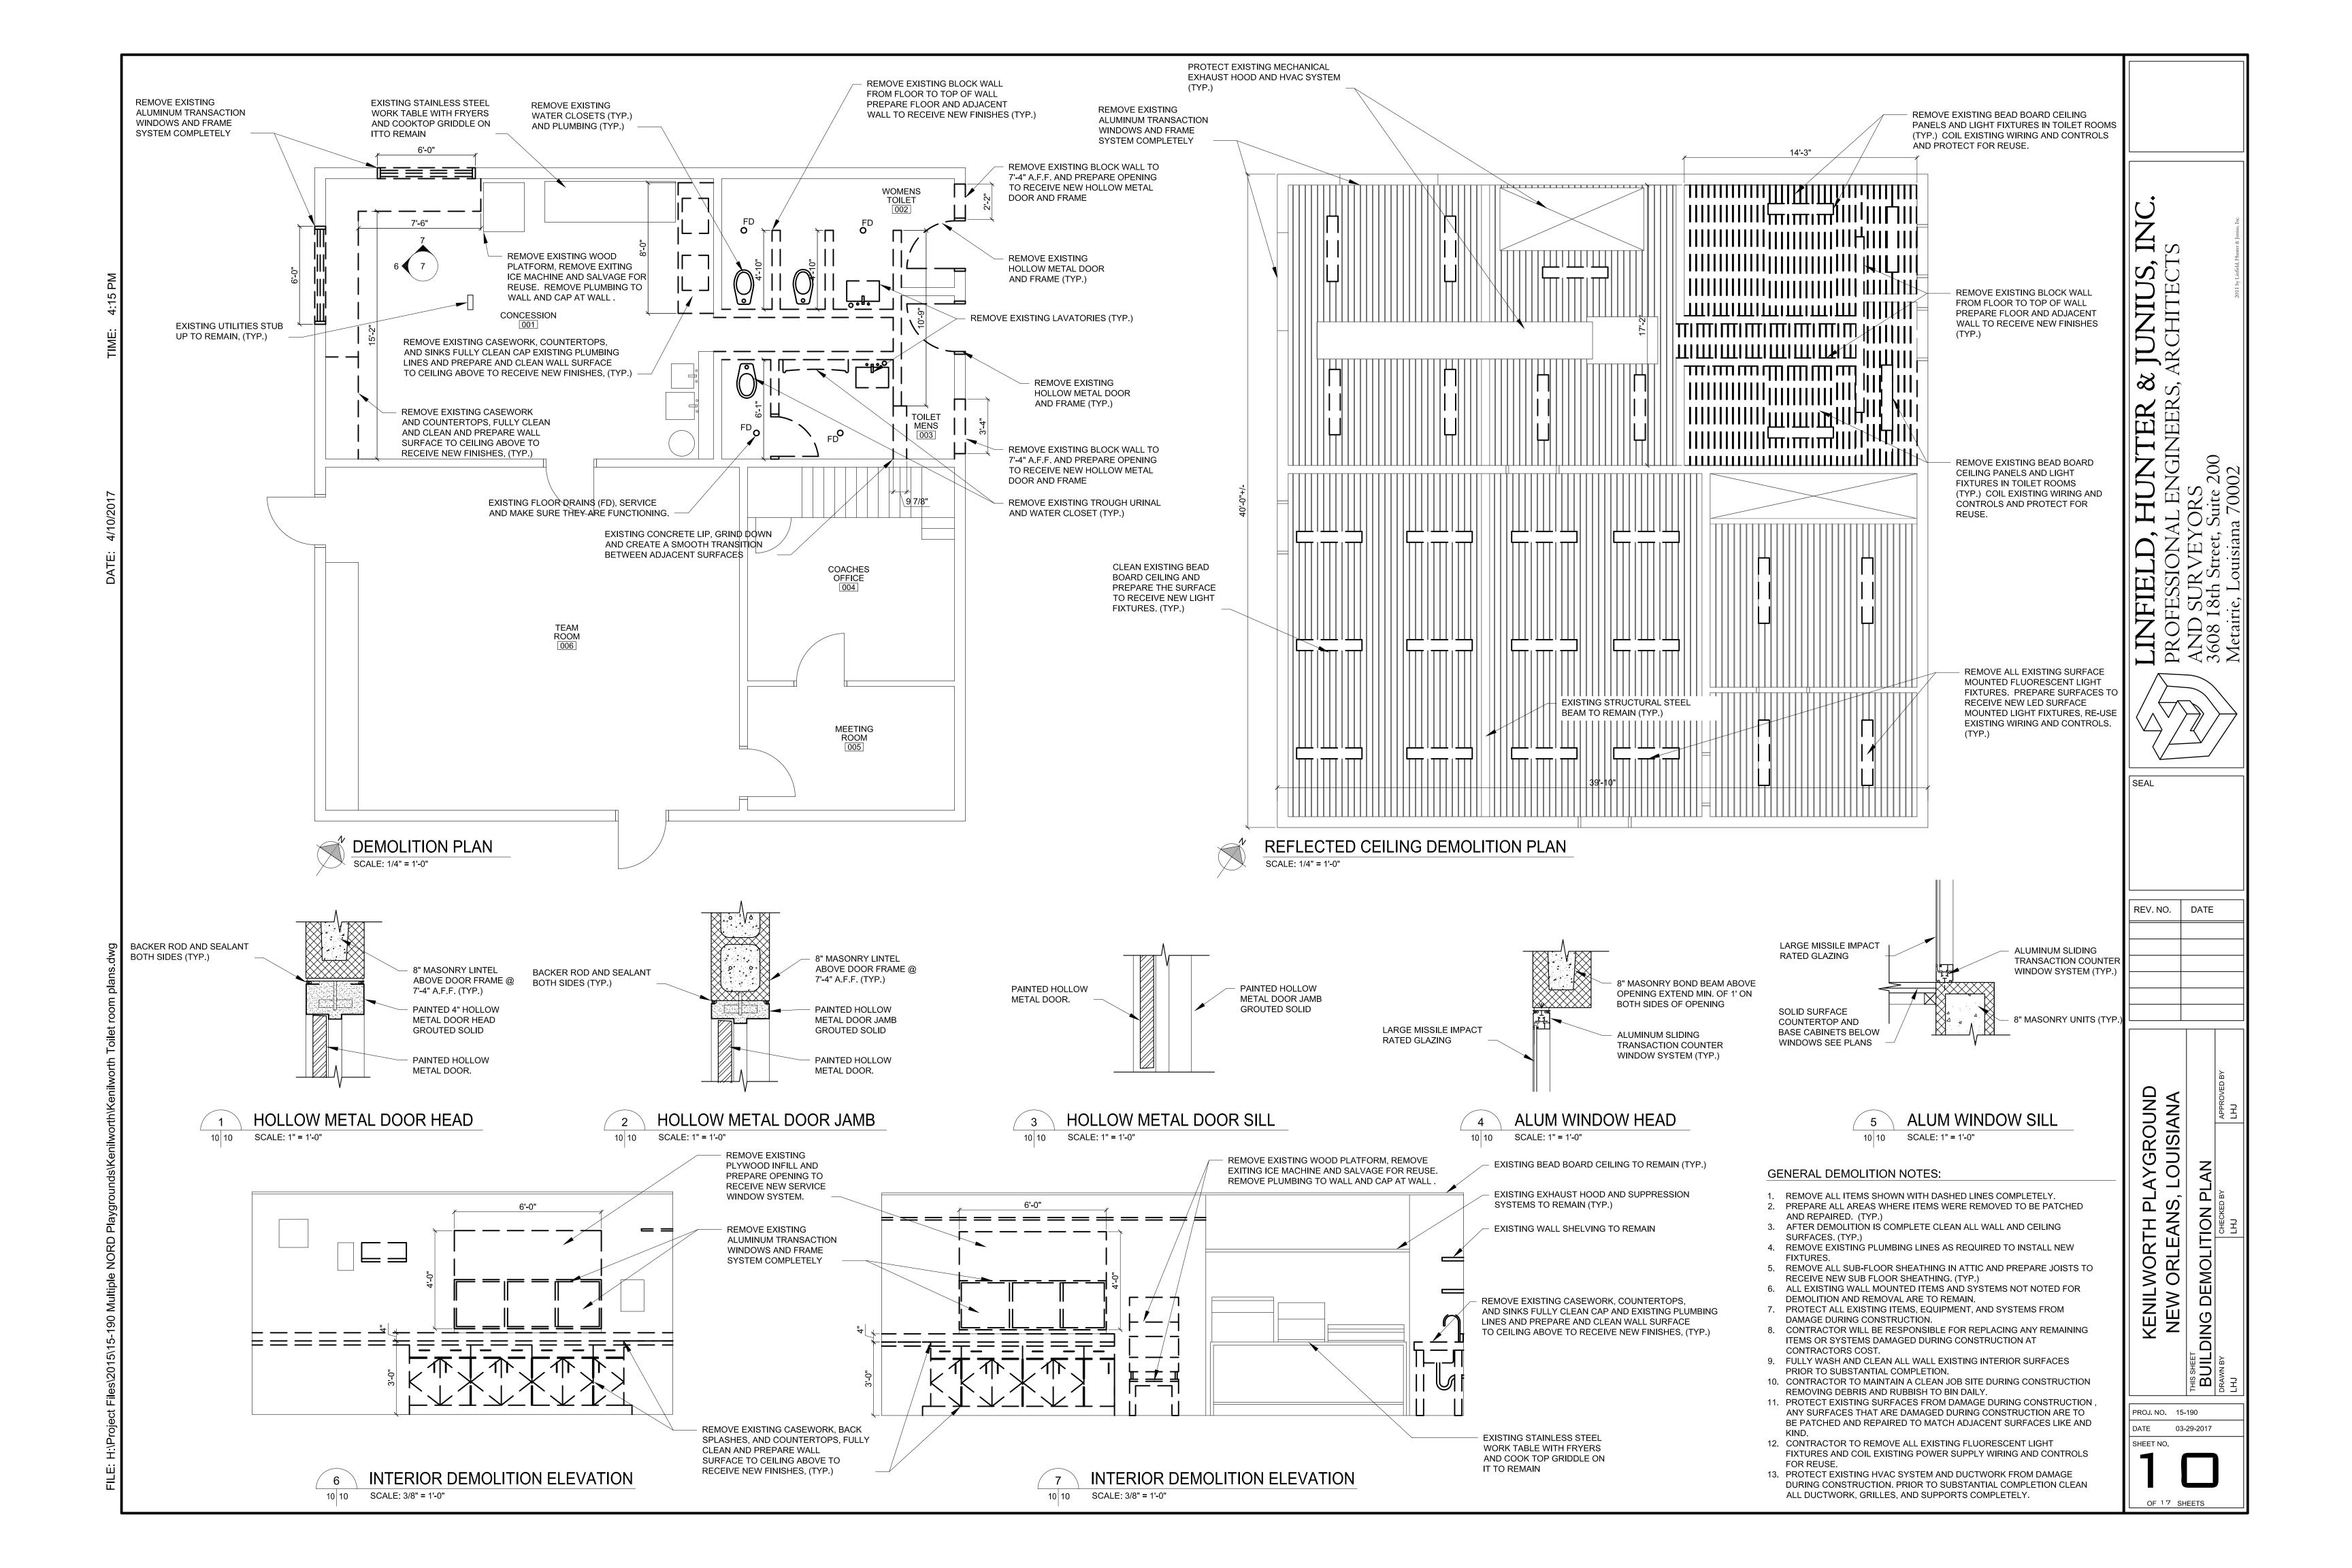


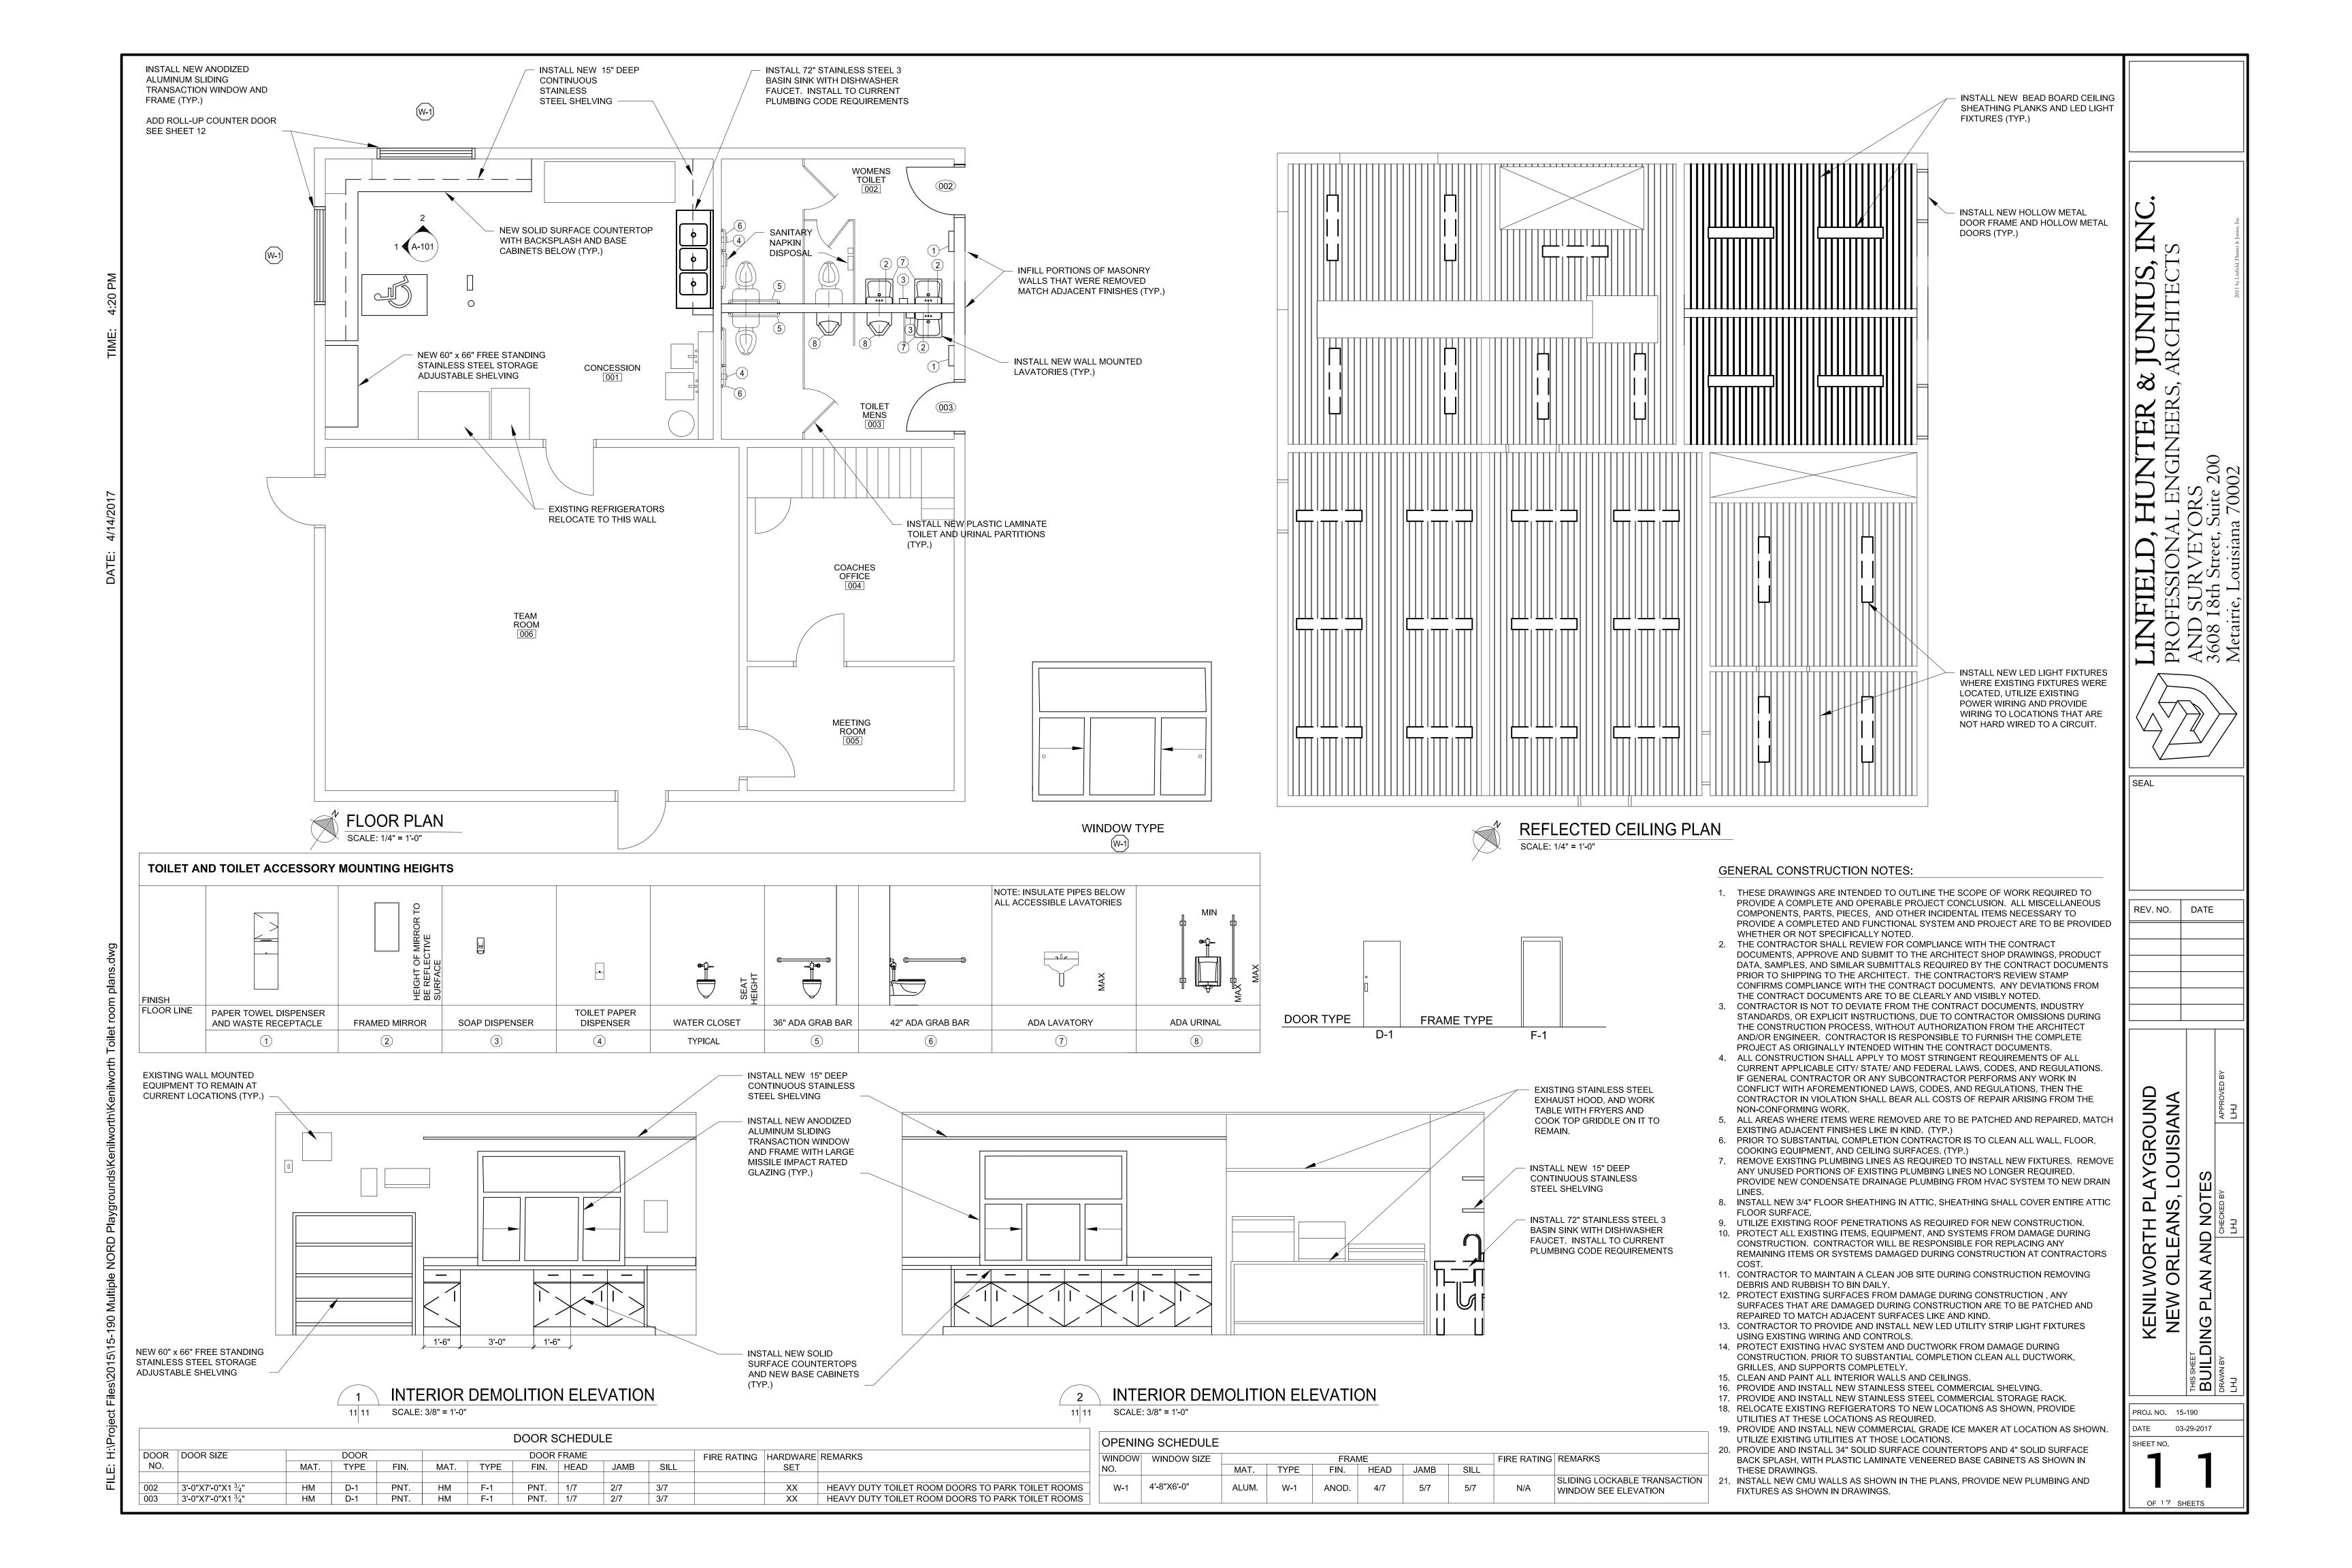

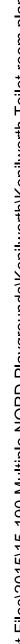







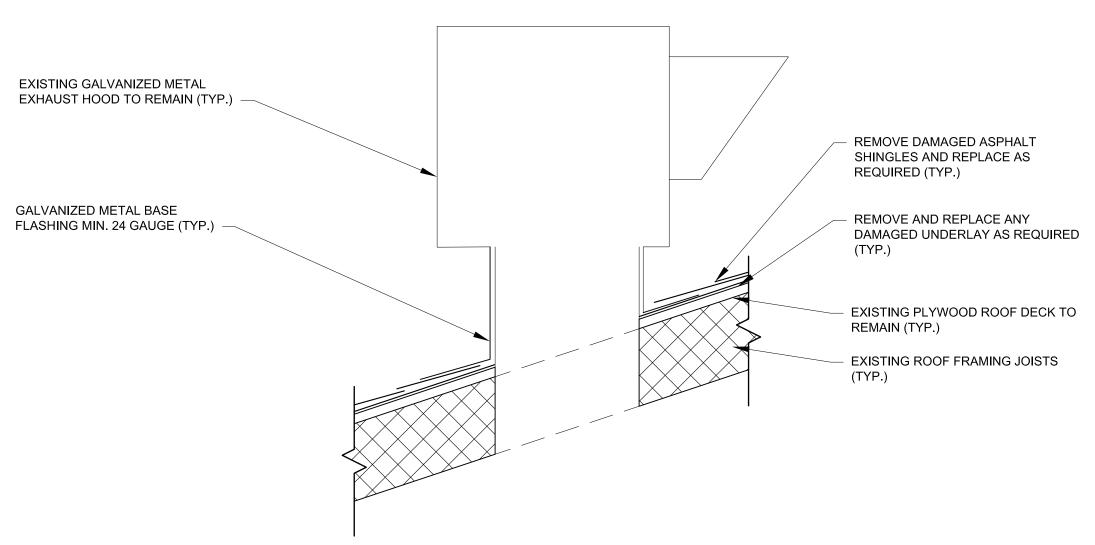

ROOF REPAIR DETAIL 12 12 SCALE: 3/8" = 1'-0"

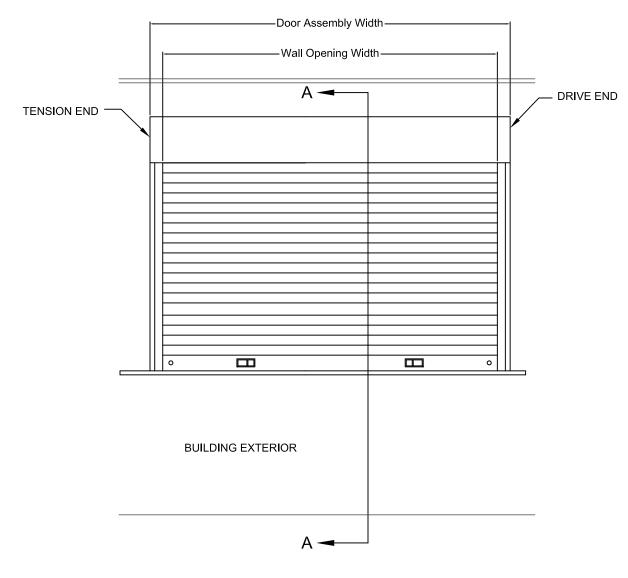

ROLL-UP COUNTER DOOR 12 12 SCALE: 1/2" = 1'-0"

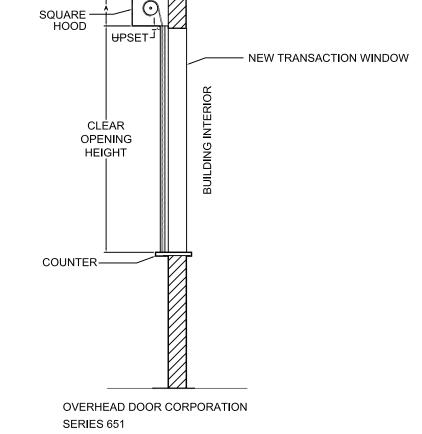

MANUAL PUSH UP (OPENING) TAMPERPROOF STAINLESS STEEL MOUNTING HARDWARE

SECTION A-A ROLL-UP COUNTER DOOR

12 12 SCALE: 1/2" = 1'-0"

DATE 03-29-2017 SHEET NO.

PROJ. NO. 15-190


THIS SHEET
ROOF REPAIR

KENILWORTH PLAYGROUND NEW ORLEANS, LOUISIANA

**S**, S

HUNTER
AL ENGINEERS
ORS
Suite 200

REV. NO. DATE

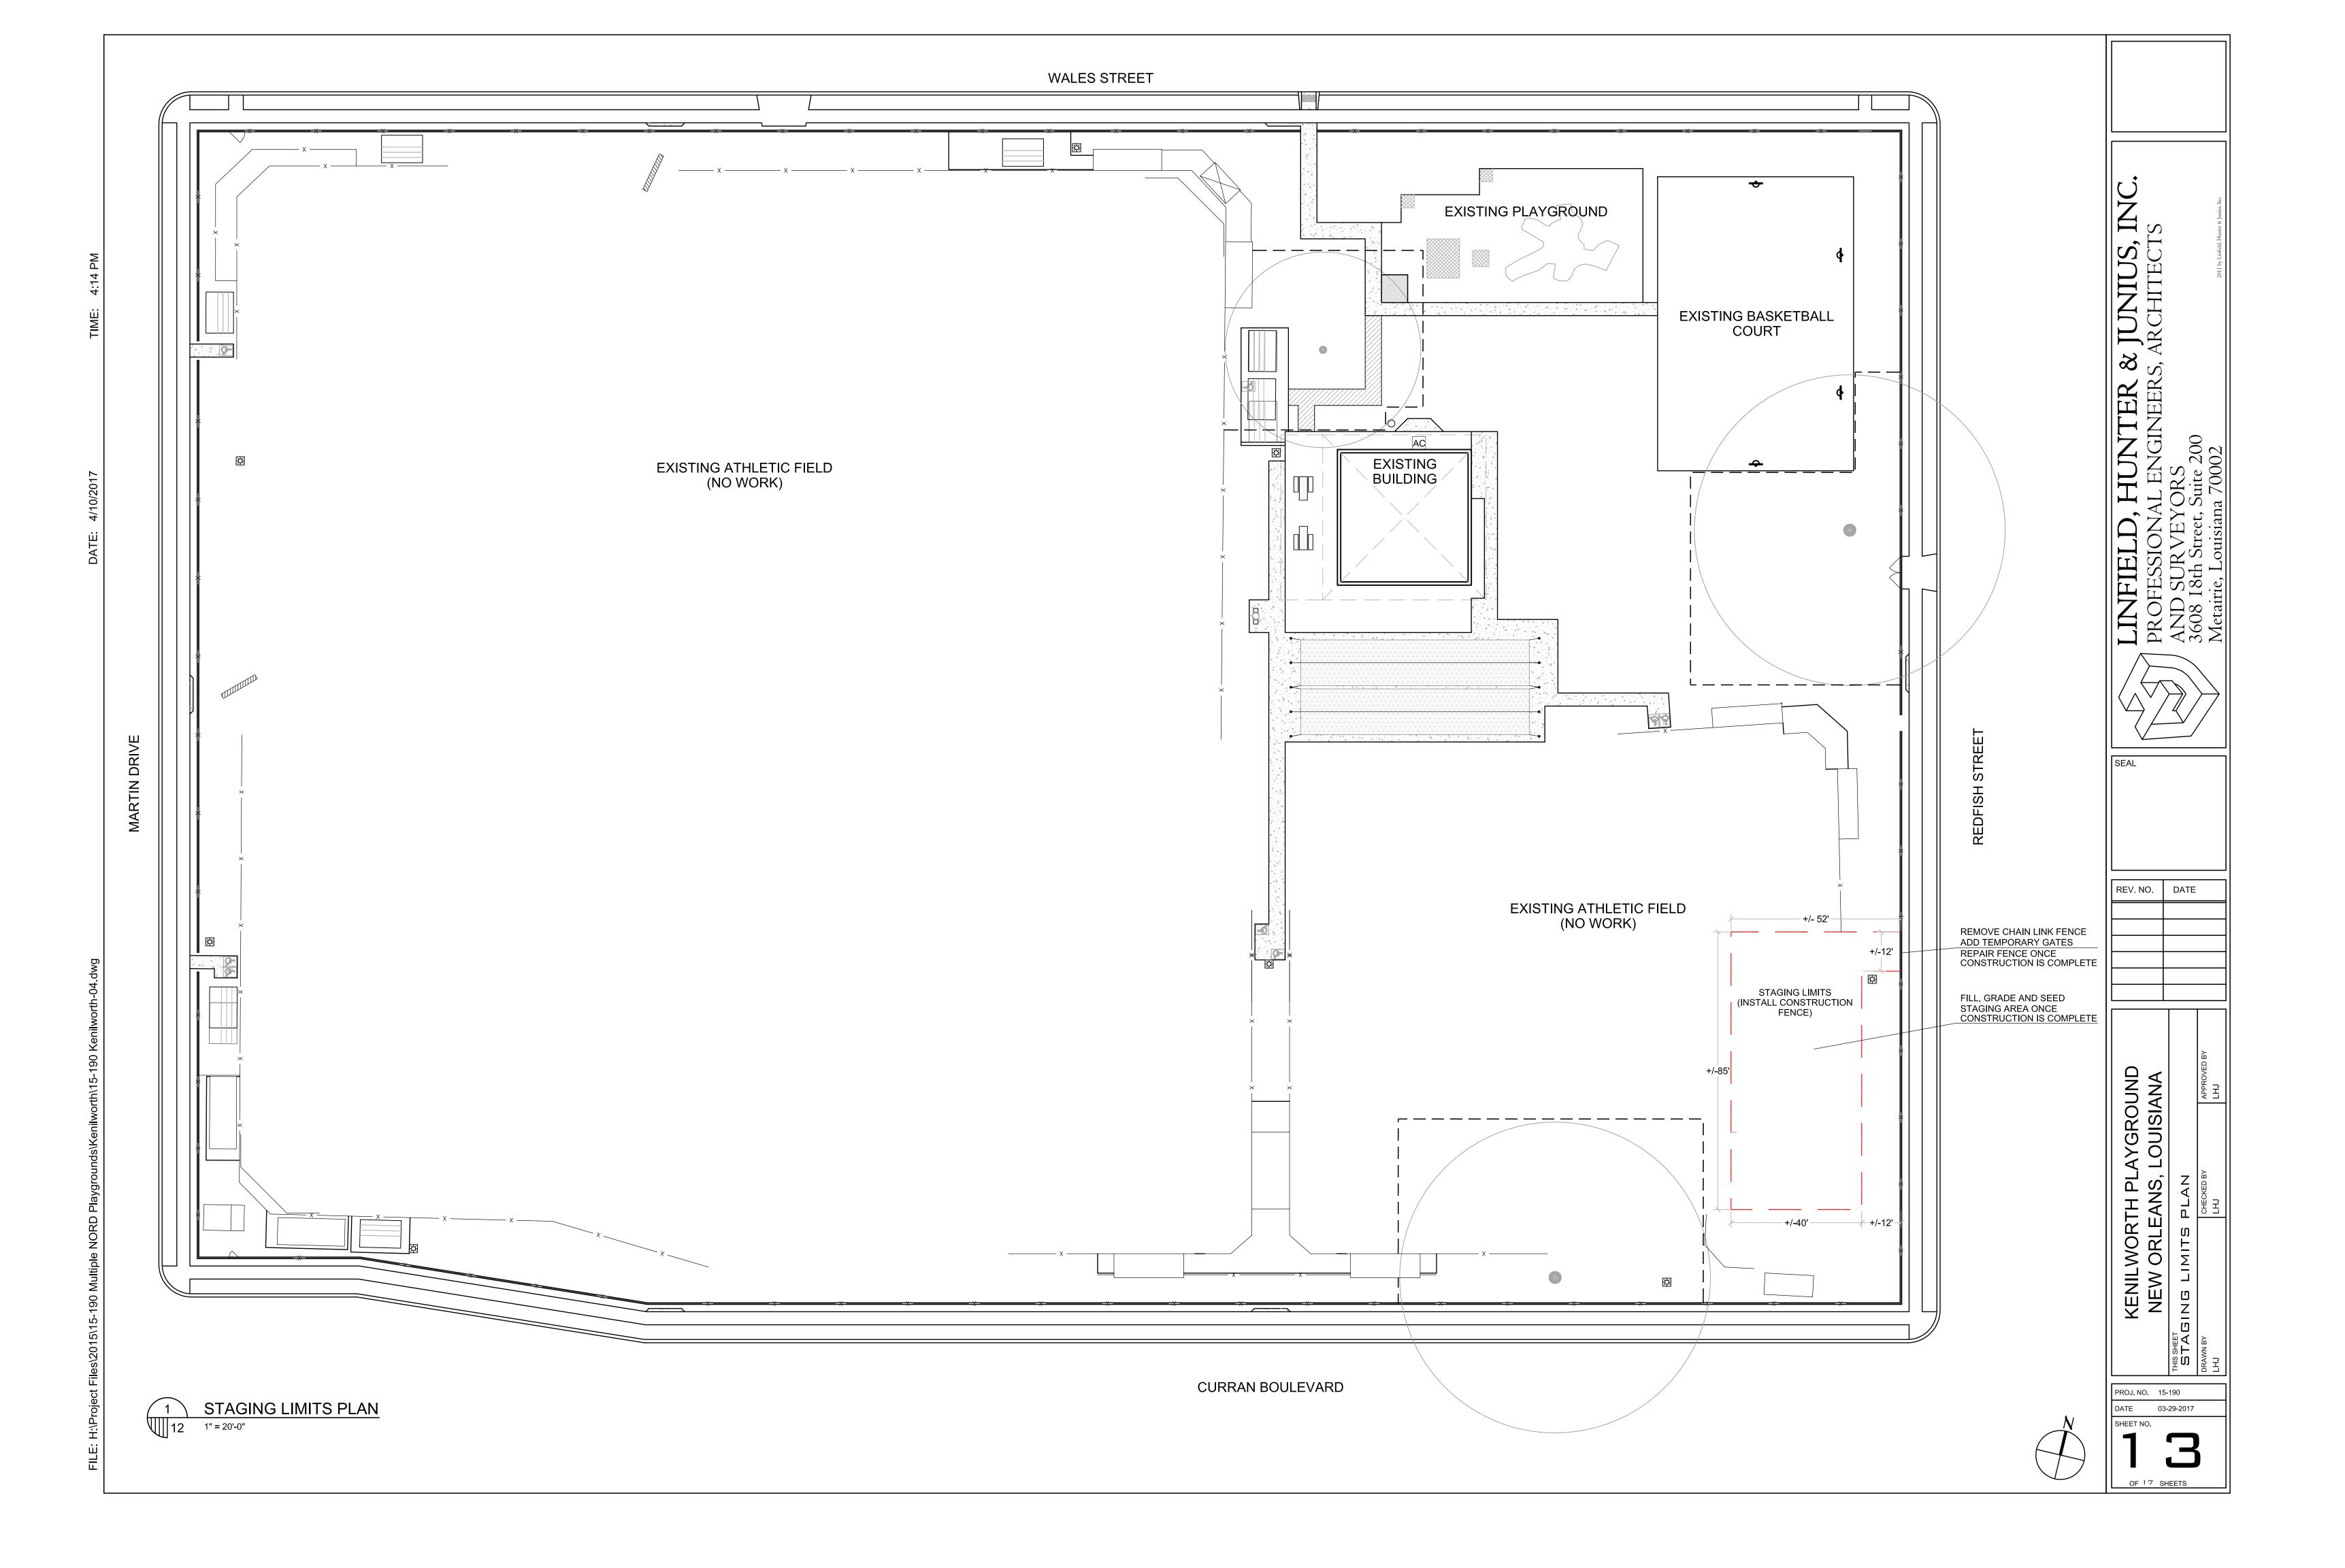

# DISCONNECT AND REVOKE ALL LOST TO REPORT JUNES HAVE WINN, GROUN TO STANK THE THE THE THE CITY 2023 NOT WANT. DISCONNECT AND REPORT JUNES HAVE WANT

LIGHTING DEMO PLAN

### 1 ALL FOLLIDMENT FL

GENERAL NOTES

- 1. ALL EQUIPMENT FURNISHED AND ALL WORK SHALL BE IN STRICT CONFORMITY WITH ELECTRICAL SECTION OF REGULATORY INSPECTIONS FOR ORLEANS PARISH, STATE FIRE MARSHALL, N.E.C. & ALL OTHER APPLICABLE LAWS, ORDINANCES, CODES & RULES OF CONSTRUCTION APPLICABLE IN THE LOCALITY OF WORK.
- 2. PERMITS, CERTIFICATES OF INSPECTION AND APPROVAL AS APPLICABLE TO THE VARIOUS PORTIONS OF THE WORK SHALL BE OBTAINED FROM THE INSPECTION AGENCY HAVING JURISDICTION THEREON AND SHALL BE DELIVERED TO THE ARCHITECT PRIOR TO ACCEPTANCE OF THE WORK. PAY ALL FEES REQUIRED IN CONNECTION WITH VARIOUS INSPECTIONS AND PERMITS.
- 3. ELECTRICAL PLANS SHOW GENERAL WORK TO BE PERFORMED AND HAVE BEEN PREPARED TO ASSIST IN DETERMINING PROPOSED COST FOR THE TOTAL PROJECT. IT IS THE RESPONSIBILITY OF THE CONTRACTOR TO VISIT THE JOB SITE AND BECOME FAMILIAR WITH EXISTING CONDITIONS WHICH MAY AFFECT HIS WORK AND FINAL BID PRICE.
- 4. EACH BRANCH CIRCUIT AND/OR FEEDER SHALL HAVE A GREEN INSULATED EQUIPMENT GROUND CONDUCTOR, SIZED PER NEC.
- 5. ALL PENETRATIONS THROUGH PARTITIONS AND CEILINGS SHALL BE PROPERLY SEALED TO MAINTAIN FIRE AND OR SMOKE RATING OF CEILINGS AND PARTITION.
- 6. UPON COMPLETION, FURNISH AS—BUILD SCHEMATIC DRAWING OF ALL VARIATIONS OF EXISTING PLANS TO OWNER.
- 7. UPON COMPLETION OF THE WORK, TEST THE NEW INDIVIDUAL SYSTEMS, INCLUDING ALL FEEDERS AND BRANCH CIRCUITS TO RECEPTACLES, LIGHTING WITH A 500 VOLT DC INSULATION TESTER (WITH AN 0-200 MEGOHM FULL SCALE.) ALL CONDUCTORS SHALL HAVE INSULATION TESTED WHEN WIRING SYSTEM IS COMPLETE AND A LOG KEPT OF THE CIRCUIT NAME, DATE AND MEGGER READINGS. RECORD FEEDER AND/OR CIRCUIT NAME, READING IN OHMS, AND SUBMIT REPORT TO ARCHITECT. CHECK FOR PROPER PHASE ROTATION. ALL TEST REPORTS SHALL BE TYPED. PROVIDE ALL INSTRUMENTS, LABOR, ETC. REQUIRED FOR TESTING. ALL TESTING SHALL BE OBSERVED BY THE ARCHITECT AND/OR REPRESENTATIVES OF ARCHITECT.
- 8. UPON COMPLETION OF ALL TESTS AND ACCEPTANCE,
  FURNISH THE OWNER A WRITTEN GUARANTEE COVERING THE ELECTRICAL WORK
  DONE AND EQUIPMENT INSTALLED FOR A PERIOD OF ONE YEAR FROM THE DATE
  OF ACCEPTANCE. DURING THE GUARANTEE PERIOD,
  RECTIFY AND REPLACE ANY DEFECTIVE MATERIAL OR WORKMANSHIP AND REPAIR
  DAMAGE CAUSED THEREBY WITHOUT ANY ADDITIONAL COST TO THE OWNER.
- 9. COORDINATE ALL LOCATIONS OF EQUIPMENT AND FINAL TERMINATION POINTS OF HVAC, PLUMBING, EXISTING EQUIPMENT, OWNER SUPPLIED EQUIPMENT, ETC., WITH APPROVED SHOP DRAWINGS OR OWNERS EQUIPMENT VENDOR PRIOR TO START OF ROUGHIN. WHERE REQUIRED, FIELD MOUNT U.L. LISTED AND APPROVED LUGS FOR OVERSIZED CONDUCTORS SPECIFIED.
- 10. THE EXACT LOCATION OF ALL WALL MOUNTED RECEPTACLES, DATA/TELEPHONE OUTLETS, ETC., SHALL BE FIELD VERIFIED WITH OWNER PRIOR TO START OF ROUGHIN.
- 11. COORDINATE MOUNTING HEIGHTS OF ALL WALL MOUNTED EQUIPMENT, WIRING DEVICES, ETC., WITH ARCHITECTURAL DRAWINGS PRIOR TO START OF ROUGH IN.
- 12. CONNECT ALL EXIT AND WALL MOUNTED BATTERY LIGHT FIXTURES TO UNSWITCHED PORTION OF LIGHTING CIRCUIT SERVING AREA.
- 13. NOT USED
- 14. IN EVENT OF CONFLICT OF INFORMATION IN THE SPECS AND/OR PLANS, CONTRACTOR SHALL BID ON THE MOST EXPENSIVE OPTION. IF SPECS MENTION THAT A CERTAIN COMPONENT IS NEEDED, CONTRACTOR IS RESPONSIBLE TO PROVIDE SUCH, EVEN IF IT IS NOT SHOWN ON PLANS OR DETAILS.
- 15. CONTRACTOR SHALL PROVIDE SCALE COORDINATION DRAWINGS FOR ENGINEER TO REVIEW PRIOR TO ANY ROUGH—IN OR ORDERING ANY EQUIPMENT IN ORDER TO AVOID ANY CONFLICTS ESPECIALLY IN TIGHT AREAS AND AT PENETRATIONS

ARCHITECTURAL, CIVIL, ELECTRICAL, TRONMENTAL & MECHANICAL ENGINEER: 1515 POYDRAS STREET, STE. 1875

NEW ORLEANS, LA. 70112

THESE DRAWINGS HAVE BEEN PREPARED UNDER MY DIRECT SUPERVISION AND TO THE BEST OF MY KNOWLEDGE AND BELIEF COMPLY WITH ALL LOCAL AND STATE AND FEDERAL REQUIREMENTS. PERIODIC CONSTRUCTION OBSERVATION OF THE WORK WILL BE PERFORMED BY OUR OFFICE.

KENILWORTH PLAYGROUND LIGHTING AND BATHRM UPGRAD NEW ORLEANS LA.


revisions


no. date & description

1
2
3
4
job number 17-XXX
drawn by IHJ
checked by BRM
date 04/10/2017
phase

PRELIMINARY

drawing number

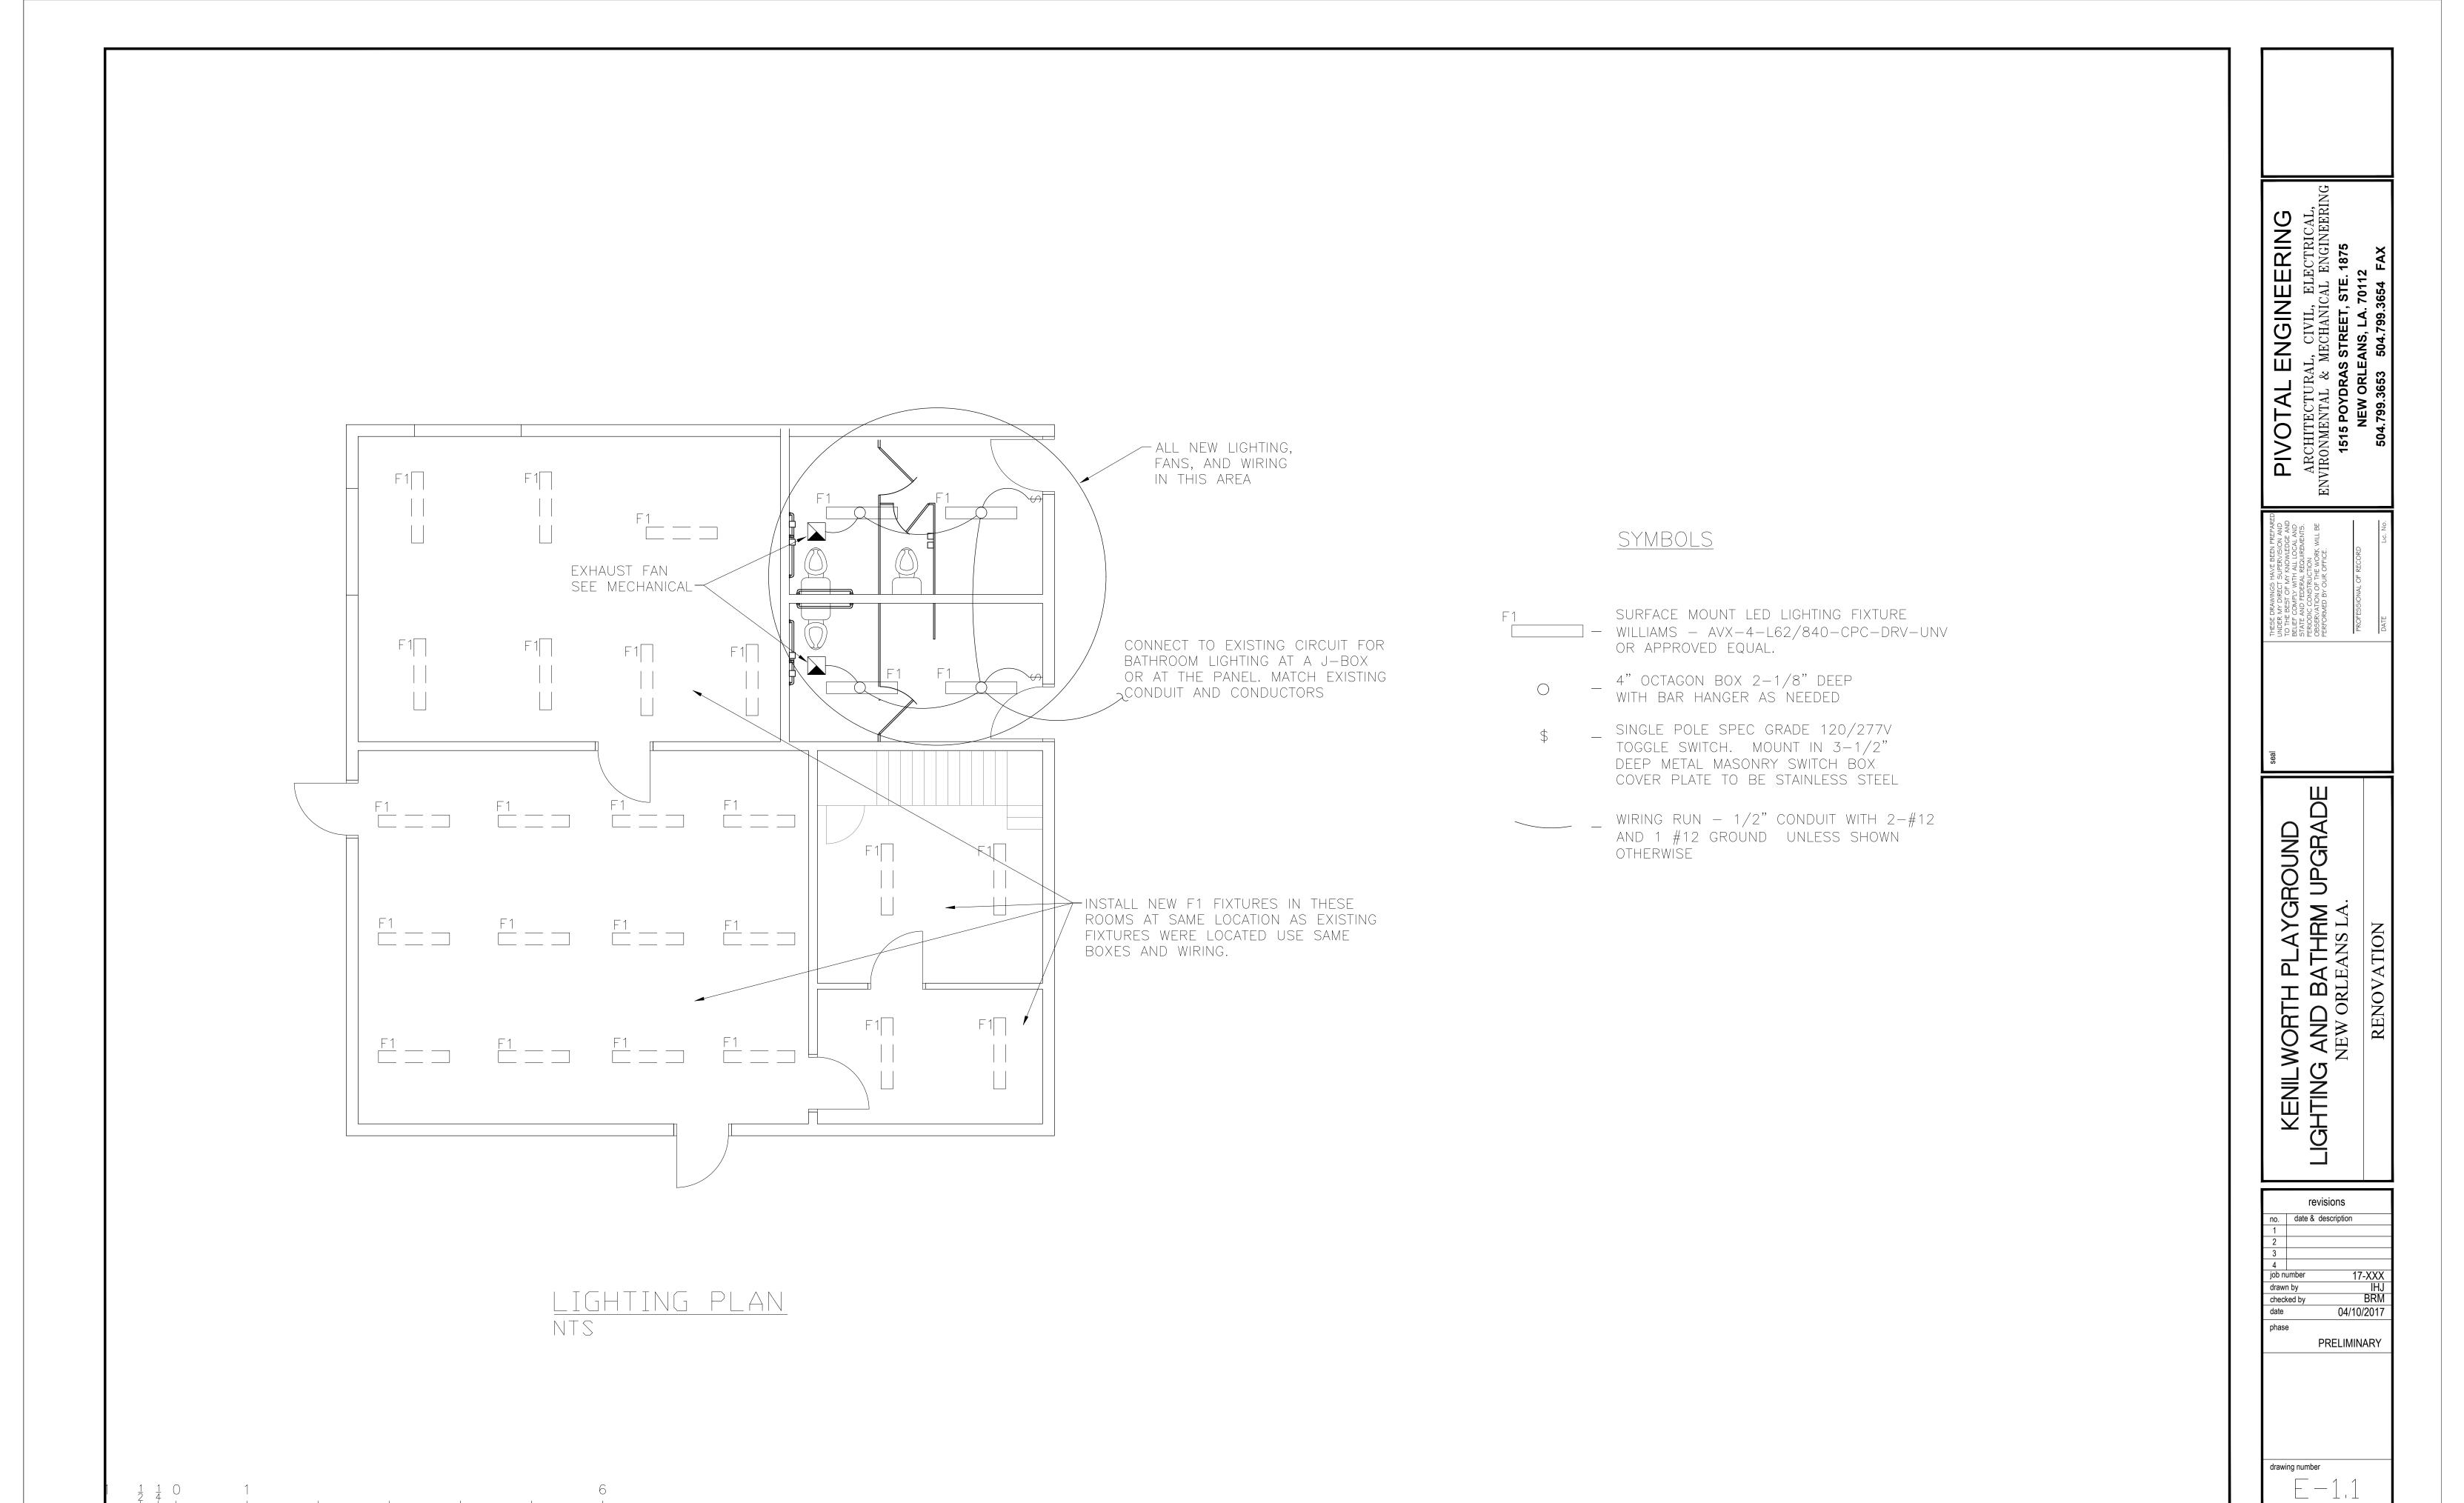

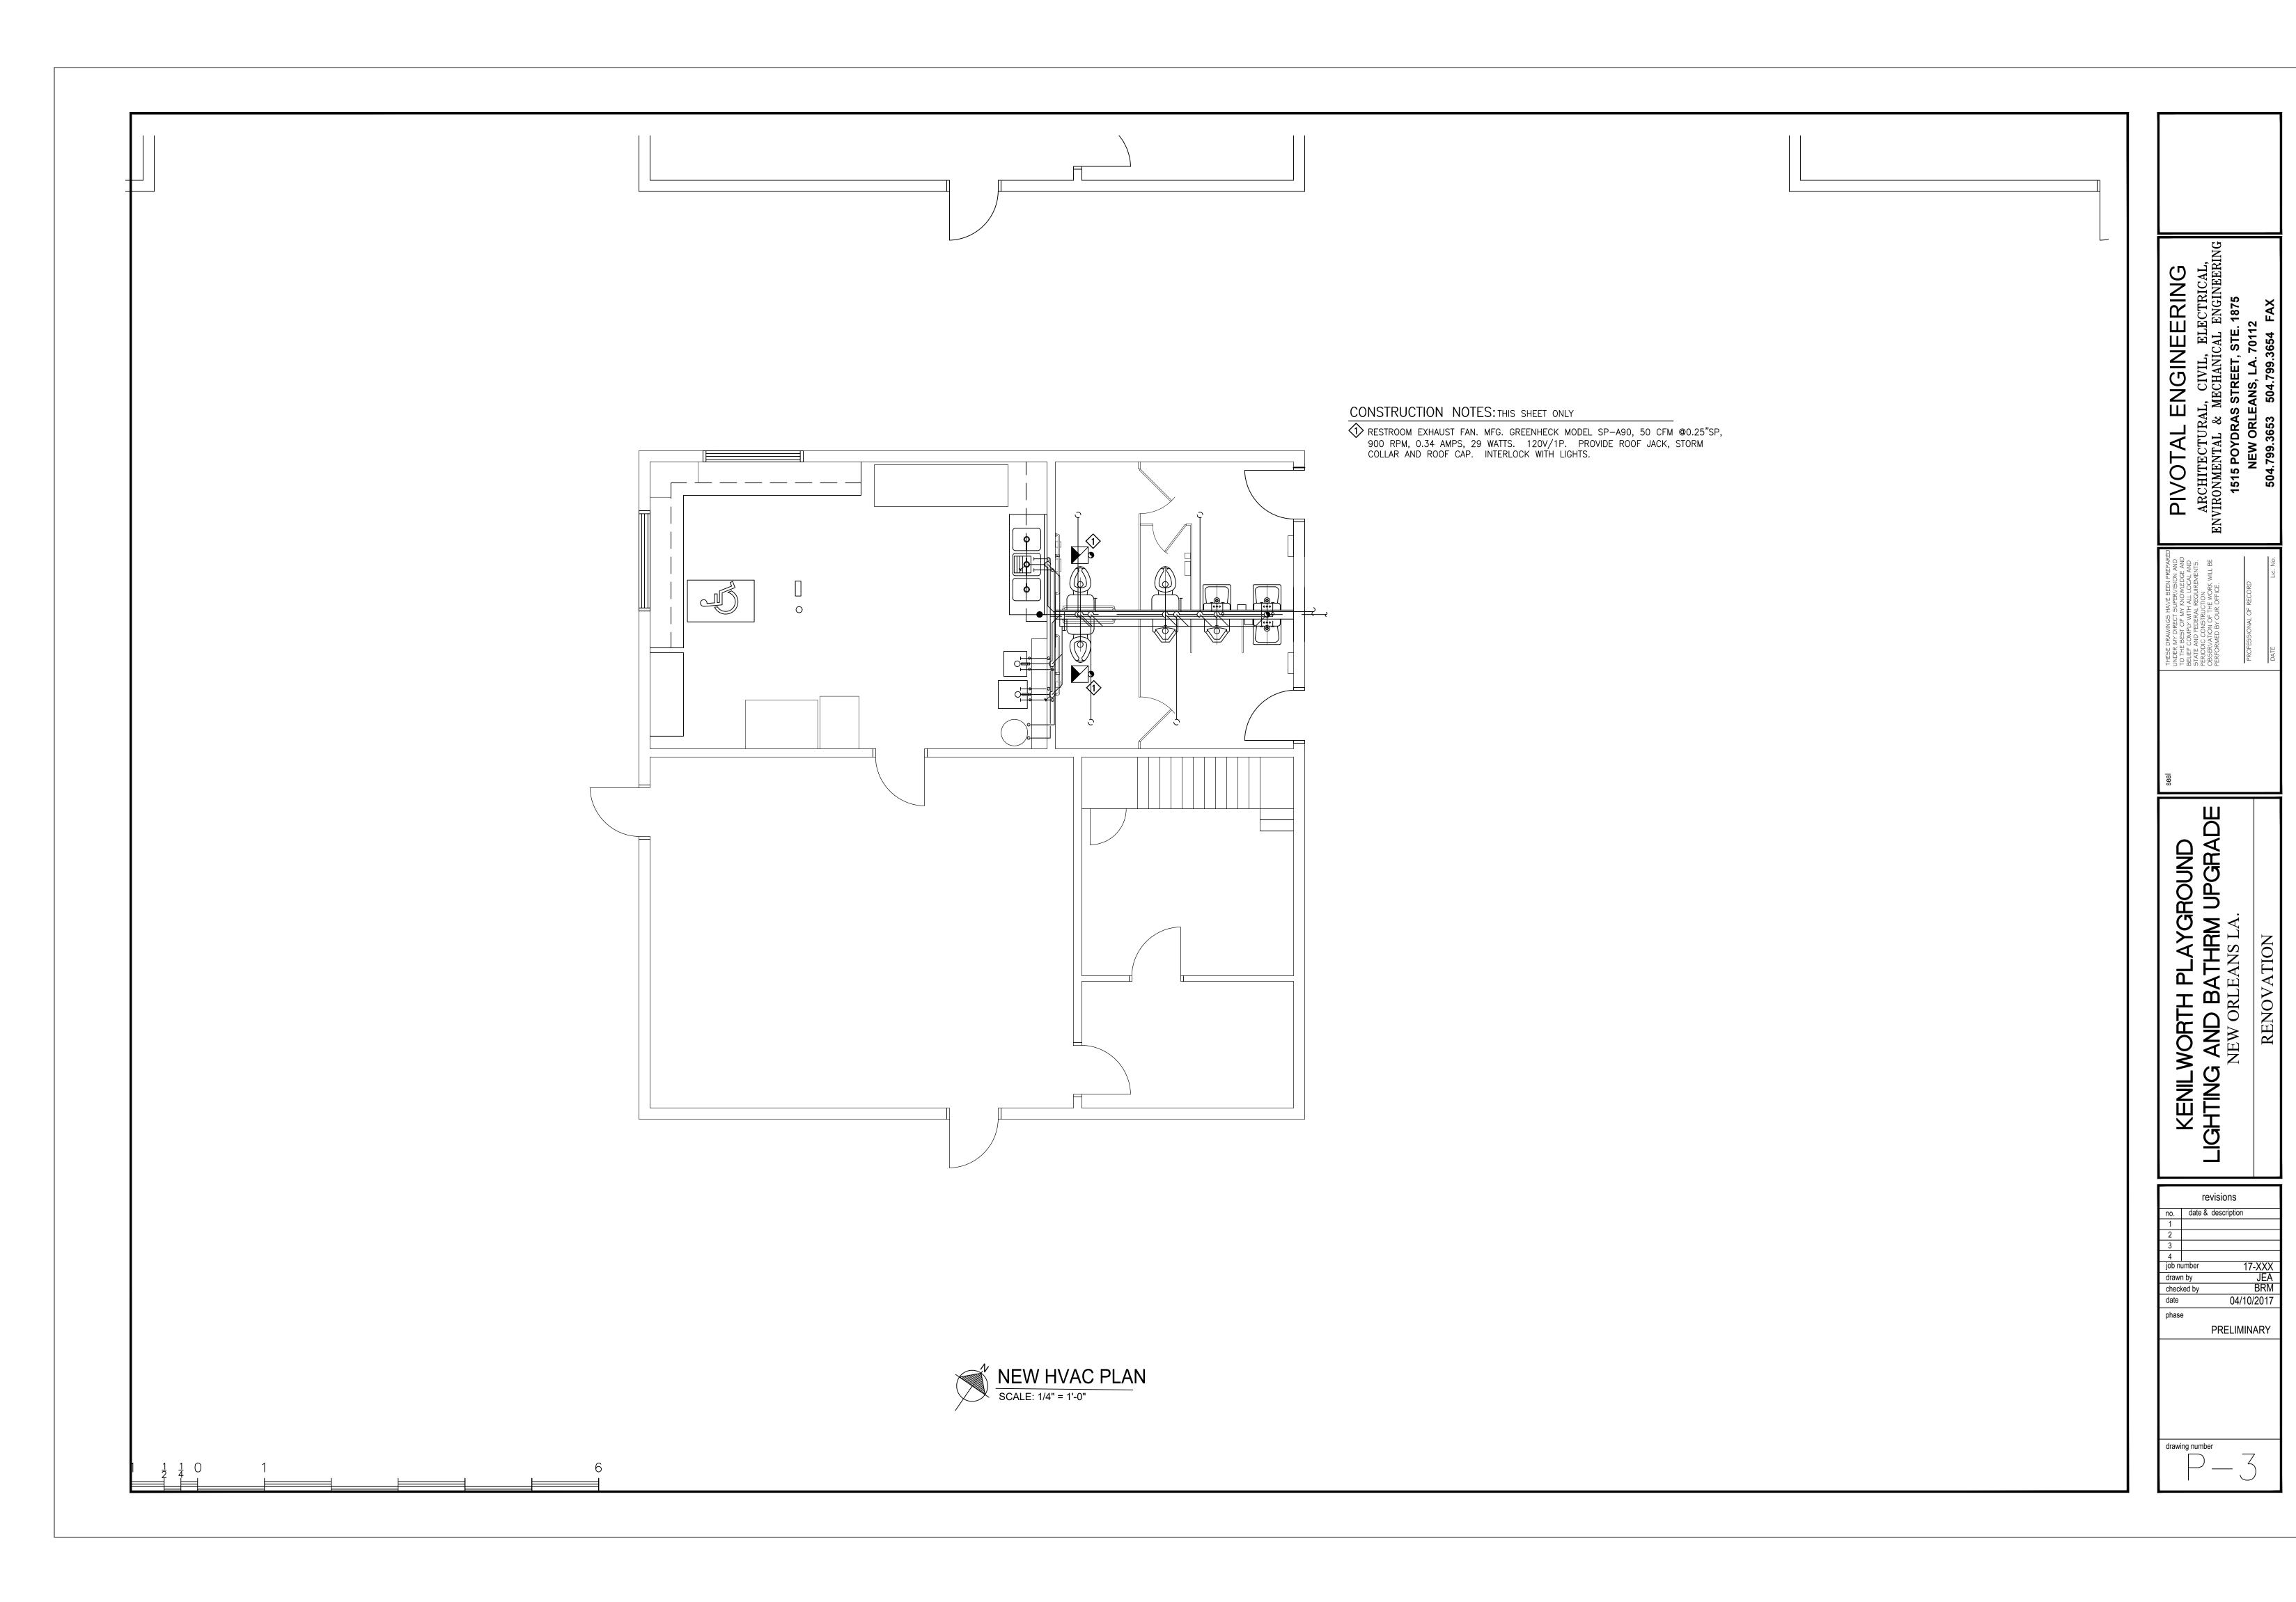

CONSTRUCTION NOTES: THIS SHEET ONLY EXISTING FLOOR DRAINS AND BRANCH PIPING TO BE RE-USED. VERIFY DRAINS AND BRANCH PIPING ARE FUNCTIONAL, LEAK-FREE AND UNOBSTRUCTED. © CONNECT NEW 4" SANITARY SEWER (SS) TO EXISTING SANITARY SEWER IN THIS AREA. VERIFY THAT EXISTING SANITARY SEWER AND LEAK-FREE AND UNOBSTUCTED.  $\stackrel{\textstyle \checkmark}{3}$  FLOOR SINK. MFG. JOSAM MODEL 49320A-NB FLOOR SINK. 6-1/4" DEEP CAST IRON BODY WITH NON-CLOG ALUMINUM DOME STRAINER, WITH NIKALOY  $\frac{1}{2}$  GRATE TOP AND 3" NO HUB CONNECTION. FLOOR CLEAN OUT. MFG. ZURN MODEL ZS-1400, DURA COATED CAST IRON BODY WITH GAS AND WATERTIGHT ABS PLUG. ADJUSTABLE CONNECT NEW
4"SS TO CLOSEST
EXISTING SS. SANITARY SEWER PLAN

SCALE: 1/4" = 1'-0"

no. date & description 04/10/2017 PRELIMINARY

drawing number

