# **GENERAL NOTES**

- ALL WORK SHALL COMPLY WITH ALL LAWS, RULES, REGULATIONS, ORDINANCES AND CODES OF THE CITY OF NEW ORLEANS, THE STATE OF LOUISIANA, AND THE FEDERAL GOVERNMENT.
- THE CONTRACTOR IS RESPONSIBLE FOR VERIFYING THE EXTENT, NATURE, AND SCOPE OF WORK MATERIALS, EQUIPMENT, TRANSPORTATION, DELIVERY, HANDLING, SERVICES, SUPERVISION AND WHERE SPECIFICALLY NOTED AS NOT IN CONTRACT (NIC).
- ALL DIMENSIONS, ANGLES, ELEVATIONS, CONDITIONS, AND PHYSICAL CONFIGURATIONS RELATIVE TO EXISTING CONDITIONS AT THE SITE SHALL BE VERIFIED IN THE FIELD BY THE CONTRACTOR
- THE CONTRACTOR IS FULLY RESPONSIBLE FOR COORDINATION OF NEW WORK WITH EXISTING AND
- ALL ASPECTS OF JOB SITE SAFETY ARE COMPLETELY THE RESPONSIBILITY OF THE CONTRACTOR THE ENGINEER WILL NOT HAVE CONTROL OR CHARGE OF AND WILL NOT BE RESPONSIBLE FOR ALL WORK IN A SAFE AND ORDERLY MANNER AVOIDING HAZARDOUS CONDITIONS. PROVIDE ALL NECESSARY TEMPORARY SHORING, BRACIND, BARRICADES AND PROTECTIVE BARRIERS AS
- THE ENGINEER HAS NOT BEEN RETAINED OR COMPENSATED TO PROVIDE DESIGN OR PROCEDURES REQUIRED FOR THE CONTRACTOR TO PERFORM HIS WORK. HENCE, THE ARCHITECT
- RESPONSIBLE FOR THE STABILITY OF THE STRUCTURE UNDER CONSTRUCTION AND FOR THE SAFETY OF THE WORKERS AND THE GENERAL PUBLIC.
- WORK AREAS SHALL BE KEPT NEAT, CLEAN, AND SAFE AT ALL TIMES BY CONTRACTOR. TRASH OR DEBRIS SHALL NOT BE ALLOWED TO ACCUMULATE ON THE SITE. PREMISES SHALL BE KEPT NEAT. SUITABLE TRASH CONTAINERS AND TRASH REMOVAL FOR THE PROPERTY. ALL WASTE SHALL BE PROPERLY AND LEGALLY DISPOSED OF.
- DO NOT SCALE ANY DRAWINGS WITHOUT SPECIFIC PERMISSION OF THE ARCHITECT. '
- DIMENSIONS SHALL GOVERN. CONSULT ARCHITECT FOR DIMENSIONS NOT SHOWN. AND OTHER INCIDENTAL ITEMS REQUIRED FOR COMPLETE ASSEMBLY/INSTALLATION OF AN ITEM OR INTERPRETATION OR CORRECTION BEFORE WORK IS EXECUTED
- ANCHORING, BRACING, BLOCKING, AND INSTALLATION MEANS OF ALL COMPONENTS OF WORK. ALL WORK WILL BE SUBJECT TO THE REVIEW, INSPECTION, AND ACCEPTANCE OF THE OWNER (AND
- THE ARCHITECT AT THE DISCRETION OF THE OWNER). UPON COMPLETION OF THE WORK, THE CONTRACTOR SHALL NOTIFY THE OWNER AND THE CONTRACTOR SHALL PREPARE AND SUBMIT A
- THE CONTRACTOR. CONTRACTOR SHALL GIVE ALL NOTICES TO ALL AUTHORITIES AND AGENCIES HAVING JURISDICTION OVER THE WORK. CONTRACTOR SHALL MAKE CERTAIN THAT ALL REQUIRED PERMITS AND APPROVALS HAVE BEEN OBTAINED PRIOR TO THE START OF ANY WORK. NO CONSTRUCTION OR FABRICATIONS SHALL BEFIN UNTIL THE CONTRACTOR HAS RECEIVED AND THOROUGHLY REVIEWED ALL DRAWINGS AND OTHER DOCUMENTS AS APPROVED BY ALL PERMITTING AUTHORITIES.
- CONTRACTOR SHALL PAY ALL APPLICABLE SALES TAXES AND ALL OTHER APPLICABLE TAXES AS REQUIRED TO COMPLY WITH ALL APPLICABLE LAWS.
- PROJECT INCLUDES ALL REQUIRED SITE PREPARATION AND SELECTIVE DEMOLITION UNLESS SPECIFICALLY NOTED AS N.I.C. PROTECT ALL SURROUNDING AREAS DURING CONSTRUCTION PROTECT ALL EXISTING CONSTRUCTION TO REMAIN DURING ENTIRE CONSTRUCTION PERIOD. PROTECT EMPLOYEES, CONSULTANTS, VISITORS, AND THE GENERAL PUBLIC DURING DEMOLITION
- WHEN ANY PART OF THE BUILDING IS OPEN TO THE EXTERIOR, PROTECT INTERIOR FROM WIND, RAIN, STORM, VANDALISM AND UNAUTHORIZED ENTRY. PREVEN ANY POSSIBILITY OF MOLD
- HARDWARE ON ALL DOORS IN THE PATH(S) OF EGRESS SHALL REQUIRE NO KEY, TOOL, SPECIAL KNOWLEDGE OR EFFOR TO OPERATE IN THE DIRECTION OF EGRESS AND SHALL NEVER BE LOCKED IN THE DIRECTION OF EGRESS
- THE FOLLOWING SYSTEMS SHALL BE DEMONSTRATED BY THE INSTALLING CONTRACTOR IN THE PRESENCE OF THE STATE FIRE MARSHAL INSPECTOR AND THE CITY OF NEW ORLEANS INSPECTOR (WITH THE CONTRACTORS SUPERINTENDENT PRESENT ALSO).
  - LIGHTED EXIT SIGNS EGRESS PATH LIGHTING
- **EMERGENCY LIGHTING**
- AUTOMATIC FIRE PROTECTION SPRINKLE SYSTEM (MUST PROVIDE MATERIALS & TEST FIRE ALARM AND DETECTION SYSTEMS (MUST PROVIDE MATERIALS & TEST CERTIFICATE)
- PRECAUTIONS AND PROTECTIVE MEASURES SHALL BE USED AS NECESSARY TO PROTECT WORKERS, GUESTS, VISITORS, STAFF AND THE GENERAL PUBLIC. ERECT SUITABLE TEMPORARY BARRIERS AT HAZARDOUS AREAS TO DETOUR PEDESTRIAN TRAFFIC AND TO PREVENT NORMAL ACCESS TO SUCH AREAS BY UNAUTHORIZED PERSONS.
- DIMENSIONS FOR STUD WALLS SHOWN ON DRAWINGS ARE TO THE FACE OF STUD FRAMING UNLESS SPECIFICALLY OTHERWISE NOTES. DIMENSIONS FOR MASONRY WALLS SHOWN ON DRAWINGS ARE TO FACE OF MASONRY UNITS UNLESS SPECIFICALLY OTHERWISE NOTED. WHERE A DIMENSIONED IS LABELED AS "CLEAR" IT IS FROM THE FACE OF THE FINISHED WALL OR SURFACE. WHERE DOORS ARE LOCATED NEAR WALL CORNER, DOOR JAMBS SHOULD BE OFFSET 6 INCHES
- FROM THE INTERSECTING WALL STUD LINE UNLESS SPECIFICALLY NOTED OTHERWISE ALL STUD SPACING SHALL BE 16 INCHES ON CENTER MAXIMUM SPACING FOR ALL STUD WALLS. NOTE THAT 16 INCHES IS THE MAXIMUM SPACING. IN SOME CASES AT EXTERIOR WALLS, THE STUD SPACING MAY BE 12 INCHES ON CENTER, REFERENCE WALL SECTIONS.
- PROVIDE BLOCKING AND SOLID GROUNDS FOR ALL EQUIPMENT, ACCESSORIES, ETC. SUCH AS BUT NOT LIMITED TO ELECTRICAL FIXTURES, TOILET PARTITIONS, TOILET ROOM ACCESSORIES, WALL MOUNTED DOOR STOPS, GRAB BARS, HARWARE SHELVING, CABINETS AND CASEWORK, FIRE EXTINGUISHER CABINETS, MISC ARCHITECTURAL FEATURES, WALL MOUNTED PLUMBING FEATURES, APPLIANCES AND SIMILAR ITEMS. ALL WOOD BLOCKING IN METAL STUD WALLS SHALL BE PRESERVATIVE PRESSURE TREATED.
- COORDINATE SPECIALTY ITEMS AND STRUCTURAL, MECHANICAL AND ELECTRICAL ROUGH-IN REQUIREMENTS WITH STUD FRAMING AND MASONRY WORK. PROVIDE STUD SPACING, EXTRA STUDS, BLOCKING, BRACING, ETC. TO SUIT VARIOUS EQUIPMENT
- AT METAL STUD FRAMING SYSTEMS, PROVIDE STIFFENERS, CONNECTIONS, CLIPS, STRAPS, "X" BRACING, COLLARS, BRIDGING, STRUTS, HANGERS, ETC. AS SHOWN OR AS NEEDED FOR RIGIDITY, STABILITY OR STIFFNESS. FOR METAL STUD FRAMING SYSTEMS FOLLOW METHODS, PROCEDURES AND RECOMMENDATIONS OF THE LIFHT GUAGE METAL FRAMING INDUSTRY UNLESS SHOWN OTHERWISE ON THE DRAWINGS OR SPECIFIED OTHERWISE IN THE SPECIFICATIONS.
- ALL SURFACES NOTED TO BE FINISHED SHALL BE PROPERLY PREPARED (SUCH AS CLEANING, SANDING, PATCHING, FILLING, PRIMING AND SEALING) AND THEN FINISHED PER THE FINISH SCHEDULE AND/OR SPECIFICATIONS OR AS REQUIRED BY CONDITIONS. ALL WORK IS "NEW" UNLESS INDICATED AS "EXISTING" OR OTHERWISE CLARIFIED ON THE
- PROVDE SEALANT/CAULKING AT ALL SEAMS, JOINTS AND MATERIAL INTERSECTIONS FOR A NEAT
- PROVIDE UL LISTED FIRSTOPPING SYSTEMS AT WALLS, PARTITIONS, CEILINGS AND FLOORS AS
- REQUIRED BY IBC 2012, NFPA 101-2012 AND AS INDICATED IN THE CONTRACT DOCUMENTS. ALL WOOD IN CONTACT WITH MASONRY, CONCRETE, OR STEEL SHALL BE ACQ PRESERVATIVE PRESSURE TREATER (PT). 0.40 LBS/CU FT. SEE SPECIFICATIONS FOR TREATMENT.

# 837 N. BROAD STREET MIXED USE DEVELOPMENT

837 N. BROAD STREET, NEW ORLEANS, LA 70122 **FOR PERMIT** MAY 25, 2020

# PROJECT INFORMATION

#### **PROJECT SUMMARY:**

THE PROPOSED BUILDING IS A TWO-STORY MIXED USE BUILDING. THE PROGRAM INCLUDES FIRST FLOOR WHITE BOX FUTURE TENANT SPACE AND SECOND FLOOR OF A DENTAL OFFICE AND WHITE BOX OFFICE SPACE THE RETAIL TENANT SPACE WILL BE DEVELOPED AS A SEPARATE PERMIT APPLICATION.

SQ 356 LOT 18-B OR 17 PTS 19 18 43X100 Property Description:

SQ 356 N BROAD ST AND DUMAINE ST LOT 17-A OR 17 PT 18 31X100

Zoning District:

**Zoning Description:** 

Historic Urban Neighborhood Mixed-Use District

# APLLICABLE CODES

#### 1. BUILDING CODES:

2015 LIFE AND SAFETY CODE (NFPA 101) 2015 INTERNATIONAL BUILDING CODE 2015 LOUISIANA STATE PLUMBING CODE (LSPC) NFPA 10 - FIRE EXTINGUISHERS NFPA 13 - AUTOMATIC SPRINKLER SYSTEMS NFPA 72 - FIRE ALARM SYSTEMS

2010 ADA ABA ACCESSIBILITY GUIDELINES AMERICAN NATIONAL STANDARD INSTITUTE (ANSI) UL FIRE RESISTANCE DIRECTORY

### 3. BASE FLOOD ELEVATION

FLOOD ZONE AE BASE FLOOD ELEVATION -1.0' (NAVD88) PROPOSED FFE 0.20' (NAVD88)





# PROJECT DIRECTORY

WMC Realty Group LLC 837 N Broad Street New Orleans, LA 70119


New Orleans, LA 70122

New Orleans, LA 70122

#### **ARCHITECT:** Royal Engineers & Consultants 4298 Elysian Fields Avenue

STRUCTURAL & CIVIL Royal Engineers & Consultants 4298 Elysian Fields Avenue Suite B

Marrero, Couvillon & Associates, LLC 3525 Hessmer Ave Suite 304 Metairie, LA 70002 (504) 834-3448

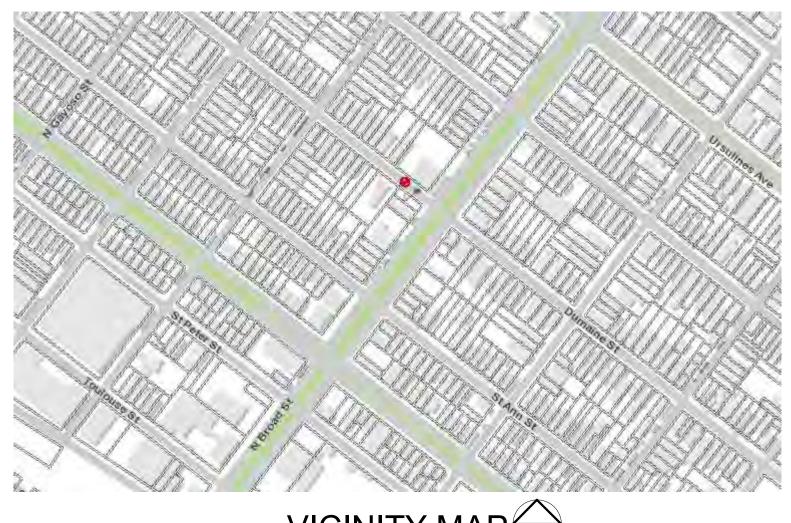

SHEET INDEX	Date			
TITLE, PROJECT INFORMATION & GENERAL NOTES ABBREVIATIONS, CODE REQUIREMENTS & SYMBOLS LIFE SAFETY PLANS SURVEY & ELEVATION CERTIFICATE CIVIL SITE PLAN UTILITIES PLAN GRADING PLAN CIVIL DETAILS CNO DETAILS FIRST FLOOR PLAN SECOND FLOOR PLAN ROOF PLAN REFLECTED CEILING PLANS REFLECTED CEILING PLANS ELEVATIONS	Description			
ELEVATIONS ASSEMBLIES & WALL SECTIONS WALL SECTIONS	o N			
DETAILS DOOR &WINDOWS SCHEDULES AND DETAILS GENERAL STRUCTURAL NOTES SCHEDULES AND TYPICAL DETAILS FOUNDATION PLAN FOUNDATION DETAILS FOUNDATION DETAILS TYPICAL FOUNDATION DETAILS 2ND FLOOR FRAMING PLAN ROOF FRAMING PLAN SHEAR WALL PLANS & HOLDOWN DETAILS	ERS & CONSULTANTS	ELDS AVENUE	LA 70122	ering.net

G001

G002 G003

C100 C101

C102

C501

C502

A102

A103 A104

S100 S101

S103

S201

S202

S203

S204

M103

M201

M301

E101

E201

E202

FRAMING DETAILS

MECHANICAL FIRST FLOOR PLAN

MECHANICAL ROOF PLAN

MECHANICAL SCHEDULES

PLUMBING RISER DIAGRAM

PLUMBING RISER DIAGRAM

PLUMBING DETAILS

PLUMBING SCHEDULES

PLUMBING UNDERFLOOR PLAN

PLUMBING SECOND FLOOR PLAN

**ELECTRICAL PANEL SCHEDULES** 

**ELECTRICAL ROOF POWER PLAN** 

MECHANICAL DETAILS

MECHANICAL SECOND FLOOR PLAN

MECHANICAL GENERAL NOTES, LEGENDS & ABBREVIATIONS

PLUMBING GENERAL NOTES, LEGENDS & ABBREVIATIONS

ELECTRICAL GENERAL NOTES, LEGENDS & ABBREVIATIONS

ELECTRICAL FEEDER DIAGRAM, SCHEDULES

ELECTRICAL SECOND FLOOR LIGHTING PLAN

ELECTRICAL FIRST FLOOR LIGHTING PLAN

ELECTRICAL FIRST FLOOR POWER PLAN


ELECTRICAL SECOND FLOOR POWER PLAN

Checked By FOR PERMIT

2019-12

5/28/2020



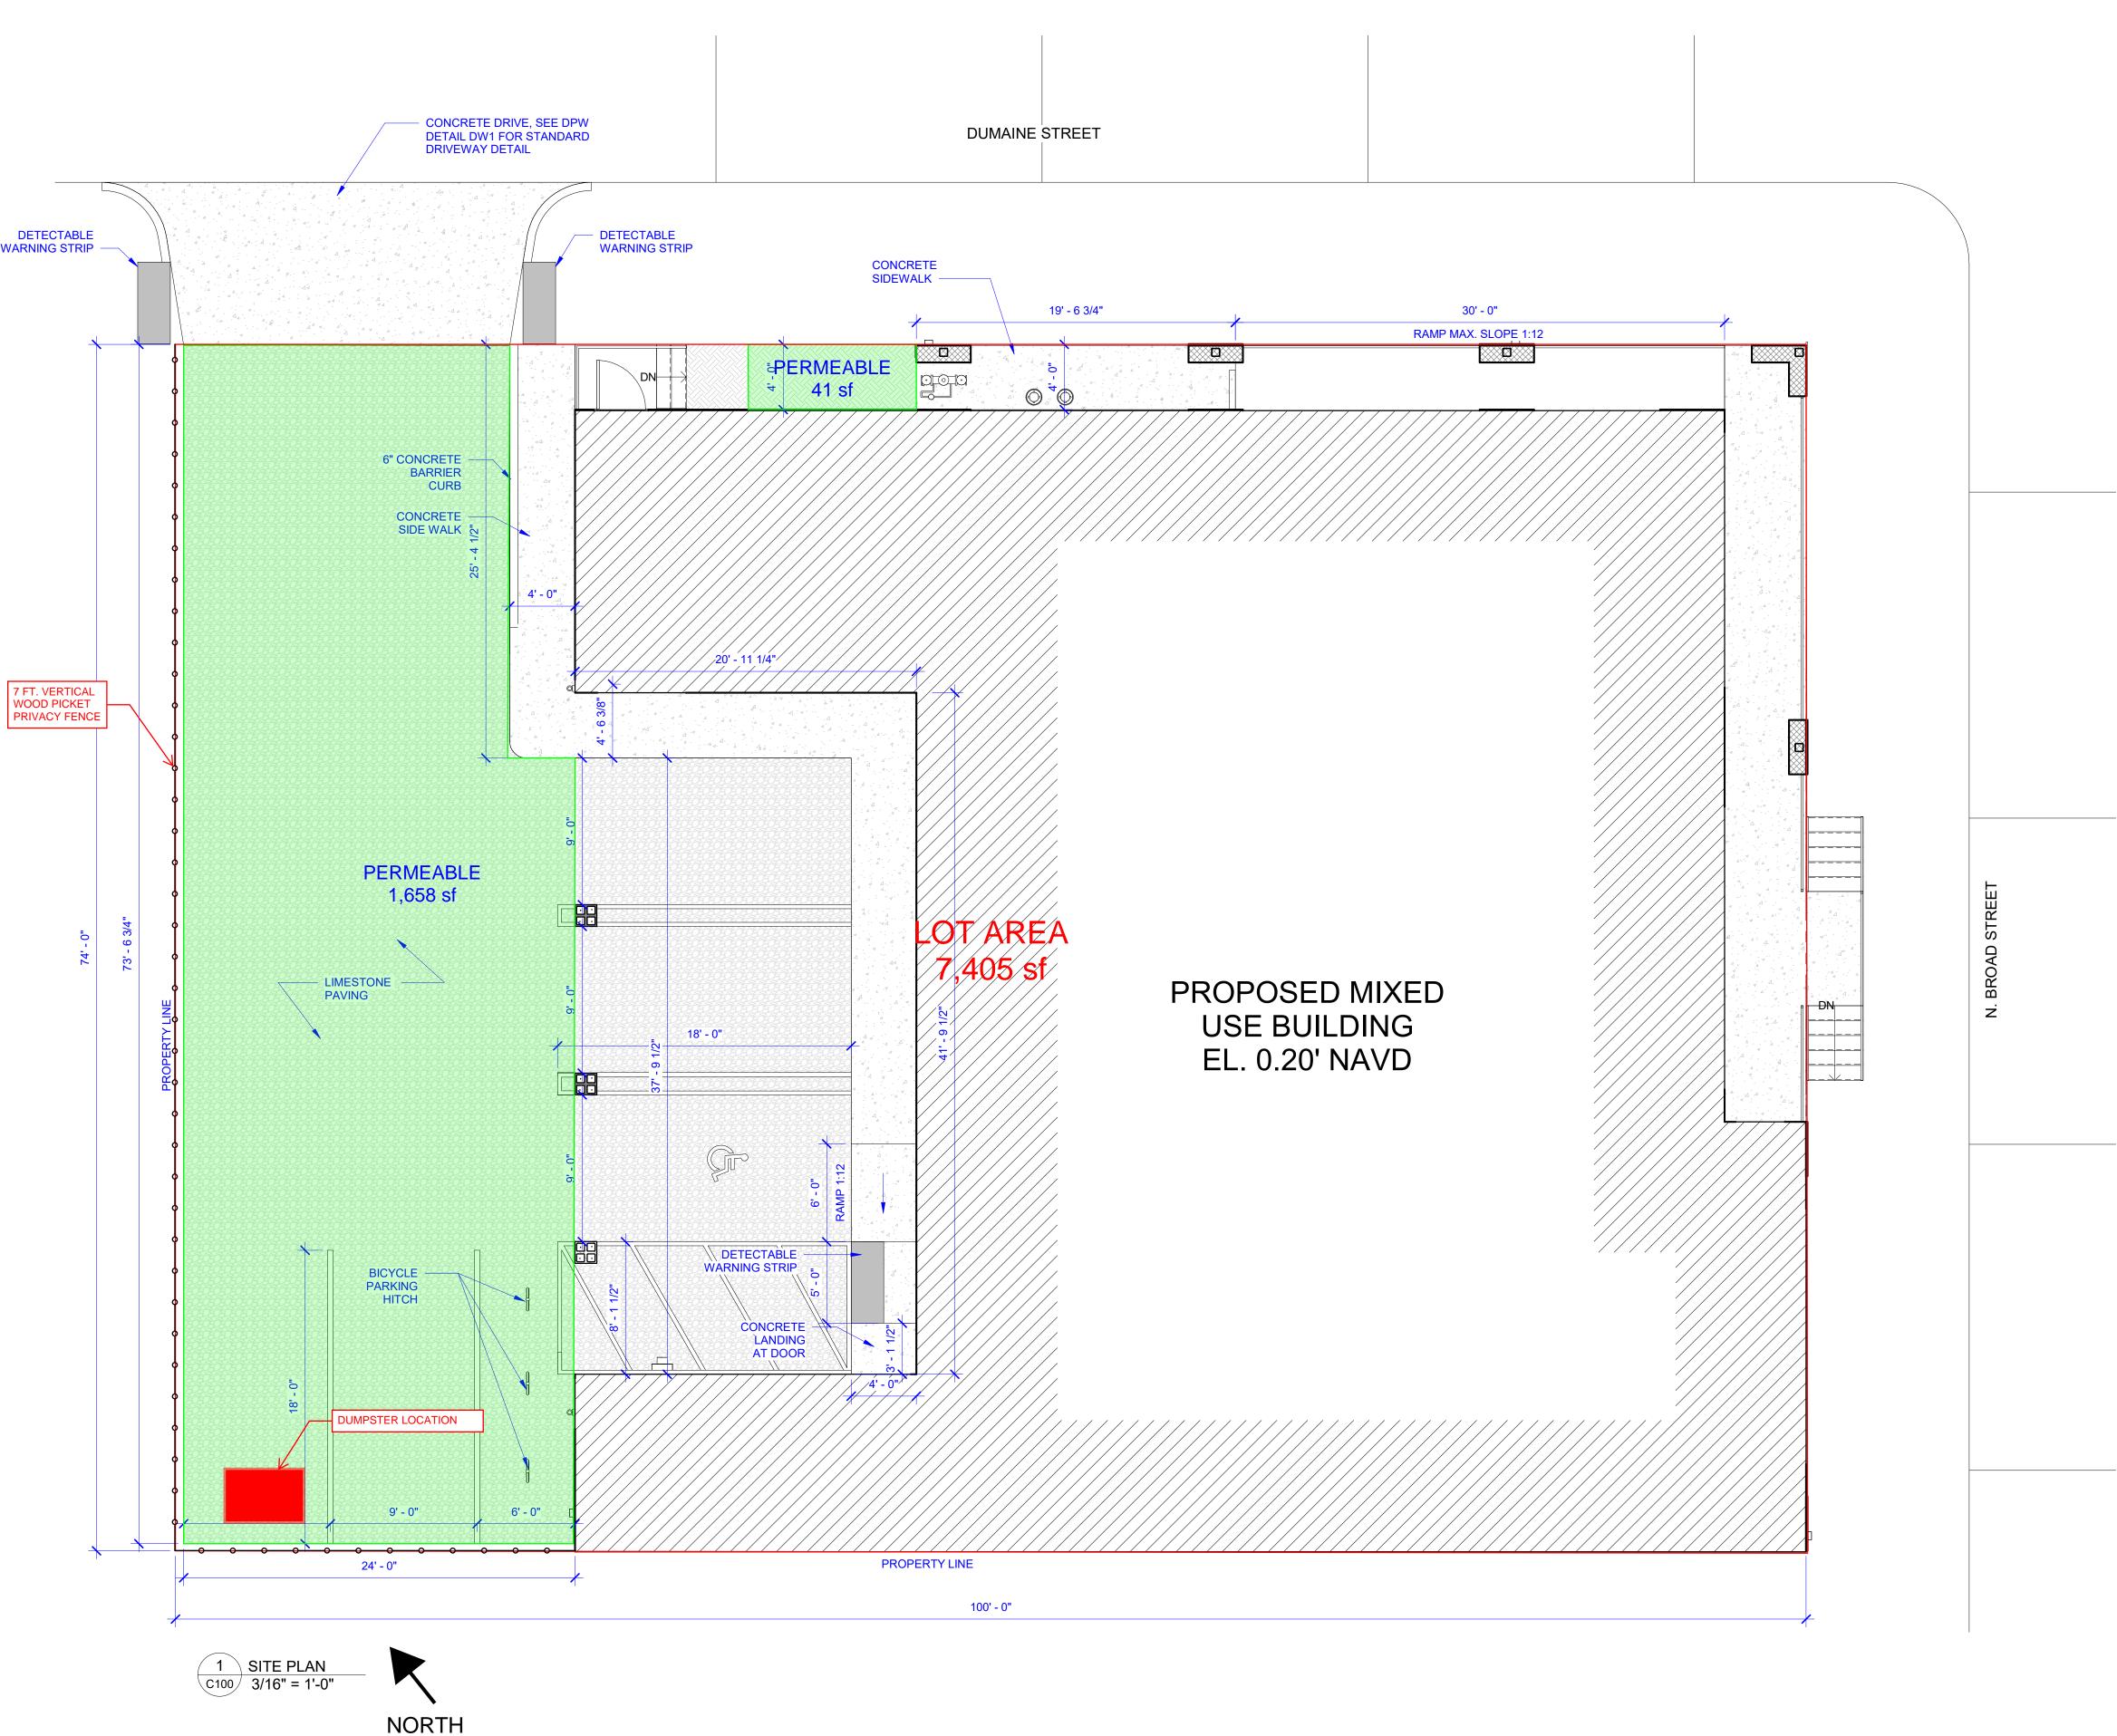

#### **CIVIL GENERAL NOTES:**

- 1. DIMENSIONS AND CONDITIONS TYING INTO OR GOVERNED BY EXISTING CONSTRUCTION ARE APPROXIMATE AND ARE NOT PURPOTED TO BE CORRECT. VERIFY EXISTENCE AND LOCATION OF ALL SURFACE AND SUBSURFACE STRUCTURES, UTILITIES, DEPTHS AND INVERTS PRIOR TO COMMENCING WORK. NOTIFY THE ARCHITECT IF CONDITIONS VARY FROM THOSE SHOWN.
- 2. ELEVATIONS ARE IN FEET, CAIRO DATUM. SEE SURVEY FOR REFERENCE BENCHMARK. ADD 20.43 TO NAVD TO OBTAIN CAIRO
- B. OBTAIN AND PAY FOR INSPECTIONS, LICENSES, PERMITS AND APPROVALS REQUIRED BY GOVERNING AUTHORITIES AND INSTALL
- ALL WORK IN COMPLIANCE THEREOF.

  DRAIN, SEWER AND WATER LINES ARE SHOWN IN SCHEMATIC DETAIL ONLY. IT IS NOT POSSIBLE TO DETAIL EVERY OFFSET, ELBOW, TEE, WYE, ETC., THAT MAY BE REQUIRED. PROVIDE COMPLETE WORKING UTILITY SYSTEMS.
- SEE ARCHITECTURAL AND PLUMBING DRAWINGS FOR CONTINUATION OF UTILITIES WITHIN 5'-0" OF BUILDINGS.
- WHERE NOTED, REFERENCED STANDARD SPECIFICATION SHALL BE THE CITY OF NEW ORLEANS DEPARTMENT OF PUBLIC WORKS STANDARD SPECIFICATIONS AND/OR THE NEW ORLEANS SEWERAGE AND WATER BOARD (S&WB) STANDARD SPECIFICATIONS, LATEST EDITION, OR THE LOUISIANA DOTD STANDARD SPECIFICATIONS FOR ROADS AND BRIDGES, LATEST EDITIONS, WHICHEVER IS MORE STRINGENT.
- 7. PROVIDE CONSTRUCTION ZONE TRAFFIC CONTROL PER LOUISIANA DOTD STANDARD PLANS.
- CONTRACTOR SHALL PROVIDE, TO THE ARCHITECT, ACCURATE ASBUILT DRAWINGS UPON SUBSTANTIAL COMPLETION OF THE PROJECT.

# EARTHWORK NOTES:

- 1. EXCAVATION SHALL INCLUDE THE REMOVAL OF MATERIAL ENCOUNTERED TO SUBGRADE ELEVATIONS INDICATED AND
- SUBSEQUENT DISPOSAL OF MATERIALS REMOVED.
  PROOFROLL SUBGRADE TO IDENTIFY WEAK AREAS. EXCAVATE
- WEAK AREAS AND BACKFILL WITH SELECT FILL.
  SELECT FILL SHALL BE LOCALLY AVAILABLE "PUMPED" SAND, FREE
  OF ROOTS, CLAY LUMPS, AND OTHER DELETERIOUS MATERIALS WITH
- NO MORE THAN 10% BY WEIGHT OF MATERIAL PASSING A U.S. STANDARD NO. 200 SIEVE.

  4. COMPACT SELECT FILL TO AT LEAST 95% (-1%, +3%) IF ITS MAXIMUM DRY DENSITY NEAR OPTIMUM WATER CONTENT IN ACORDANCE WITH ASTM D698 (STANDARD PROCTOR). FILL MATERIAL SHALL BE PLACED
- IN "LIFTS" NOT EXCEEDING EIGHT (8) INCHES.

  5. ALL CLEARING, FILLING AND COMPACTION OPERATIONS SHALL BE ACCOMPLISHED DURING PERIODS OF DRY WEATHER ONLY. DUE CONSIDERATION SHOULD BE GIVEN TO THE "SITE CONDITIONS" IN DETERMINING WHEN TO CONTINUE WORK FOLLOWING RAIN EVENTS.

#### **CONCRETE PAVING NOTES:**

- 1. WHERE NEW PAVING IS TO MEET EXISTING, SAW CUT TO ENSURE A STRAIGHT JOINT.
- 2. FOLLOW NEW ORLEANS DPW STANDARDS FOR ALL PAVEMENT IN PUBLIC RIGHT OF WAY.
- DEFORMED STEEL BARS SHALL BE GRADE 60 AND SHALL CONFORM TO ASTM A615. WELDED WIRE FABRIC SHALL CONFORM TO ASTM A185. DOWEL BARS SHALL BE PLAIN BARS CONFORMING TO ASTM A615.

### **LIMESTONE PAVING NOTES:**

- 1. ALL LIMESTONE PAVING SHALL BE SURROUNDED BY 6" BARRIER CURB OR CONCRETE PAVING EDGE.
- CURB OR CONCRETE PAVING EDGE.
  PROVIDE TRUEGRID PRO PLUS
- 3. PROVIDE MIN. THICKNESS OF 18 IN. OF WELL GRADED LIMESTONE.
  LIMESTONE SHALL BE COMPACTED TO AT LEAST 95% OF MAXIMUM
  DRY DENSITY AT OPTIMUM MOISTURE CONTENT ACCORDING TO
  ASTM D 1557 OR BE COMPACTED TO A MINUMUM RELATIVE DENSITY
  OF 75% AS DETERMINED BY ASTM D 4253 AND D 4254. THE MATERIAL
  SHALL BE PLACED IN 6 IN. LOOSE LIFTS.
- 4. GEOTEXTILE FABRIC SHALL BE A NON-WOVEN FABRIC WITH AN APPARENT OPENING SIZE (AOS) SMALLER THAT THE U.S. NO. 70 SIEVE.

# ZONING INFO:

ZONING DISTRICT: HU-MU

MIN. LOT AREA:
MIN. LOT WIDTH:
NONE
MAX. BUILDING HEIGHT:
MIN. PERMEABLE SPACE:
NONE
40' & NO MORE THAN 3 STORIES
10%

FRONT YARD: 0'
INTERIOR SIDE YARD: NONE
CORNER SIDE YARD: NONE

GROSS FLOOR AREA 1ST FLR: GROSS FLOOR AREA 2ND FLR:


REAR YARD: NONE
15' ABUTTING RESIDENTIAL DIST.

4192 SF 5533 SF

TOTAL GROSS FLOOR AREA: 9,725 SF
USES

RETAIL (FUTURE): PERMITTED PERMITTED

PARKING REQUIREMENTS:
DENTAL OFFICE 2ND FLOOR:
FUTURE TENANT OFFICE 2ND FLOOR:
RETAIL/OFFICE FUTURE 1ST FLOOR:
LESS THAN 5000 SF/EXEMPT
LESS THAN 5000 SF/EXEMPT

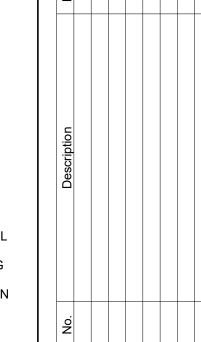

YAL ENGINEERS & CONSULTA 8 ELYSIAN FIELDS AVENUE TE B W ORLEANS, LA 70122

WMC REALTY
837 N BROAD
DEVELOPMENT
837 N Broad Street
New Orleans, LA 70119


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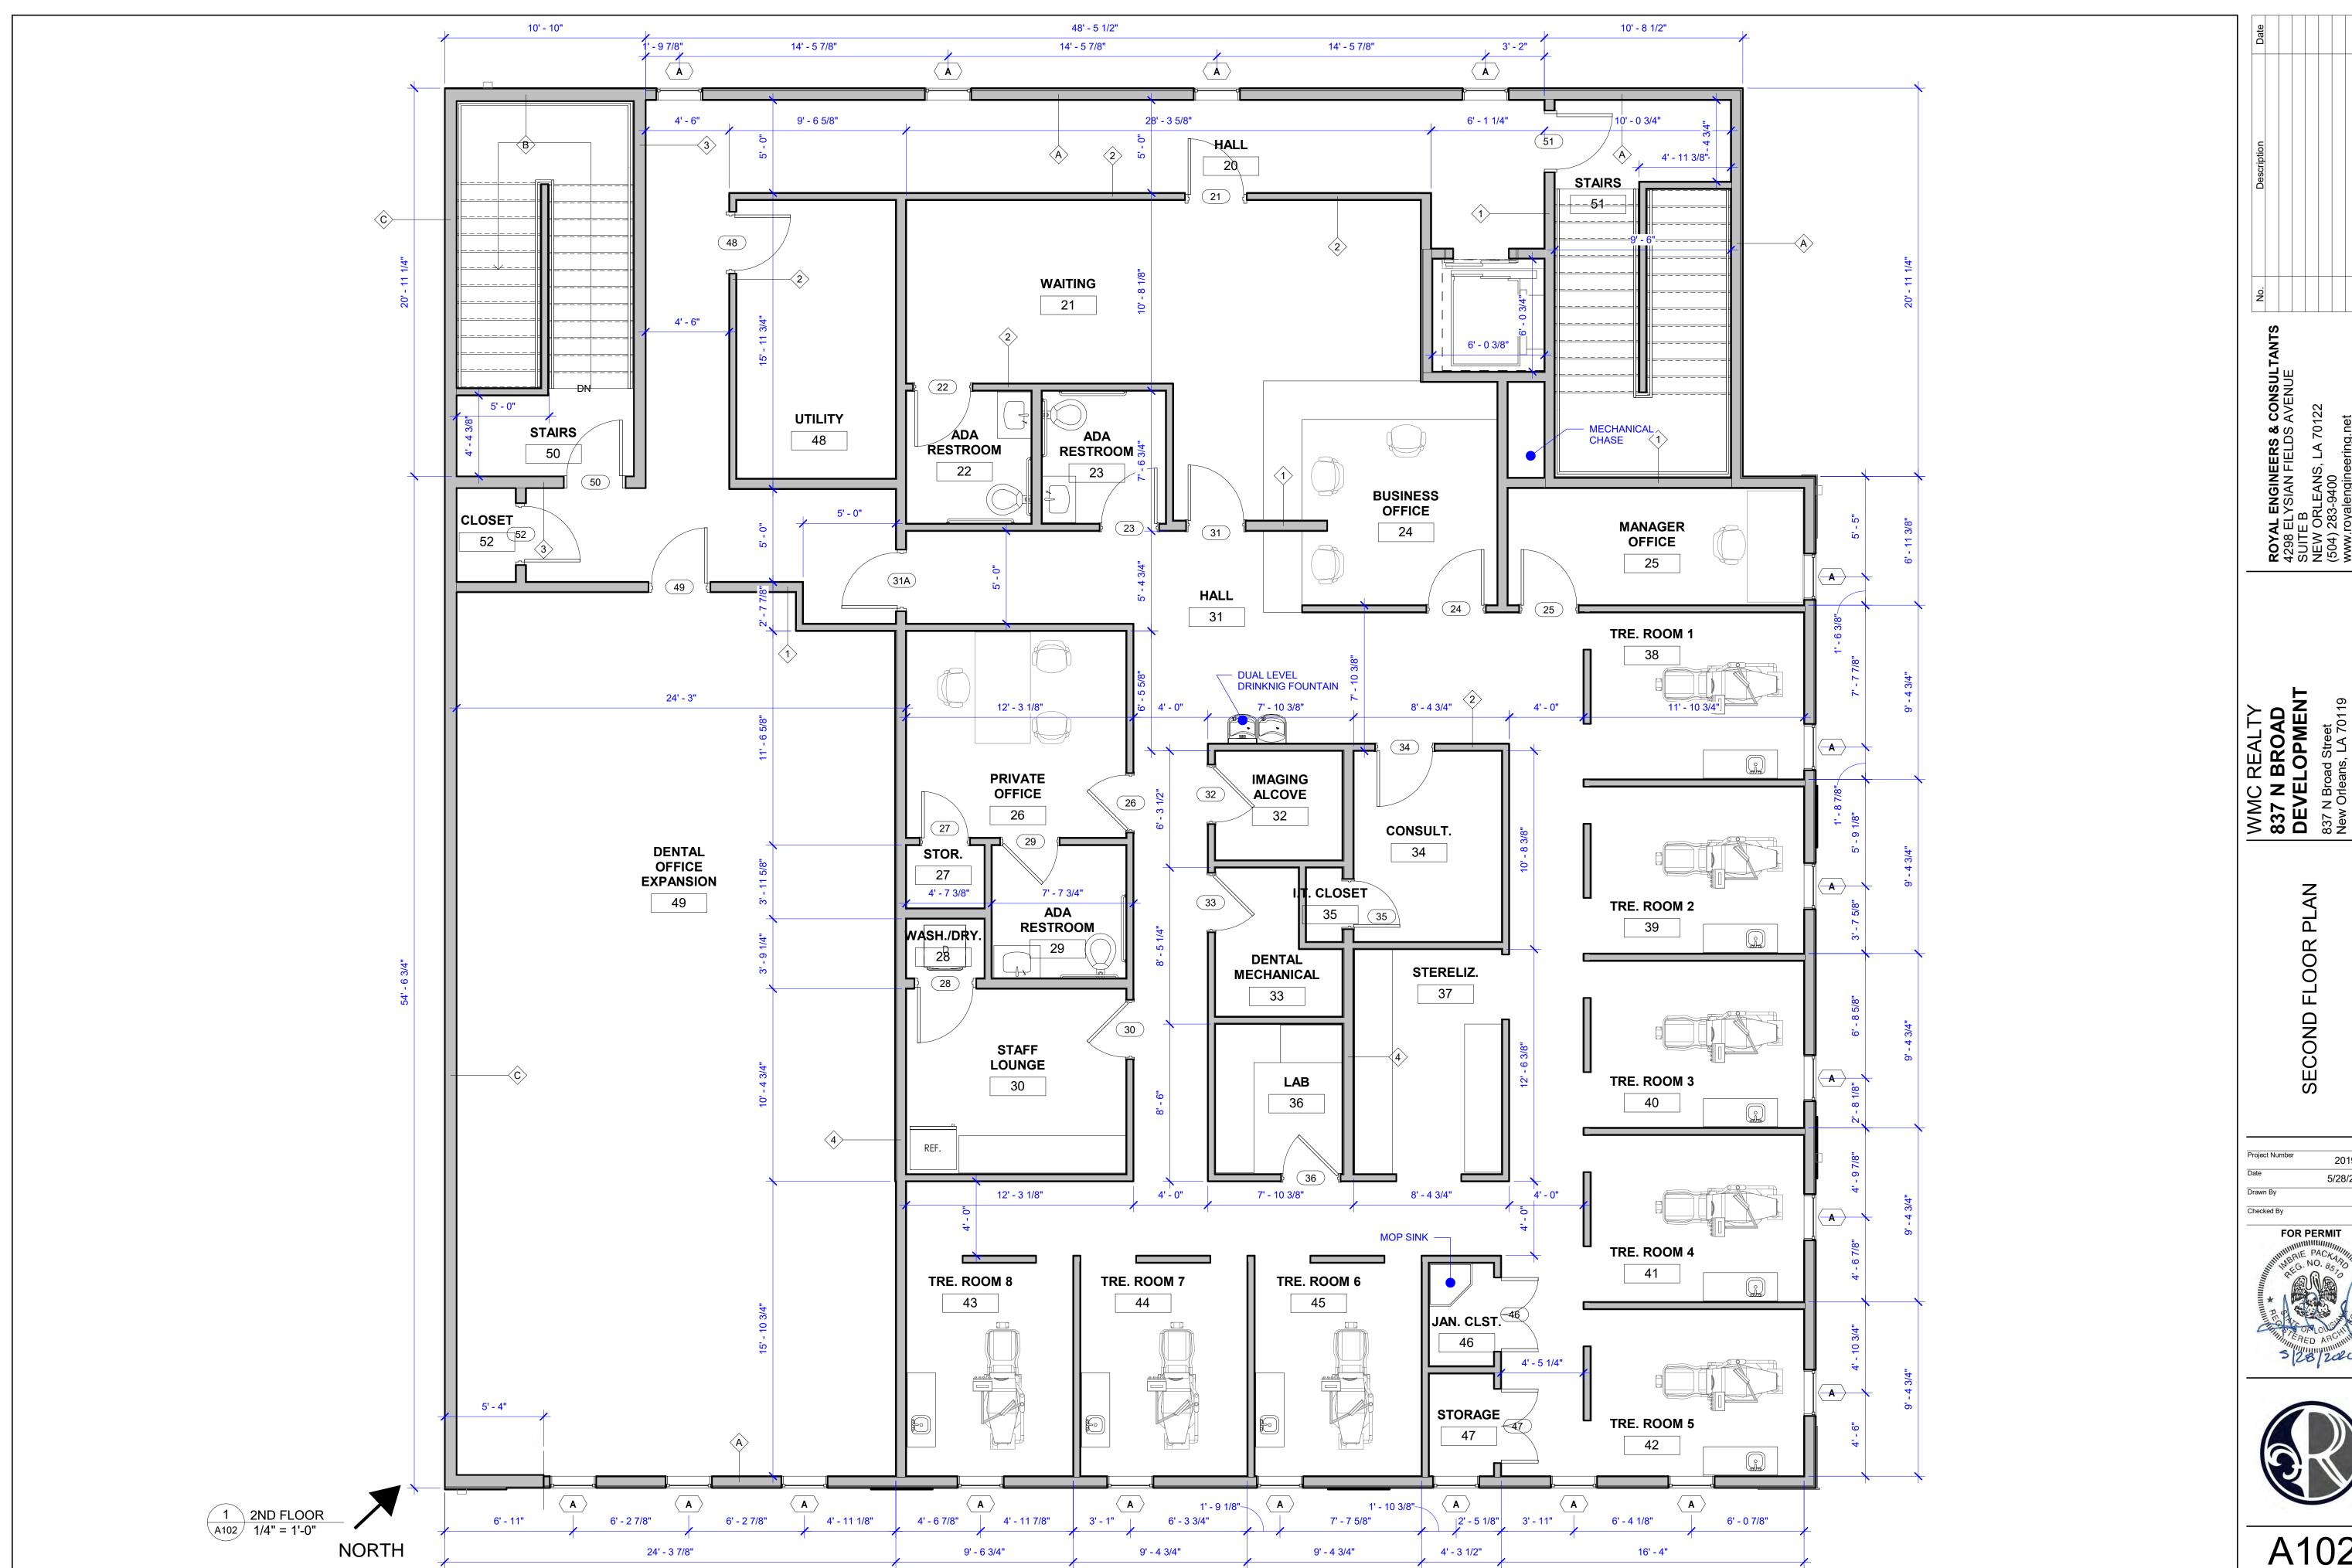
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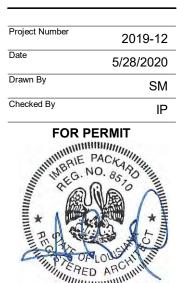
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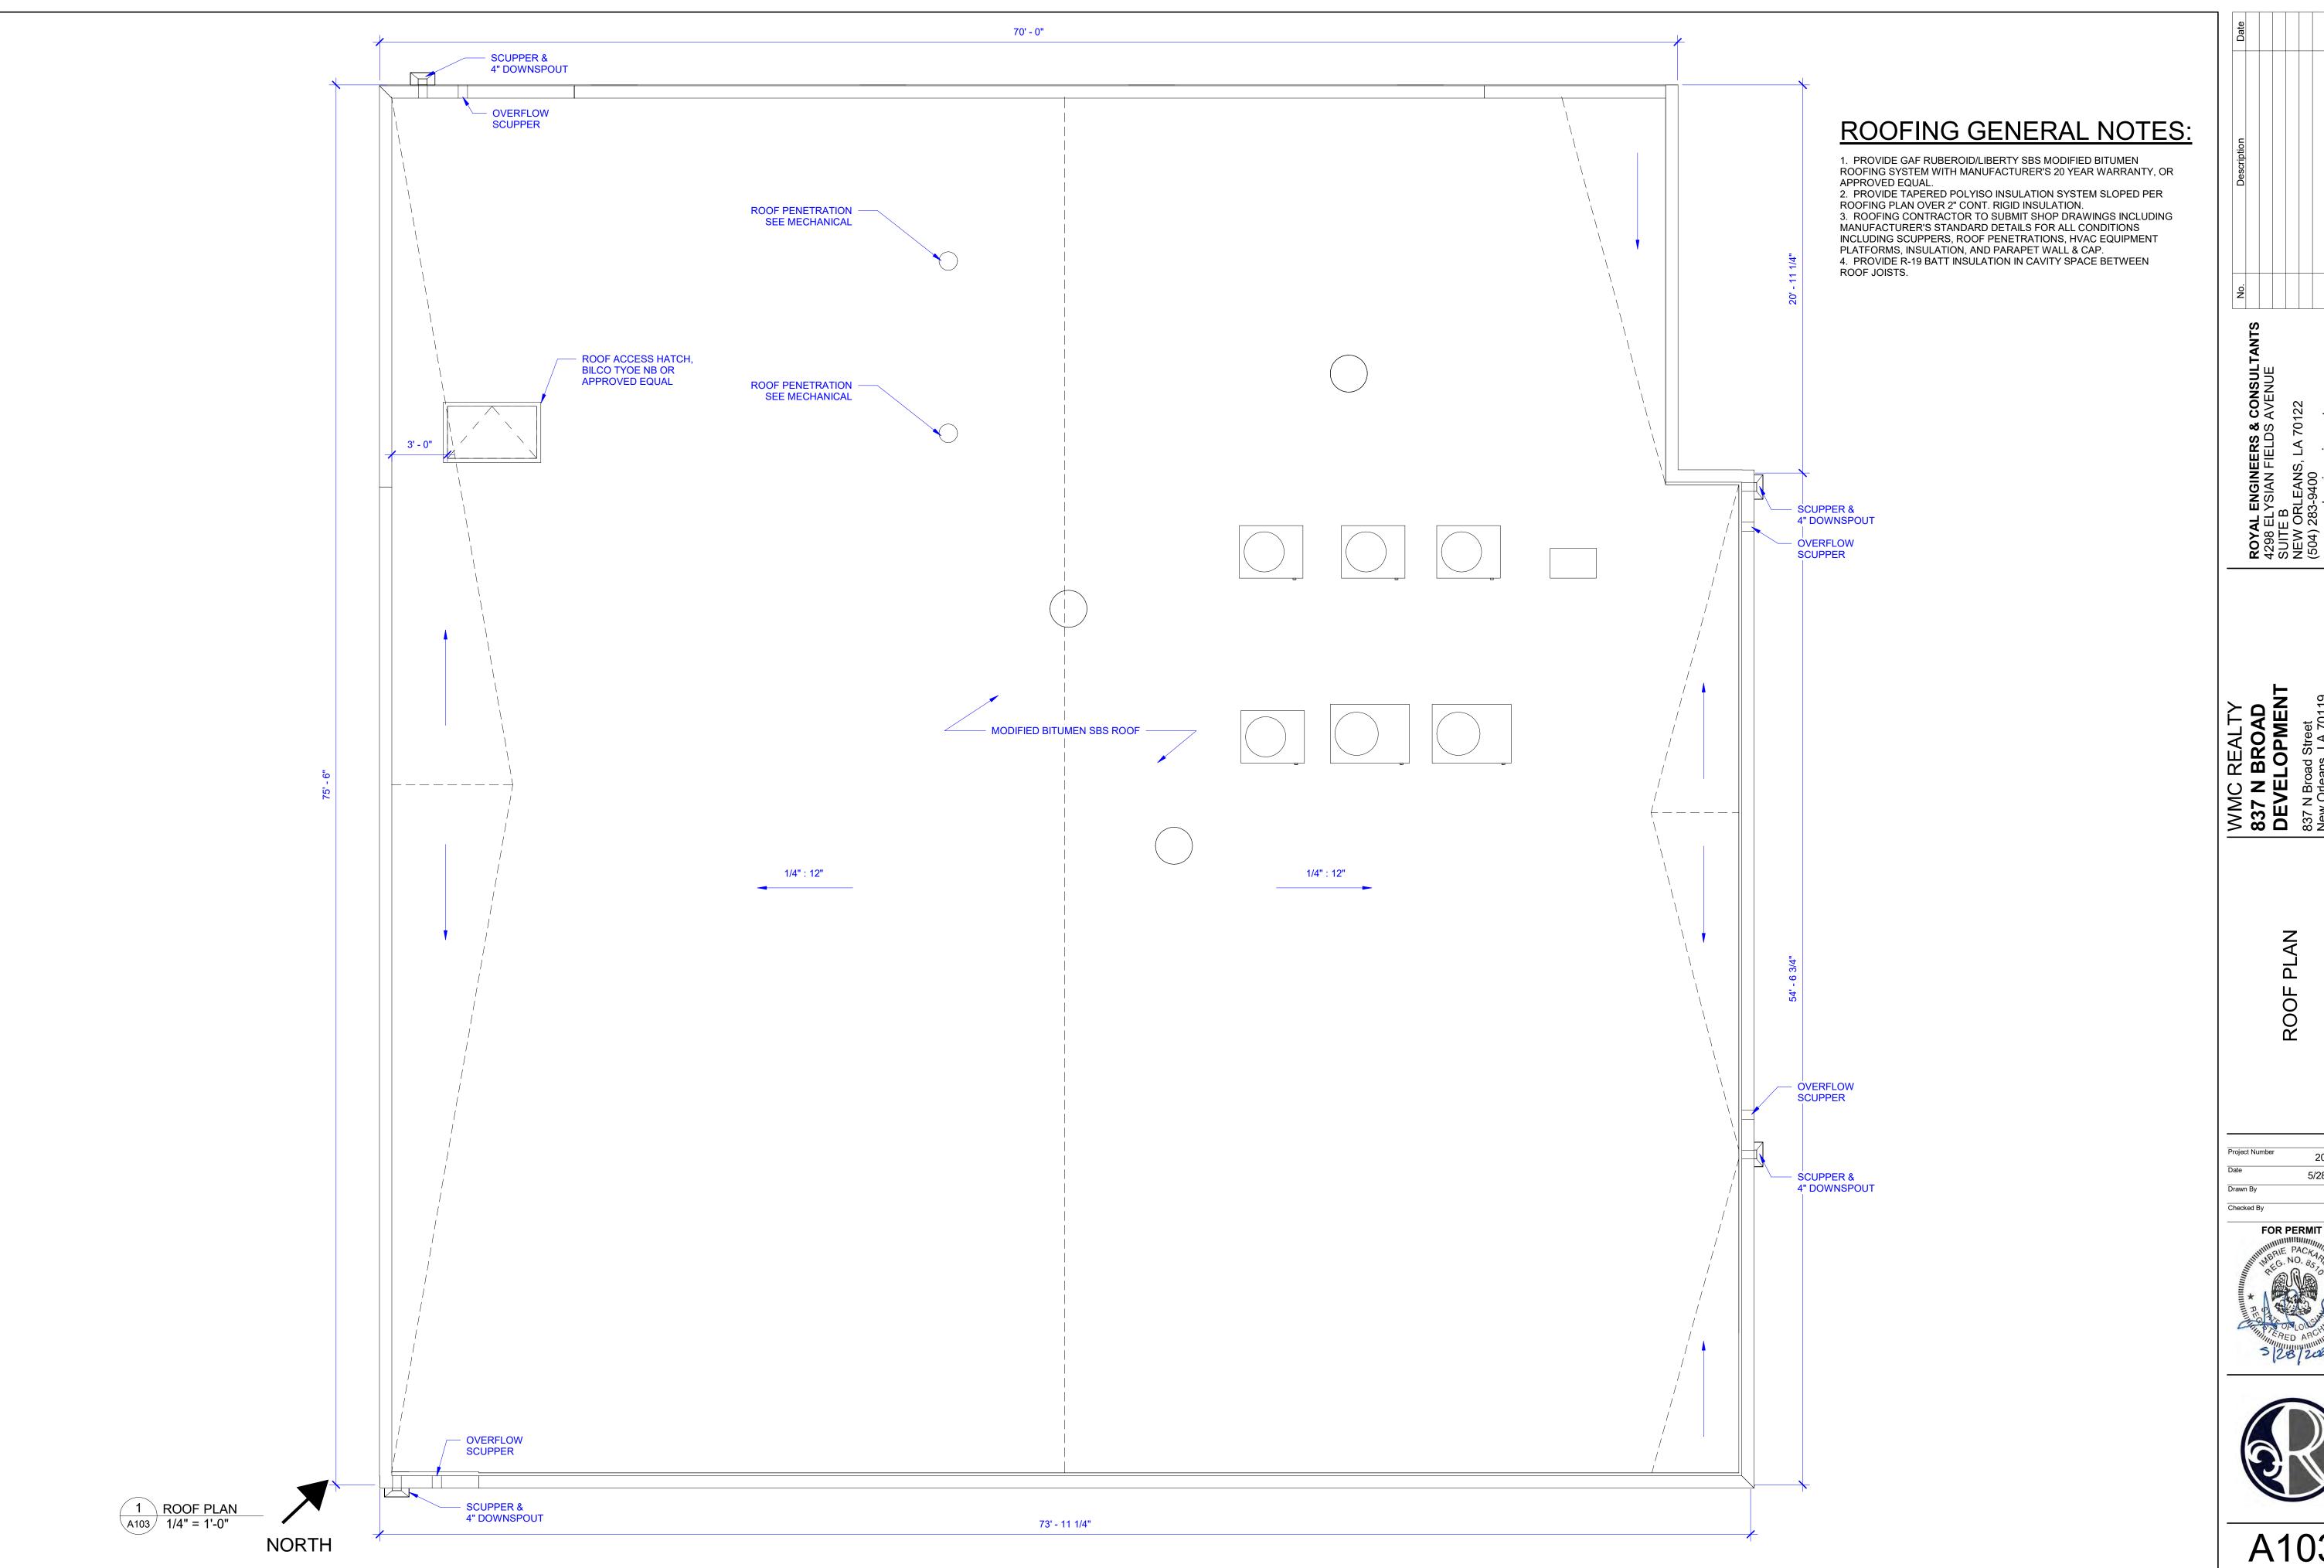








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2019-12

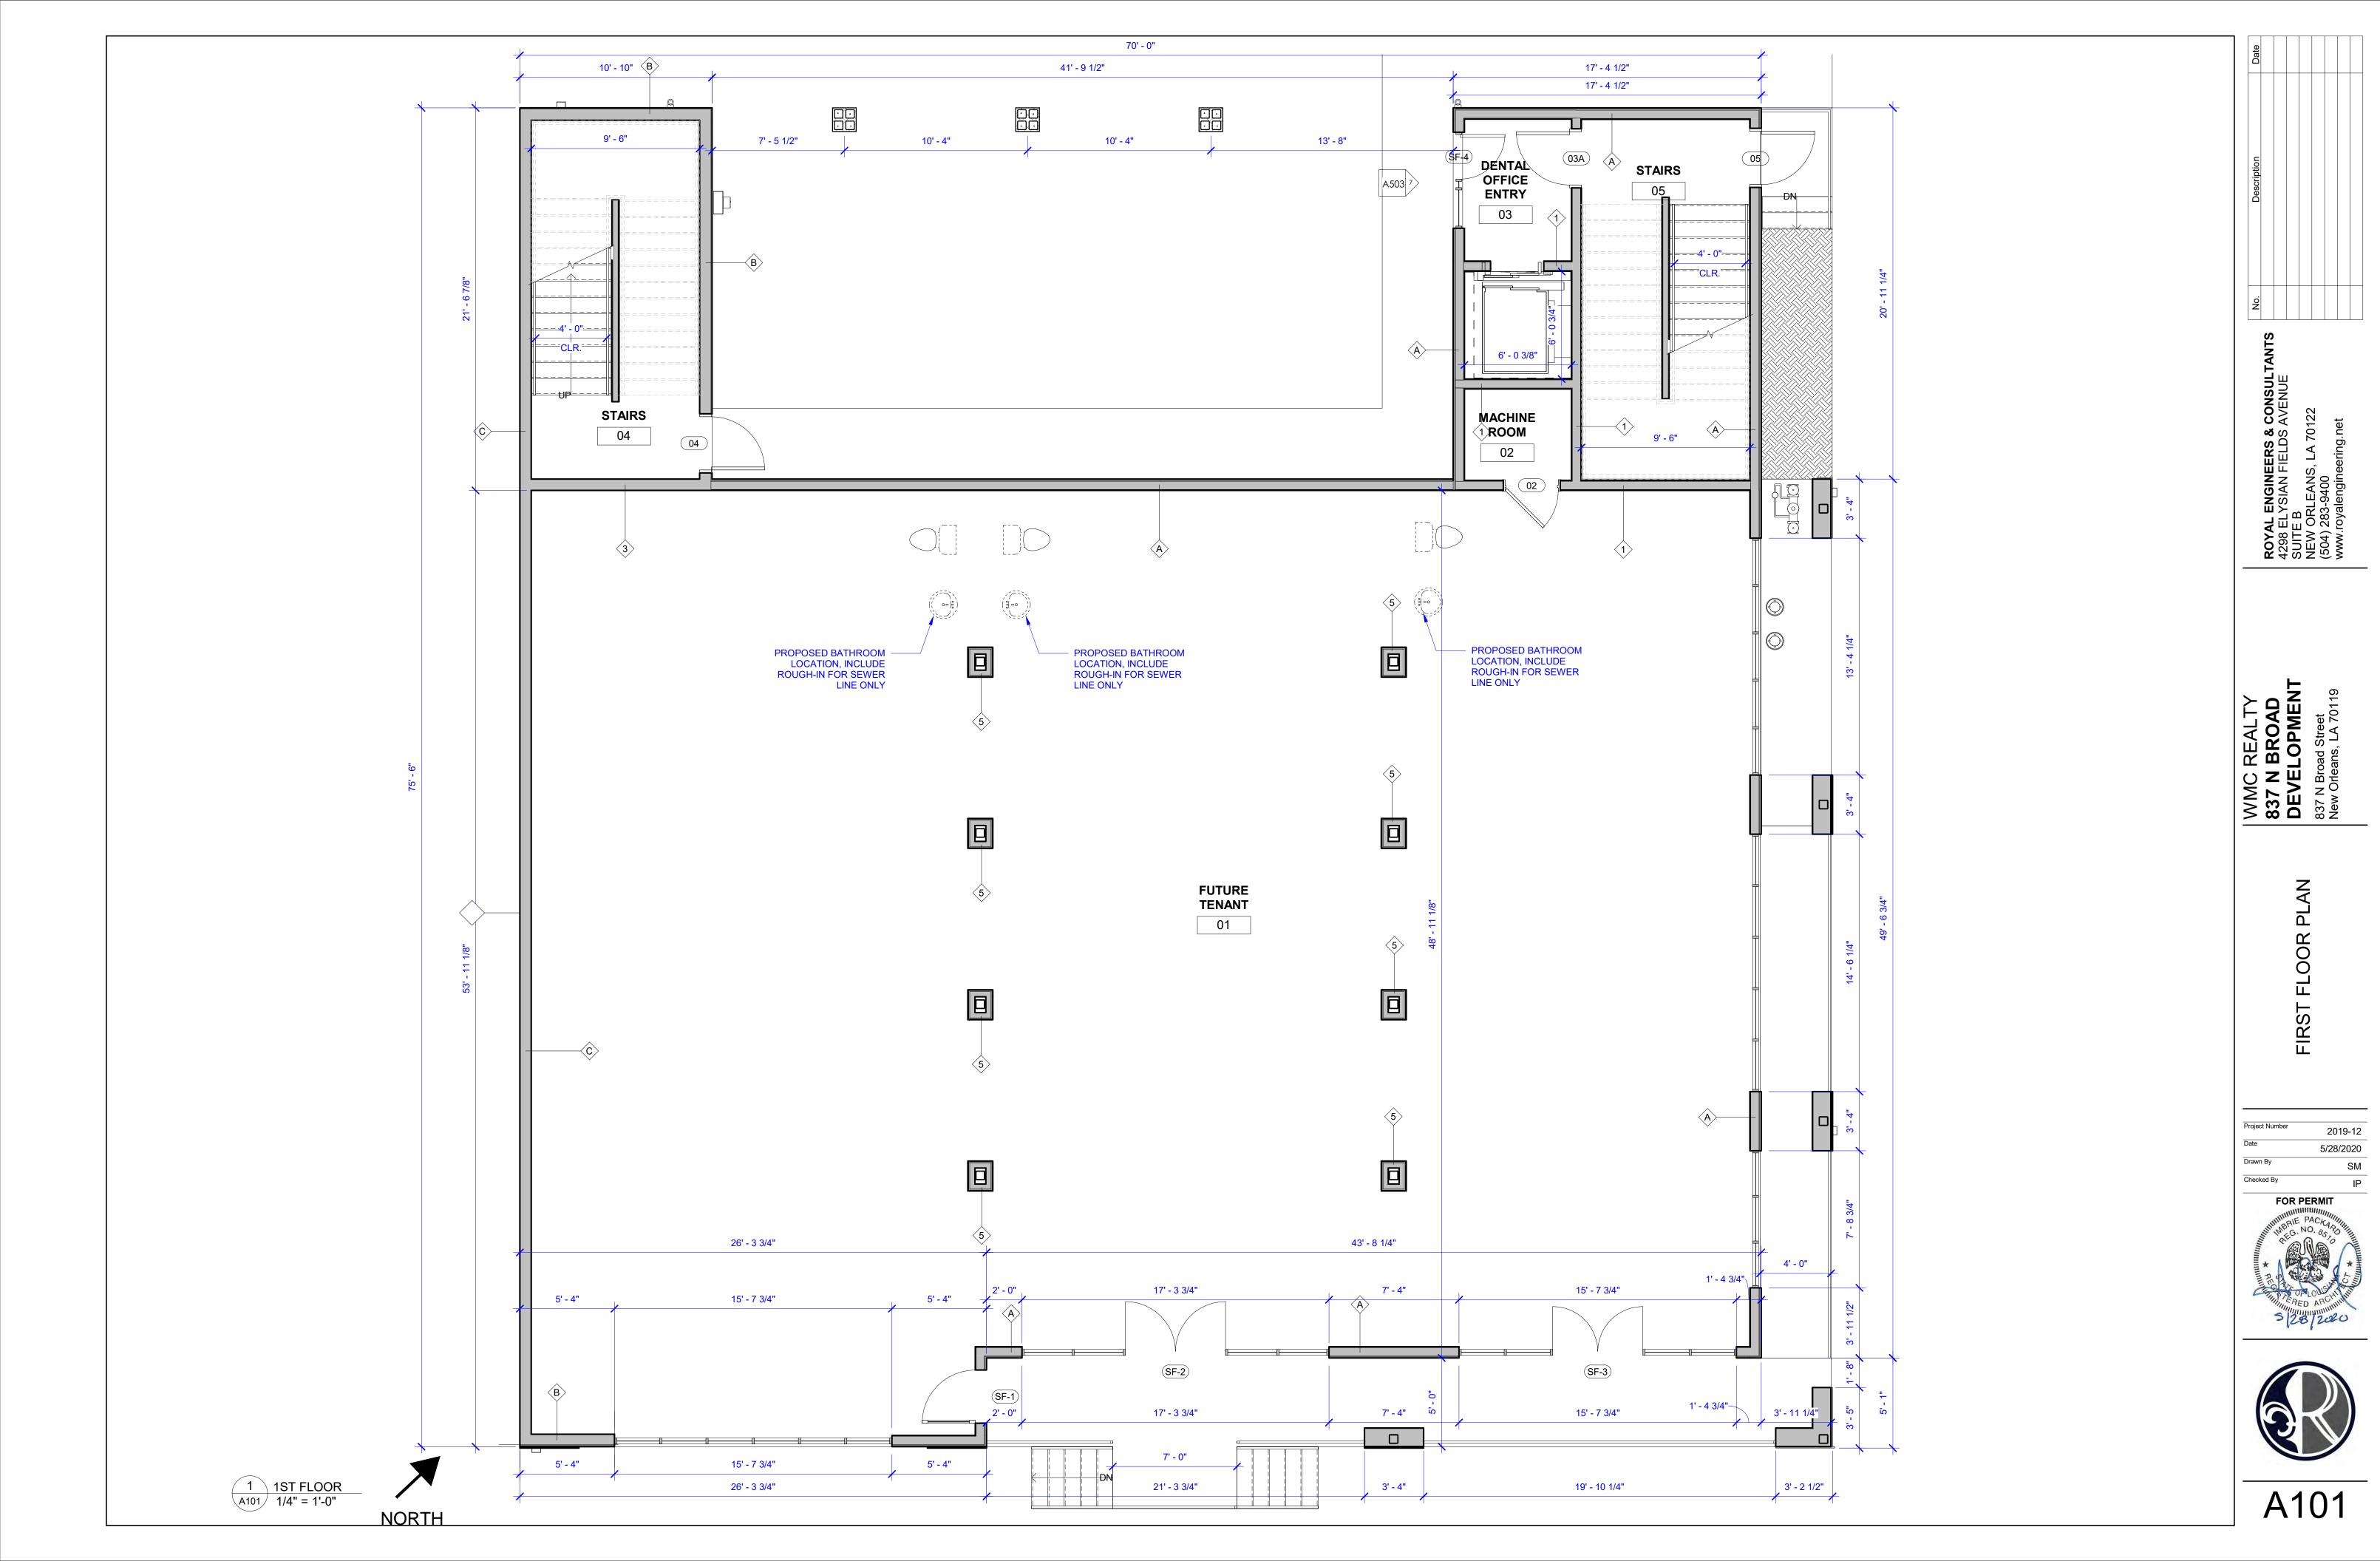837 N Broad Street
New Orleans, LA 70119

ENGINEERS & CONSULTANTS YSIAN FIELDS AVENUE

VIIONS

Project Number 2019-12

Date 5/28/2020


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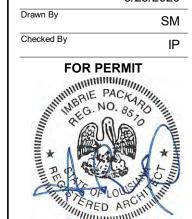
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2019-12 5/28/2020 FOR PERMIT






# GENERAL NOTE:


A. COORDINATE LOCATION OF ALL EXTERIOR WALL SCONCES WITH DOWNSPOUTS. REFERENCE ARCHITECTURAL ELEVATIONS.
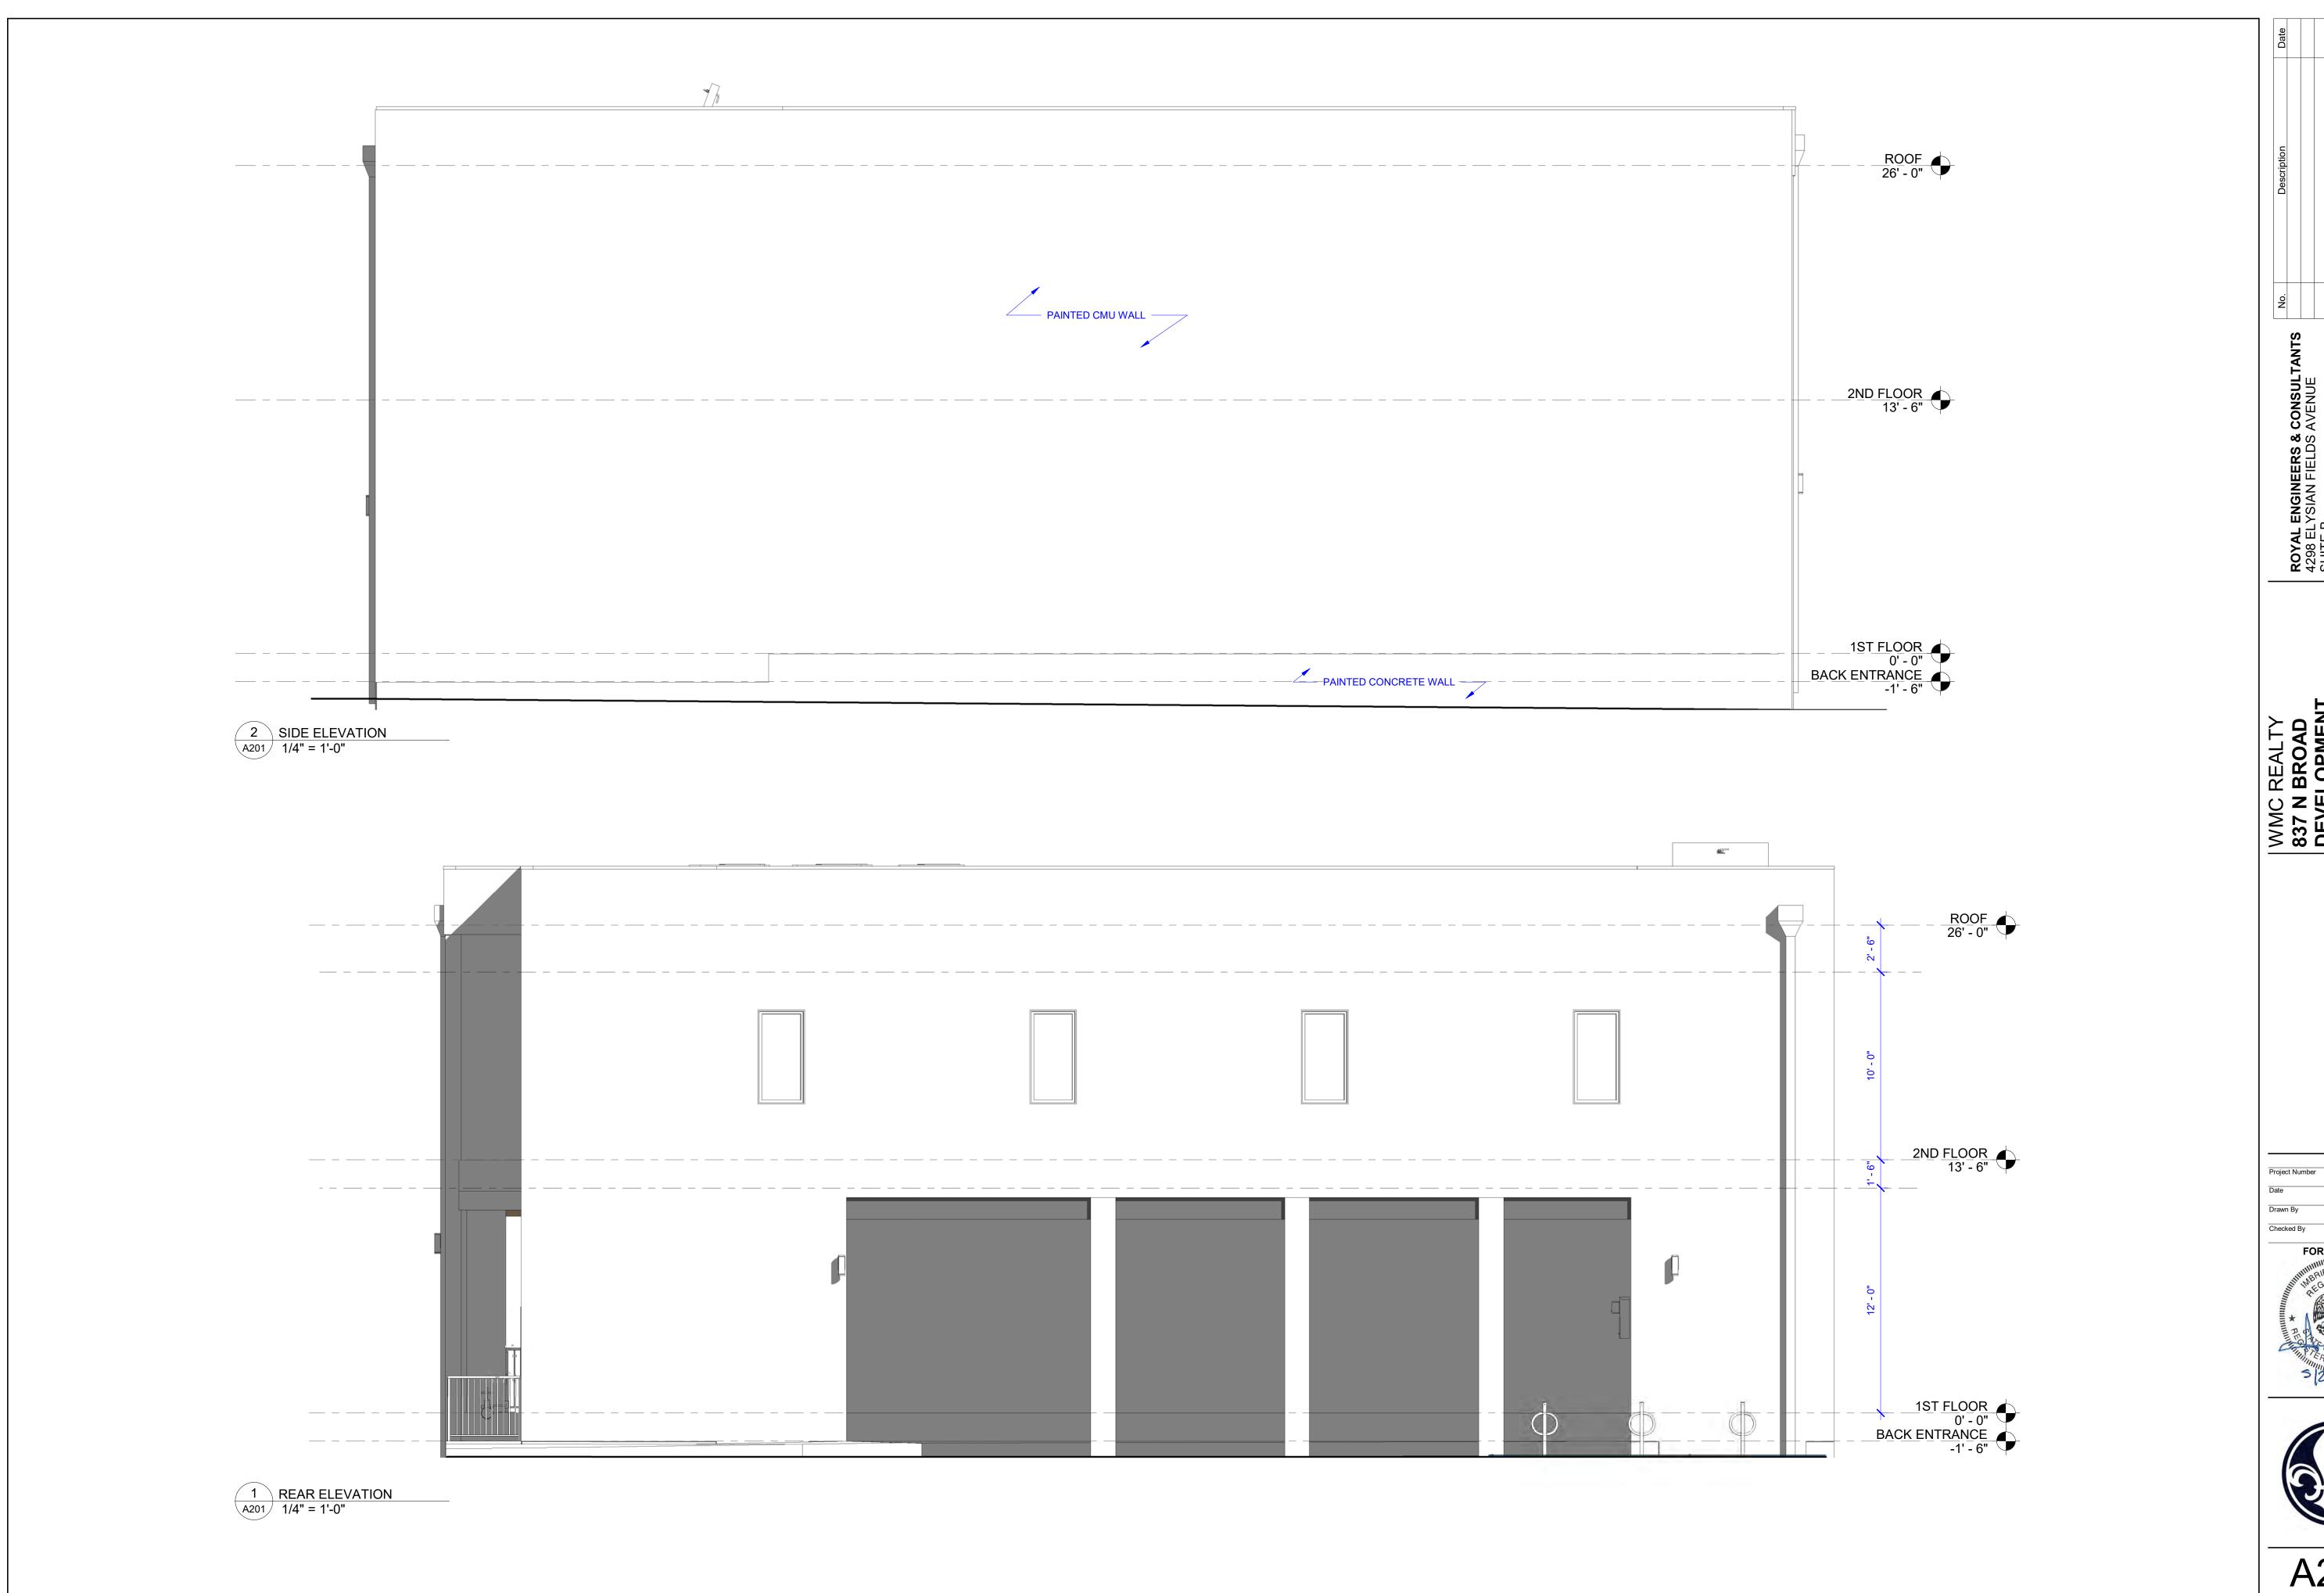
# KEY NOTES:

- (1) CONTINUE TO FLOOR 2
- $\langle 2 \rangle$  HOMERUN SEPARATELY FROM STAIRWELL FIXTURES.

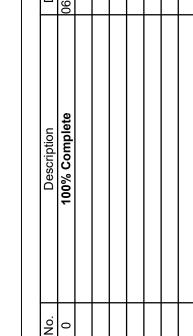

Project Number	2019-12
Date	06/02/2020
Drawn By	AG
Checked By	KS

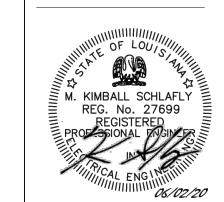




FIRST FLOOR LIGHTING PLAN E101 SCALE: 3/16"=1'-0"



E101

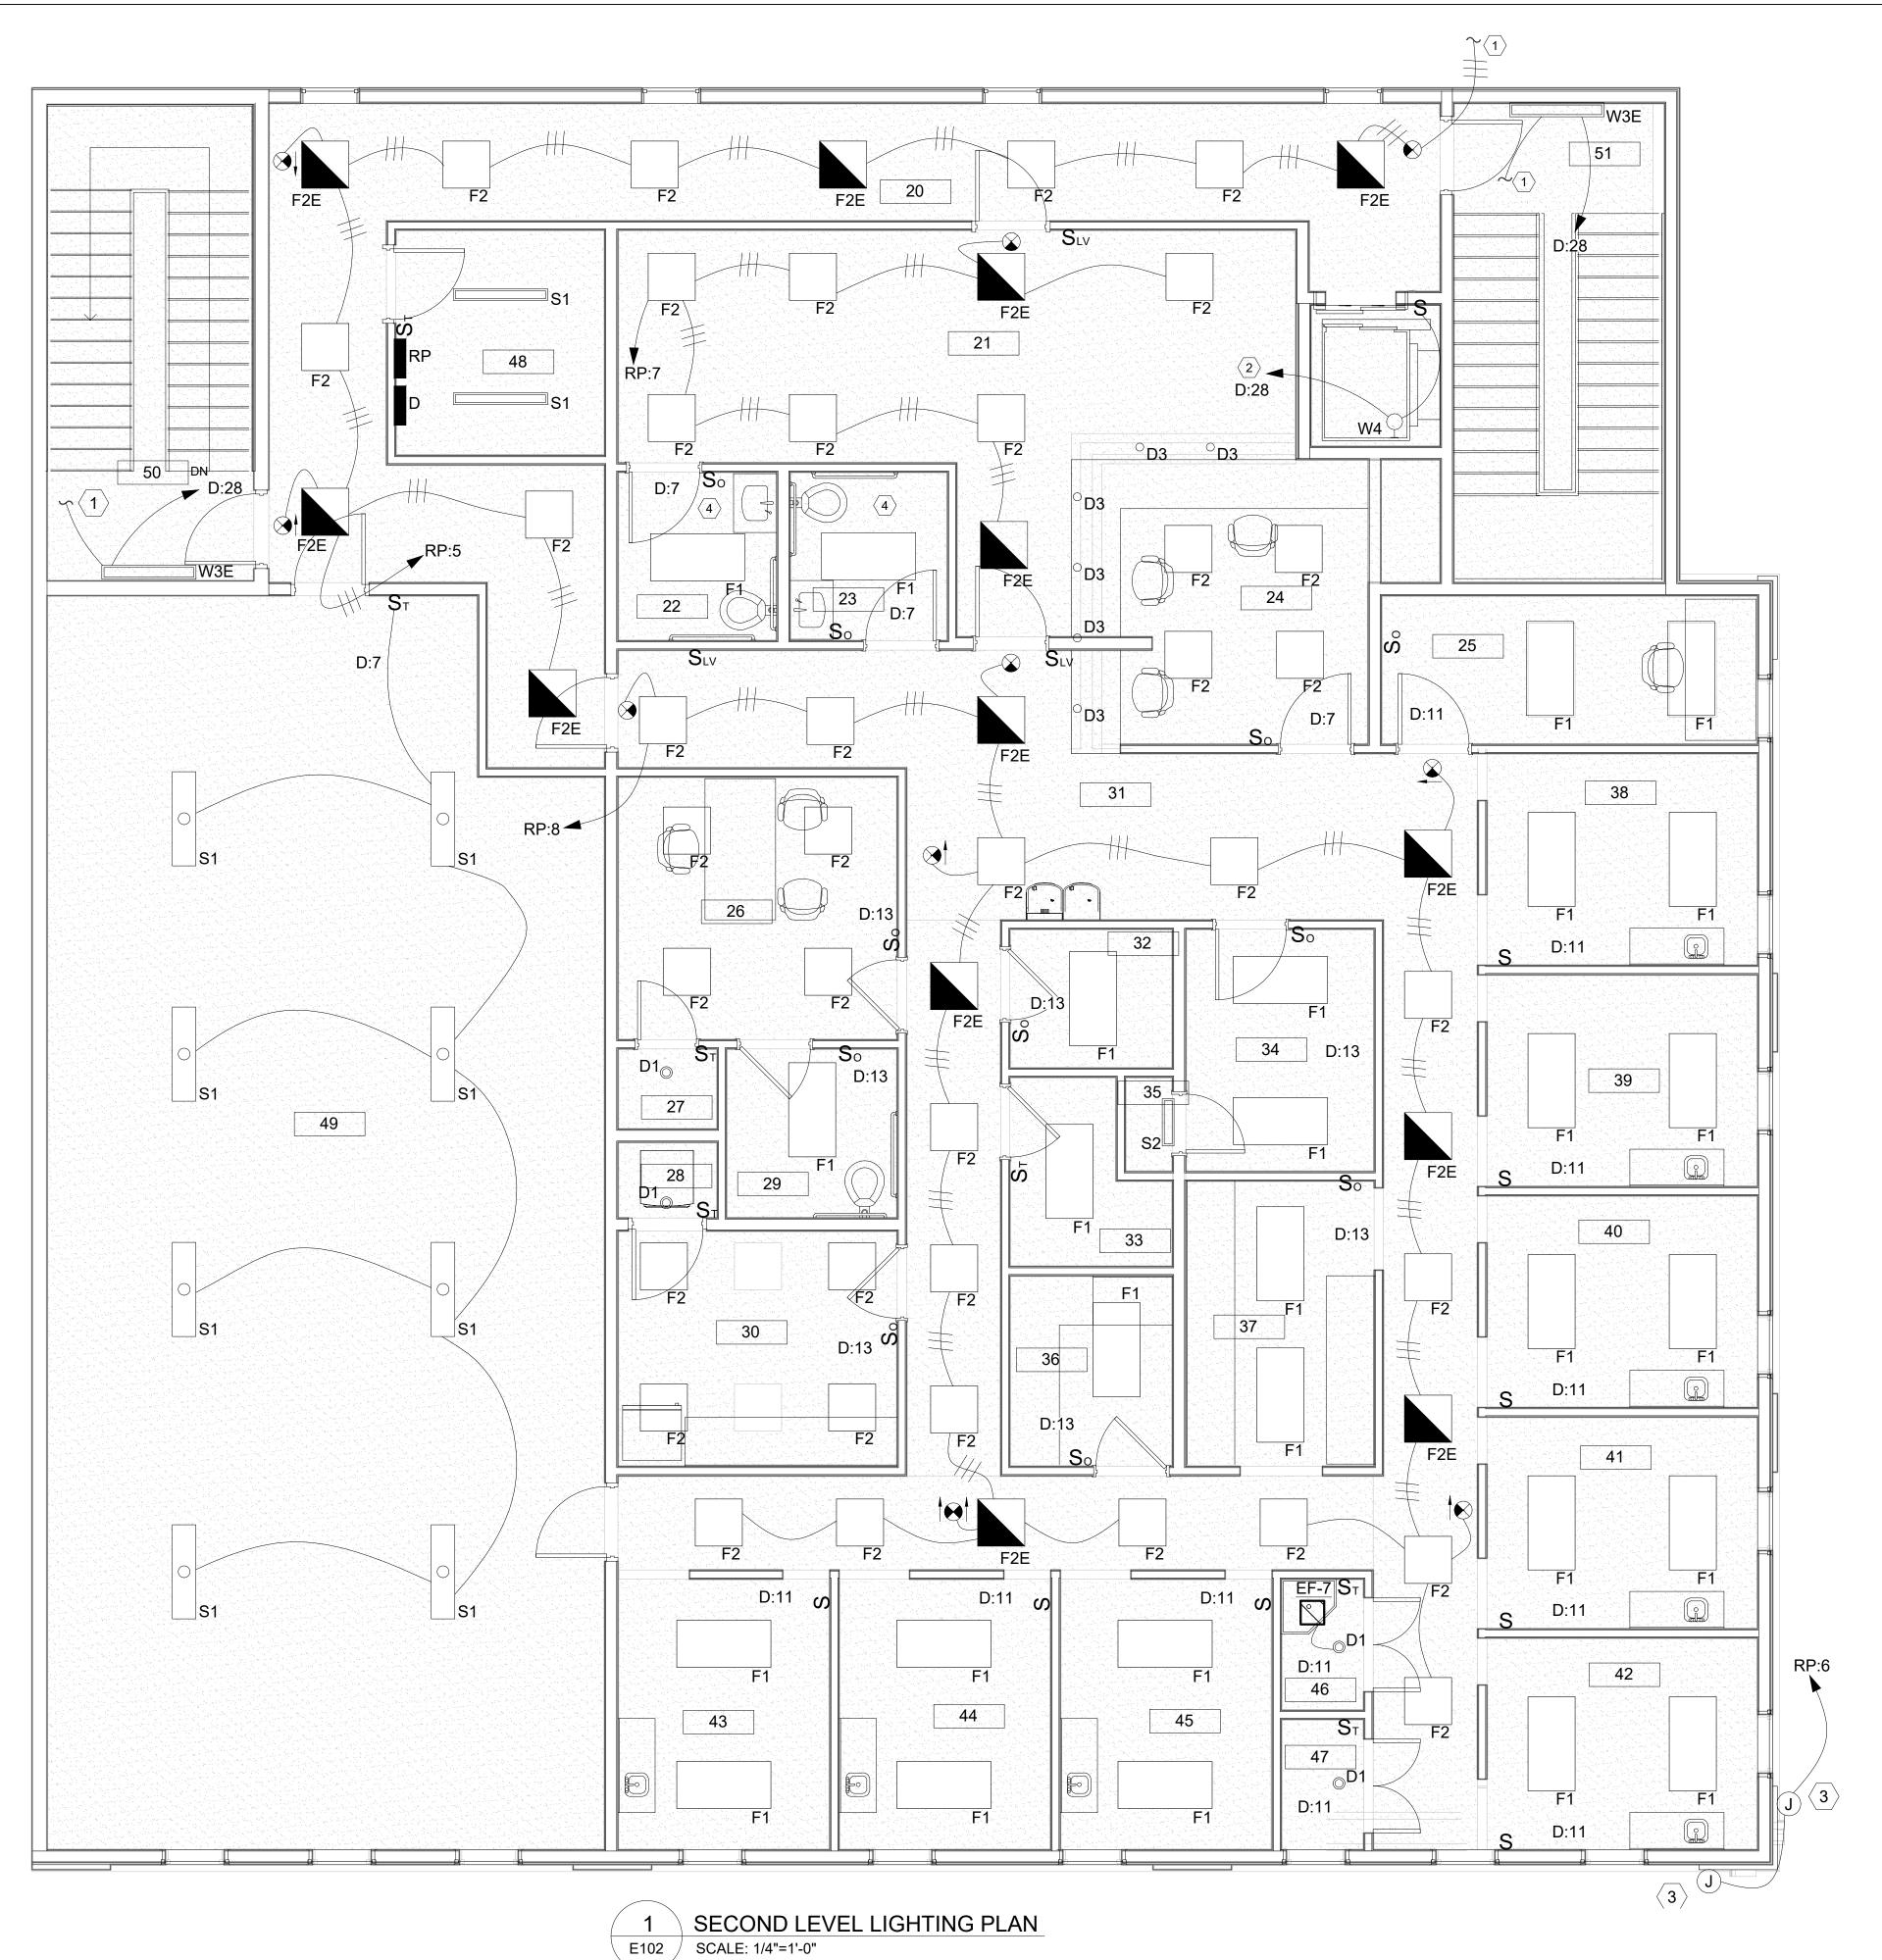


#### **GENERAL NOTES:**

- A. ALL WIRE SHALL BE COPPER, 2 #12 AWG AND 1 #12 GND IN 1/2"C., UNLESS OTHERWISE NOTED.
- B. ALL CONDUIT SHALL CONTAIN A #12 GND UNLESS OTHERWISE NOTED.

# **KEY NOTES:**

- 1 CONTINUE TO FLOOR BELOW.
- $\langle 2 \rangle$  HOMERUN SEPARATELY FROM STAIRWELL FIXTURES.
- COORDINATE WITH SIGN INSTALLER AND PROVIDE CONNECTORS AS NECESSARY TO EXTERIOR SIGNAGE.
- 4 CONNECT RESTROOM EXHAUST FAN TO LIGHTING CONTROL IN SAME ROOM SUCH THAT WHEN LIGHT IS ON, FAN IS ENERGIZED.

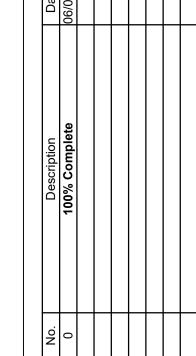

DYAL ENGINEERS & CONSULT/ 1988 ELYSIAN FIELDS AVENUE JITE B EW ORLEANS, LA 70122 04) 283-9400

37 N BROAD
EVELOPMENT
87 N Broad Street


ELECTRICAL SECOND FLOOR LIGHTING PLAN

 Project Number
 2019-12

 Date
 06/02/2020

 Drawn By
 AG

 Checked By
 KS

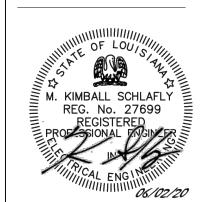



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