


ISOMETRIC DRAWING - NORTHEAST CORNER

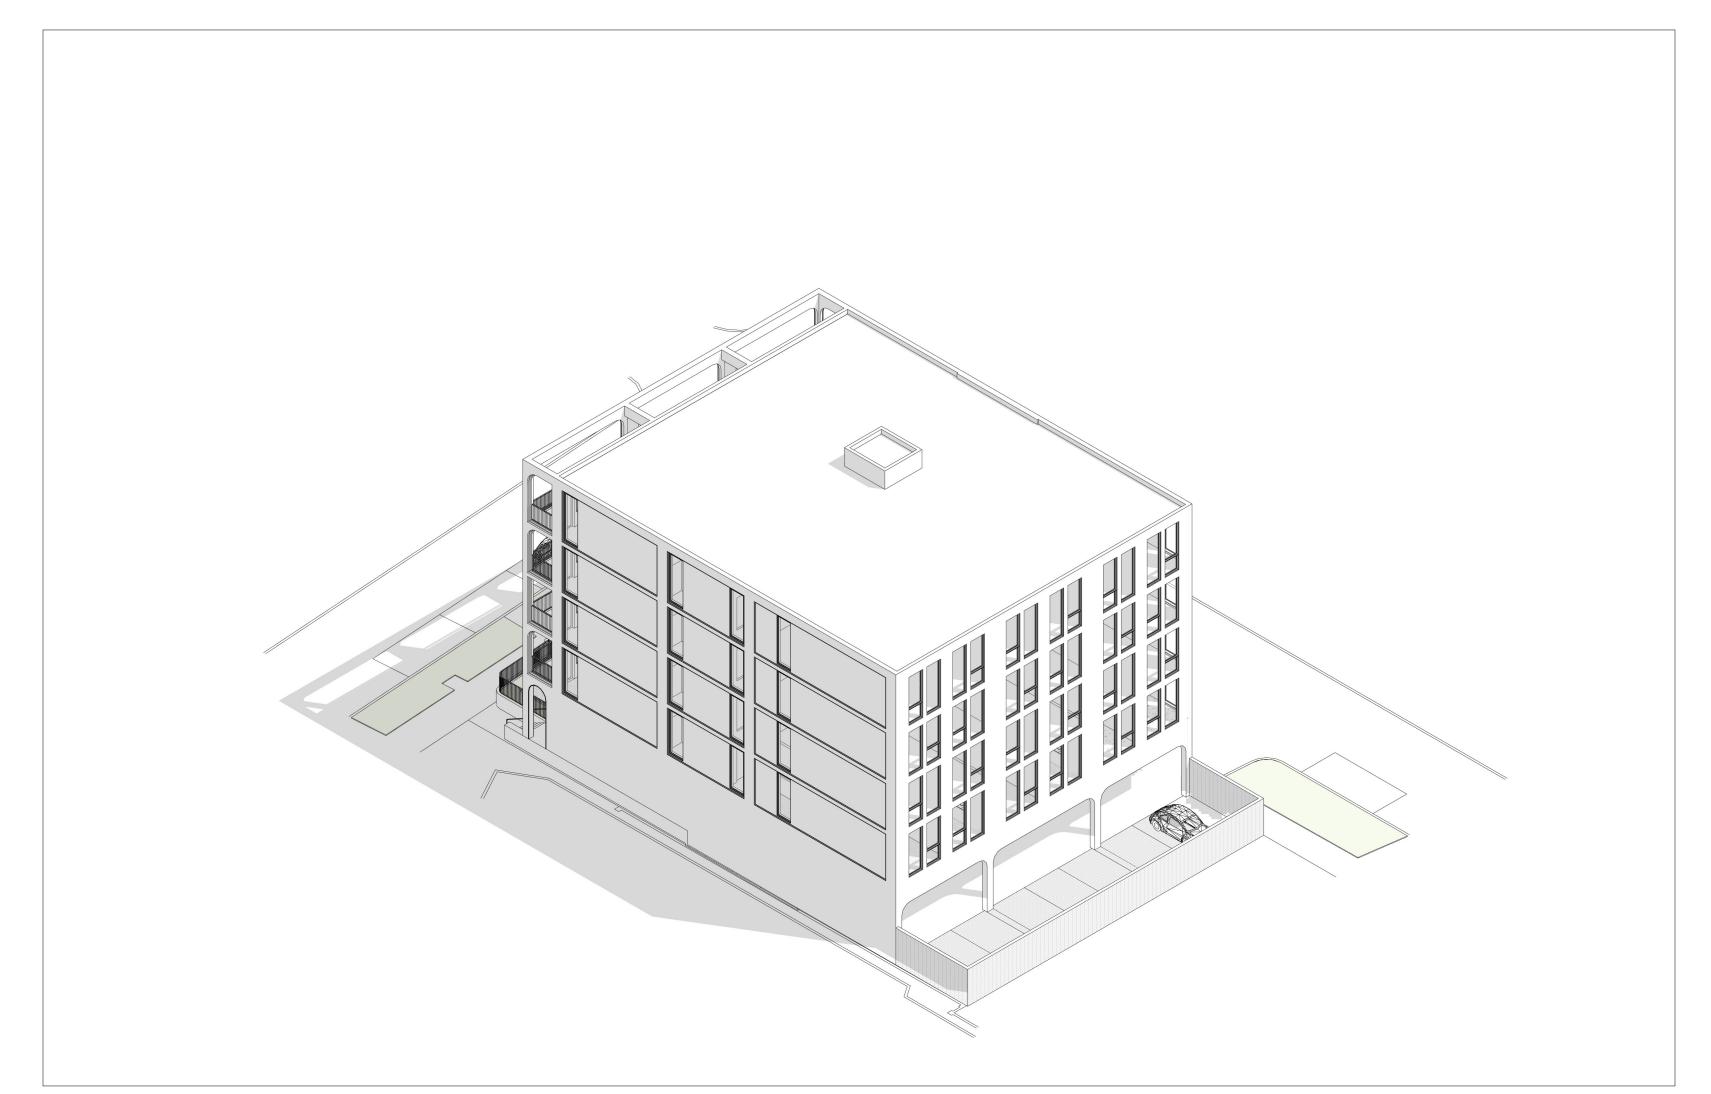

ISOMETRIC DRAWING - SOUTHWEST CORNER


## DRAWING LIST

SHEET NUMBER	SHEET NAME	
A-000	PROJECT INFORMATION	
A-001	ZONING ANALYSIS 1	
A-002	ZONING ANALYSIS 2	
A-003	ZONING ANALYSIS 3	
A-010	UNIT MATRIX AND GROSS AREA PLANS	
A-050	SITE PLAN	
A-051	SITE PLANTING PLAN	
A-052	SITE LIGHTING PLAN	
A-101	FLOOR PLAN - LEVEL 01	
A-103	FLOOR PLAN - LEVEL 03	
A-301	ELEVATION - NORTH	
A-302	ELEVATION - EAST	
A-303	ELEVATION - SOUTH	
A-304	ELEVATION - WEST	

## 3500 ST. CHARLES

PROJECT ADDRESS: 3500 SAINT CHARLES AVENUE NEW ORLEANS, LA 70115

FAROUKI FAROUKI LLC 1229 SAINT THOMAS, SUITE B NEW ORLEANS, LA 70130 T: 646.306.9820

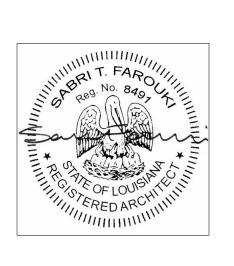

05/02/22 CPC SUBMISSION 03/07/22 SCHEMATIC DESIGN NO DATE ISSUE

SHEET TITLE: PROJECT INFORMATION

SHEET NUMBER:

PROJECT AN	ND SITE INFORMATION	
PROJECT OVERVIEW	THE PROJECT IS THE NEW CONSTRUCTION OF A 5-STORY HOTEL BUILDING ON A VACANT SITE.	
ADDRESS	3500 ST. CHARLES AVENUE NEW ORLEANS, LA 70130	
BOUNDING STREETS	ST. CHARLES AVENUE, ALINE STREET, PRYTANIA STREET, FOUCHER STREET	
BLOCK / LOT	BLOCK 377 / LOT C	
SITE AREA	9,503 SF	
ZONING DISTRICT	MU-1 (MEDIUM INTENSITY MIXED-USE DISTRICT)	70
OVERLAY ZONING DISTRICTS	- ST. CHARLES AVENUE USE RESTRICTION DISTRICT - CPC CHARACTER PRESERVATION CORRIDOR DESIGN OVERLAY DISTRICT	FOUCHER STREET
HISTORIC DISTRICT	NOHDLC, SAINT CHARLES AVENUE (FULL CONTROL)	
FLOOD ZONE	- MAJORITY: FLOOD ZONE X - PARTIAL: FLOOD ZONE AE	

	ST. CHARLES AVENUE	
	3500 ST. CHARLES AVENUE	
FOUCHERS	ALME STREET  PRYTANIA STREET	

BUILDING CODE INFORMATION		
GROSS FLOOR AREA	33,980 SF (INCLUDES STRUCTURE-OVER-PARKING)	
HEIGHT	60 FT	
STORIES	5 STORIES	
OCCUPANCY	RESIDENTIAL GROUP R-1 - HOTELS (TRANSIENT)	
CONSTRUCTION TYPE	FLOOR 1: I-A, FLOORS 2-5: V-A (PER IBC 2015 510.2 - HORIZONTAL SEPARATION ALLOWANCE)	
AUTO. SPRINKLER SYSTEM	YES (NFPA 13)	
EMERGENCY POWER	YES	
FIRE ALARM	YES	
SMOKE DETECTOR	YES	

## 3500 ST. **CHARLES**

PROJECT ADDRESS: 3500 SAINT CHARLES AVENUE NEW ORLEANS, LA 70115

ARCHITECT:

FAROUKI FAROUKI LLC 1229 SAINT THOMAS, SUITE B NEW ORLEANS, LA 70130 T: 646.306.9820

## 1 LOCATION PLAN

**REGULATIONS** 

## CPC CHARACTER PRESERVATION CORRIDOR DESIGN OVERLAY DISTRICT

NOTES REGARDING HDLC APPROVAL: 1. AT THE DECEMBER 8, 2021 COMMISSION MEETING, THE HDLC VOTED TO GRANT CONCEPTUAL APPROVAL OF THE MASSING AND SITE STRATEGY.

	THE DECEMBER	o, zozi commi	JOIOIN WILL I IINO	, THE HOLE VE	TED TO GIVAN	II CONCLI	IOALAIINOVALOI	THE WIASSING AIN	DUILLIN
Δ٦	ΓΤΗΕ ΙΔΝΙΙΔΒΎ 5	2022 COMMISS	ION MEETING T	THE HOLC VOT	FD TO GRANT	CONCEPTION	JAL APPROVAL OF T	HE OVERALL DESIG	3N
. /		, 2022 CONTINIOS	IOIN IVILLIIINO, I	TIL TIDLE VOI		CONCELLO			J14.

PROPOSED DESIGN

REGULATIONS	PROPOSED DESIGN		
ALLOWABLE HEIGHT FOR R, TYPE V-A, SPRINKLERED: 70 FT (IBC TABLE 504.3)	60 FT	(COMPLIES)	
ALLOWABLE STORIES FOR R-1, TYPE V-A, SPRINKLERED: 4 STORIES (IBC TABLE 504.4)	4 STORIES OF V-A CONSTRUCTION	(COMPLIES)	
ALLOWABLE AREA FOR R-1, TYPE V-A, SPRINKLERED: 36,000 SF (IBC TABLE 506.2)	6,963 SF	(COMPLIES)	

ST. CHARLES AVENUE USE RESTRICTION OVERLAY DISTRICT
THE FOLLOWING USES ARE PROHIBITED:

5. MOTOR VEHICLE SERVICE & REPAIR, MINOR OR MAJOR

**USE INFORMATION** 

PERMITTED USES

HOTEL/MOTEL

CAR WASH

4. GAS STATION

2. NEW DRIVE-THROUGH FACILITY

3. NEW RESTAURANT, FAST FOOD

NONE (COMPLIES) NONE (COMPLIES) NONE (COMPLIES) NONE (COMPLIES) NONE (COMPLIES)

PROPOSED USES

PRIMARY USE: HOTEL (COMPLIES)

ACCESSORY USES: BAR (COMPLIES)

RESTAURANT, SPECIALTY (COMPLIES)

3. STREET FACADES SHALL BE ARTICULATED WITH NO BLANK WALLS

18.14.B ADDITIONAL DESIGN REVIEW APPROVAL STANDARDS:

HISTORIC DISTRICTS THAT RETAIN UNIQUE CHARACTER.

1. DESIGN SHALL BE COMPATIBLE IN SCALE, MATERIALS, STREET LEVEL

USES, AND SPATIAL RELATIONSHIPS WITH EXISTING DEVELOPMENT IN

2. DESIGN SHALL PRESERVE THE RHYTHM OF THE STREET, DOORWAYS,

4. ALL SIDES AND AREA OF STRUCTURE VISIBLE TO THE PUBLIC SHALL BE TREATED WITH MATERIALS, FINISHES AND ARCHITECTURAL DETAILS APPROPRIATE TO PRIMARY STREET-FACING FACADES.

COMPLIES - THE DESIGN IS COMPATIBLE IN SCALE, MATERIALS, STREET LEVEL USES, AND SPATIAL RELATIONSHIPS WITH EXISTING DEVELOPMENT.

COMPLIES - THE DESIGN PRESERVES THE RHYTHM OF THE STREET, AND WINDOWS, ALTHOUGH MINOR VARIATIONS TO ADD INTEREST ARE DOORWAYS, AND WINDOWS.

> COMPLIES - THE DESIGN HAS ARTICULATED STREET FACADES WITH NO BLANK WALLS ALONG THE STREET. COMPLIES - ALL SIDES OF STRUCTURE VISIBLE TO THE PUBLIC ARE

TREATED WITH APPROPRIATE STREET-FACING MATERIALS AND DETAILS

FIRE-RESISTANCE RATING REQUIREMENTS FOR BUILDING ELEMENTS (IBC TABLE 601)				
BUILDING ELEMENT				
PRIMARY STRUCTURAL FRAME				

ROOF CONSTRUCTION

**BUILDING ELEMENT** 

1" = 20'-0" 4 SIGNAGE PLAN

CONSTRUCTION TYPE ANALYSIS

SUILDING ELEMENT	TYPE I-A	TYPE V-A
RIMARY STRUCTURAL FRAME	3 HR	1 HR
EARING WALLS EXTERIOR INTERIOR	3 HR 3 HR	1 HR 1 HR
XTERIOR NONBEARING WALLS AND PARTITIONS (GROUP R, < 5 FT)	1 HR	1 HR
NTERIOR NONBEARING WALLS AND PARTITIONS	0 HR	0 HR
LOOR CONSTRUCTION	2 HR (3 HR BETWEEN 1-A AND V-A)	1 HR

1 1/2 HR

1 HR

## SITE DESIGN STANDARDS

REGULATIONS

**BULK REGULATIONS** 

MINIMUM LOT AREA:	NON-RES.: NONE	9,503 SF	(COMPLIES)	
MAX. BUILDING HEIGHT:	NON-RES.: 60 FT / 5 STORIES	60 FT / 5 STORIES	(COMPLIES)	
MIN. PERMEABLE OPEN SPACE:	20% OF THE LOT AREA	2,005 SF / 9,503 SF = 21%	(COMPLIES)	
MINIMUM YARD REQUIREMENTS				
FRONT YARD	NONE	18'-4"	(COMPLIES)	

PROPOSED DESIGN

FRONT YARD	NONE	18'-4"	(COMPLIES)
INTERIOR SIDE YARD	MIXED-USE: NONE (UNLESS ABUTTING RES. DISTRICT)	0'-0"	(COMPLIES)
CORNER SIDE YARD	NONE	0'-0"	(COMPLIES)
REAR YARD	MIXED-USE: NONE (UNLESS ABUTTING RES. DISTRICT)	18'-0"	(COMPLIES)

## <u>P.O.S.</u> 210 SF

1/16" = 1'-0"

PRIMARY STRUCTURAL FRAME	PROTECTED STRUCTURAL STEEL
BEARING WALLS	
EXTERIOR	COLD-FORMED STEEL AND GWB
INTERIOR	COLD-FORMED STEEL AND GWB, CMU CORE WAL
EXTERIOR NONBEARING WALLS AND PARTITIONS (GROUP R, < 5 FT)	COLD-FORMED STEEL AND GWB
INTERIOR NONBEARING WALLS AND PARTITIONS	COLD-FORMED STEEL AND GWB
FLOOR CONSTRUCTION	COMPOSITE (CONCRETE AND METAL DECK)
ROOF CONSTRUCTION	METAL DECK

BUILDING ELEMENT DESCRIPTION

## OFF-STREET PARKING AND LOADING

## OFF-STREET VEHICLE AND BICYCLE PARKING REQUIREMENTS

REQUIREMENTS		PROPOSED DESIGN	
VEHICLE SPACES	HOTEL: 1 PER 2 GUEST BEDROOMS (40 BEDROOMS / 2 = 20 SPACES) 17 AFTER EXEMPTION (SEE BELOW)	12 OFF-STREET SPACES 7 ON-STREET SPACES = 19 SPACES TOTAL (SEE BELOW)	(COMPLIES)
SHORT-TERM BICYCLE SPACES	HOTEL: 1 PER 5 ROOMS (40 ROOMS / 5 = 8 SPACES)	8 SPACES	(COMPLIES)
OFF-STREET LOADING	10,000 - 100,000 GSF: 1 SPACE	1 SPACES	(COMPLIES)

## CALCULATION OF PARKING EXEMPTION (22.5.A.6)

"THE FIRST FIVE-THOUSAND (5,000) SQUARE FEET IN GROSS FLOOR AREA FOR COMMERCIAL USES IN THE HU-B1, HU-MU, AND MU-1 DISTRICTS ARE EXEMPT FROM THE VEHICLE PARKING REQUIREMENTS OF TABLE 22-1."

40 GUEST BEDROOMS / 2 = 20 SPACES (REQUIRED PRIOR TO EXEMPTION)

5,000 SF (EXEMPT) / 33,980 (GSF) = 15% (EXEMPT)

85% X 20 SPACES = 17 SPACES (REQUIRED AFTER EXEMPTION)

ON-STREET SPACES TO COUNT TOWARD PARKING REQUIREMENTS

"IN THE HU-MU, C1, C2, AND MU-1 DISTRICTS, ON-STREET PARKING SPACES LOCATED ALONG THE FRONT OR SIDE PROPERTY LINE MAY BE COUNTED TOWARD REQUIRED OFF-STREET PARKING SPACES FOR COMMERCIAL USES."

## 2 PERMEABLE OPEN SPACE (P.O.S.)

3 PARKING PLAN

OFF 5 OFF 6 OFF 7 LOADING (8) BICYCLE SPACES —

# HOTEL HOTEL

HOTEL NAME AND BUILDING ADDRESS PAINTED ON GLASS -

## APPLICABLE CODES


INTERNATIONAL BUILDING CODE 2015 INTERNATIONAL MECHANICAL CODE 2015 **INTERNATIONAL PLUMBING CODE 2012** NATIONAL ELECTRICAL CODE 2014

NFPA LIFE SAFETY CODE 2015

1/4" = 1'-0"

LOUISIANA ADMINISTRATIVE CODE TITLE 51 (PUBLIC HEALTH - SANITARY CODE)

D.O.J. ADA STANDARDS FOR ACCESSIBLE DESIGN 2010

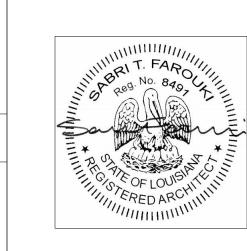



05/02/22 CPC SUBMISSION 03/07/22 SCHEMATIC DESIGN NO DATE ISSUE

SHEET TITLE: **ZONING ANALYSIS 1** 

**SHEET NUMBER:** 

As indicated ARCH E1 (30" X 42")

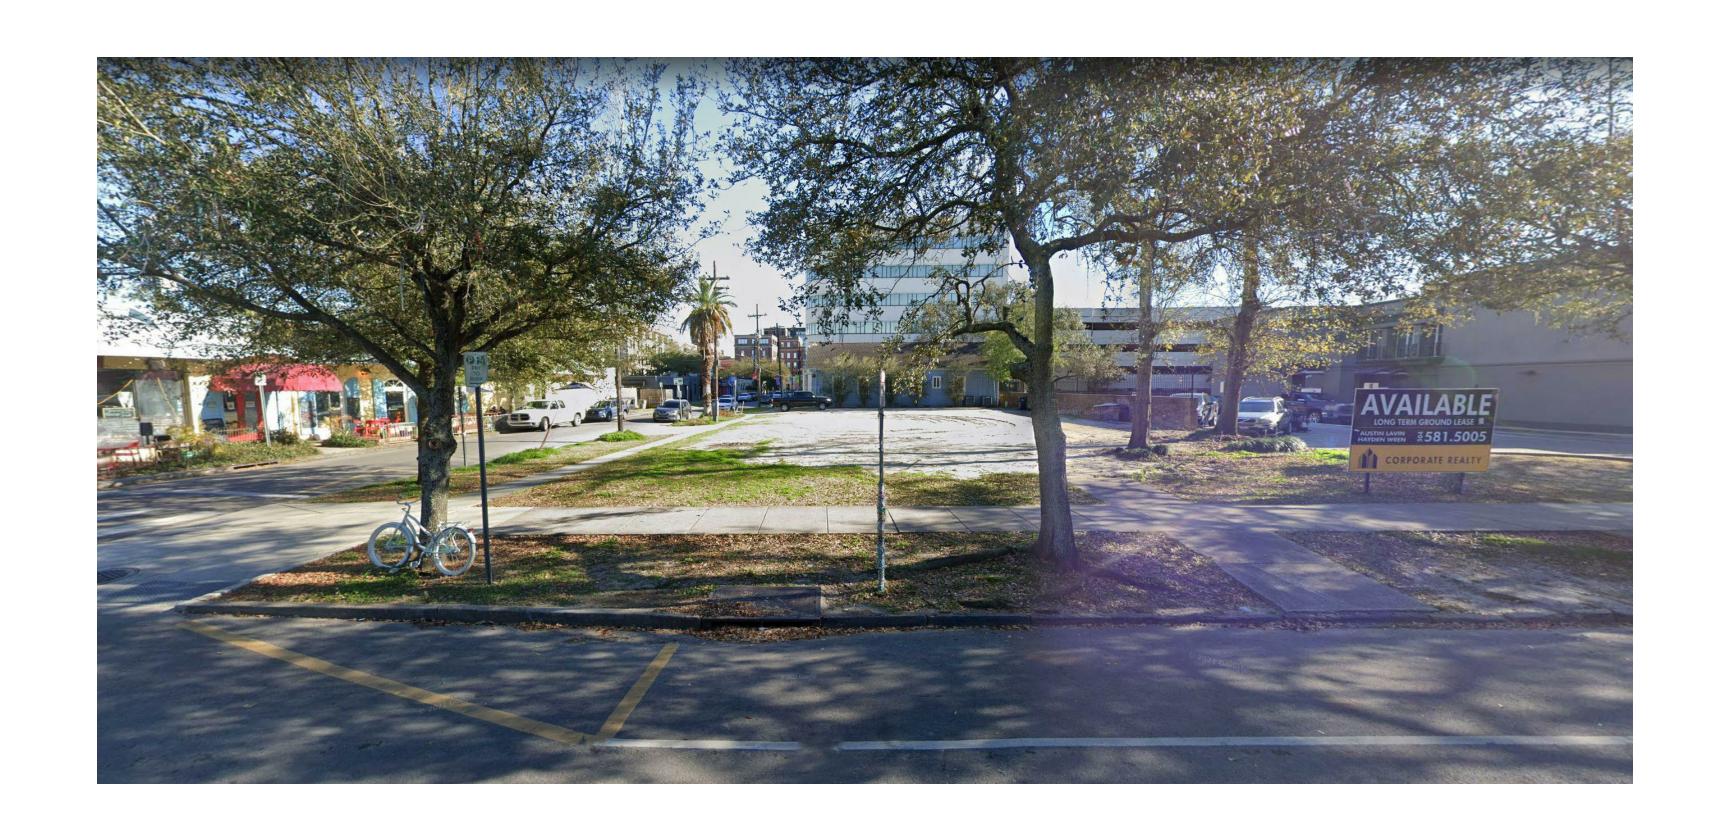

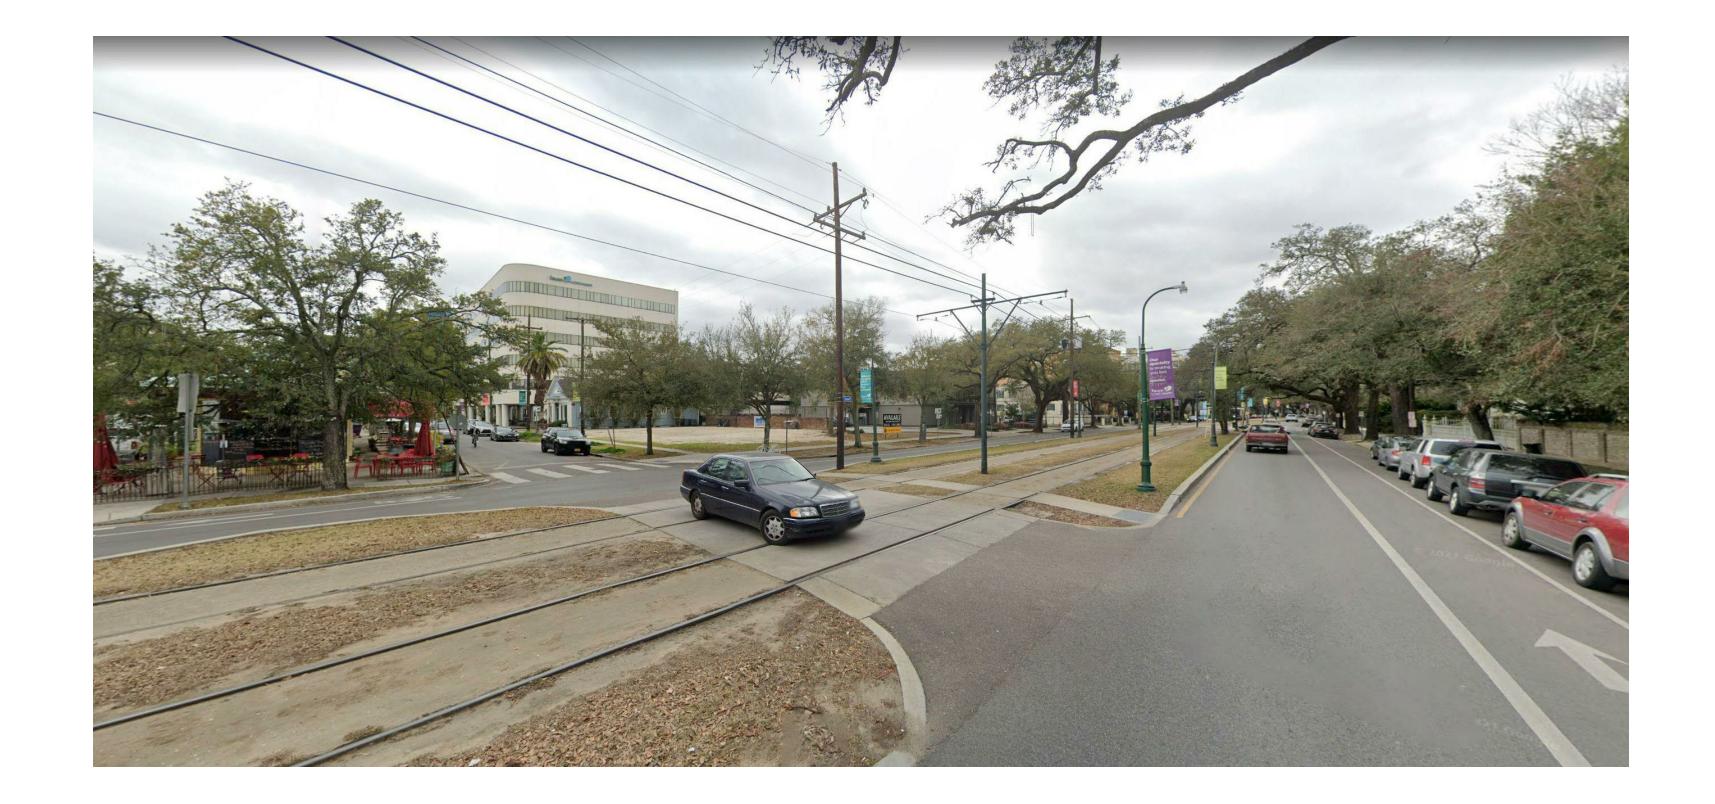


## 3500 ST. CHARLES

3500 SAINT CHARLES AVE NEW ORLEANS, LA 70115

ARCHITECT:

FAROUKI FAROUKI LLC
1229 SAINT THOMAS, SUITE B
NEW ORLEANS, LA 70130
T: 646.306.9820

## EXISTING SITE PHOTO (FROM ST. CHARLES AVE.)

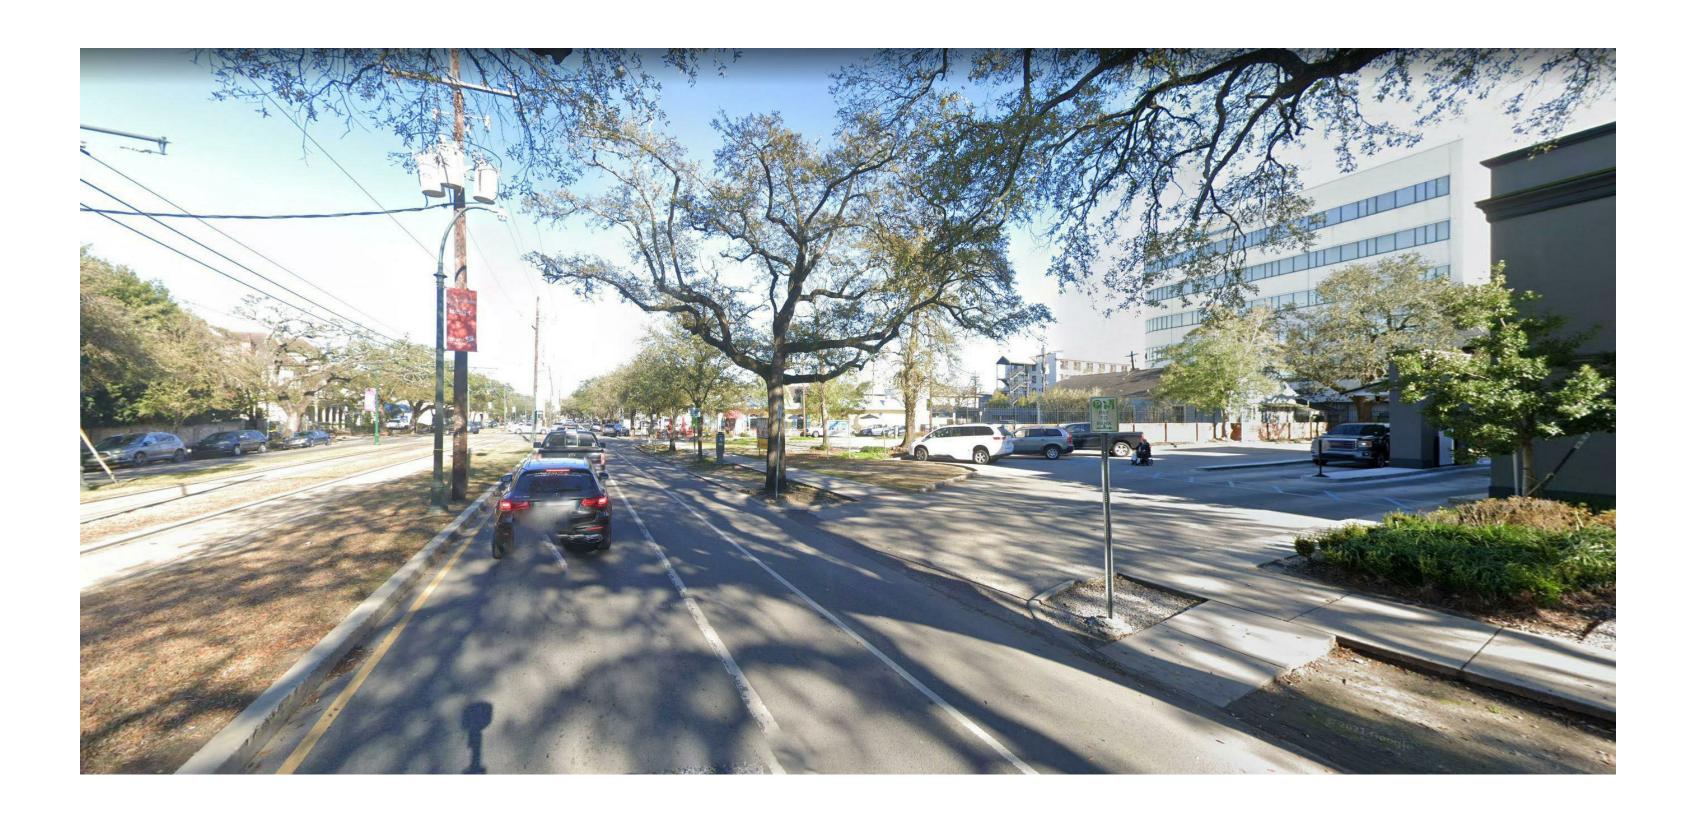


EXISTING SITE PHOTO (FROM ST. CHARLES AVE. AND ALINE ST.)



EXISTING SITE PHOTO (FROM ST. CHARLES AVE. AND FOUCHER ST.)

EXISTING SITE PHOTO (FROM ALINE ST. AND PRYTANIA ST.)

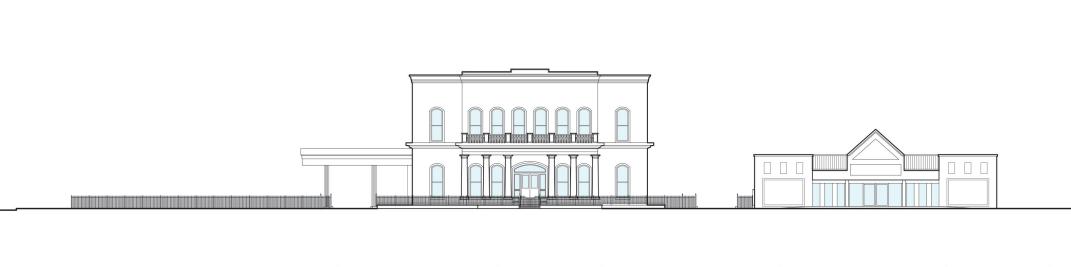

3412 ST. CHARLES AVE. (IBERIABANK)

3430 ST. CHARLES AVE. (DISCOUNT ZONE)




3500 ST. CHARLES AVE.

3540 ST. CHARLES AVE. (CAPITAL ONE BANK)



3626 ST. CHARLES AVE. (HAMPTON INN)

3636 ST. CHARLES AVE. (ST. CHARLES INN)

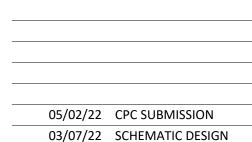

SHEET TITLE:
ZONING ANALYSIS 2

NO DATE ISSUE

SHEET NUMBER:

A-002

ISSUE DATE: PROJ NUMBER: 059

059





## 3500 ST. **CHARLES**


3500 SAINT CHARLES AVENUE NEW ORLEANS, LA 70115

1229 SAINT THOMAS, SUITE B NEW ORLEANS, LA 70130 T: 646.306.9820

HDLC ARC APPROVED RENDERING (FROM ST. CHARLES AVE. AND ALINE ST.)



HDLC ARC APPROVED RENDERING (FROM ST. CHARLES AVE. AND FOUCHER ST.)

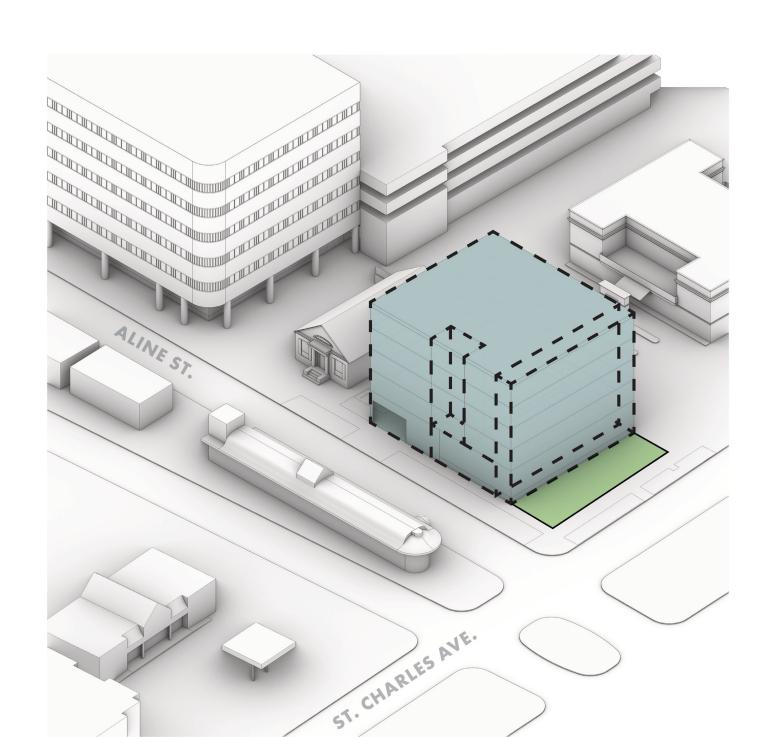

MASSING STEP #1:

MASSING STEP #2:

CREATE A GALLERY ON ST. CHARLES AVE. TO BREAK DOWN THE MASS AND CREATE DEPTH and layering on the front facade.


MASSING STEP #3:


CREATE A GALLERY ON ALINE ST. TO FURTHER BREAK DOWN THE MASS AND CREATE DEPTH AND LAYERING ON THE SIDE FACADE.





05/02/22 CPC SUBMISSION


**ZONING ANALYSIS 3** 

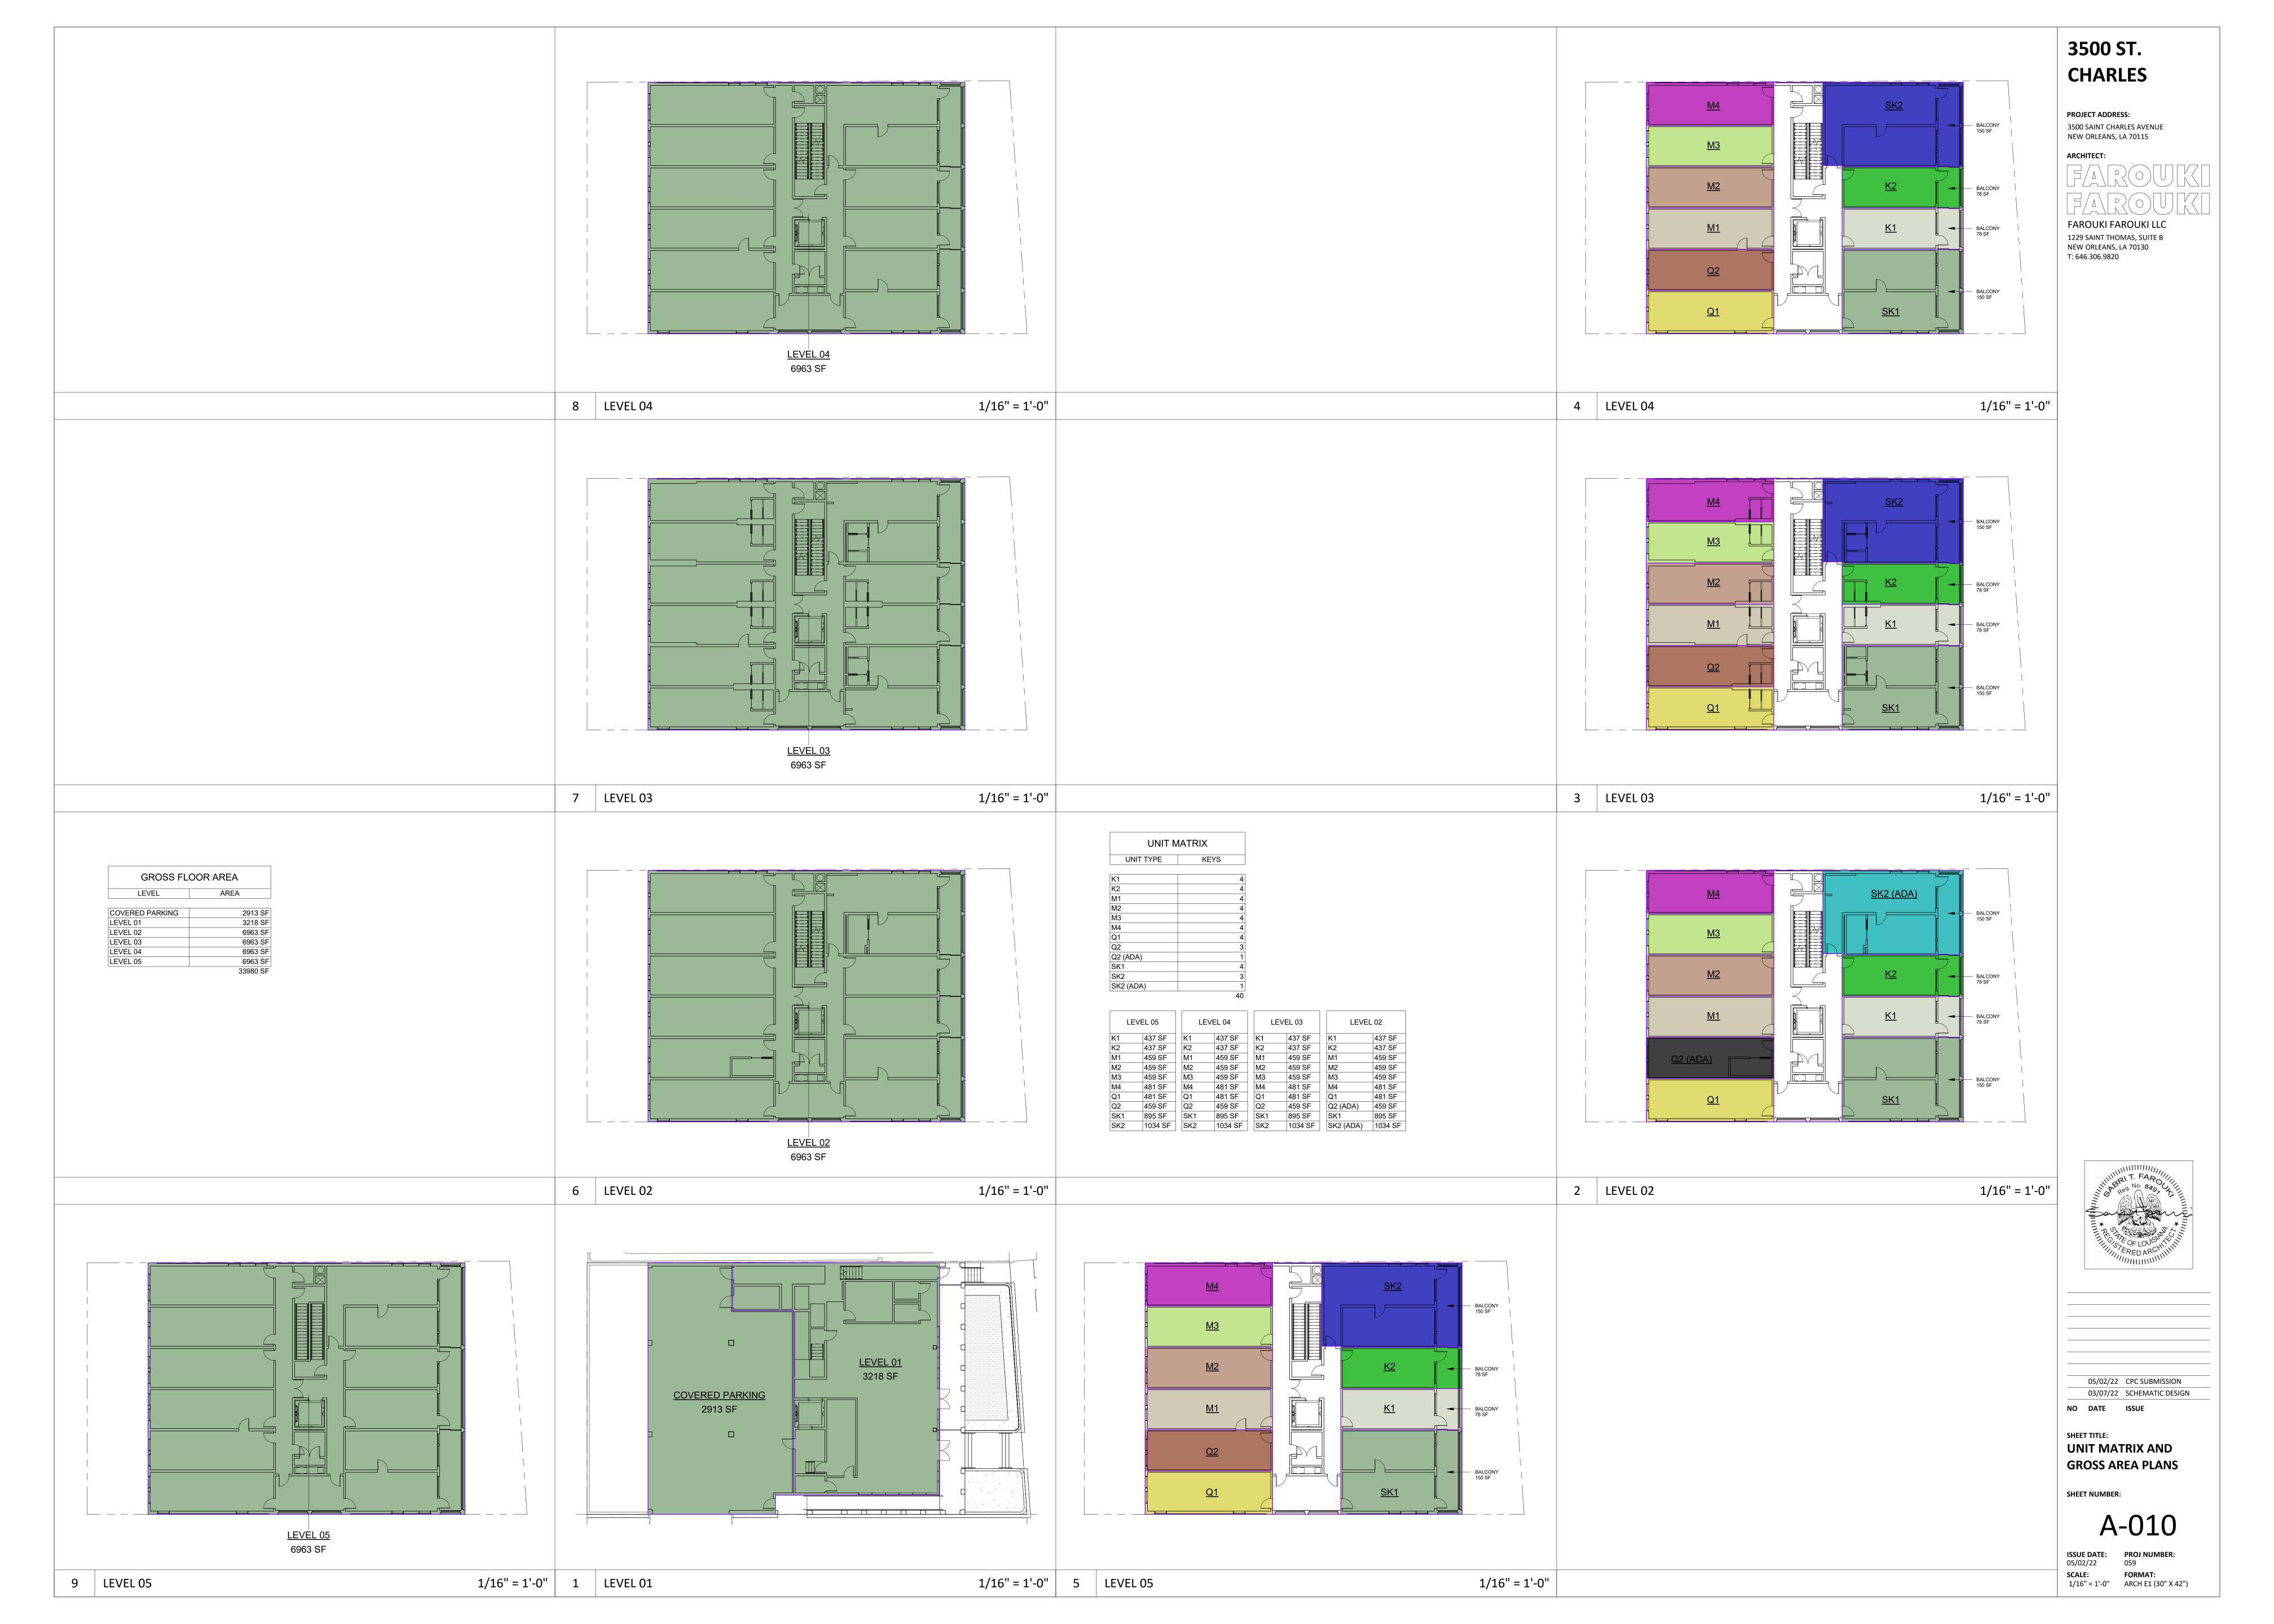


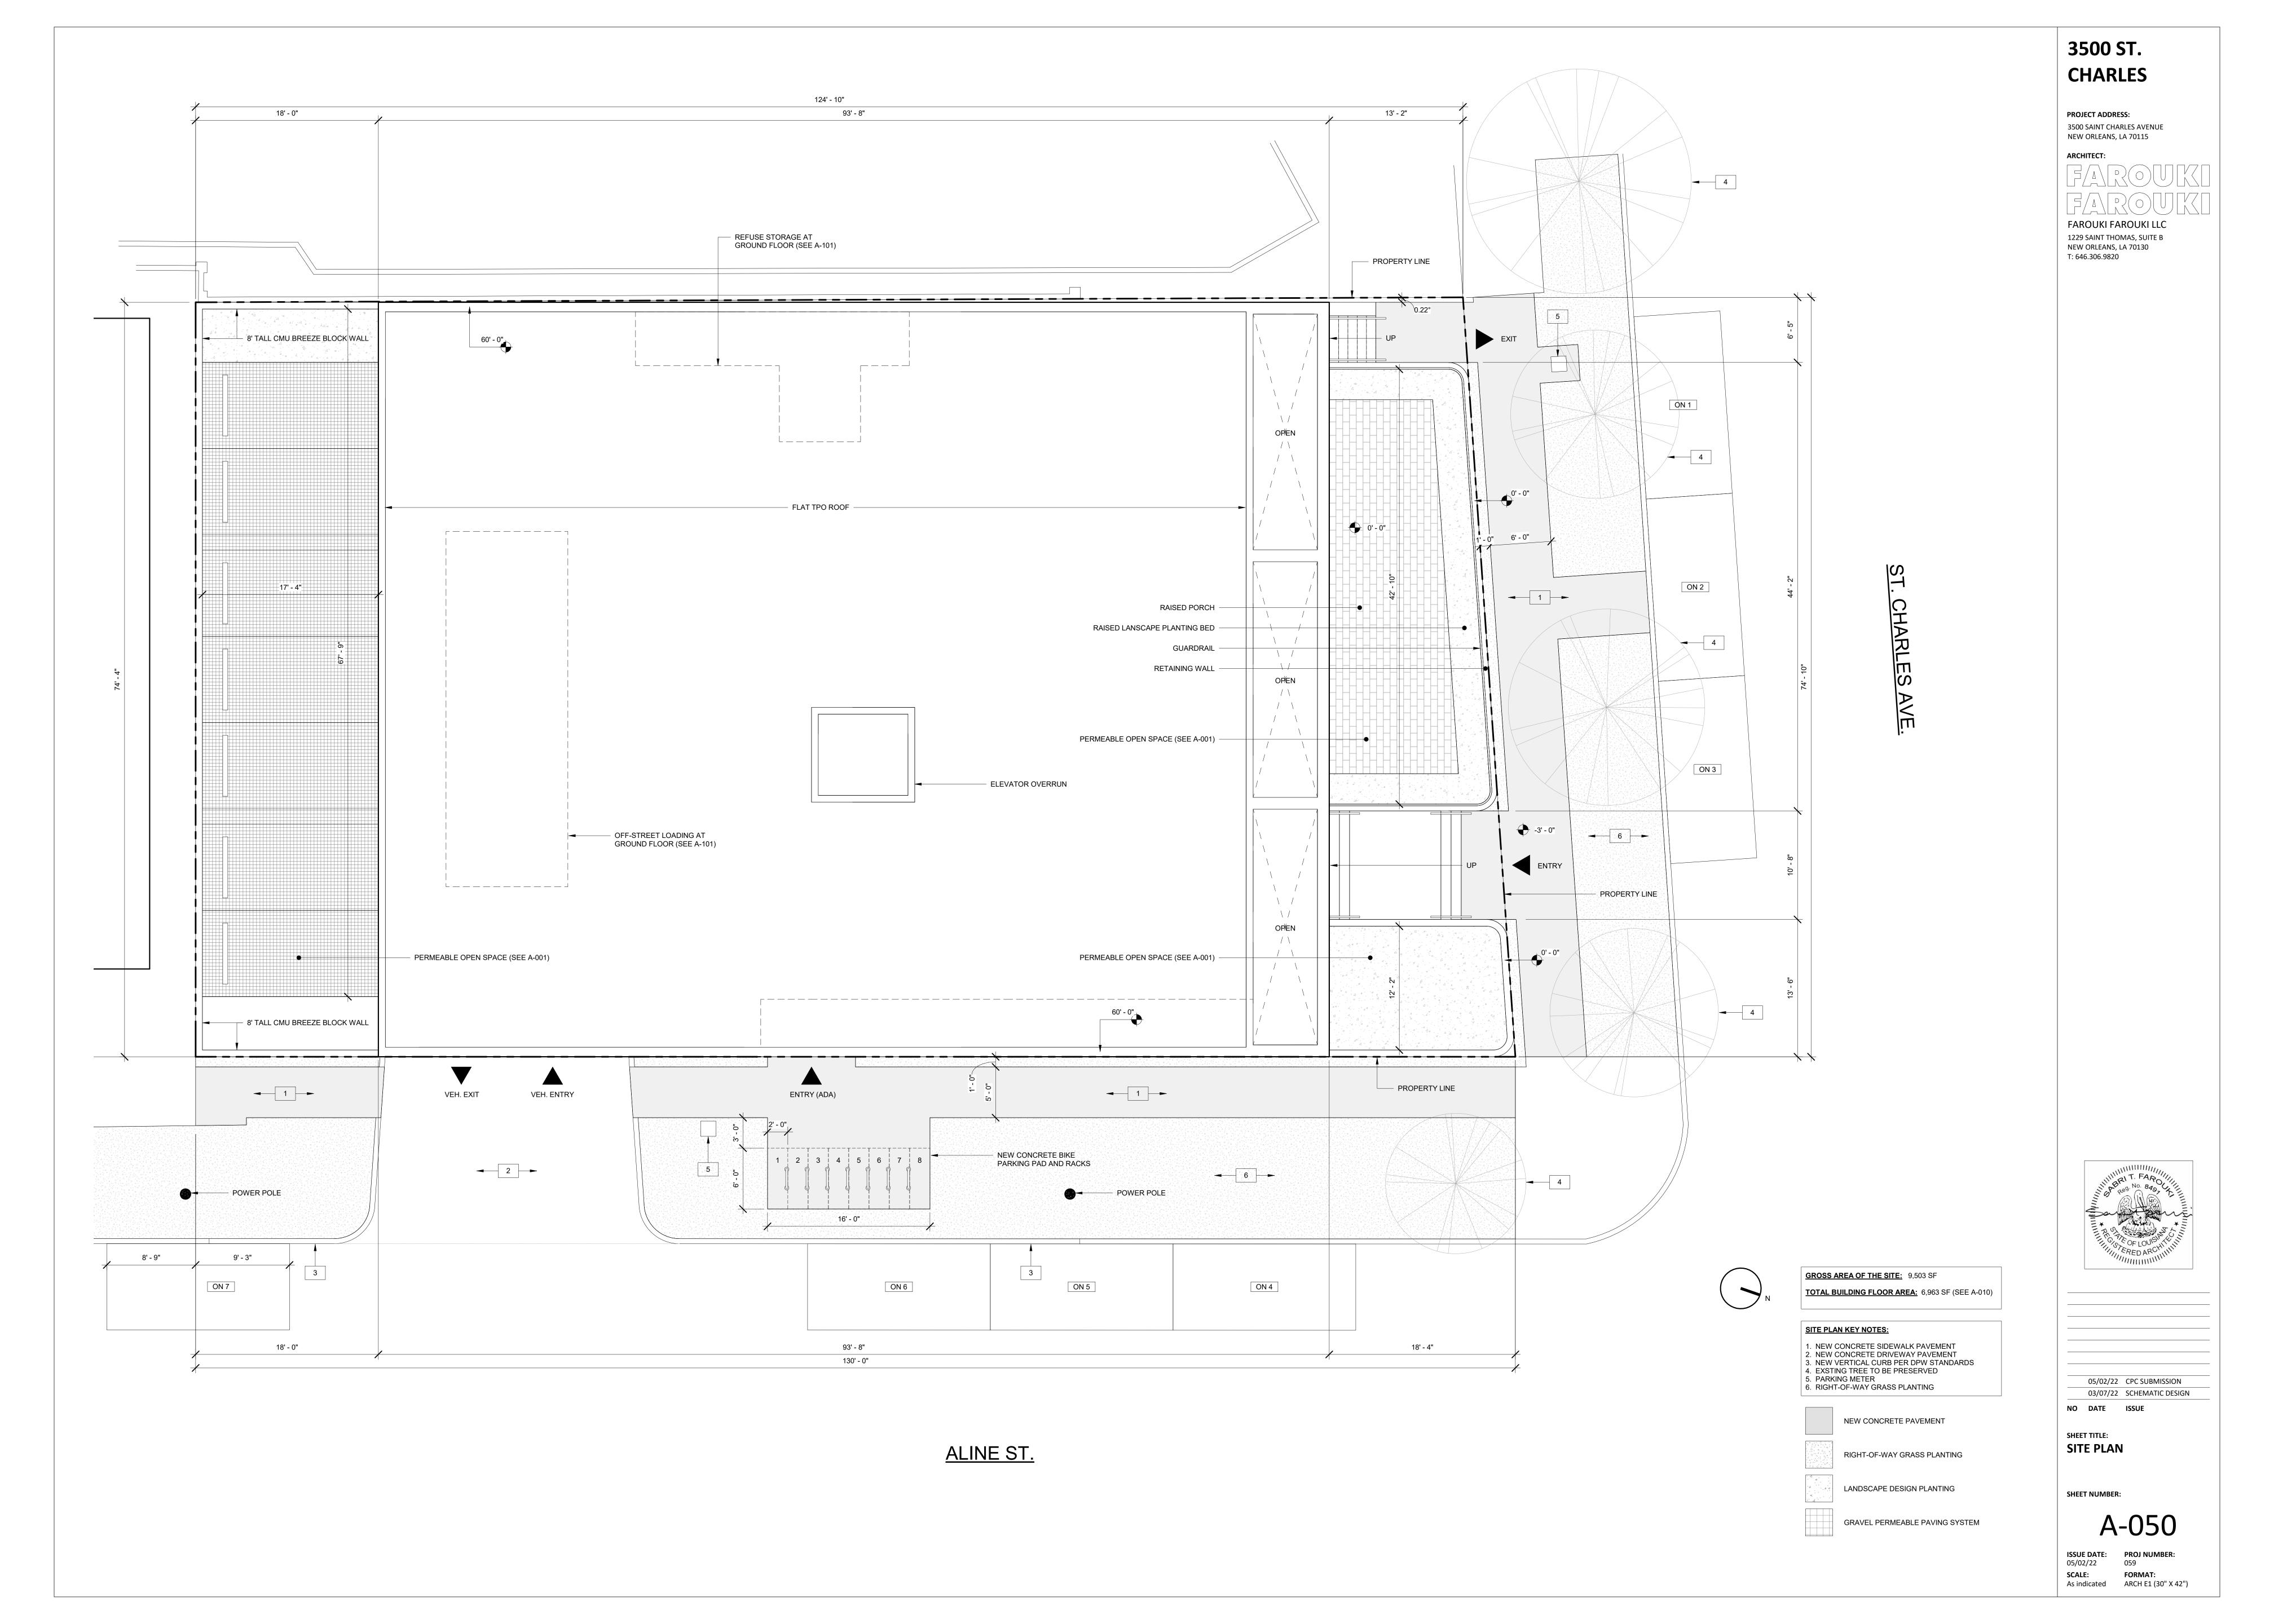

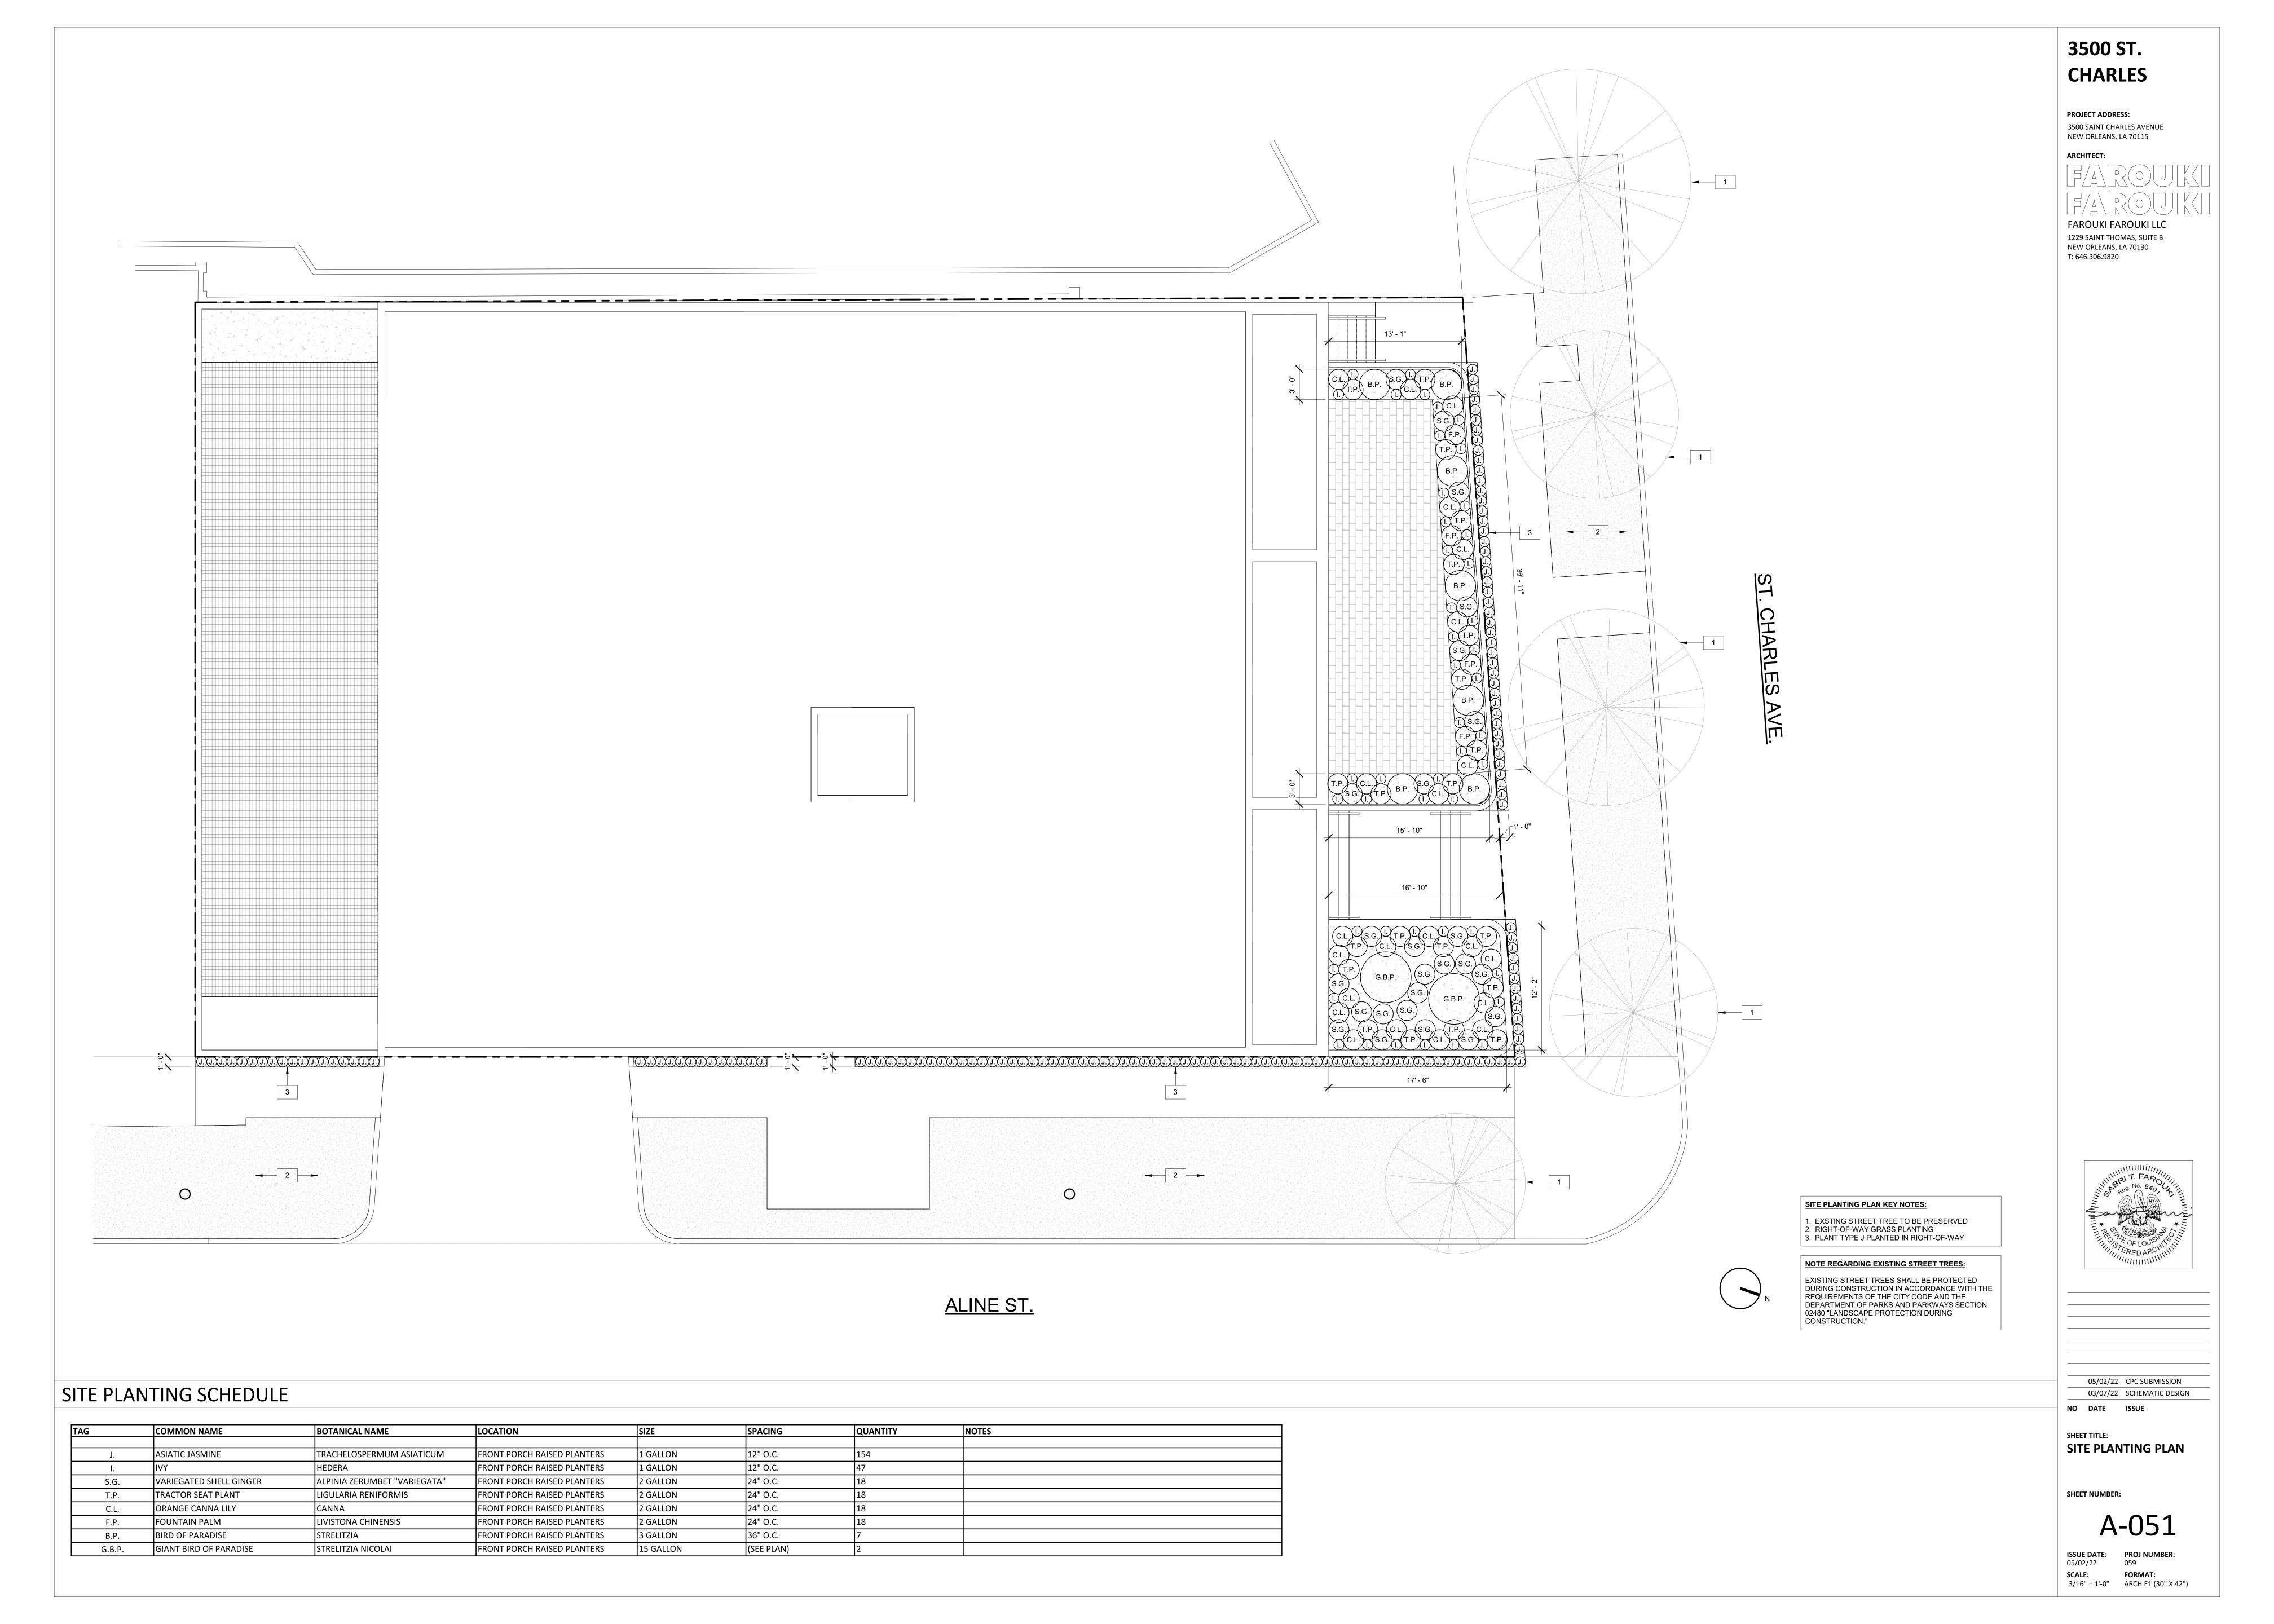

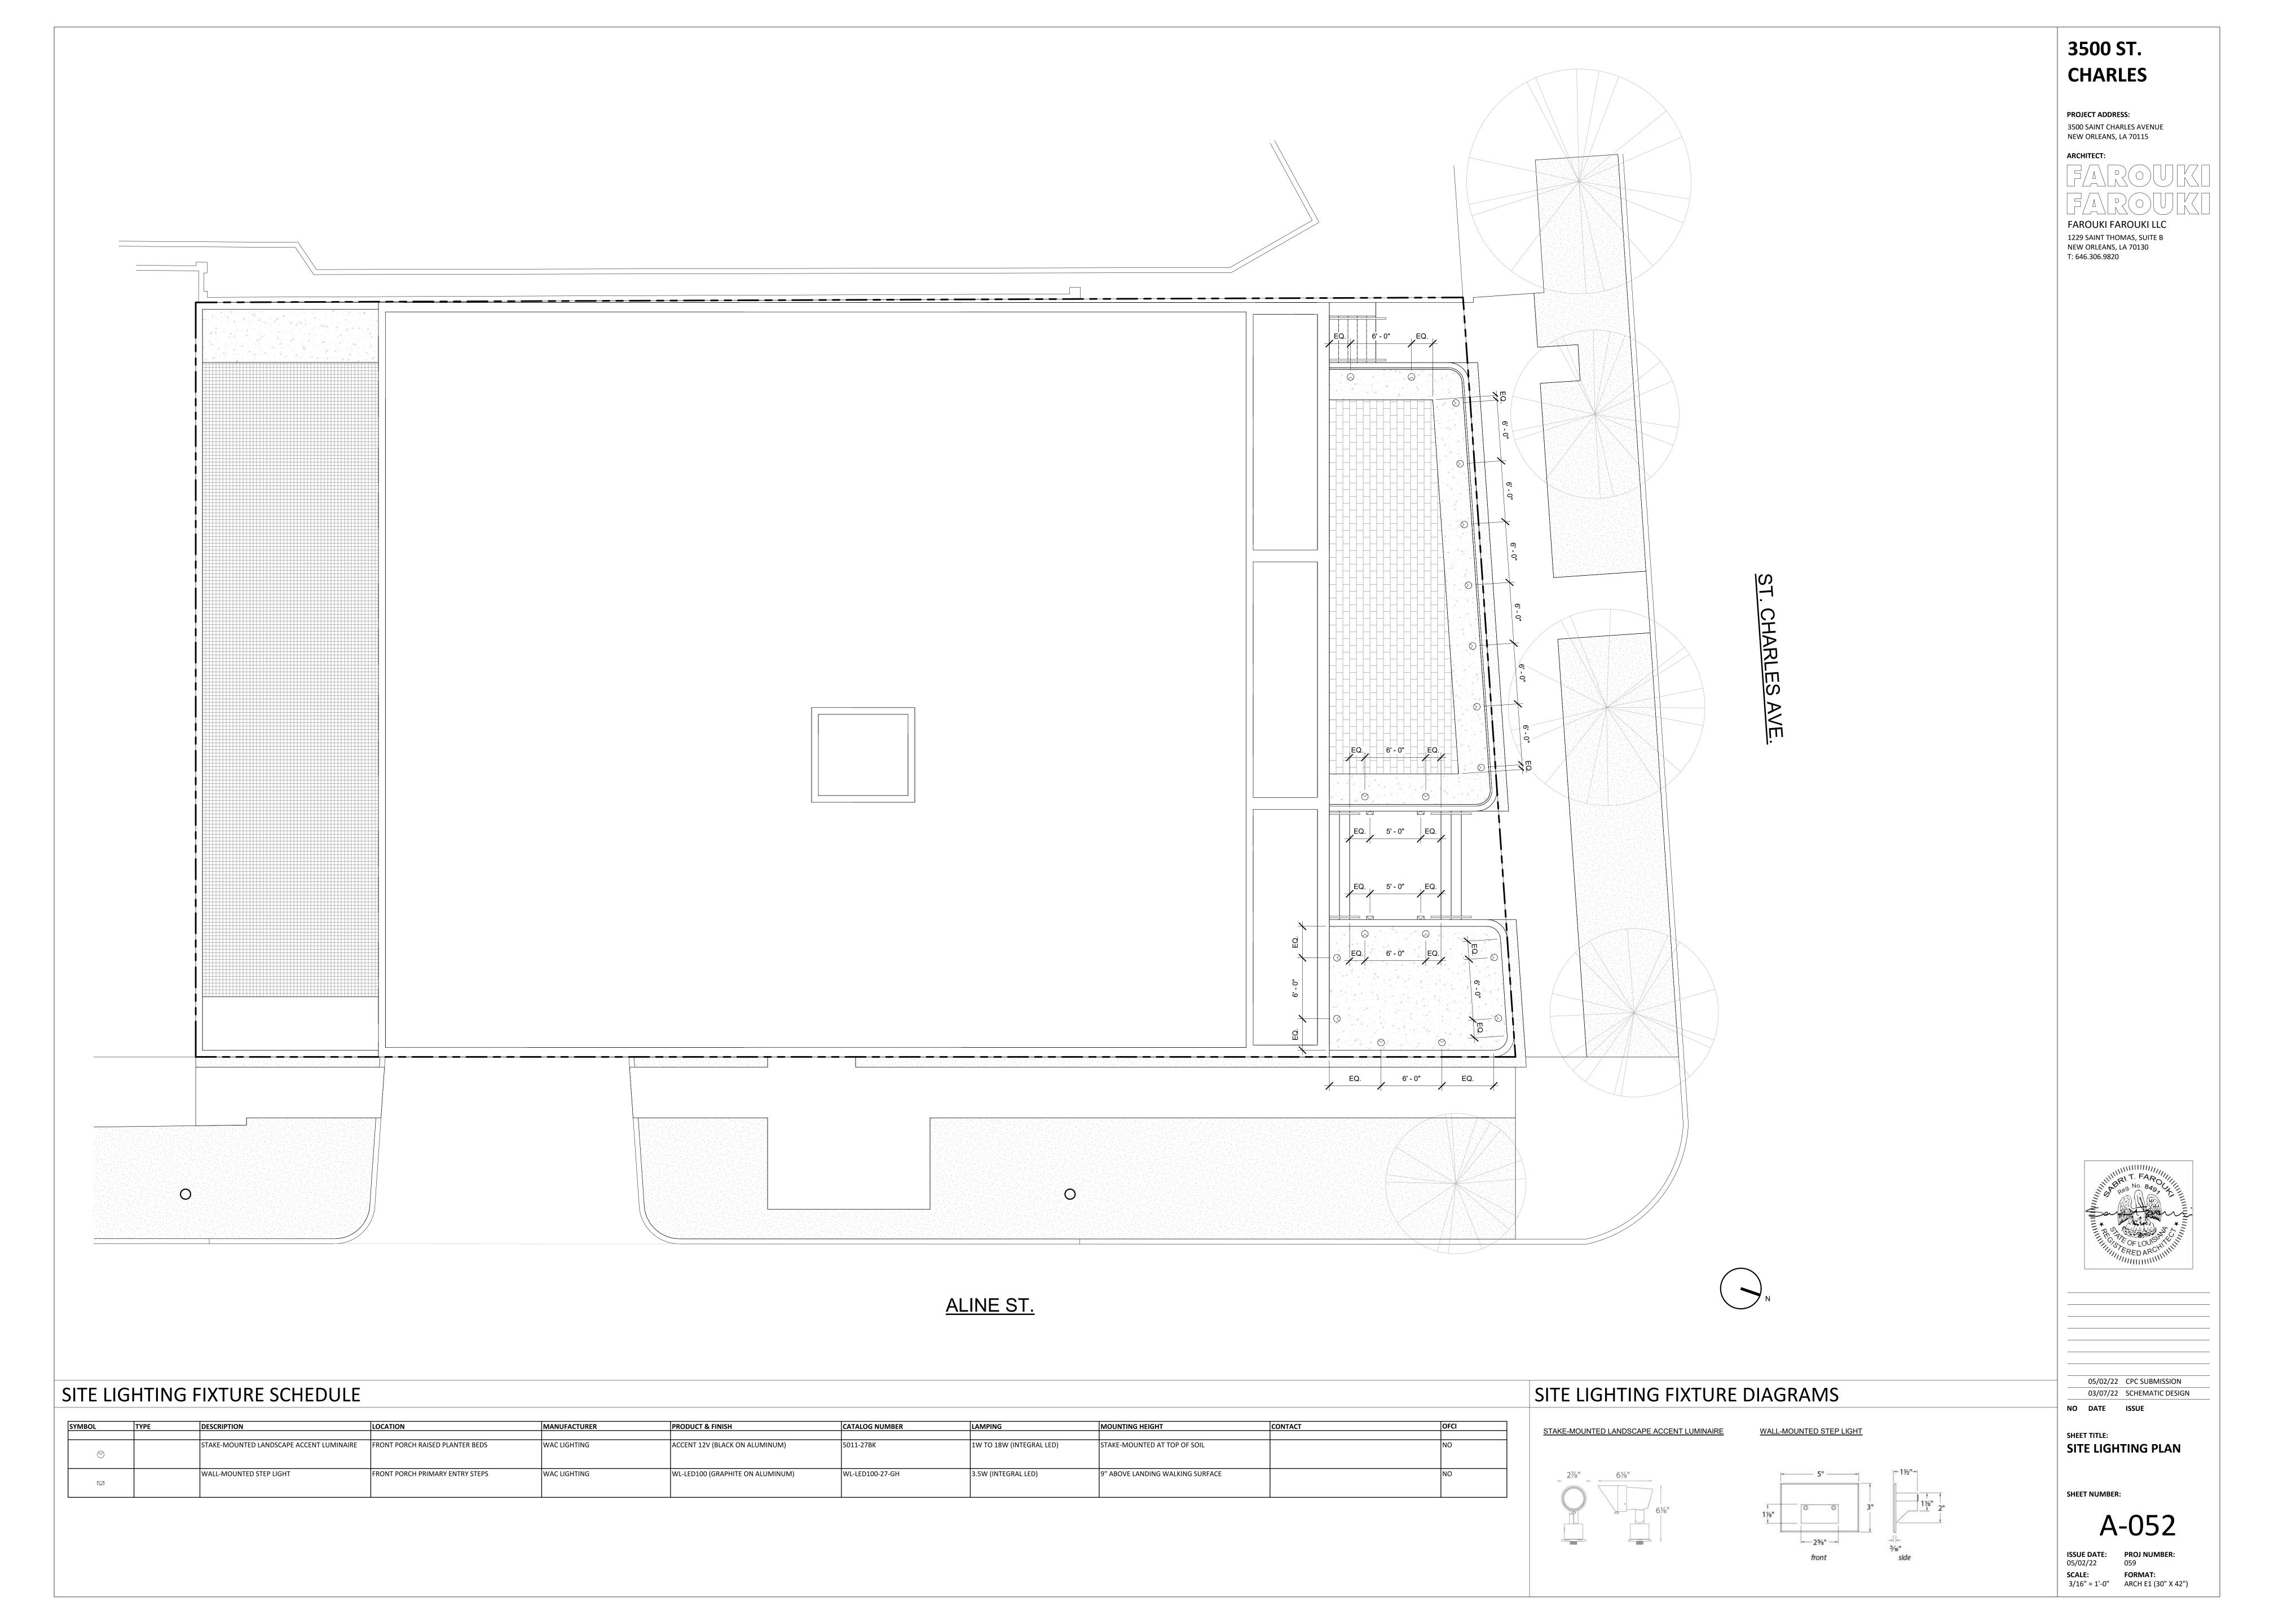

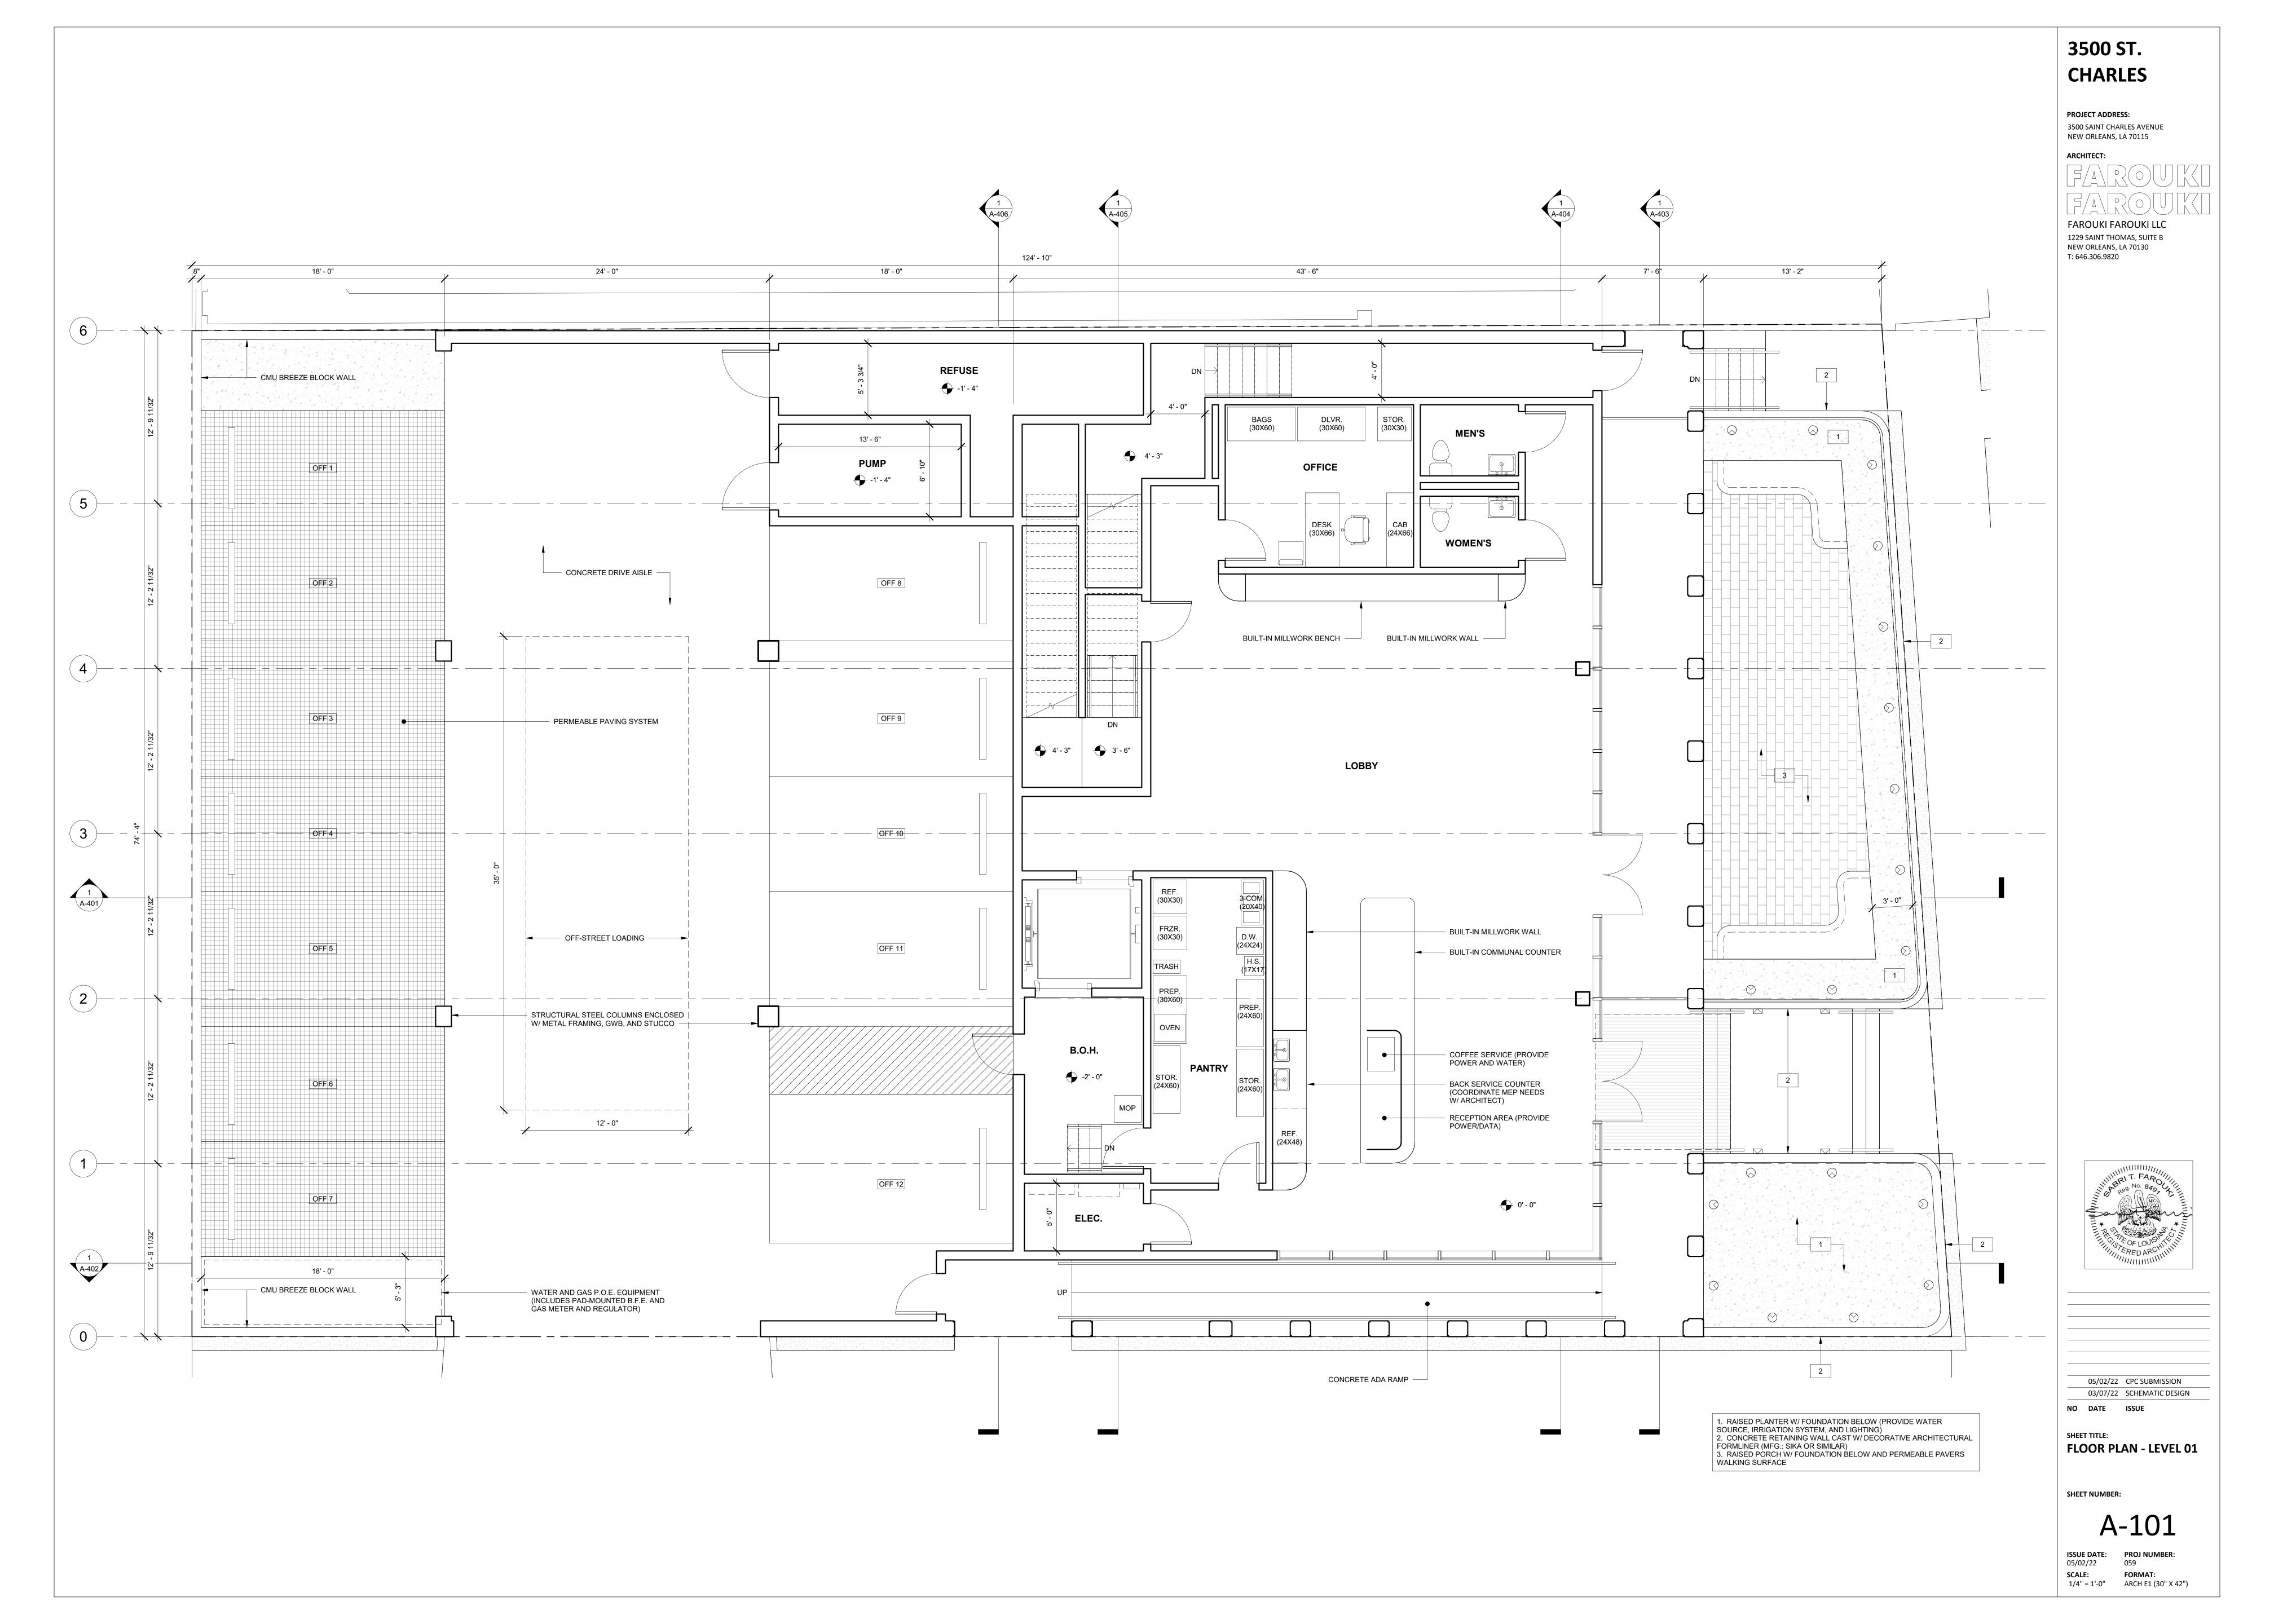

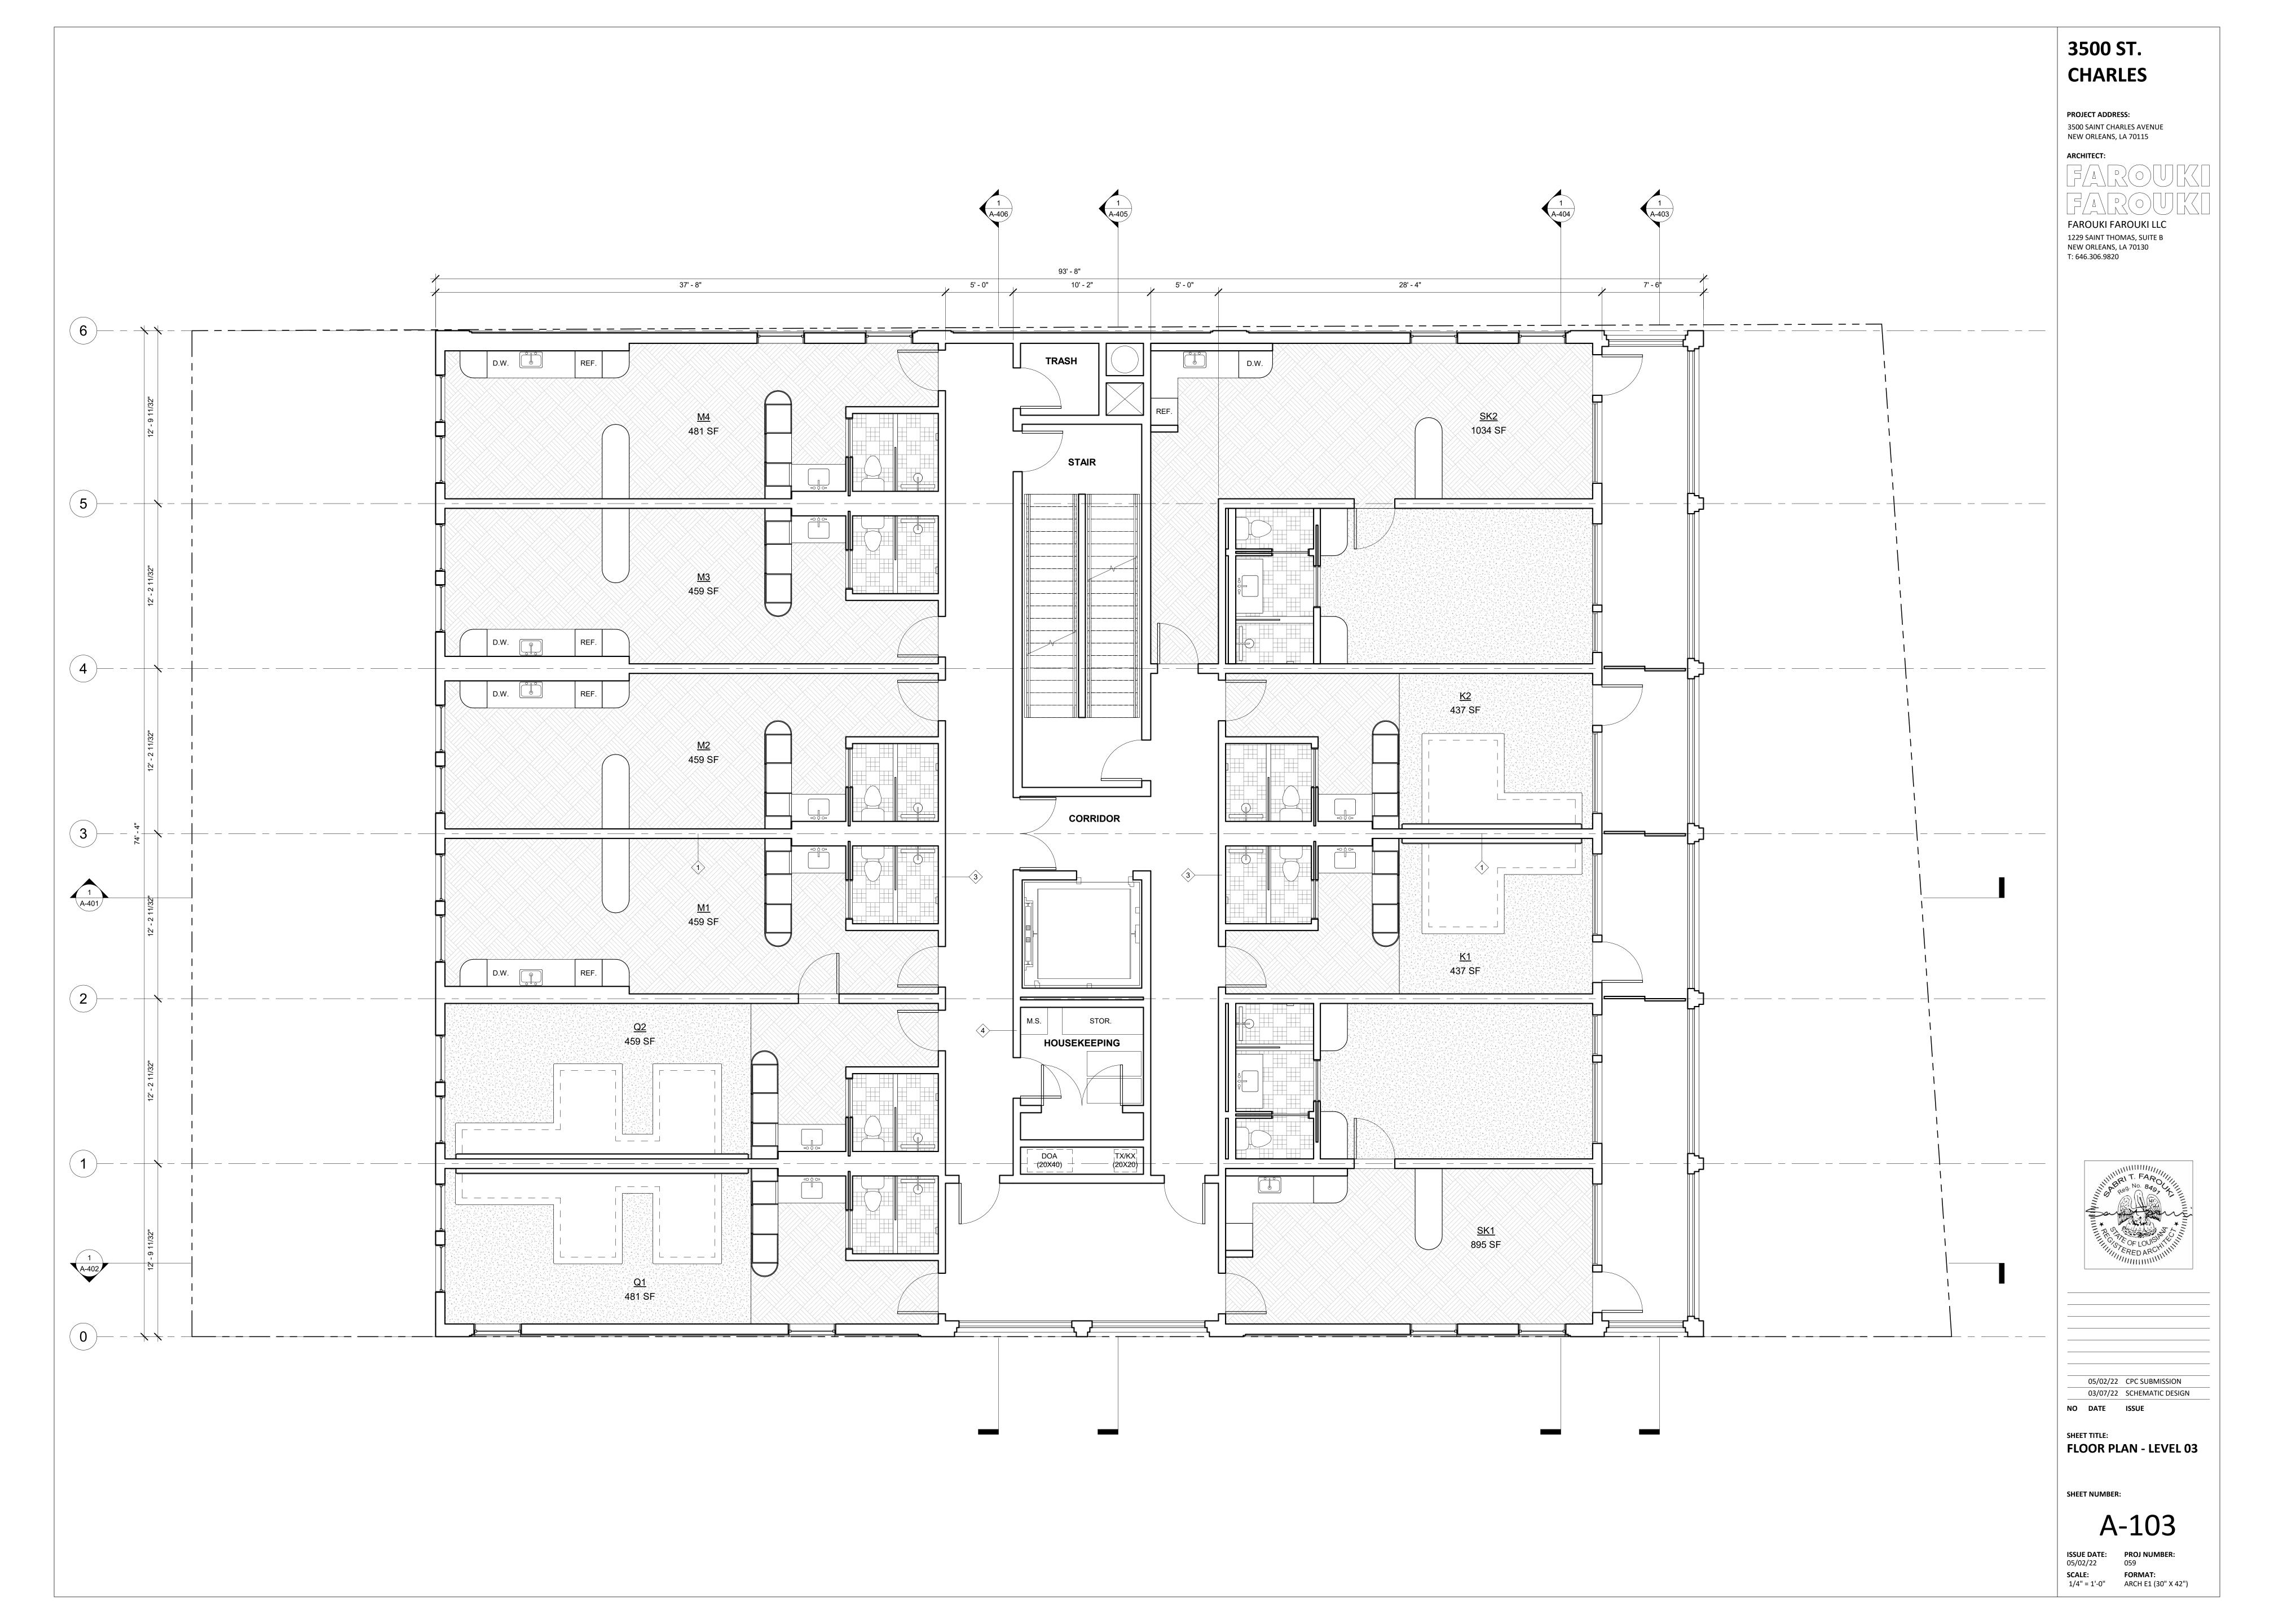

- 1. THE DESIGN IS COMPATIBLE IN SCALE, MATERIALS, STREET LEVEL USES, AND SPATIAL RELATIONSHIPS WITH EXISTING DEVELOPMENT.
- THE DESIGN PRESERVES THE RHYTHM OF THE STREET, DOORWAYS, AND WINDOWS.
   THE DESIGN HAS ARTICULATED STREET FACADES WITH NO BLANK WALLS ALONG
- 4. ALL SIDES OF STRUCTURE VISIBLE TO THE PUBLIC ARE TREATED WITH APPROPRIATE STREET-FACING MATERIALS AND DETAILS.

THE STREET.

3-PART STUCCO SYSTEM W/ CONTINUOUS INSULATION (SEE A-410 FOR ADDITIONAL INFORMATION.)
 CONCRETE RETAINING WALL CAST W/ DECORATIVE ARCHITECTURAL FORMLINER (MFG.: SIKA OR SIMILAR)
 CONTINUOUS ARCHITECTURAL GUARDRAIL (PAINTED STEEL ROD PICKETS W/ STEEL FLAT BAR TOP AND BOTTOM RAILS)
 OUTSIDE CORNER REGLET DETAIL AT GROUND FLOOR ROUND ARCHES.
 TWO-STEP (4" EACH / 8" OVERALL) ARCHITECTURAL REVEAL TYPICAL AT FLOORS 2 TO 5.
 TWO-STEP (1" EACH / 2" OVERALL) ARCHITECTURAL REVEAL TYPICAL AT EAST AND WEST ELEVATIONS.
 ALUMINUM STOREFRONT SYSTEM
 FIXED ALUMINUM SINGLE-LITE PUNCHED WINDOW
 FIXED ALUMINUM DIVIDED-LITE PUNCHED WINDOW
 OUTSWING FULL-LITE BALCONY DOOR

11. CONTINUOUS ARCHITECTURAL GUARDRAIL (PAINTED STEEL ANGLED FLAT BAR PICKETS W/ STEEL FLAT BAR TOP AND BOTTOM

12. CÓNTRASTING STUCCO COLOR 13. CMU BREEZE BLOCK WALL NEW ORLEANS, LA 70115

ARCHITECT:

REPORT RE


3500 SAINT CHARLES AVENUE


3500 ST.

**CHARLES** 

**PROJECT ADDRESS:** 

FAROUKI FAROUKI LLC
1229 SAINT THOMAS, SUITE B
NEW ORLEANS, LA 70130
T: 646.306.9820

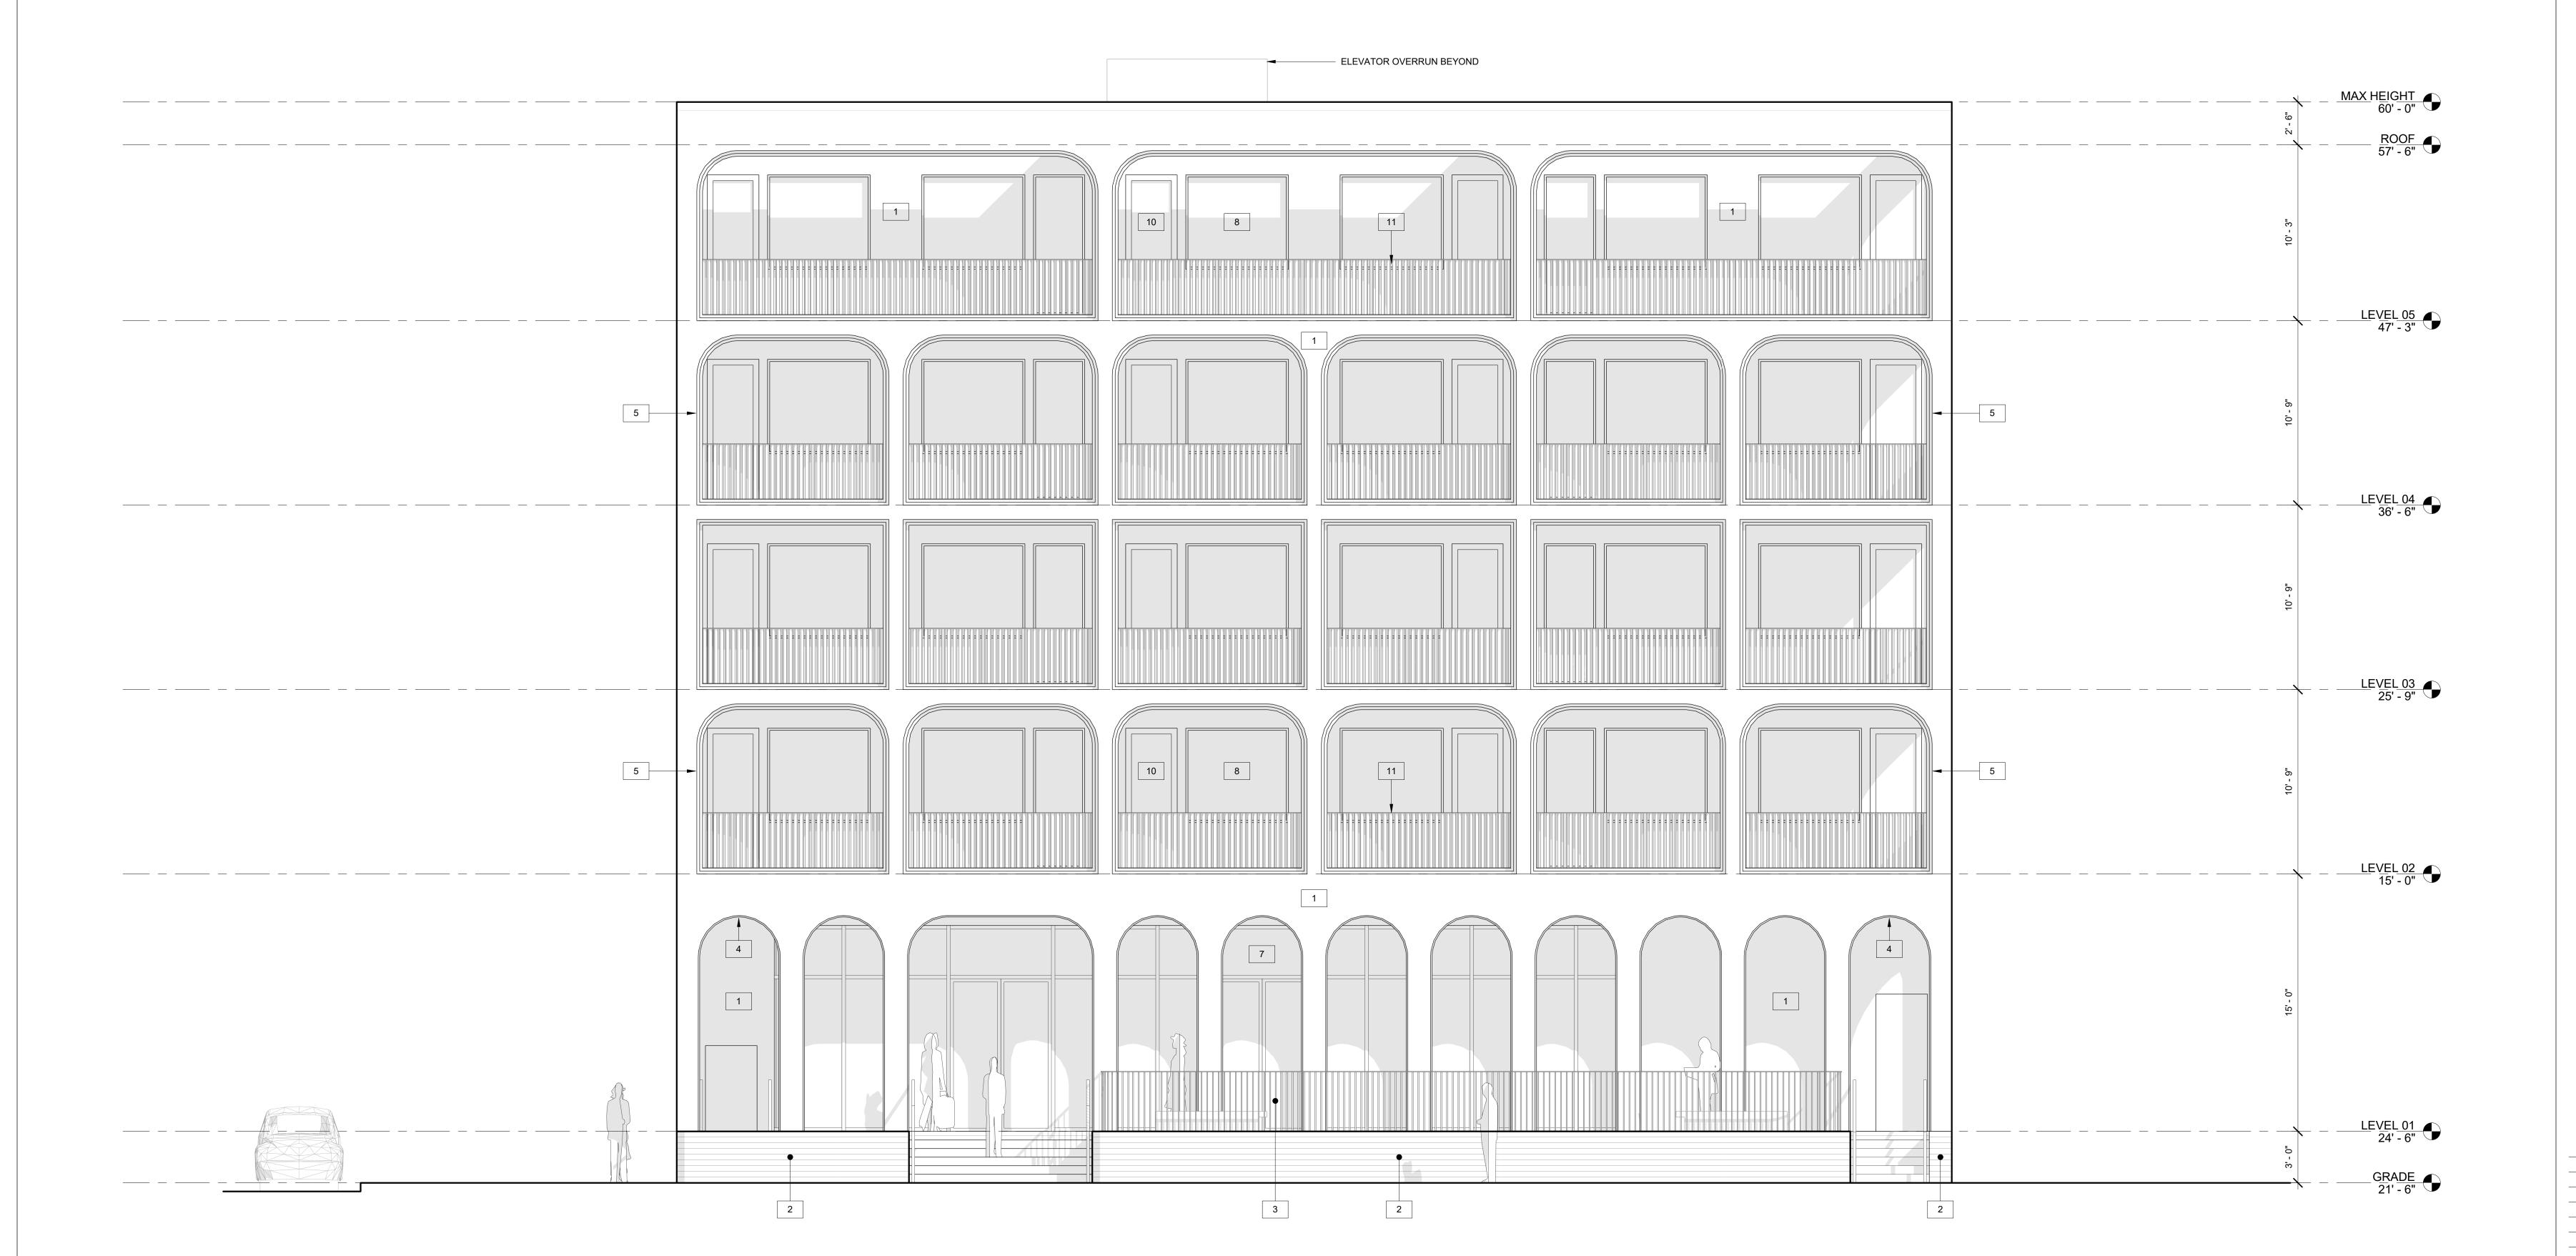

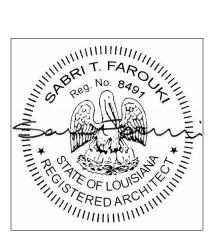

05/02/22 CPC SUBMISSION
03/07/22 SCHEMATIC DESIGN

NO DATE ISSUE

SHEET TITLE:
ELEVATION - NORTH

SHEET NUMBER:

A-30

THE DESIGN IS COMPATIBLE IN SCALE, MATERIALS, STREET LEVEL USES, AND SPATIAL RELATIONSHIPS WITH EXISTING DEVELOPMENT.

 THE DESIGN PRESERVES THE RHYTHM OF THE STREET, DOORWAYS, AND

3. THE DESIGN HAS ARTICULATED STREET FACADES WITH NO BLANK WALLS ALONG THE STREET.

4. ALL SIDES OF STRUCTURE VISIBLE TO THE PUBLIC ARE TREATED WITH APPROPRIATE STREET-FACING MATERIALS AND DETAILS.

1. 3-PART STUCCO SYSTEM W/ CONTINUOUS INSULATION (SEE A-410 FOR ADDITIONAL INFORMATION.)
2. CONCRETE RETAINING WALL CAST W/ DECORATIVE ARCHITECTURAL FORMLINER (MFG.: SIKA OR SIMILAR)
3. CONTINUOUS ARCHITECTURAL GUARDRAIL (PAINTED STEEL ROD PICKETS W/ STEEL FLAT BAR TOP AND BOTTOM RAILS)

CONTINUOUS ARCHITECTURAL GUARDRAIL (PAINTED STEEL ROD PICKETS W/ STEEL FLAT BAR TOP AND BOTTOM RAILS)
 OUTSIDE CORNER REGLET DETAIL AT GROUND FLOOR ROUND ARCHES.
 TWO-STEP (4" EACH / 8" OVERALL) ARCHITECTURAL REVEAL TYPICAL AT FLOORS 2 TO 5.
 TWO-STEP (1" EACH / 2" OVERALL) ARCHITECTURAL REVEAL TYPICAL AT EAST AND WEST ELEVATIONS.
 ALUMINUM STOREFRONT SYSTEM

8. FIXED ALUMINUM SINGLE-LITE PUNCHED WINDOW
9. FIXED ALUMINUM DIVIDED-LITE PUNCHED WINDOW
10. OUTSWING FULL-LITE BALCONY DOOR
11. CONTINUOUS ARCHITECTURAL GUARDRAIL (PAINTED STEEL ANGLED FLAT BAR PICKETS W/ STEEL FLAT BAR TOP AND BOTTOM

12. CONTRASTING STUCCO COLOR
13. CMU BREEZE BLOCK WALL

3500 ST. CHARLES


PROJECT ADDRESS:
3500 SAINT CHARLES AVENUE
NEW ORLEANS, LA 70115

ARCHITECT:

FAROUK

FAROUK

FAROUKI FAROUKI LLC 1229 SAINT THOMAS, SUITE B NEW ORLEANS, LA 70130 T: 646.306.9820

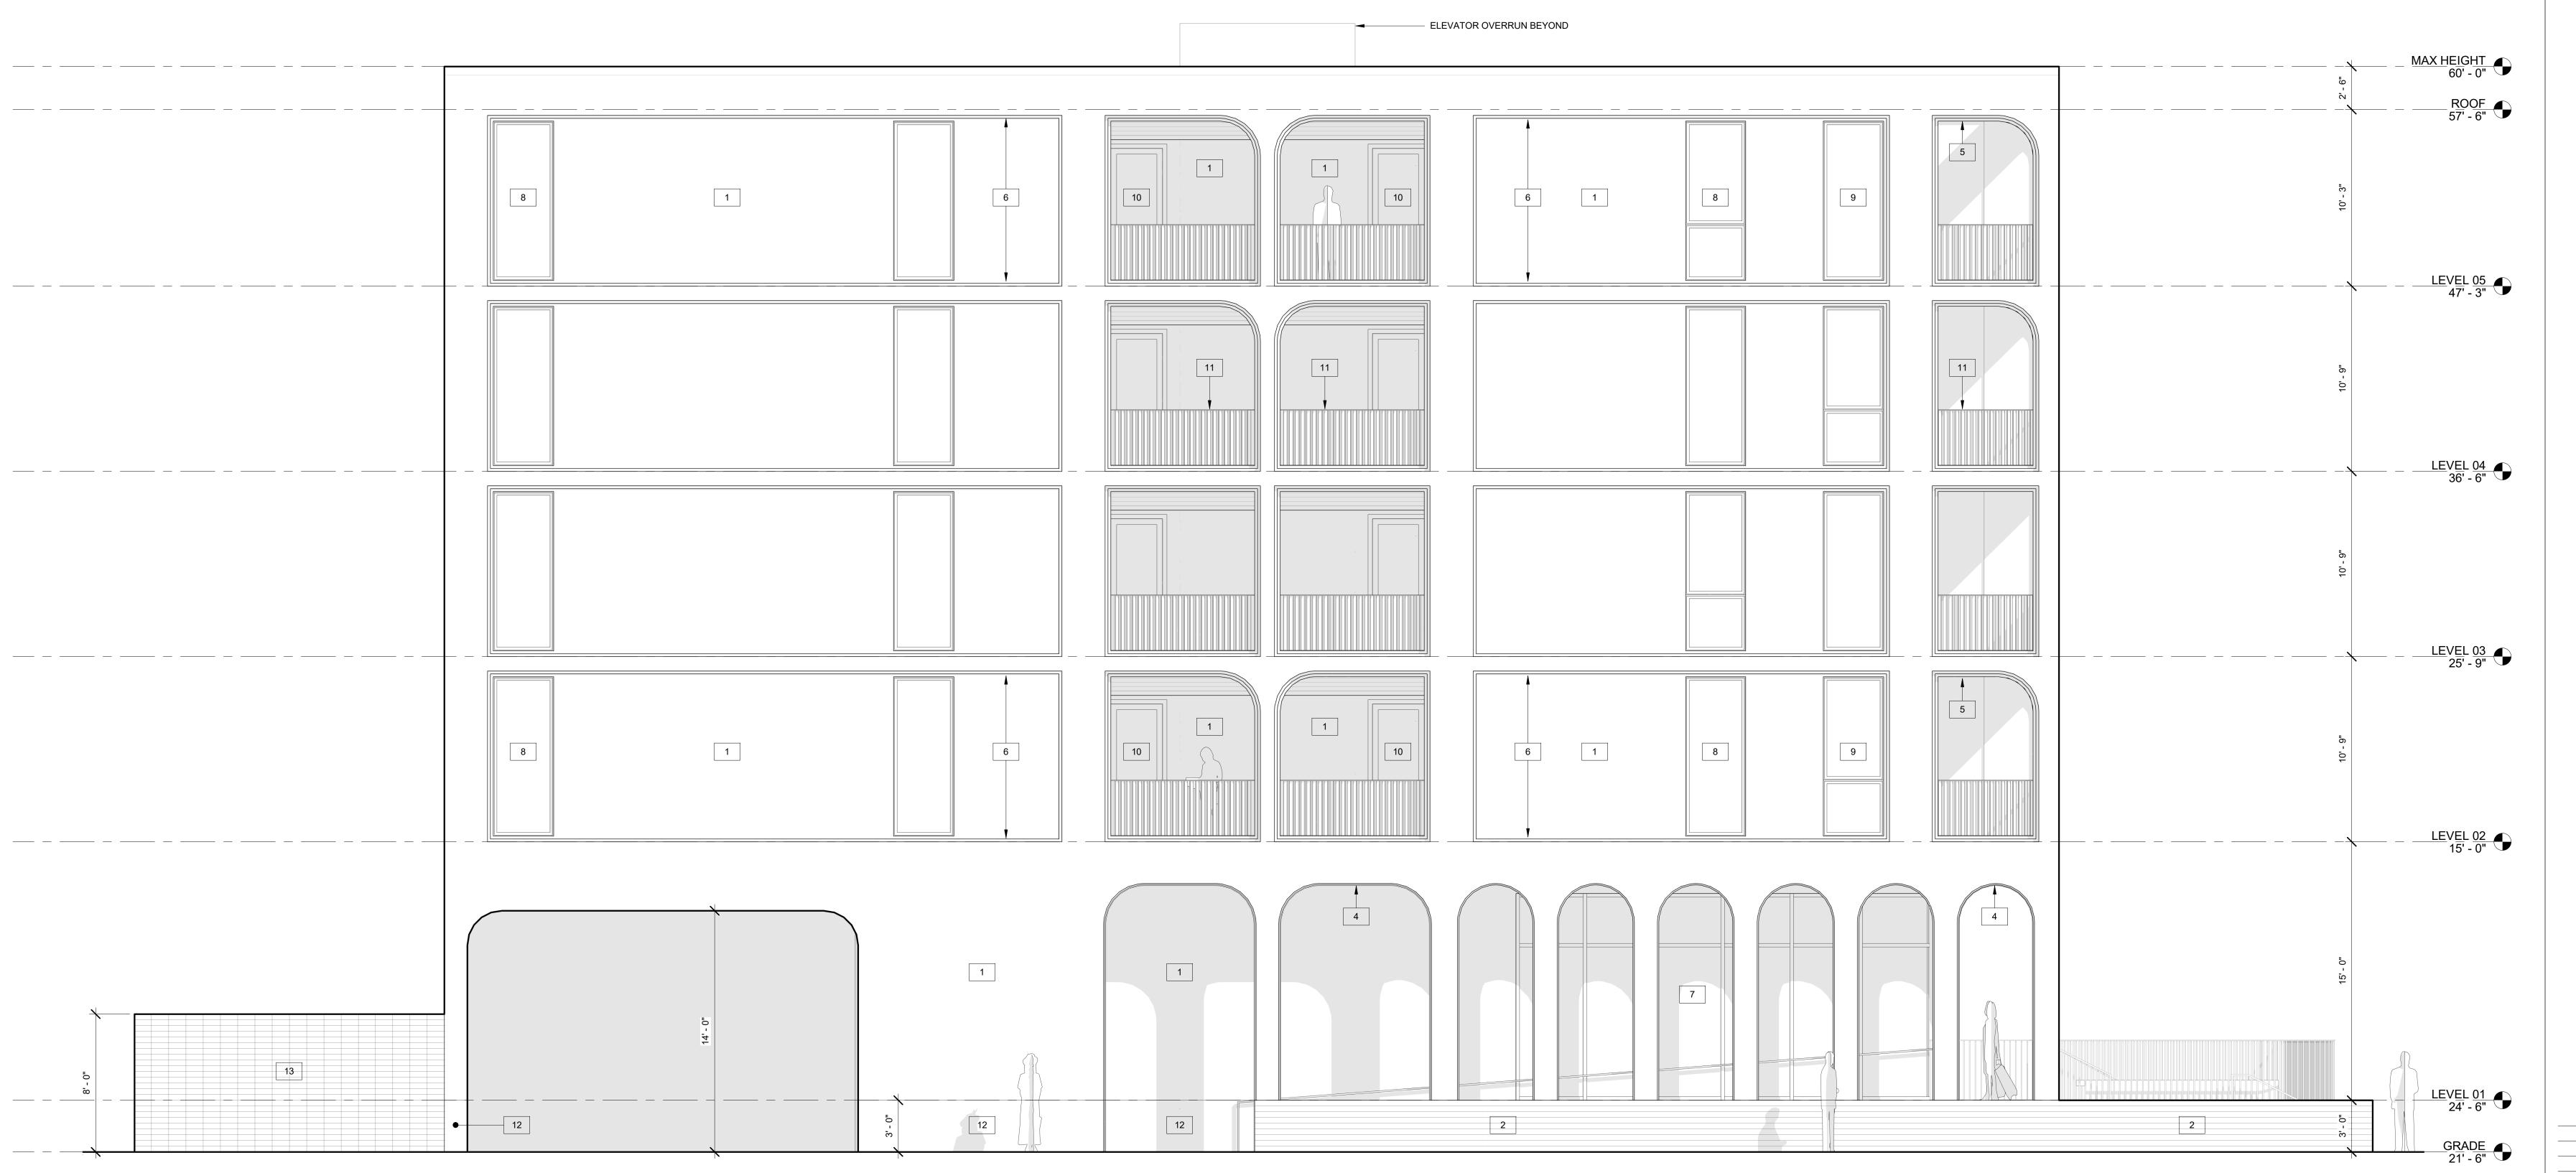



05/02/22 CPC SUBMISSION
03/07/22 SCHEMATIC DESIGN

NO DATE ISSUE

SHEET TITLE:

ELEVATION - EAST

SHEET NUMBER:

A-302

- 1. THE DESIGN IS COMPATIBLE IN SCALE, MATERIALS, STREET LEVEL USES, AND SPATIAL RELATIONSHIPS WITH EXISTING DEVELOPMENT.
- 2. THE DESIGN PRESERVES THE RHYTHM OF THE STREET, DOORWAYS, AND WINDOWS.
- 3. THE DESIGN HAS ARTICULATED STREET FACADES WITH NO BLANK WALLS ALONG THE STREET.
- 4. ALL SIDES OF STRUCTURE VISIBLE TO THE PUBLIC ARE TREATED WITH APPROPRIATE STREET-FACING MATERIALS AND DETAILS.

3-PART STUCCO SYSTEM W/ CONTINUOUS INSULATION (SEE A-410 FOR ADDITIONAL INFORMATION.)
 CONCRETE RETAINING WALL CAST W/ DECORATIVE ARCHITECTURAL FORMLINER (MFG.: SIKA OR SIMILAR)
 CONTINUOUS ARCHITECTURAL GUARDRAIL (PAINTED STEEL ROD PICKETS W/ STEEL FLAT BAR TOP AND BOTTOM RAILS)
 OUTSIDE CORNER REGLET DETAIL AT GROUND FLOOR ROUND ARCHES.
 TWO-STEP (4" EACH / 8" OVERALL) ARCHITECTURAL REVEAL TYPICAL AT FLOORS 2 TO 5.
 TWO-STEP (1" EACH / 2" OVERALL) ARCHITECTURAL REVEAL TYPICAL AT EAST AND WEST ELEVATIONS.
 ALUMINUM STOREFRONT SYSTEM
 FIXED ALUMINUM SINGLE-LITE PUNCHED WINDOW
 FIXED ALUMINUM DIVIDED-LITE PUNCHED WINDOW
 OUTSWING FULL-LITE BALCONY DOOR
 CONTINUOUS ARCHITECTURAL GUARDRAIL (PAINTED STEEL ANGLED FLAT BAR PICKETS W/ STEEL FLAT BAR TOP AND BOTTOM RAILS)
 CONTRASTING STUCCO COLOR

13. CMU BREEZE BLOCK WALL

## 3500 ST. CHARLES


PROJECT ADDRESS:
3500 SAINT CHARLES AVENUE
NEW ORLEANS, LA 70115


ARCHITECT:

ROUKE

ROUK

FAROUKI FAROUKI LLC 1229 SAINT THOMAS, SUITE B NEW ORLEANS, LA 70130 T: 646.306.9820

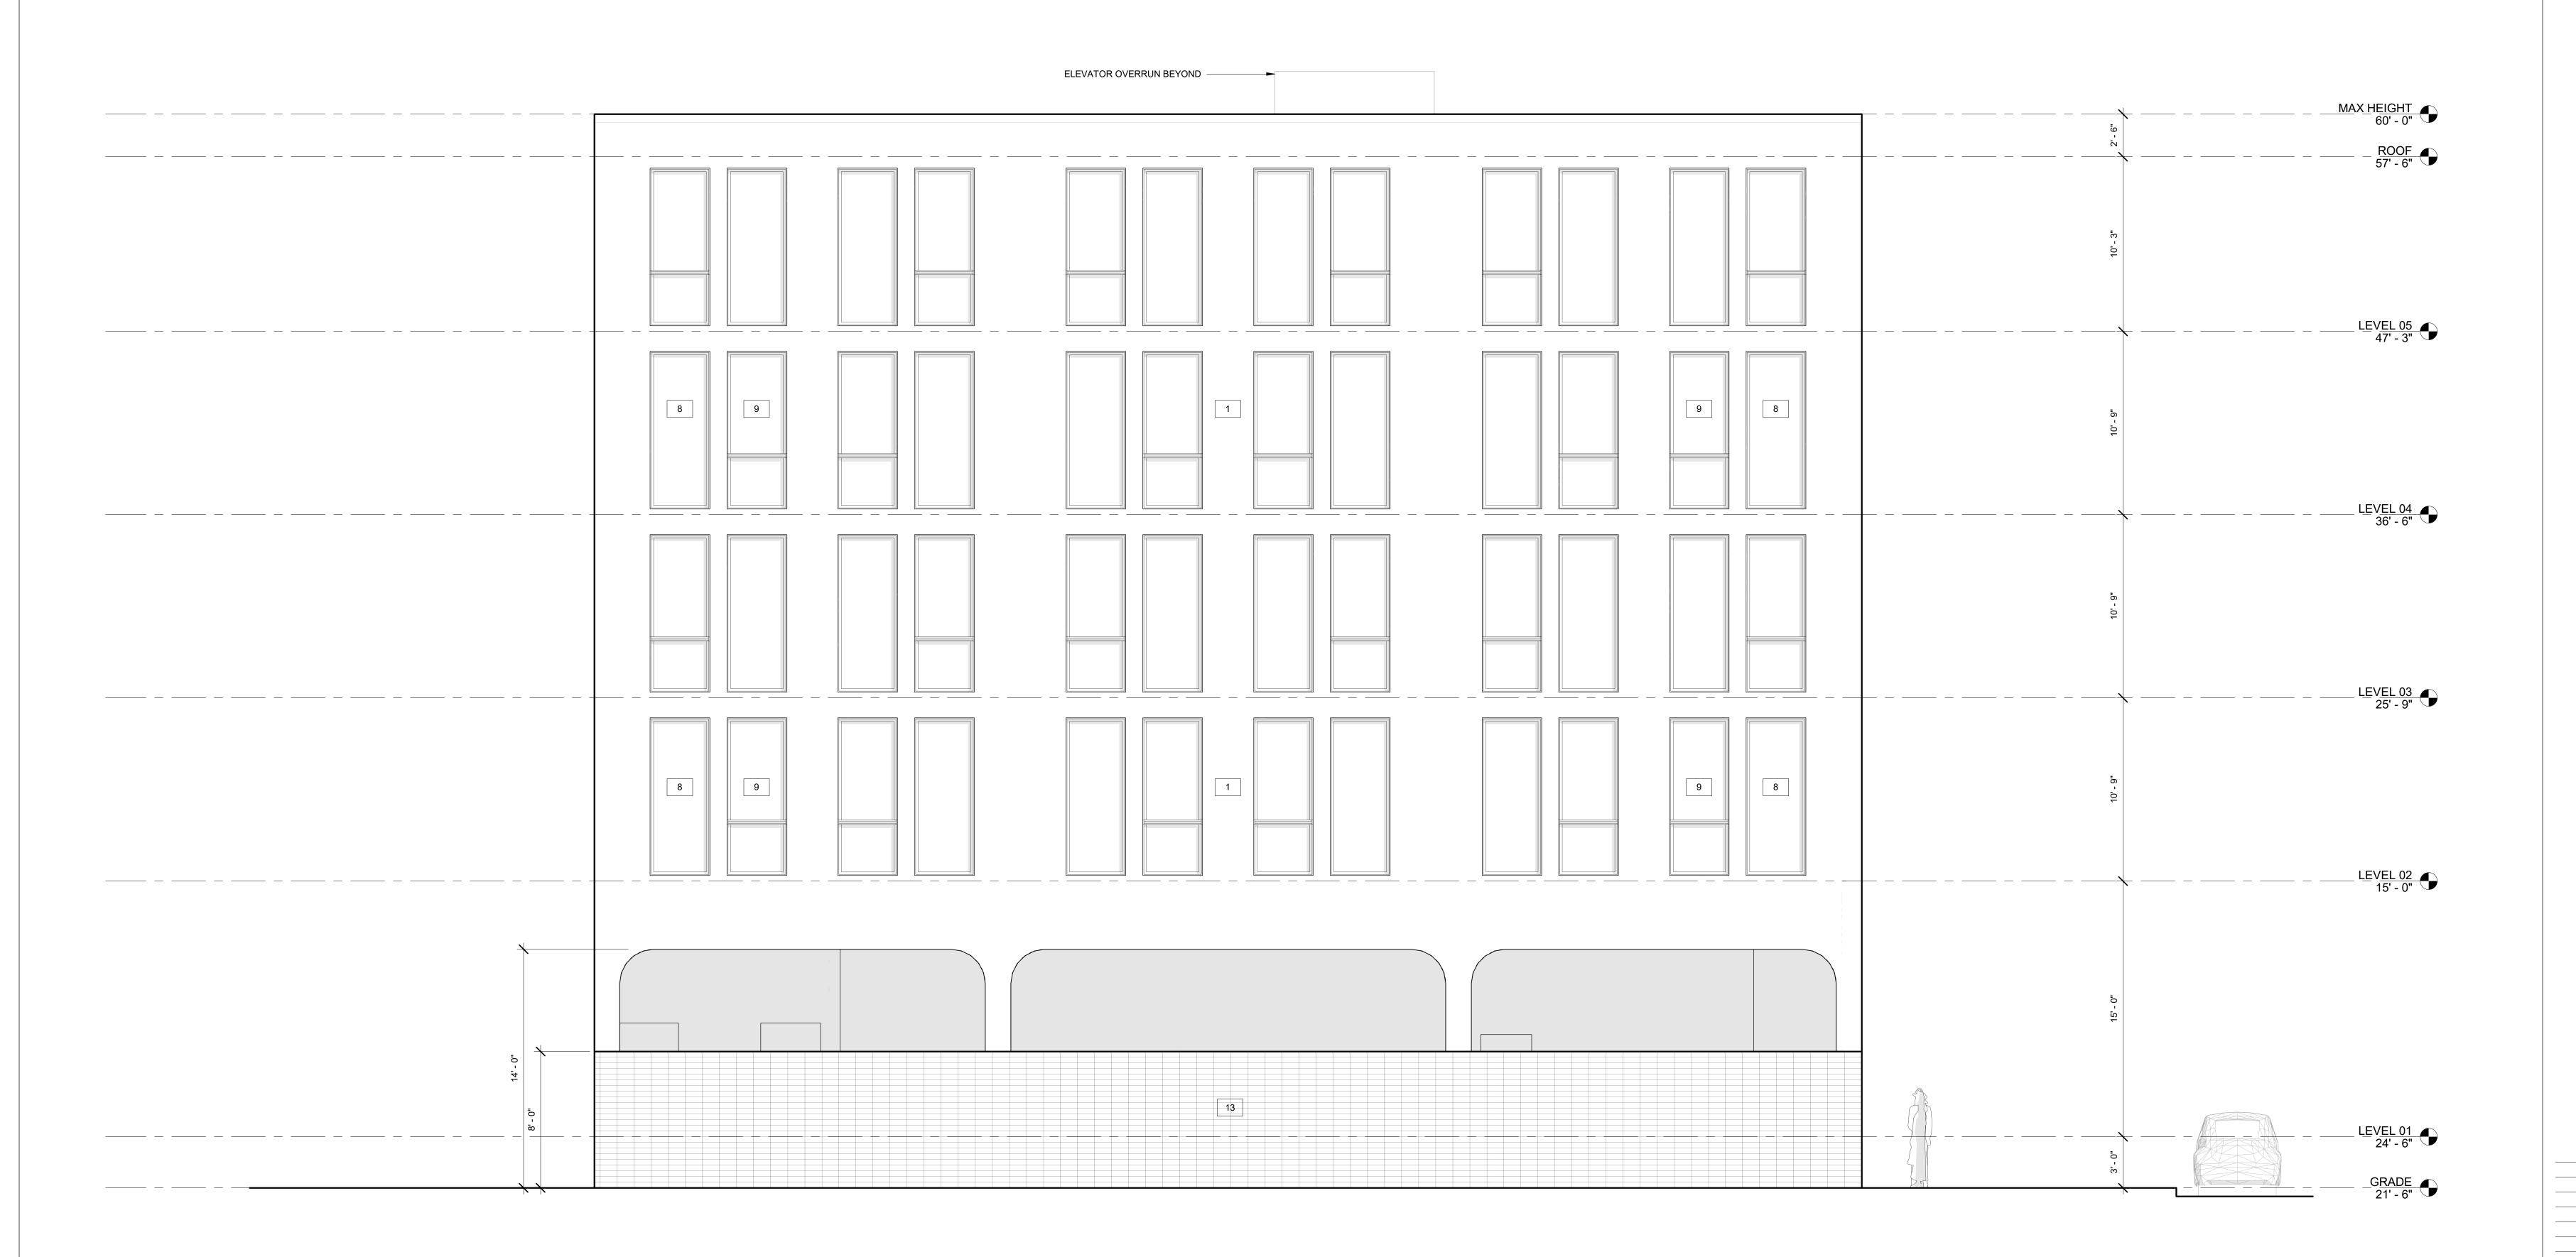

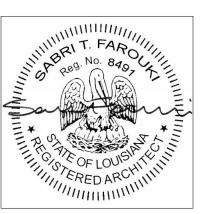

05/02/22 CPC SUBMISSION
03/07/22 SCHEMATIC DESIGN

NO DATE ISSUE

SHEET TITLE:
ELEVATION - SOUTH

SHEET NUMBER:

A-303

- 1. THE DESIGN IS COMPATIBLE IN SCALE, MATERIALS, STREET LEVEL USES, AND SPATIAL RELATIONSHIPS WITH EXISTING DEVELOPMENT.
- 2. THE DESIGN PRESERVES THE RHYTHM OF THE STREET, DOORWAYS, AND WINDOWS.
- 3. THE DESIGN HAS ARTICULATED STREET FACADES WITH NO BLANK WALLS ALONG THE STREET.
- 4. ALL SIDES OF STRUCTURE VISIBLE TO THE PUBLIC ARE TREATED WITH APPROPRIATE STREET-FACING MATERIALS AND DETAILS.

1. 3-PART STUCCO SYSTEM W/ CONTINUOUS INSULATION (SEE A-410 FOR ADDITIONAL INFORMATION.)
2. CONCRETE RETAINING WALL CAST W/ DECORATIVE ARCHITECTURAL FORMLINER (MFG.: SIKA OR SIMILAR)
3. CONTINUOUS ARCHITECTURAL GUARDRAIL (PAINTED STEEL ROD PICKETS W/ STEEL FLAT BAR TOP AND BOTTOM RAILS)
4. OUTSIDE CORNER REGLET DETAIL AT GROUND FLOOR ROUND

- 4. OUTSIDE CORNER REGLET DETAIL AT GROUND FLOOR ROUND ARCHES.
  5. TWO-STEP (4" EACH / 8" OVERALL) ARCHITECTURAL REVEAL TYPICAL AT FLOORS 2 TO 5.
  6. TWO-STEP (1" EACH / 2" OVERALL) ARCHITECTURAL REVEAL TYPICAL AT EAST AND WEST ELEVATIONS.
  7. ALUMINUM STOREFRONT SYSTEM
  8. FIXED ALUMINUM SINGLE-LITE PUNCHED WINDOW
- 9. FIXED ALUMINUM SINGLE-LITE PUNCHED WINDOW
  10. OUTSWING FULL-LITE BALCONY DOOR
  11. CONTINUOUS ARCHITECTURAL GUARDRAIL (PAINTED STEEL ANGLED FLAT BAR PICKETS W/ STEEL FLAT BAR TOP AND BOTTOM RAILS)
- 12. CONTRASTING STUCCO COLOR
  13. CMU BREEZE BLOCK WALL

3500 ST. CHARLES


PROJECT ADDRESS:
3500 SAINT CHARLES AVENUE
NEW ORLEANS, LA 70115


ARCHITECT:

ROUKE

ROUK

FAROUKI FAROUKI LLC 1229 SAINT THOMAS, SUITE B NEW ORLEANS, LA 70130 T: 646.306.9820

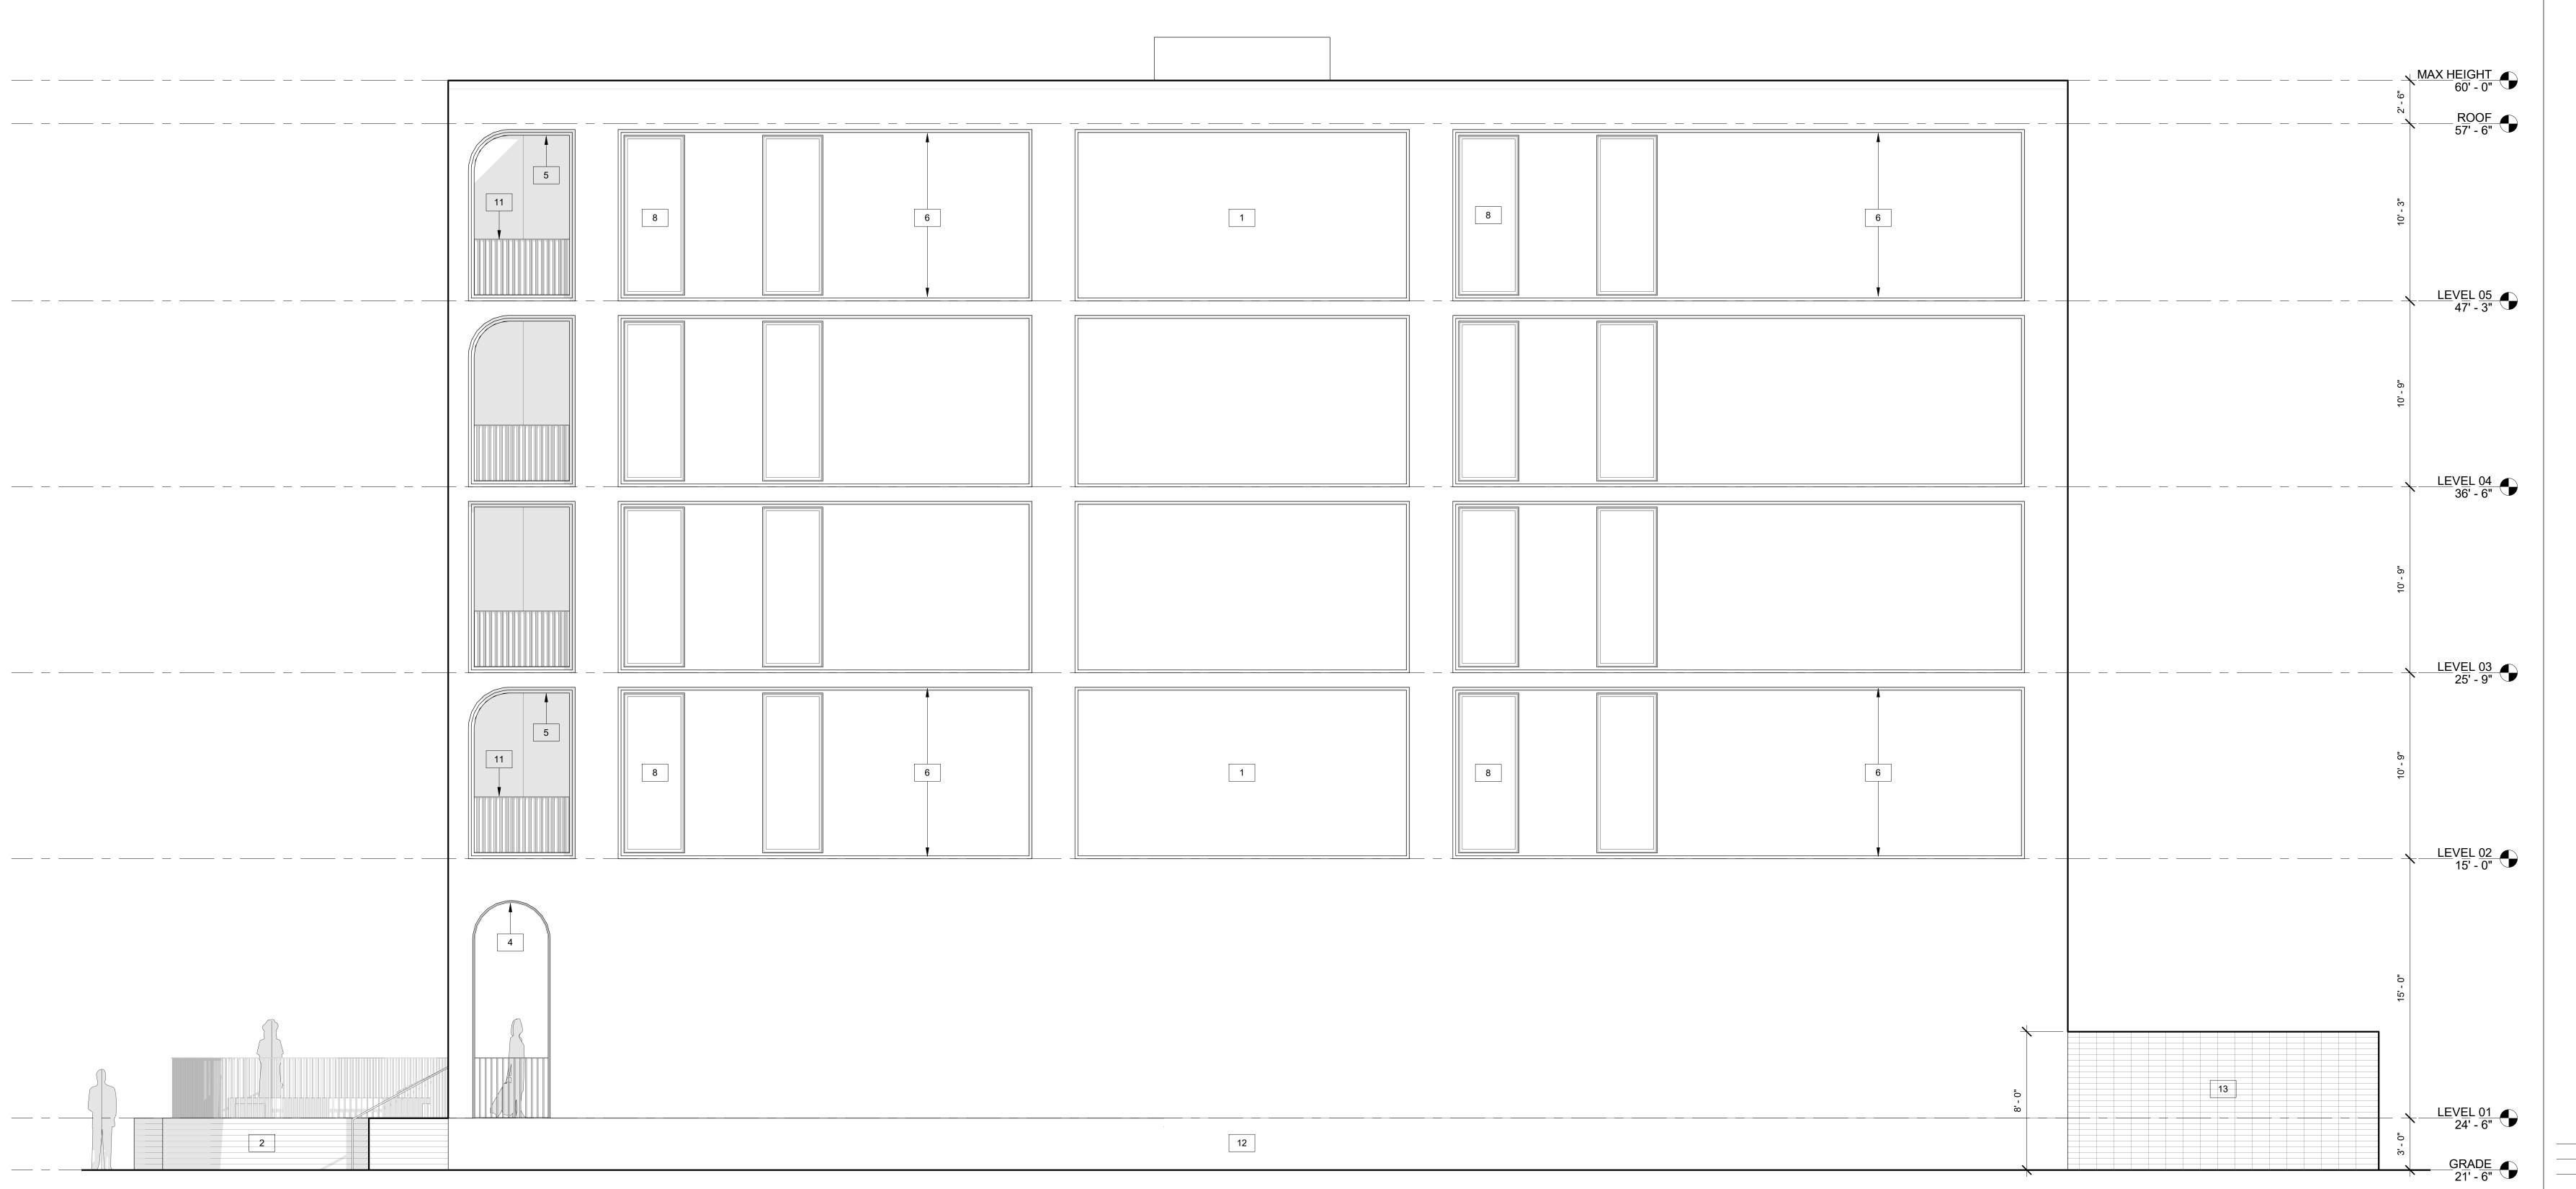

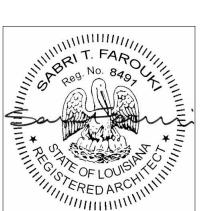

05/02/22 CPC SUBMISSION
03/07/22 SCHEMATIC DESIGN

NO DATE ISSUE

SHEET TITLE:

ELEVATION - WEST

SHEET NUMBER:

A-30