
## Vieux Carré Commission Architecture Committee Meeting

Tuesday, March 14, 2023








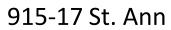



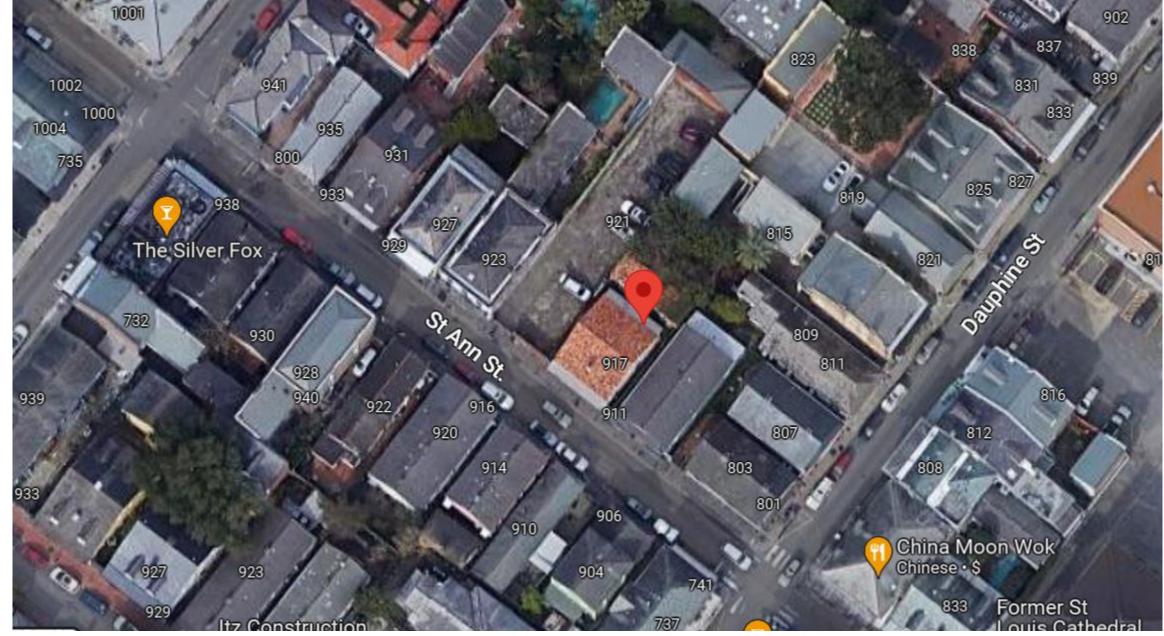

915-17 St. Ann





915-17 St. Ann – 1950s





915-17 St. Ann – 1940s-50s?





915-17 St. Ann – 1950s





915-17 St. Ann – 1962





915-17 St. Ann – 1964





915-17 St. Ann – 1964



915-17 St. Ann – ca. 1964





915-17 St. Ann – ca. 1964





915-17 St. Ann





915-17 St. Ann



915-17 St. Ann



915-17 St. Ann



915-17 St. Ann



915-17 St. Ann



915-17 St. Ann




915-17 St. Ann



915-17 St. Ann, HABS Survey



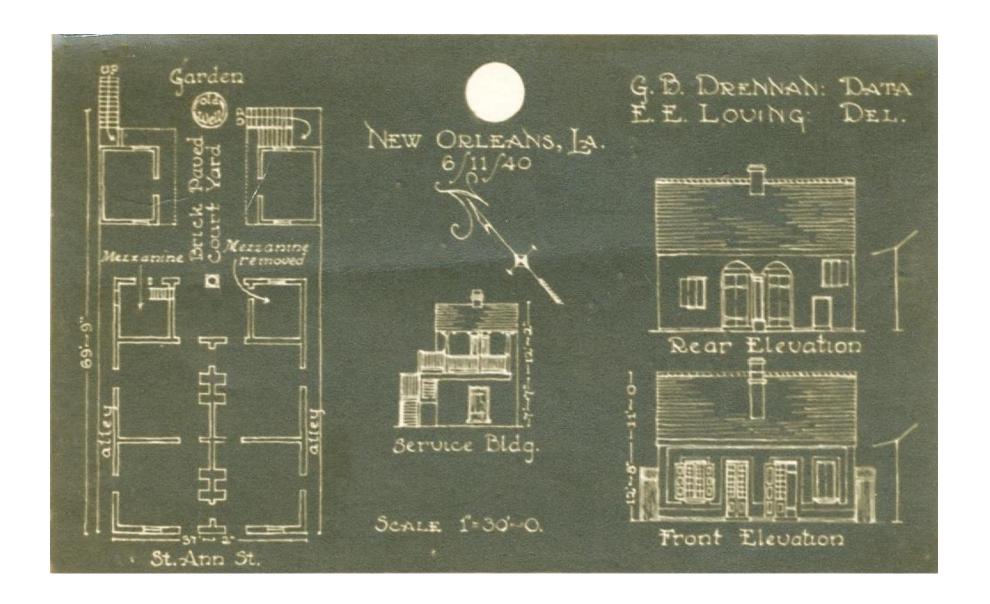





STATE	COUNTY	TOWN OR VICINITY
Louisiana	Orleans	New Orleans
INDEX NUMBER		d Gaillard, Jr. Cottage . Ann street
REPRESENTED IN NEGATIVE FILE		ORY: Built circa 1824 by ond Gaillard, Jr. Present
PUBLISHED PHOTOGRAPHS	owner: Harold Schilke.  DESCRIPTION: One-story. Front brick. Sides	
PUBLISHED DRAWINGS	and rear stucco on brick. Loggia with mezza- nine in rear. Slate, gable roof. 2 similar 2-story brick service buildings with wood	
• F• 6—8369	balconies. REFERENCES: Co	urt Records. Map of New Orleans 1808.  AMERICAN BUILDINGS SURVEY














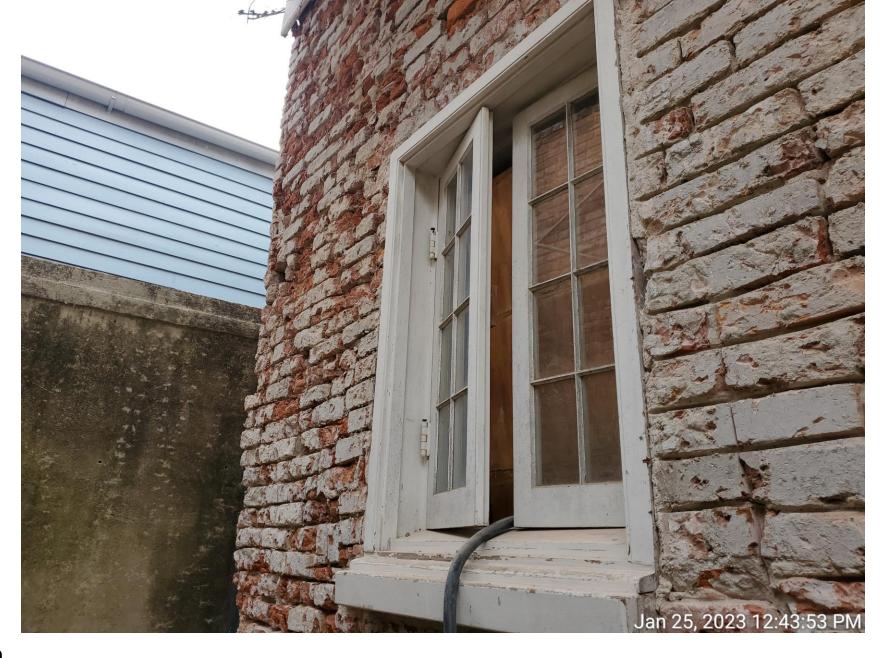

















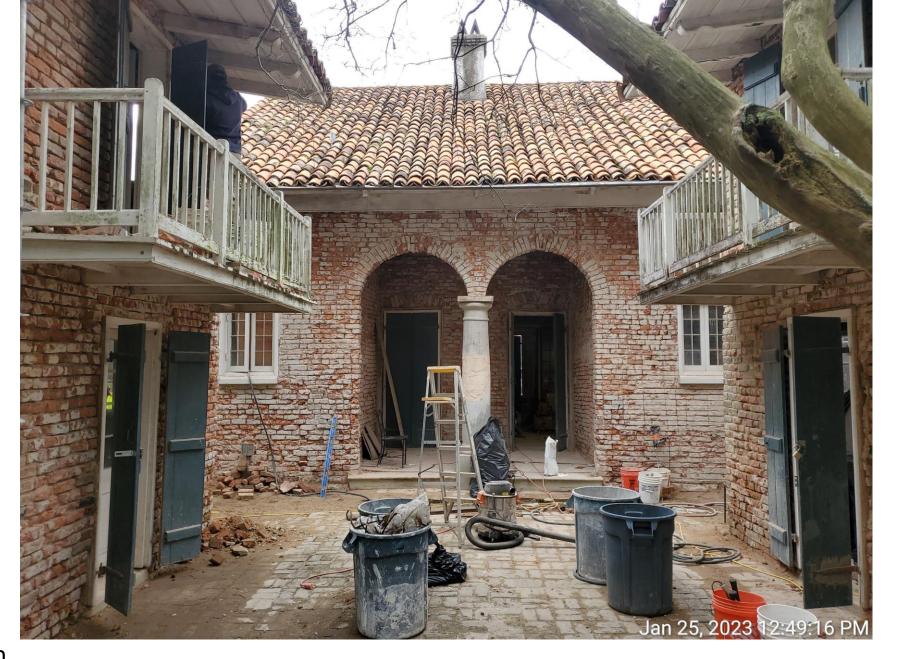








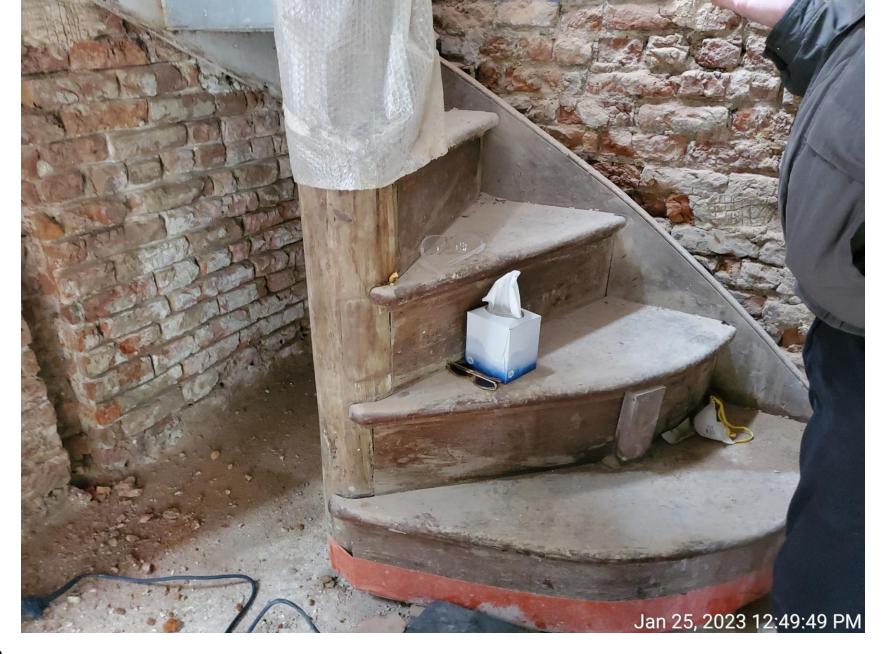







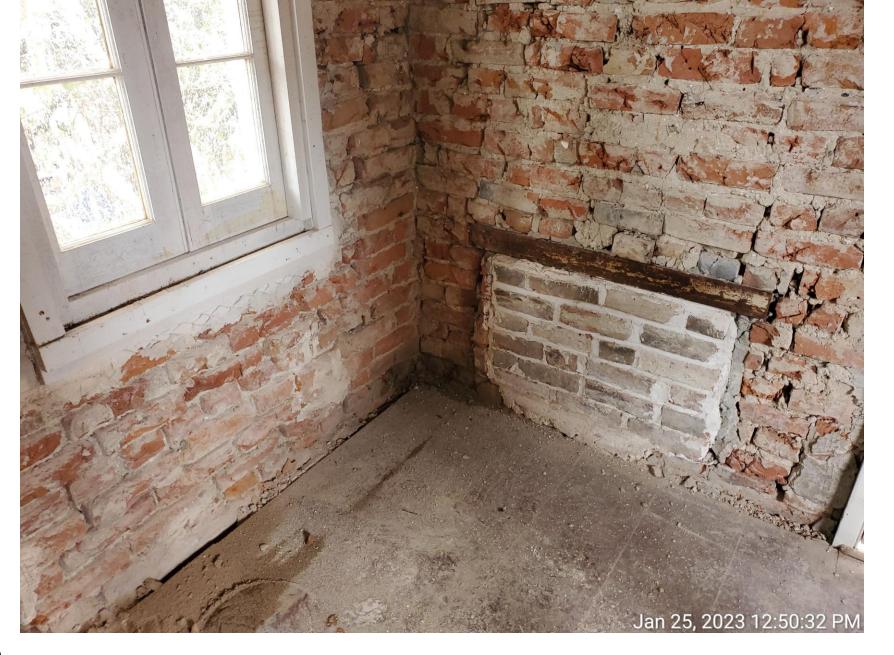





























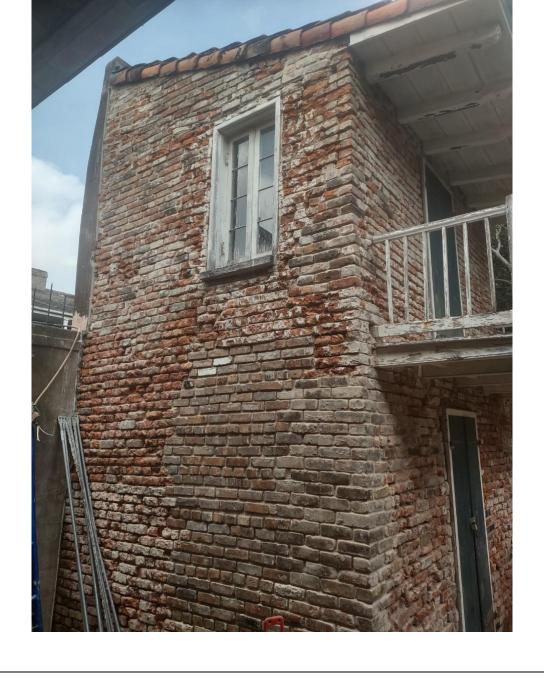



915-17 St. Ann



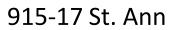




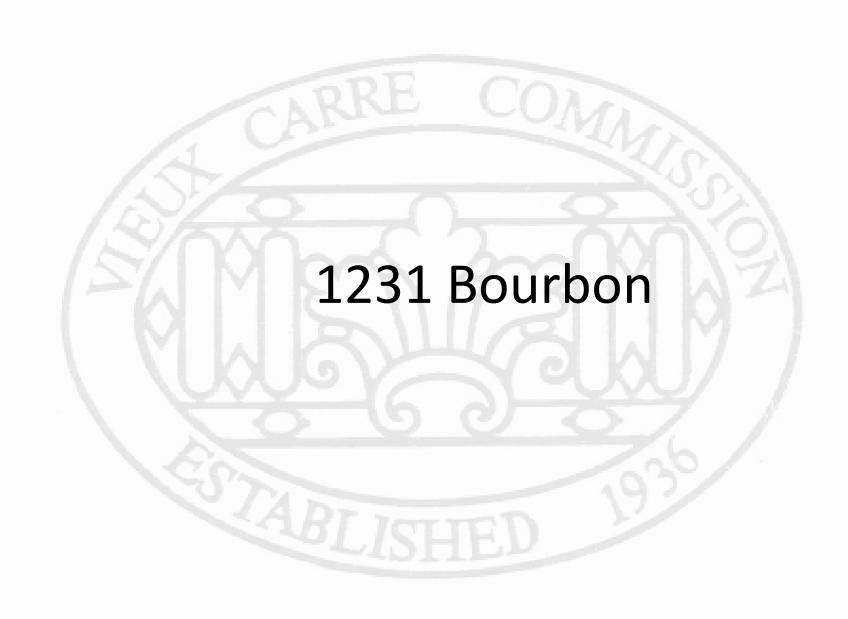


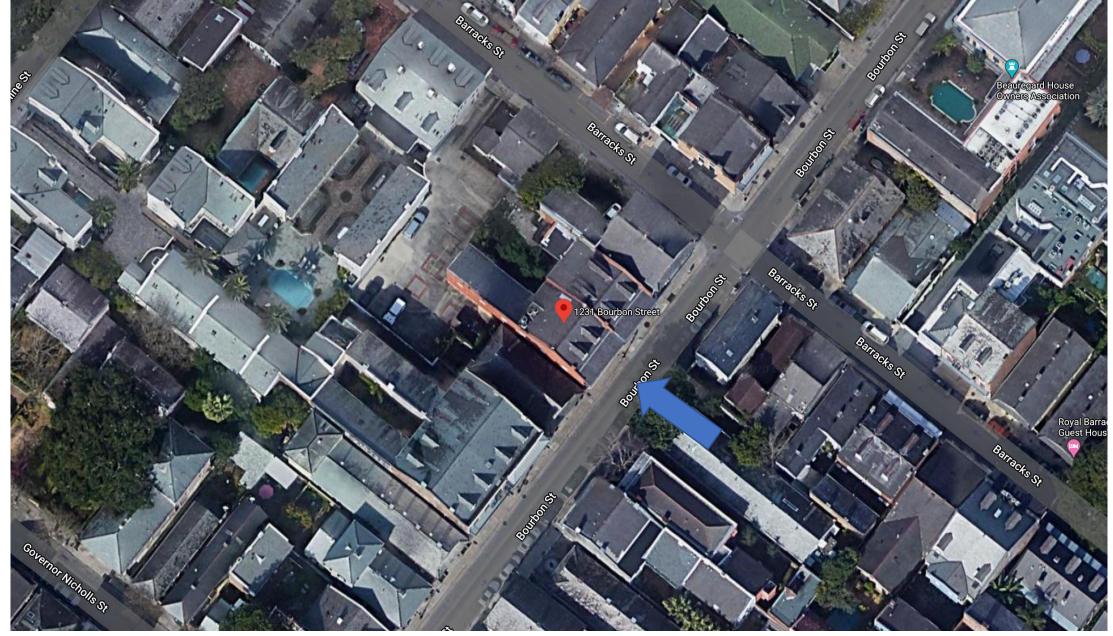

1231 Bourbon

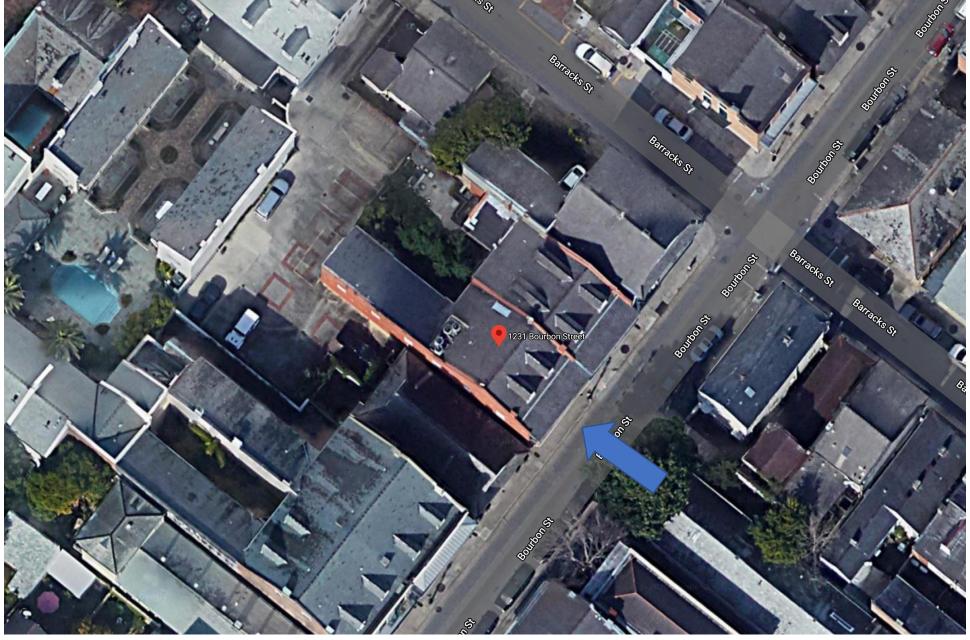



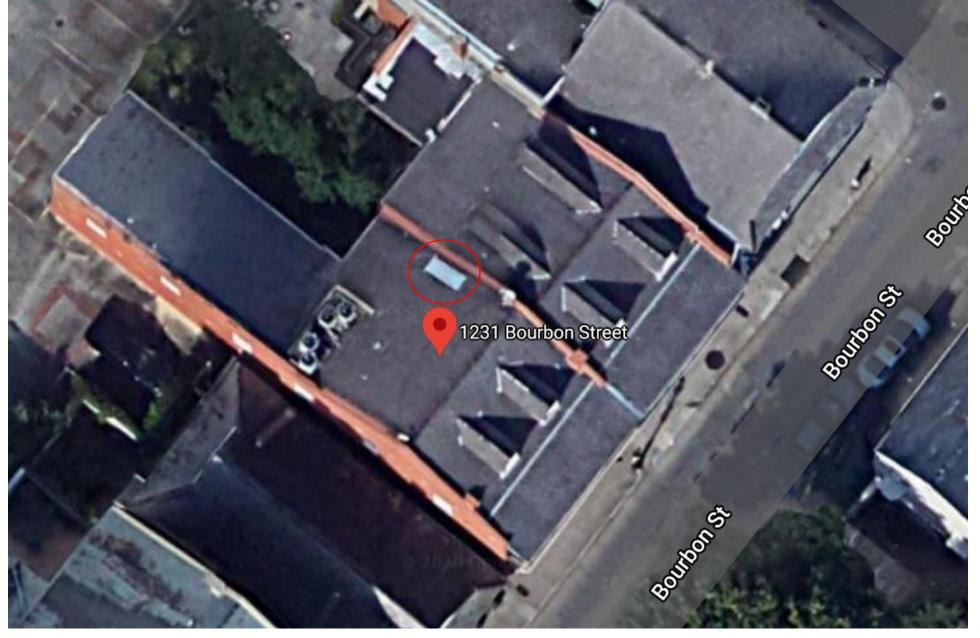
























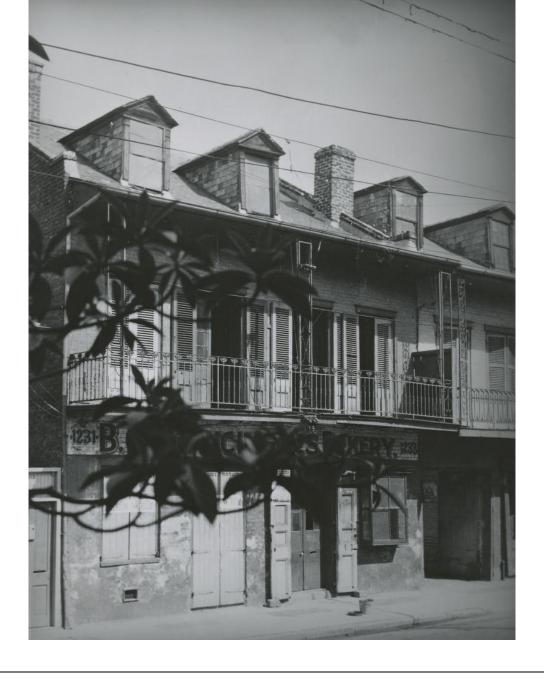





































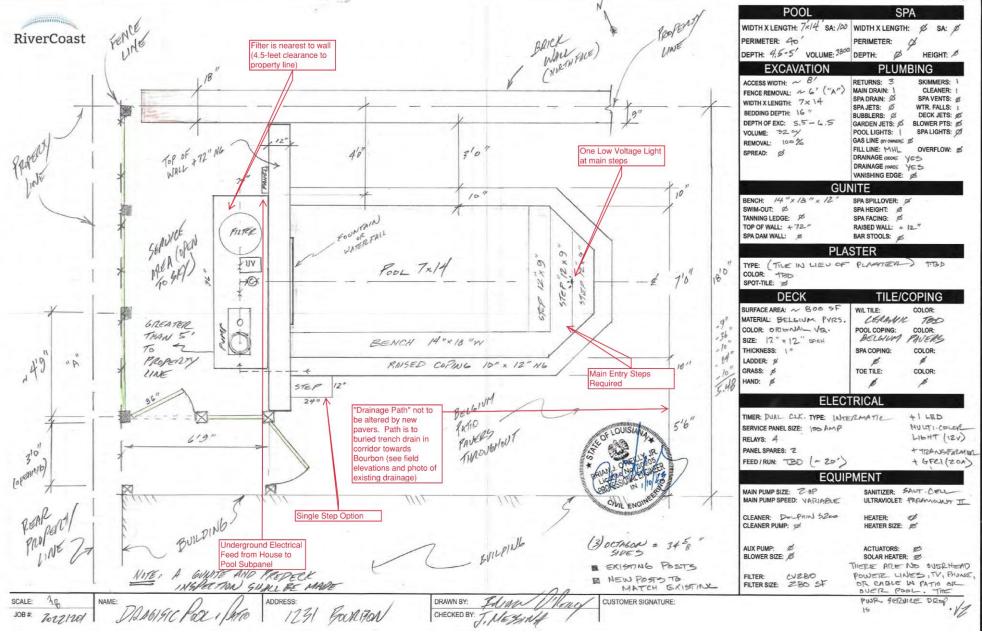




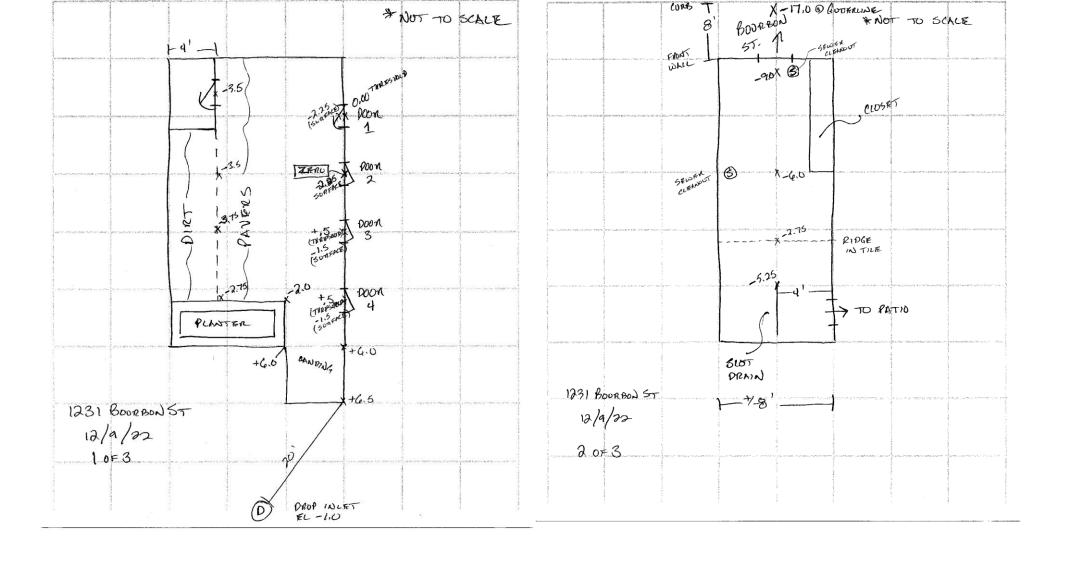







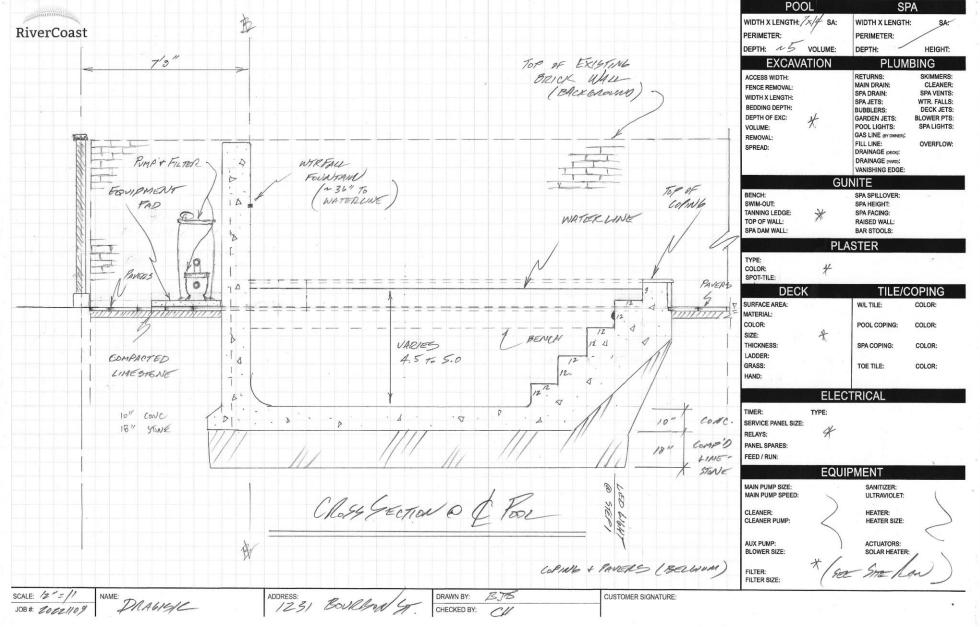



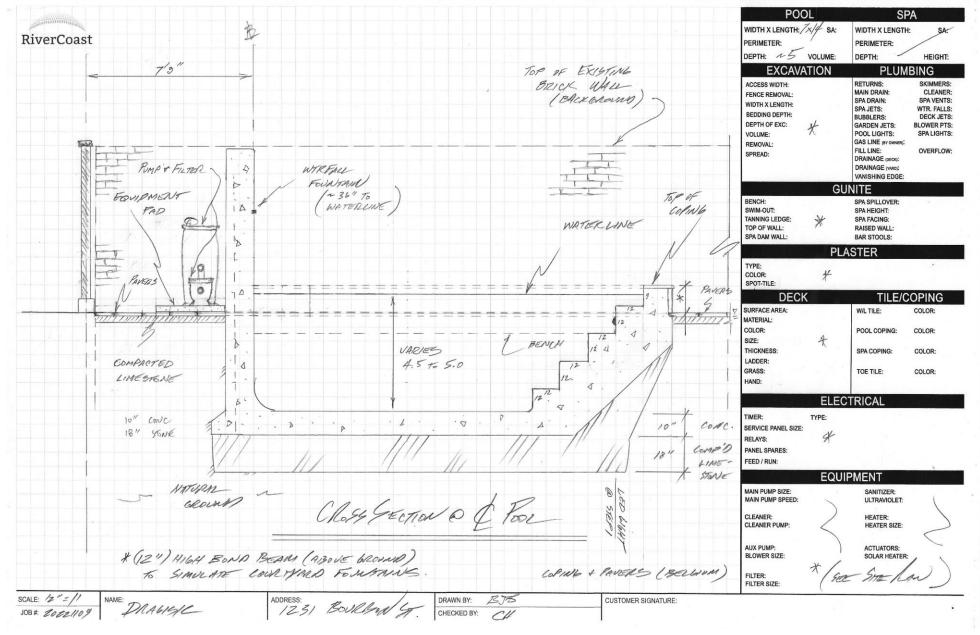



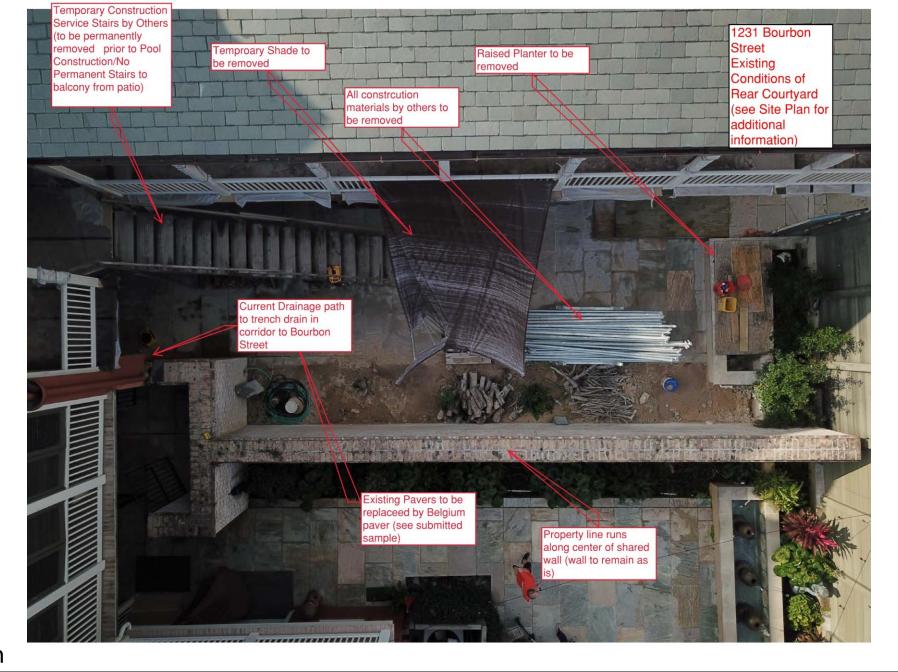













1231 Bourbon




1231 Bourbon





1231 Bourbon




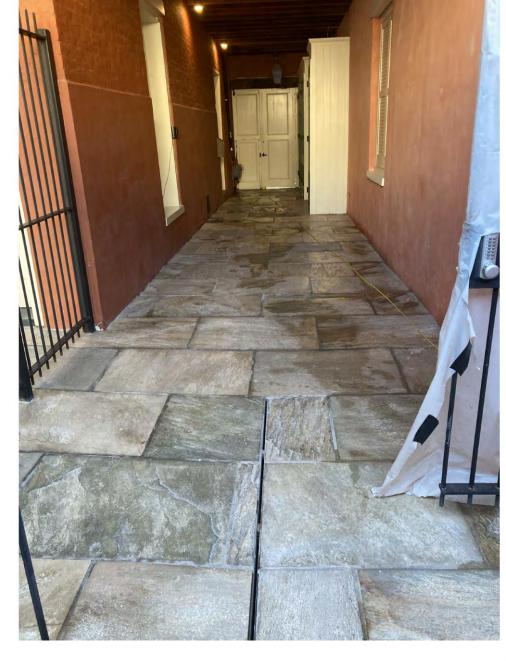

1231 Bourbon






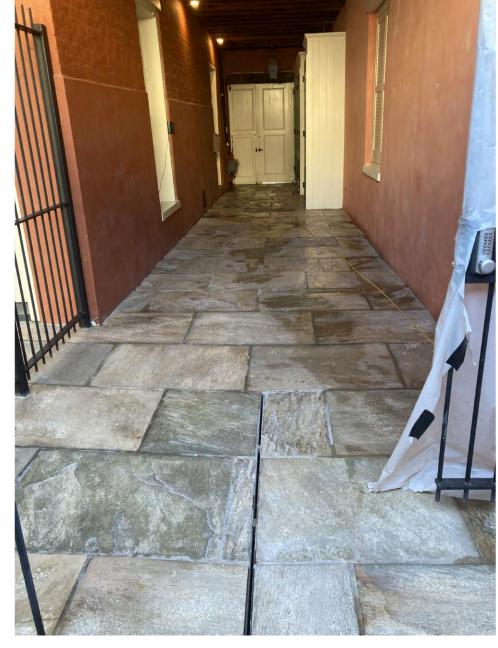

1231 Bourbon



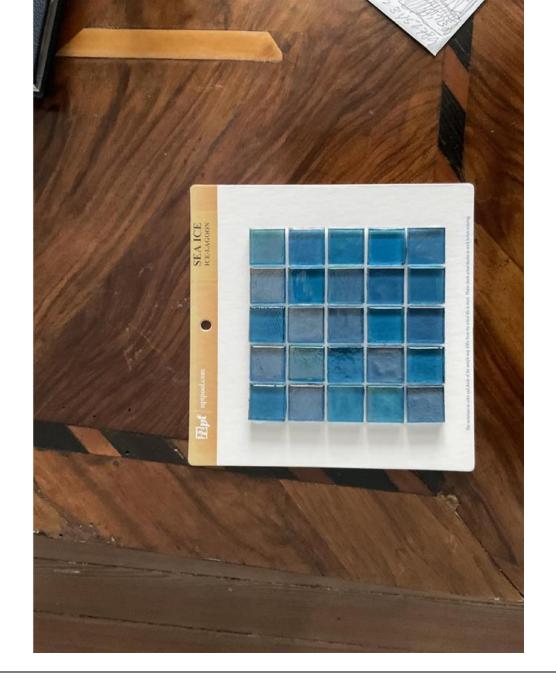



# **Technical Specifications**

**CS Series Filters** 






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Part No.	Description	Size
CS100	CS Cartridge Filter	100 Sq. Ft.
CS150	CS Cartridge Filter	150 Sq. Ft.
CS200	CS Cartridge Filter	200 Sq. Ft.
CS250	CS Cartridge Filter	250 Sq. Ft.

## **CS Filter Head Loss Curves**

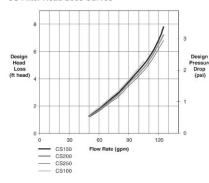

Specifications and Dimensions, CS Series Filters						
Model No.	CS100	CS150	CS200	CS250		
Filter Area	100 ft <sup>2</sup>	150 ft²	200 ft²	250 ft²		
Design Flow Rate	1 gpm/ft <sup>2</sup>	.85 gpm/ft²	.625 gpm/ft²	.5 gpm/ft <sup>2</sup>		
Maximum Flow	100 gpm	125 gpm	125 gpm	125 gpm		
Six (6) Hour Capacity	36,000 gallons	45,000 gal- lons	45,000 gallons	45,000 gal- lons		
Eight (8) Hour Capacity	48,000 gallons	60,000 gal- lons	60,000 gallons	60,000 gal- lons		
Normal Start Up Pressure	6-15 psi	6-15 psi	6-15 psi	6-15 psi		
Max. Working Pressure	50 psi	50 psi	50 psi	50 psi		
Cartridges Required	1	1	1	1		
Shipping Weight	28 lbs.	28 lbs.	34 lbs.	36 lbs.		
Height ('A')	32%"	32%"	42½"	421/2"		

www.ZodiacPoolSystems.com

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# There's no need to sacrifice your pump's power.

The ideal replacement for high energy-consuming single-speed pumps up to 1.5 HP, the 115v/230v dual voltage VS FloPro" 1.85 is *the onl*yvariable-speed pump on the market that offers the same performance at both voltages.

### 115v/230v Dual Voltage

With the ability to provide the same head pressure and flow rates at both 115v and 230v, the VS FloPro 1.85 eliminates the need for expensive main power rewiring without compromising performance.

### · Add iQPUMP01 for Instant Automation

Two auxiliary relays can be used to control other pool equipment, such as booster pumps and salt chlorinators, for easier installation and operation. No need for additional timeclocks!



## • Lower Electricity Costs

Save over \$850¹ per year in energy costs! The variable-speed motor allows for dramatic energy savings and quieter operation.

### . Our Quietest Variable-Speed Pump

Over 40% quieter? than other Jandy variablespeed pumps, the VS FloPro 1.85 HP features proprietary sound dampening motor technology allowing it to operate with noticeably less noise.

#### . Choose Your Own Controller

Designed to work with the following Jandy® control systems for complete programmability and customization (controller sold separately):

- Jandy AquaLink® Automation Systems
- > iQPUMP01 with iAquaLink® App Control
- > JEP-R Controller


### Additional Features

- Adjustable base for seamless direct replacement of a variety of other pumps in the aftermarket
- Zero Clearance TEFC Motor for cool, quiet operation in tight spaces
- > 2" unions included or utilize 2" internal threads
- Easy Controller Setup auto detects connection to an automation system or a traditional controller, eliminating the need to adjust settings manually
- RS485 Quick Connect Port for faster installation and maintenance
- > Dry Contact Relay Control
- Tool-free lid for easy debris removal
- > Ergonomic easy-transport handle

## ADJUSTABLE BASE CONFIGURATIONS

Base	Fits	Dimension	Dimension	
No Base	Hayward® Super Pump® Pentair® SuperFlo® Sta•Rite® SuperMax®	7 3/4"	12 3/4"	
Small Base	Hayward Super II" Jandy PlusHP and MaxHP Pumps	8 7/8"	13 7/8"	
Small Base w/ Spacers	Pentair WhisperFlo® Sta-Rite Dyna-Glas™	9 1/8"	14 1/8"	
Small Base + Large Base	Sta-Rite Max-E-Pro® Sta-Rite Dura-Glas® Sta-Rite Dura-Glas II Sta-Rite Max-E-Glas®	10 3/4"	15 3/4"	


#### DIMENSIONS

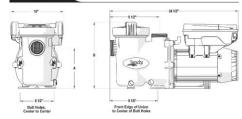

## SPECIFICATIONS

Model No.	THP	WEF4	Voltage	Max Watts	Amps	Union	Rec. Pipe Size <sup>s</sup>	Carton Weight	Overall Length
VSFHP185DV2A	1.85	8.5	230 VAC 115 VAC	1,700W 1,800W	7.5 15.5	2"×2"	1 1/2" - 2 1/2"	53 lbs.	24 1/2"

#### ERFORMANCE

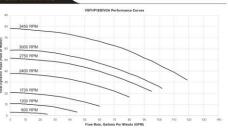

\*Based on a 22,500 gallon pool with two turnovers per day at an energy cost of \$0.195/kWh vs. comparable single speed pumps, when tested in a accordance with the applicable requirements of 10 CFR 429.

\*When compared to the average dB reading of other Jandy variables, speed pumps at 3450 RPM from 6 ft...

5 mall base with spacers included with all FloPro pumps. Large base is optional part R0544600, WEF – weighted energy factor in kgal/kWh. WEF is a performance-based metric adopted by the Department of Energy to characterize the energy performance of dedicated-purpose pool pumps. Department of Energy to CFR Parts 429 and 431.

Always follow local building and safety codes for pipe sizing and guidelines

Jandy.com | 1.800.822.7933

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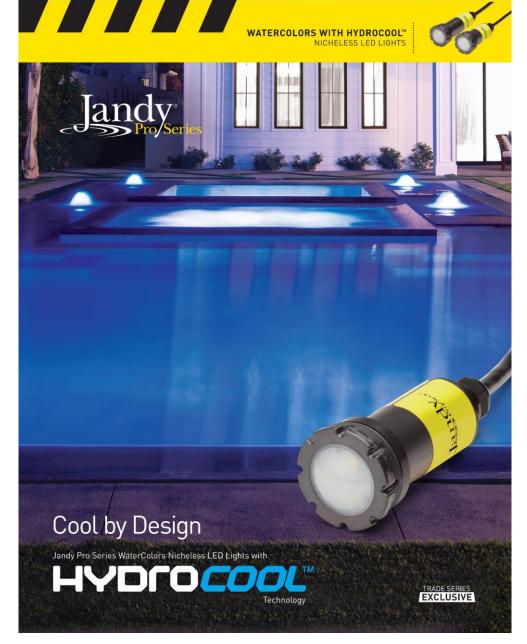













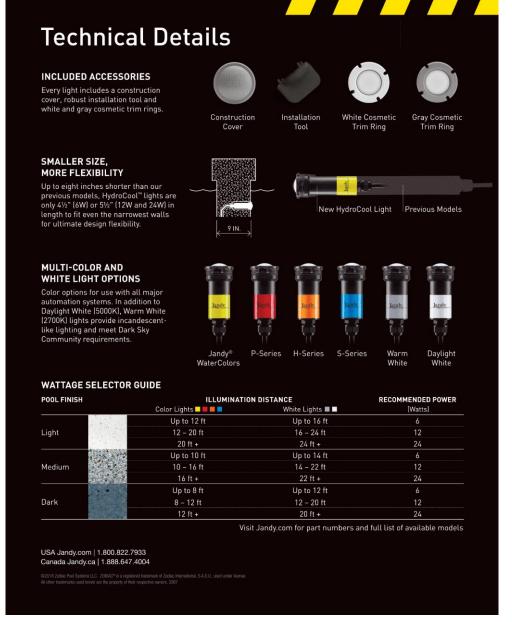










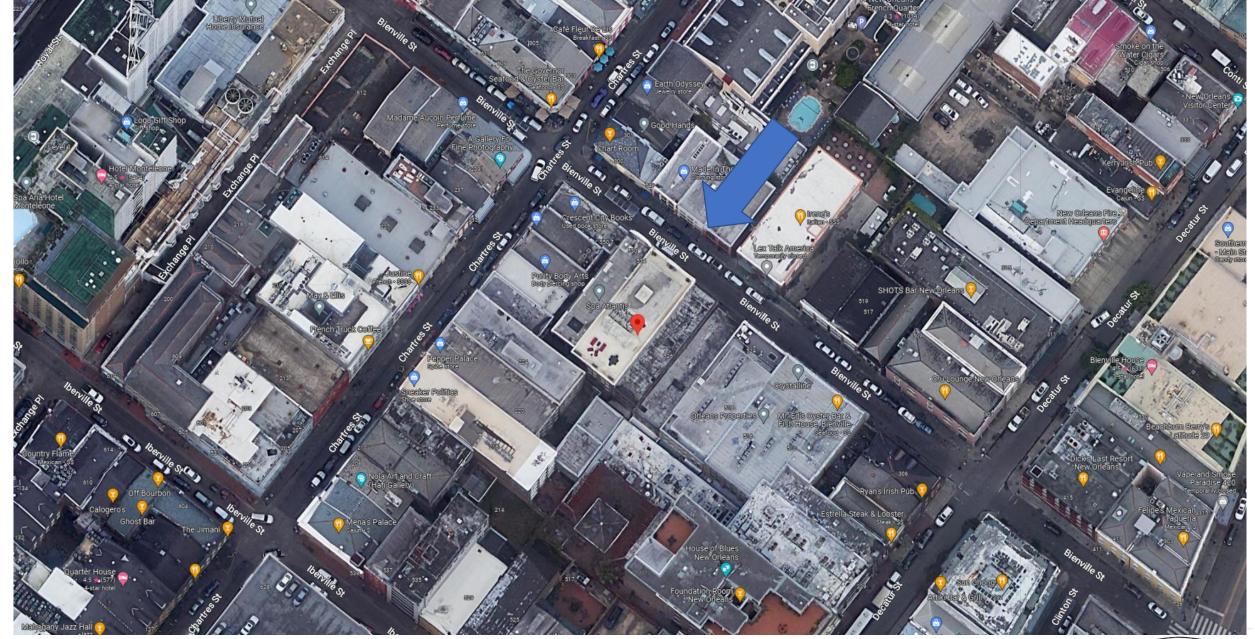

528 Bienville









CLEAR PENATRATING
WATER REPELLANT
FOR MASONRY WALLS
\* DOES NOT ALTER APPEARANCE

# Siloxane PD

Sure Klean\* Weather Seal Siloxane PD (predilute) is a ready-to-use, water-based silane/siloxane water repellent for concrete and most masonry and stucco surfaces. Siloxane PD will not impair the natural breathing characteristics of treated surfaces. It helps masonry resist cracking, spalling, staining and other damage related to water intrusion. Low color and alkaline stable, Siloxane PD is ideal for field and in-plant application.

#### TYPICAL TECHNICAL DATA

FORM	Cloudy white liquid, odorless
SPECIFIC GRAVITY	0.996
pH	4-5
WT/GAL	8.29 lbs
ACTIVE CONTENT	7%
TOTAL SOLIDS	4% ASTM D 5095
VOC CONTENT	<30 g/L Low Solids Coating
FLASH POINT	>212° F (>100° C) ASTM D 3278
FREEZE POINT	32° F (0° C)
SHELF LIFE	1 year in tightly sealed, unopened container

#### ADVANTAGES

- Penetrates deeply for long-lasting protection on vertical or horizontal surfaces.
- · Service life is estimated at more than 10 years.
- · Treated surfaces "breathe" does not trap moisture.
- Water-based formula minimizes explosion and fire hazards compared to solvent-based water repellents.
- Appropriate for use on manufactured stone surfaces.
- Resists water penetration when applied over existing shrinkage cracks of 0.02 inches or less.
- Easy cleanup with PROSOCO's 2010 All Surface Cleaner.

- · Low odor for safer application to occupied buildings.
- Alkaline stable suitable for new "green" concrete, 14–28 days old.
- · Ready-to-use. No on-site dilution required.

#### Limitation

- Will not keep water out of cracks, defects or open joints.
- Not appropriate for use on limestone, marble, travertine or other calcareous stones. Always test other natural stone to ensure desired results.
- · Not recommended for below-grade application.
- Not suitable for application to synthetic resin paints, gypsum, or other non masonry surfaces.

## REGULATORY COMPLIANCE

#### **VOC Compliance**

Sure Klean® Weather Seal Siloxane PD is compliant with the US Environmental Protection Agency's AIM VOC regulations. Visit www.proscco.com/voccompliance to confirm compliance with individual district or state regulations.




NOTE. The SWR Institute Validation Program uses standardized testing for validation purposes, including testing on CMU. PROSOCO doss.not recommend the use of Siloxane PD on CMU. Please reference the Substrate Chart on page 2.

Product Data Sheet • Page 1 of 3 • Item #40027 - 122122 • ©2022 PROSOCO, Inc. • prosoco.com








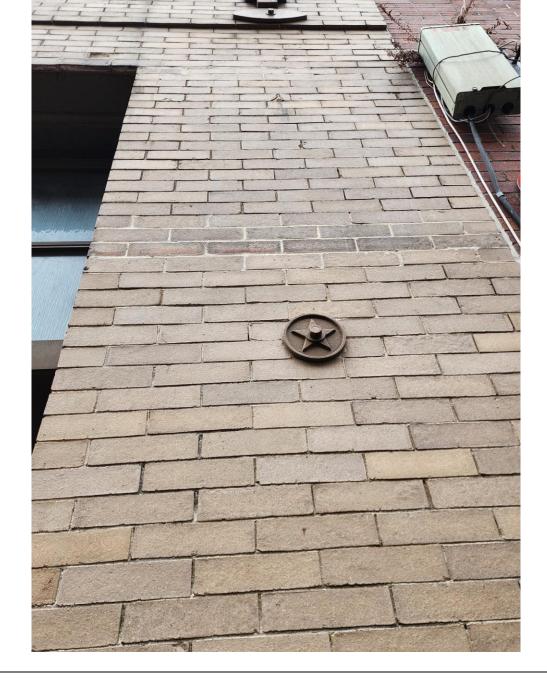



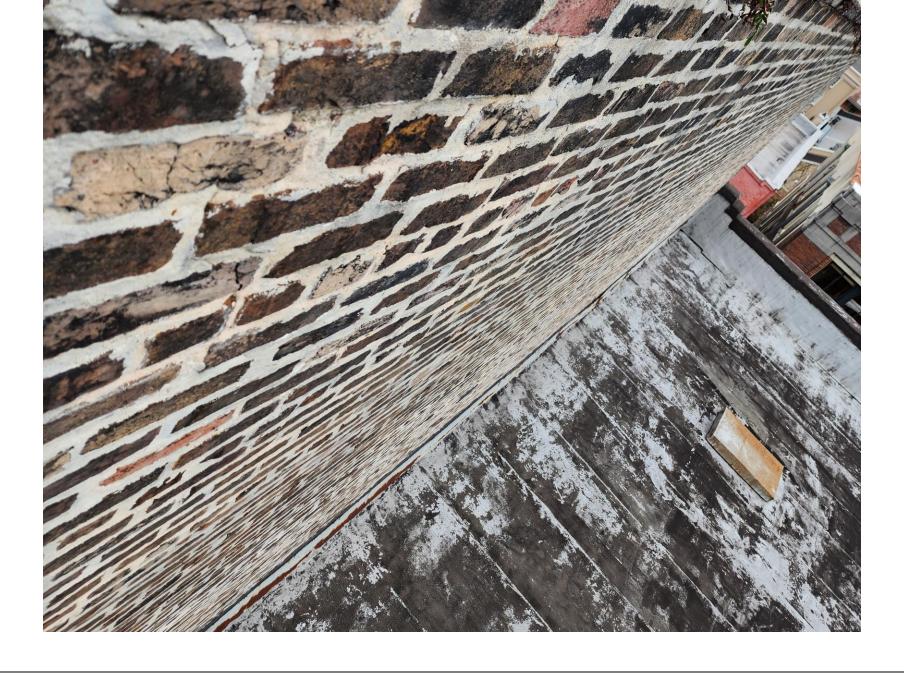









528 Bienville



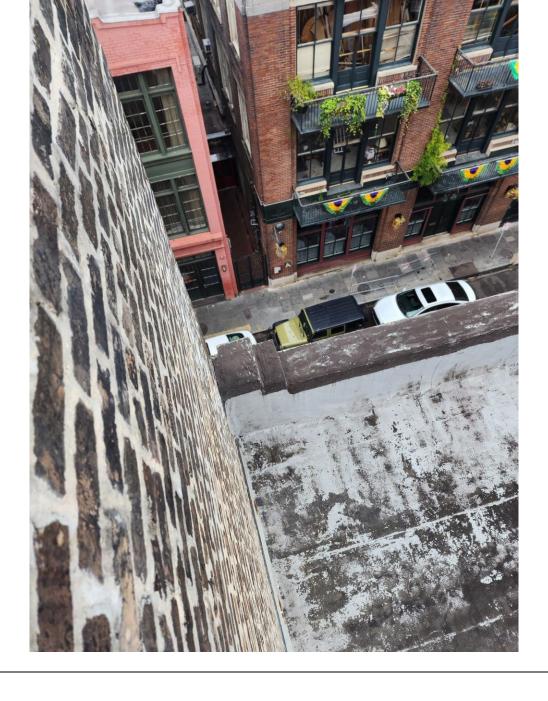



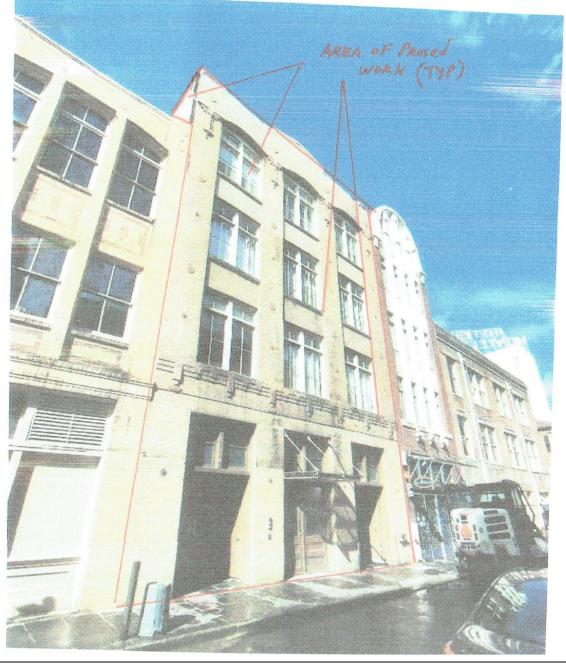


528 Brenville ST

528 Bienville








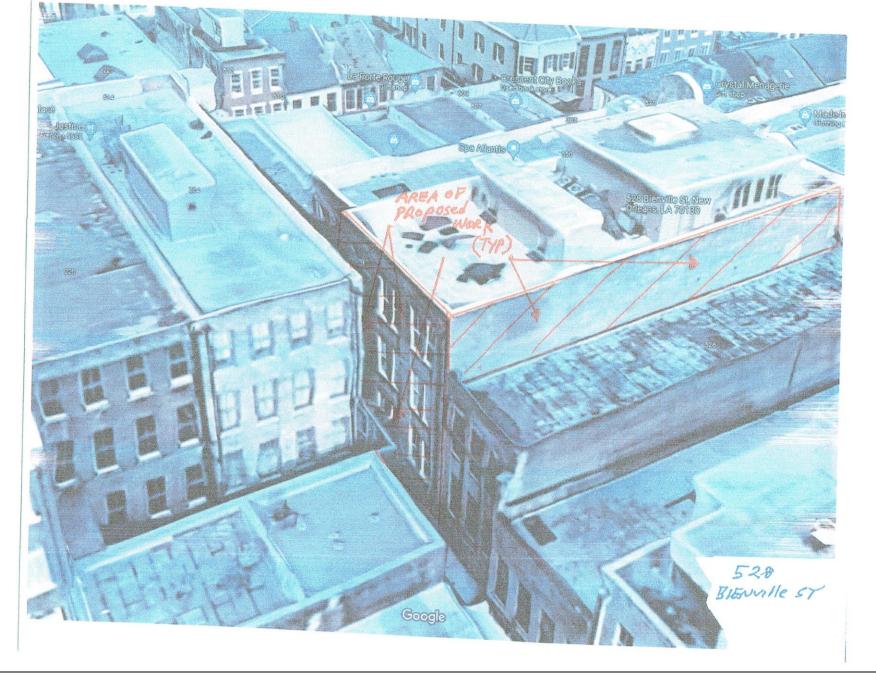








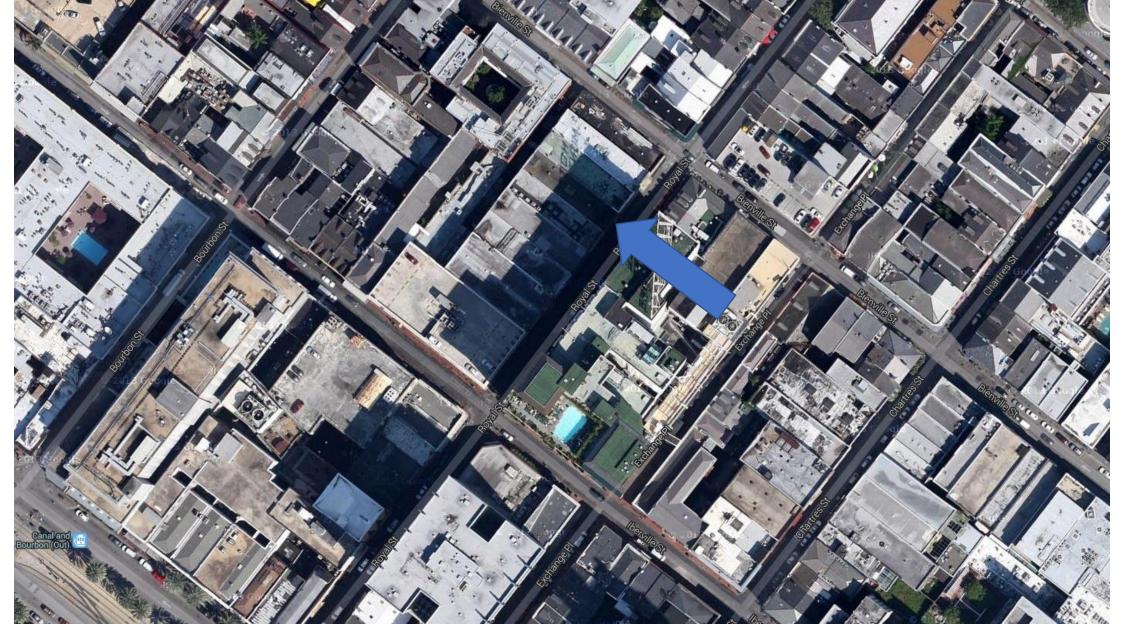






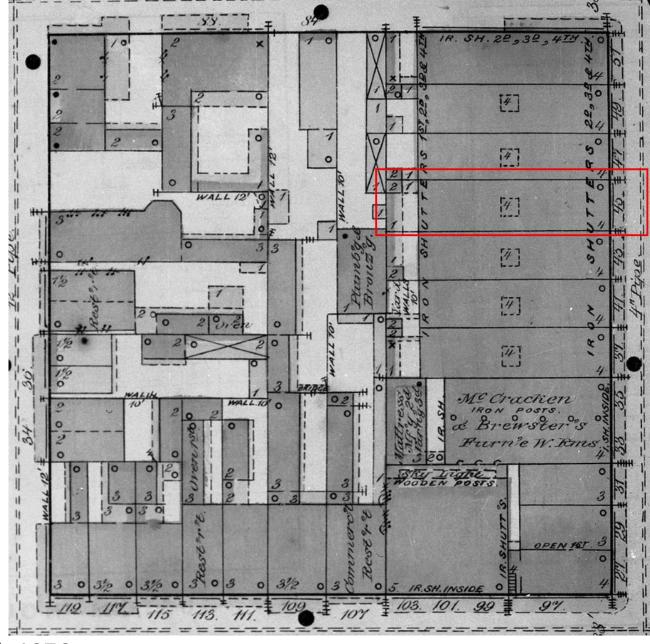






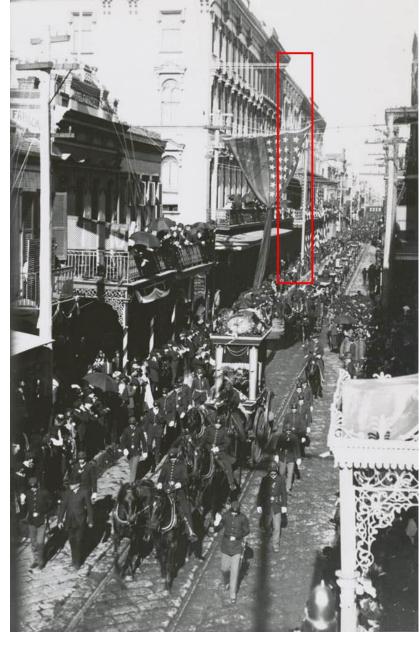






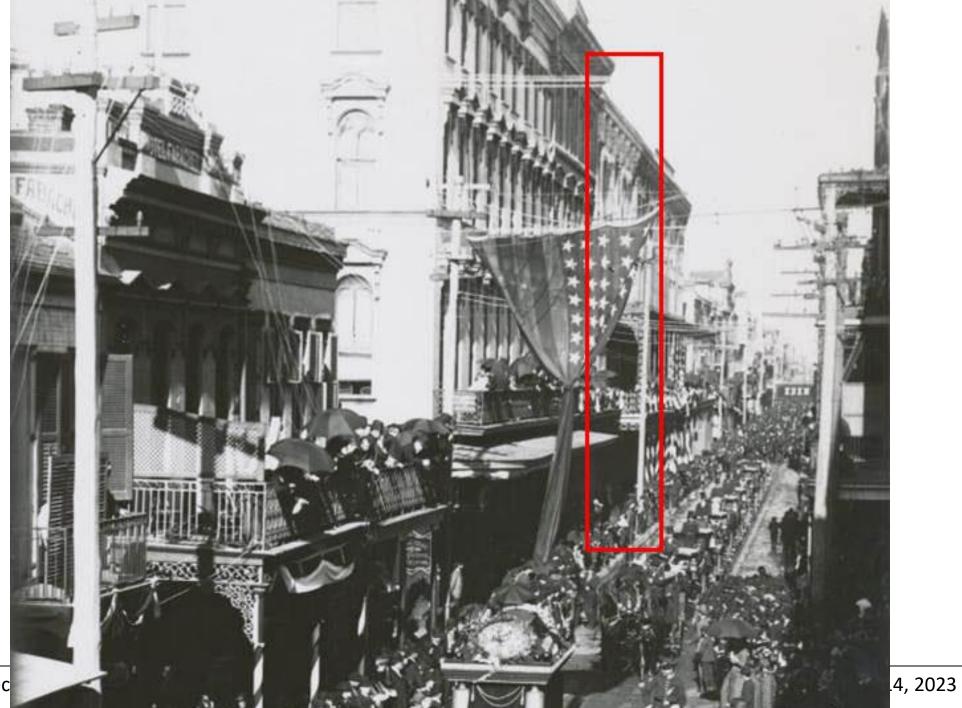







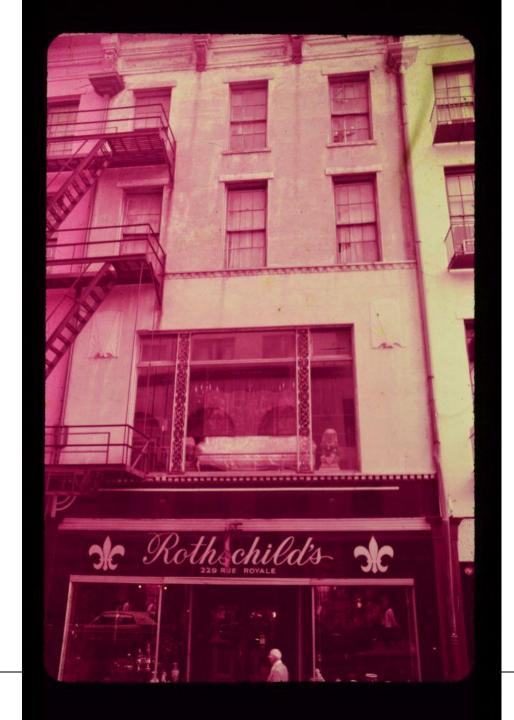

229 Royal, 1975














229 Royal









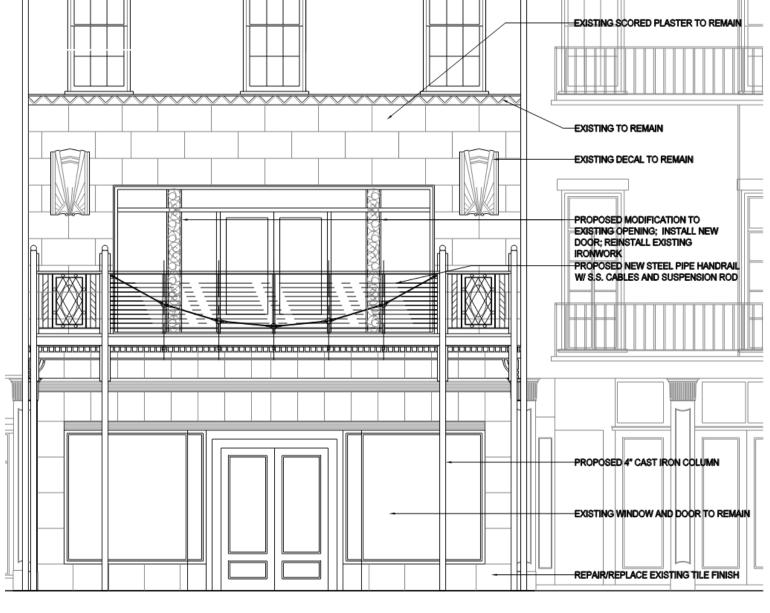

229 ROYAL ST. PROPOSED

233 ROYAL ST.





229 ROYAL ST. PROPOSED


233 ROYAL ST.





229 Royal – Side by Side

VCC Architectural Committee

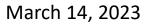

# ALTERATIONS TO 229 ROYAL ST.

# 229 ROYAL STREET

# NEW ORLEANS, LOUISIANA

### **GENERAL NOTES:**

#### PROJECT ADDRESS 229 ROYAL STREET

NEW ORLEANS, LA 70130

#### PROJECT DESCRIPTION

THE SCOPE OF THE PROJECT IS TO RENOVATE AN EXISTING FOUR STORY STRUCTURE LOCATED IN THE FRENCH QUARTER, THE SCOPE OF WORK INCLUDES THE ENTIRE STRUCTURE. THE WORK TO BE PERFORMED INCLUDES INTERIOR LAYOUT MODIFICATIONS, NEW KITCHEN EQUIPMENT AND NEW INTERIOR FINISHES, PLUMBING, HVAC AND ELECTRICAL WORK SHALL BE PERFORMED. NEW SPRINKLER SYSTEM AND FIRE ALARM TO BE INSTALLED WITH NO STRUCTURAL WORK BEING DONE.

#### ZONING

RS.2 CITY OF NEW ORLEANS, VCC-2

#### **BUILDING AREA**

FIRST FLOOR: 3,190 GROSS SQ. FT. SECOND FLOOR: 2,937 GROSS SQ. FT. THIRD FLOOR: 2,832 GROSS SQ. FT. FOURTH FLOOR: 2,832 GROSS SQ. FT. FIFTH FLOOR/ROOF TERRACE 2,294 GROSS SQ. FT.

## OCCUPANCY

## A. CLASSIFICATION

ASSEMBLY GROUP A-2 FIRST & SECOND FLOORS: THIRD FLOOR; FOURTH FLOOR: FUTURE LEASE SPACE BUSINESS B. LOAD FIRST FLOOR: 120 SECOND FLOOR: 115 THIRD FLOOR: FOURTH FLOOR:

48

TYPE IIIA

#### CONSTRUCTION TYPE IBC CLASSIFICATION.

FIFTH FLOOR/ROOF TERRACE

III (211) ARCHITECTURAL APPLICABLE CODES INTERNATIONAL BUILDING CODE (IBC) - 2023 EDITION

#### LIFE SAFETY CODE (NFPA 101) - 2015 EDITION SPRINKLER NFPA 13

#### EXIT REQUIREMENTS

COMMON PATH SHALL NOT EXCEED 20 FT ALLOWABLE DEAD END DISTANCE 20 FT ALLOWABLE TRAVEL DISTANCE

#### PROJECT DIRECTORY:

MCC REAL ESTATE 3330 N CAUSEWAY BLVD., SUITE 400 METAIRIE, LA 70002 504.833.2805 RYAN JAEGER rjaeger@mccgroup.com CHRISTIN WILLIE (INTERIORS)

#### ARCHITECT

cwillie@mccgroup.com

JOHN C. WILLIAMS ARCHITECTS, LLC 824 BARONNE STREET NEW ORLEANS, LA 70113 504.566.0888 JOHN C. WILLIAMS icwilliams@williamsarchitects.com SARA BEAMAN sbeaman@williamsarchitects.com

#### STRUCTURAL ENGINEER

WALTER ZEHNER & ASSOCIATES INC 4702 TOULOUSE STREET NEW ORLEANS, LA 70119 504,488,1442 504,488,1448 FAX WALTER ZEHNER walterzehner@msn.com

#### MECHANICAL ENGINEER

ALL-TEMP REFRIGERATION SERVICES 271 HIGHWAY 1085 MADISONVILLE, LA 70447 LOUIS P. VERGES lverges@alltempexperts.com

#### ELECTRICAL ENGINEER

3330 NORTH CAUSEWAY BOULEVARD METAIRE, LA 70002

504.830.4210 HERB SCHAEFFER herb@mccgroup.com

### SHEET INDEX

COVER SHEET

REFLECTED CEILING, PROPOSED & DEMOLITION FIRST FLOOR PLANS

REFLECTED CEILING, PROPOSED & DEMOLITION SECOND FLOOR PLANS

EXISTING & PROPOSED ROYAL ST ELEVATIONS EXISTING & PROPOSED ROYAL ST ELEVATIONS

#### SYMBOL LEGEND

(	ELEVATION TAG
03 A401	SECTION TAG
RES	ROOM TAG
(E	EXTERIOR DOOR / WINDOW TAG
(A	DOOR TAG



IOHN C WILLIAMS

504,566,0888 PHONE 504,566,0897 FAX

(will) (will not) be providing project postsyction administrative services on the

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ALTERATIONS TO 229 ROYAL ST.

o. Date Scope 02-13-2023 DESIGN REVISE DRAWING TITLE: TITLE PAGE

JOB No.:

DATE: 02-13-2023 DRAWING No.:

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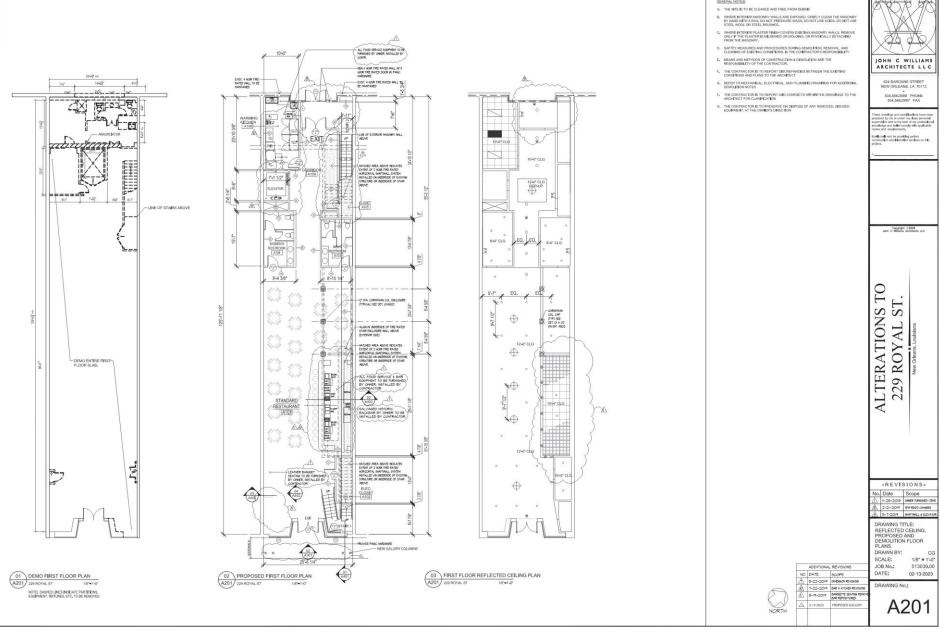
VICINITY MAP

PROJECT LOCATION 229 ROYAL STREET




229 Royal – Current Proposal

**VCC Architectural Committee** 







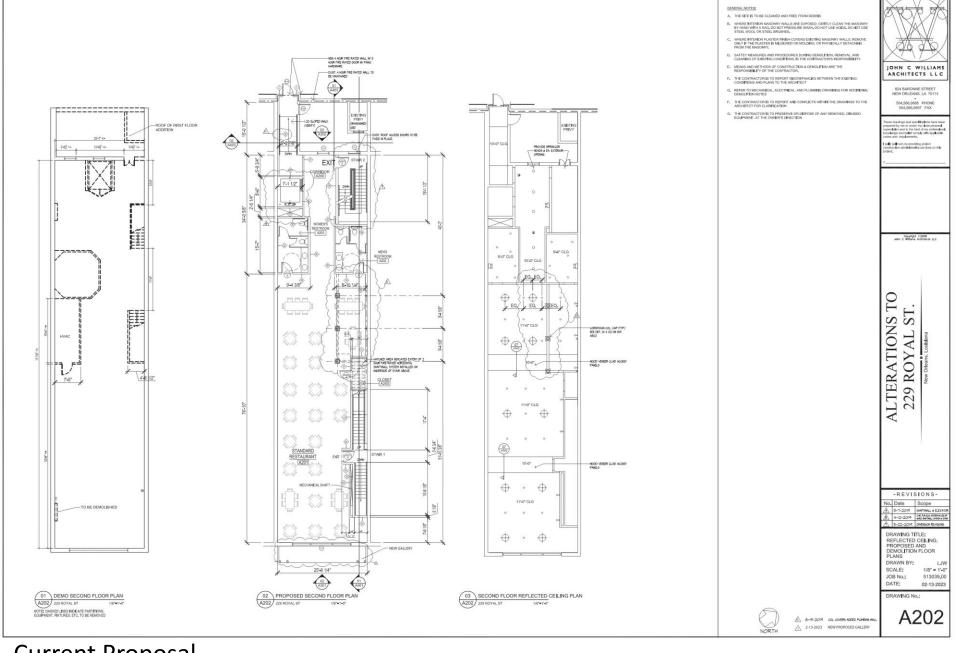


229 Royal – Current Proposal

4, 2023







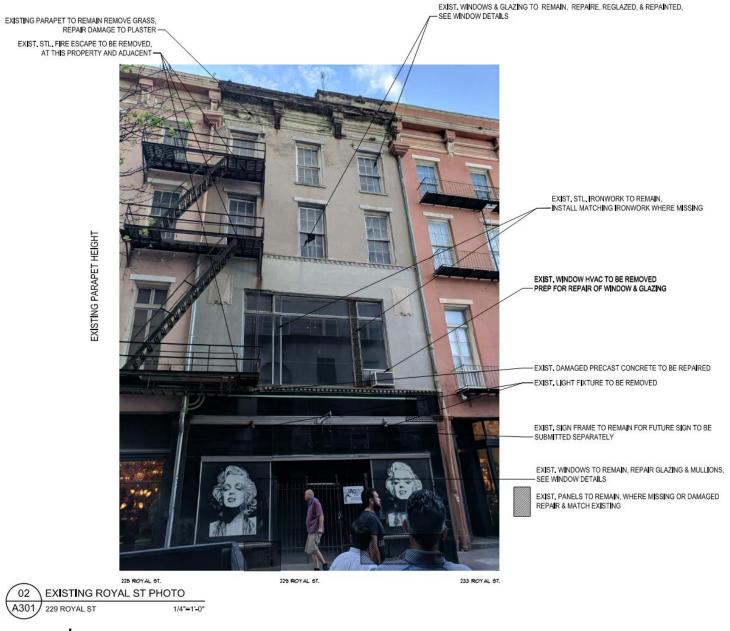







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ALTERATIONS

-REVISIONS-

DRAWING TITLE: EXISTING & PROPOSED ROYAL ST ELEVATIONS

JOB No.: DATE: 02-13-2023

DRAWING No.:

A301.1


1/8" = 1'-0"

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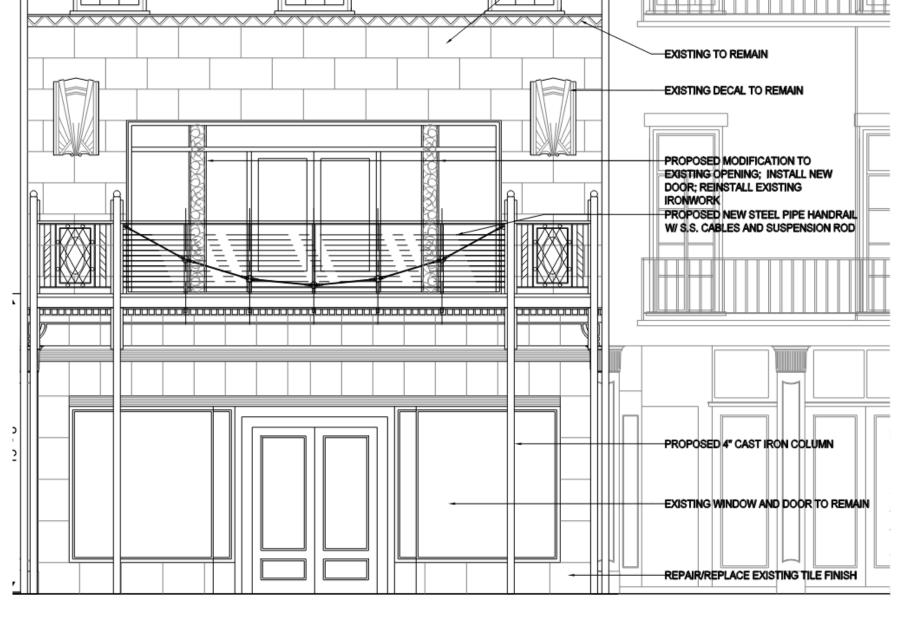
PROPOSED EXTERIOR ELEVATION SCALE: 1/4"=1'-0" A301

229 Royal – Current Proposal

**VCC Architectural Committee** 



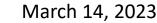





229 ROYAL ST. PROPOSED


233 ROYAL ST.



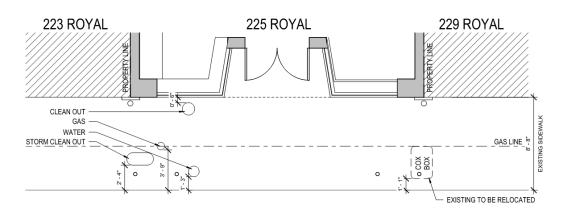


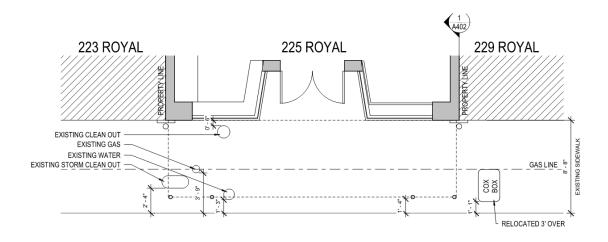



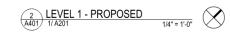




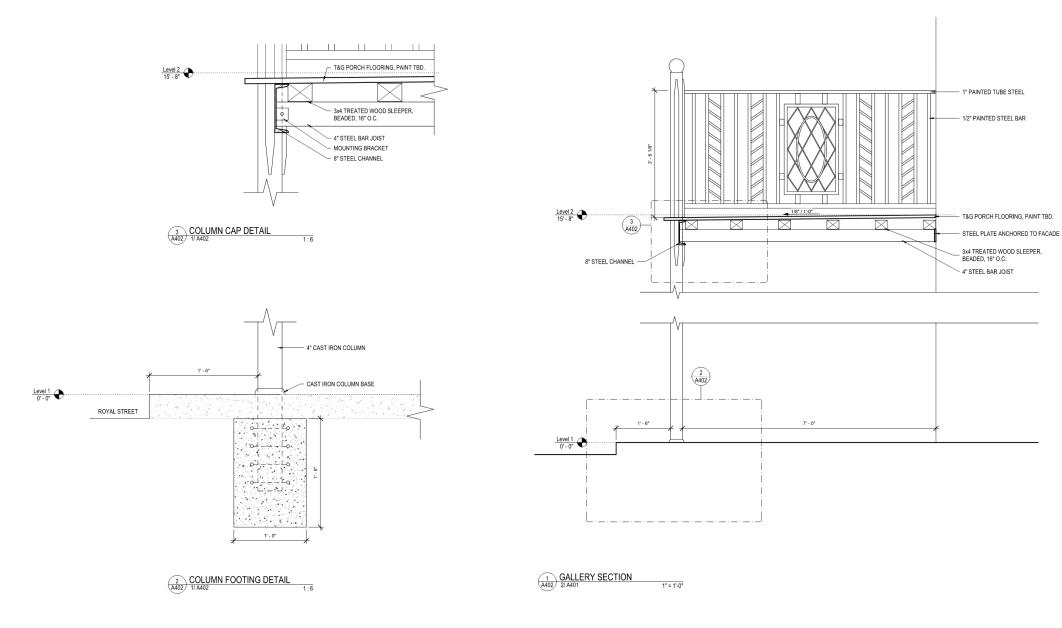

Copyright © 2022 John C Williams Architects LLC GALLERY ADDITION 229 ROYAL ST Project Status -REVISIONS-DRAWING BY SCALE JOB No. DATE SHEET NAME Author As indicated 500001 02/28/23 GALLEY DETAILS


A402

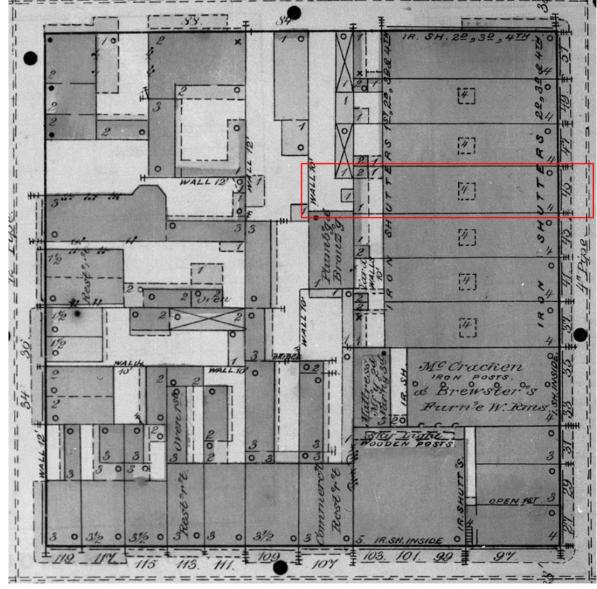

1876 SANBORN MAP


(BEFORE THE CURRENT ADDRESS SYSTEM)


1908-1909 SANBORN MAP
(GALLERY DEMOLISHED BY 1929 SANBORN MAP)

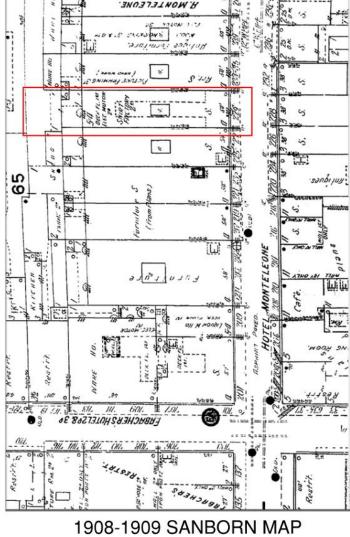

- WISHED

229 Royal – Current Proposal

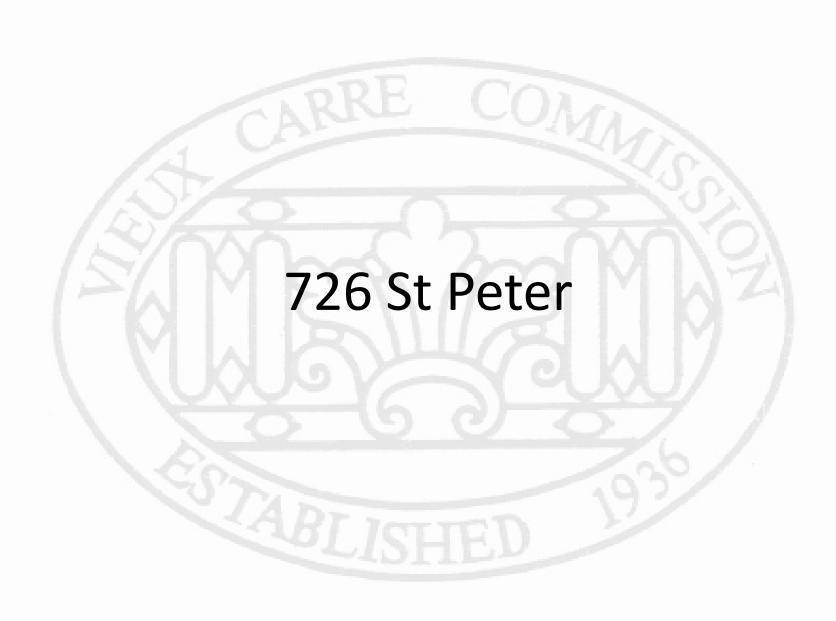


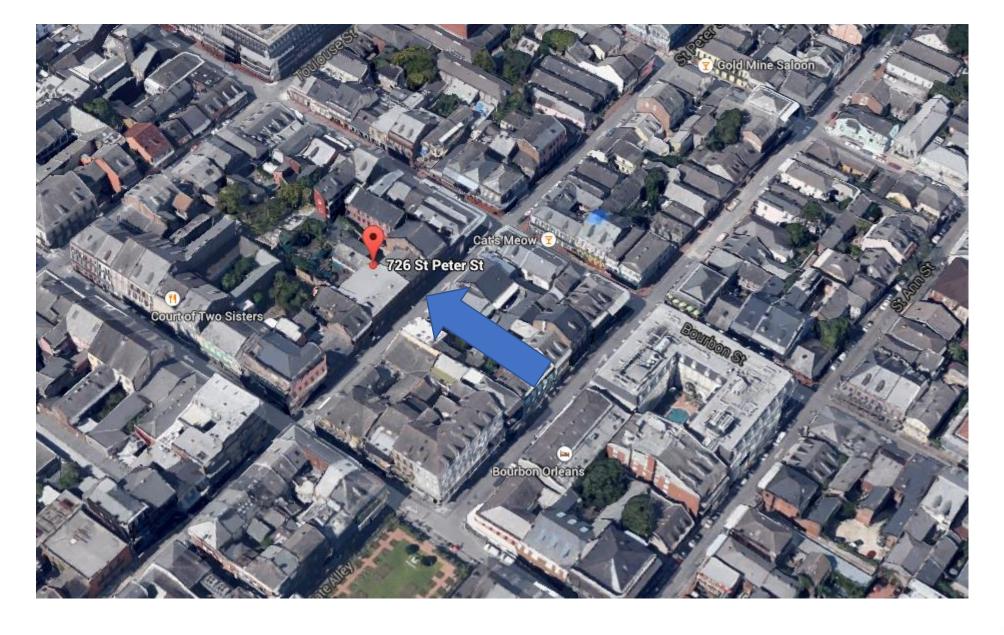







726 St. Peter

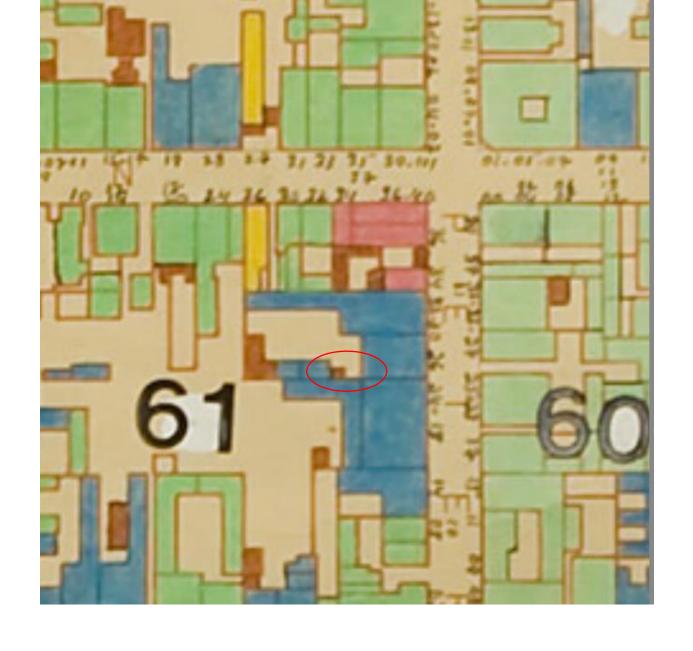

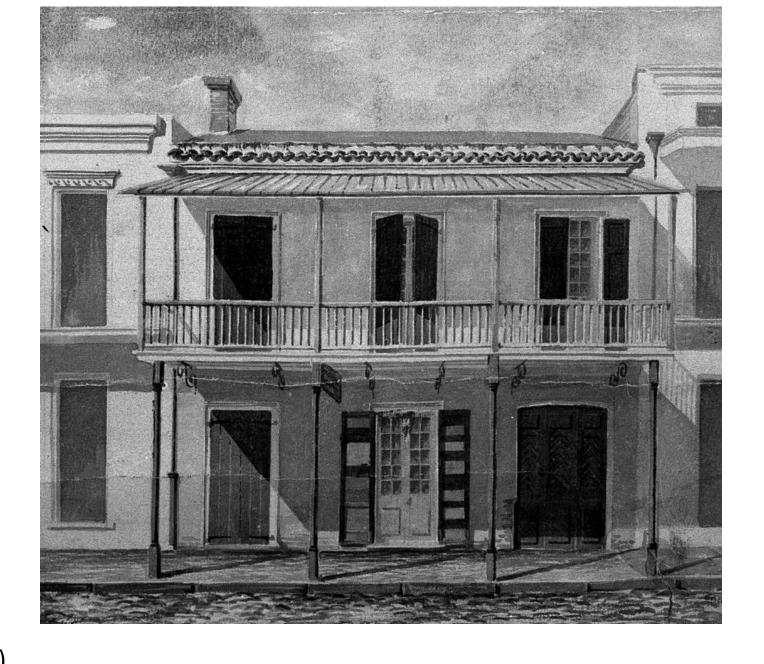





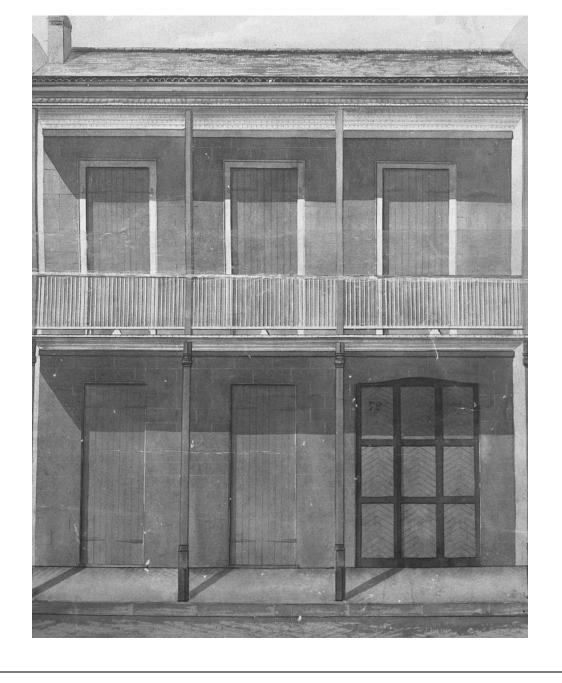







726 St. Peter (c. 1900)


















































































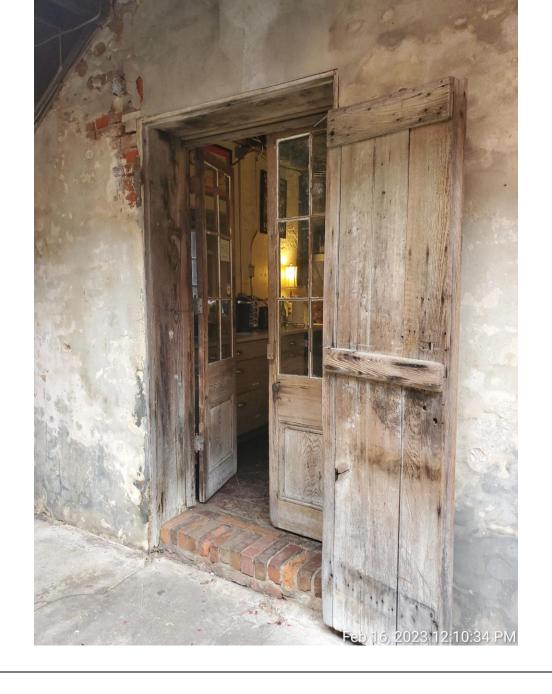





























## 726 ST PETER ST - VCC SET



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3 41 <sub>12</sub> 15	







PROJECT DIRECTORY & INFO

GENERAL CONTRACTOR

PROJECT ADDRESS 726-736 ET PETER STREET


CONSTRUCTION THREE


BUILDING CODE REQUIREMENTS NOT LIMITED TO THE FOLLOWING: 2213 INTERNATIONAL BURDING CODE-JISC 2213 INTERNATIONAL BURDING CODE-JISC 2213 INTERNATIONAL STREET CODE CITT OF NOV ORIEDAN COMPTIBLE BURDING CORREST ORDERANCE 1360 SF 1192 SF 144 SF 1455 SF 620 SF 1457 SF 6228 SF

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PRESERVATION HALL
726 ST PETER STREET NEW ORLEANS, LA
70112






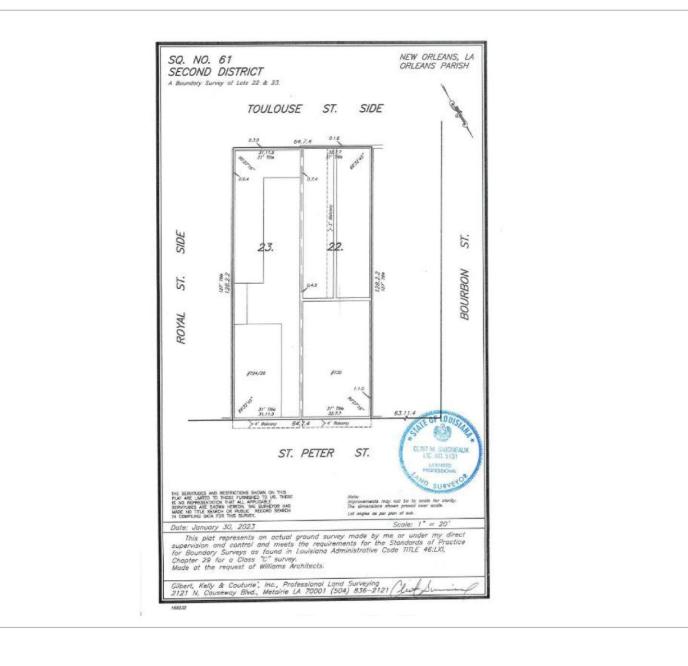
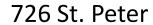
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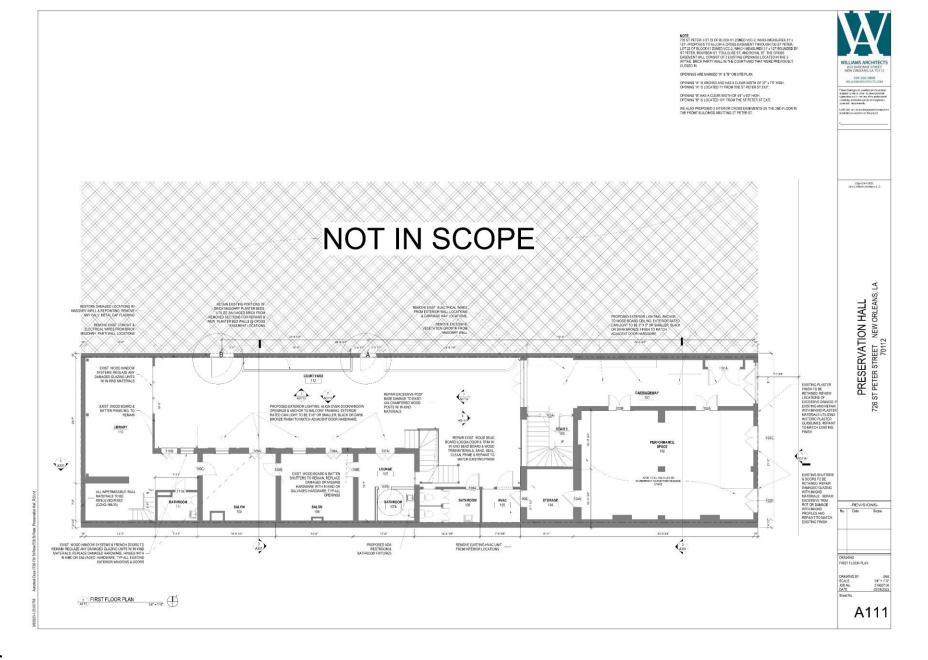
Coopegit G 2025 John C Villiana Actions ( ) C


PRESERVATION HALL
726 ST PETER STREET NEW ORLEANS, LA
70112



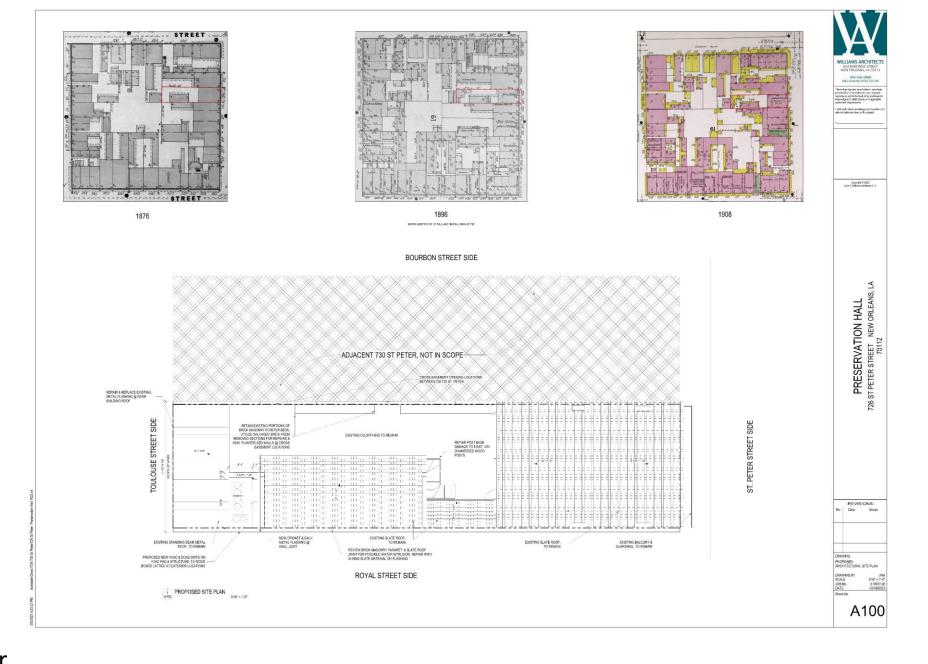






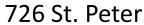




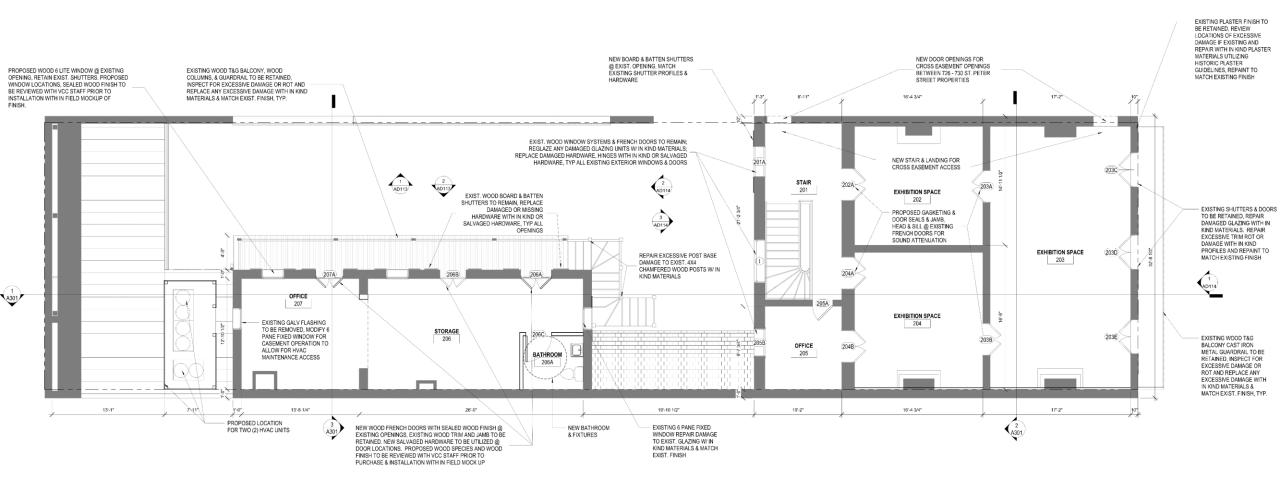


1 SECOND FLOOR PLAN
A112/ 1/4" = 1"

726 St. Peter



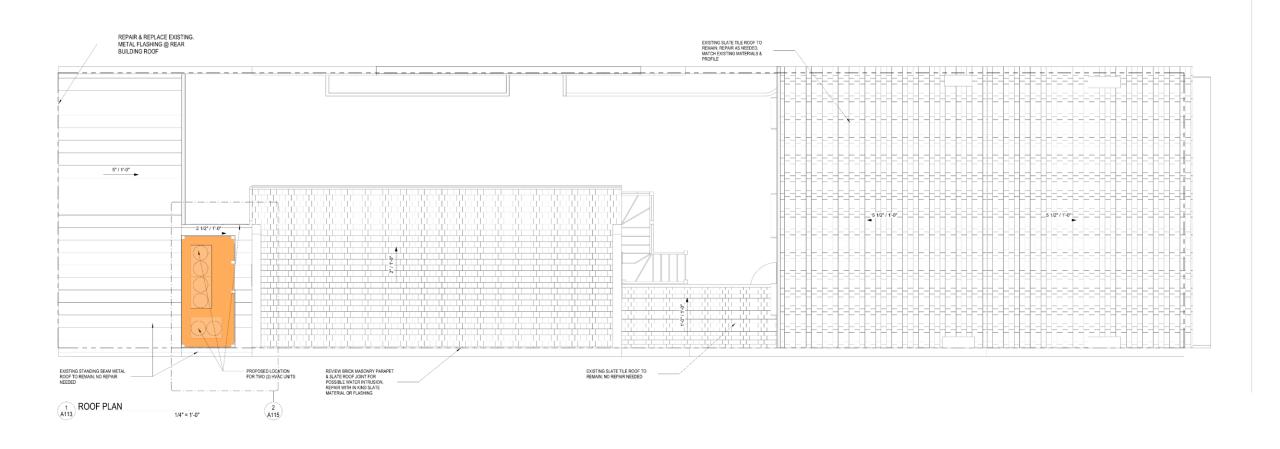


## 726 St. Peter

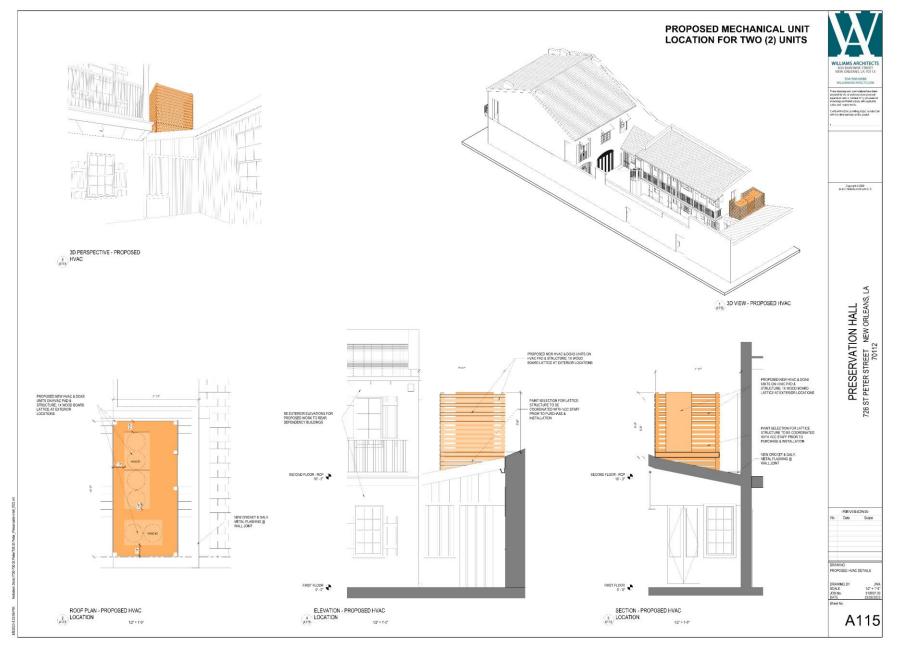






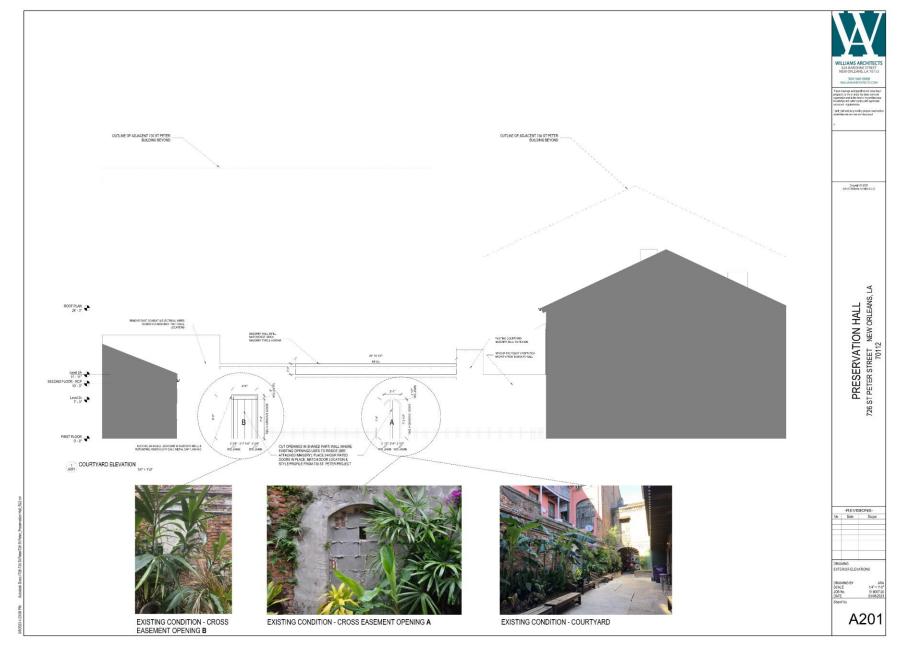








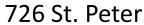



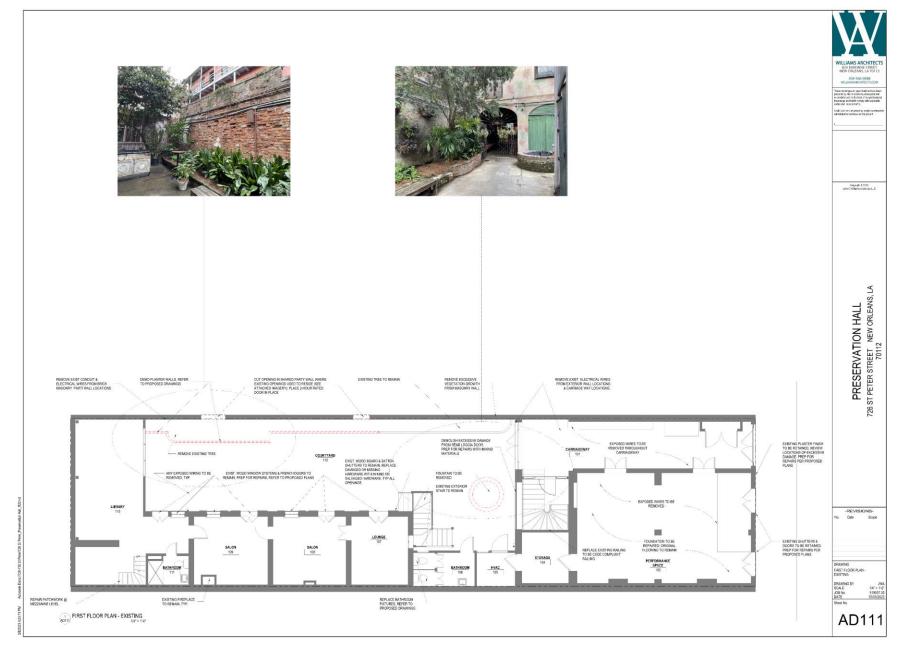













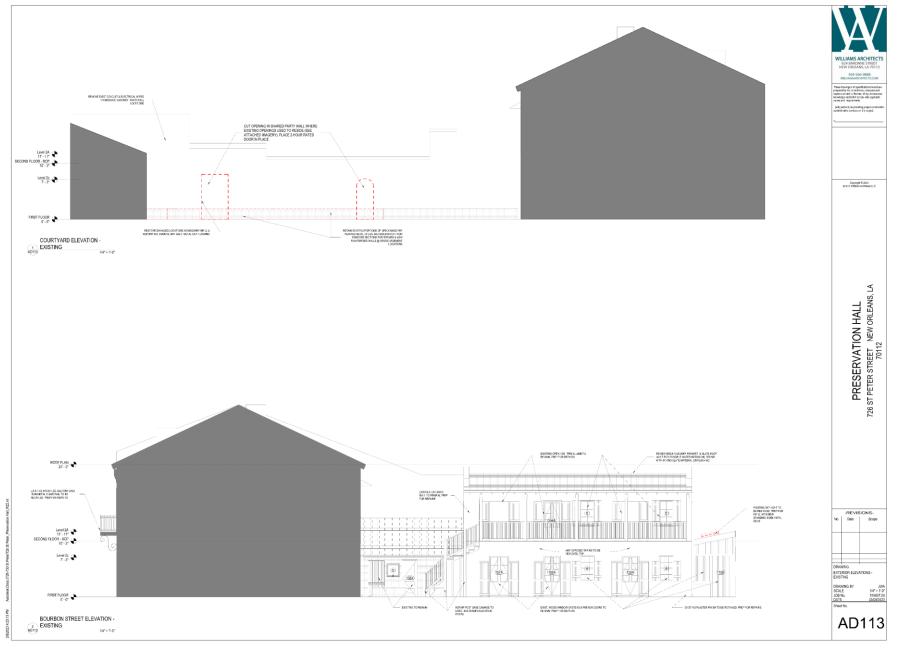






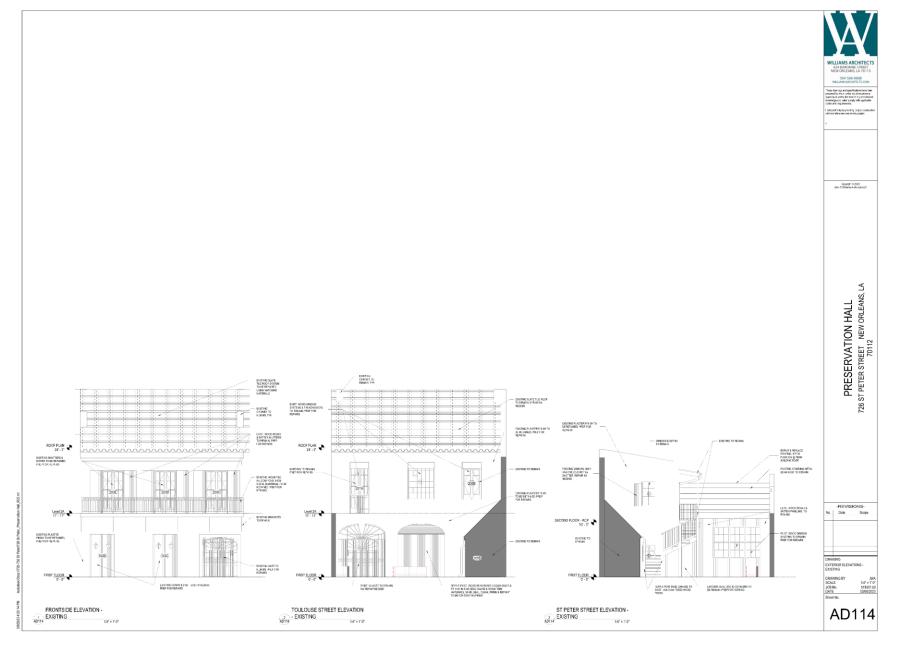









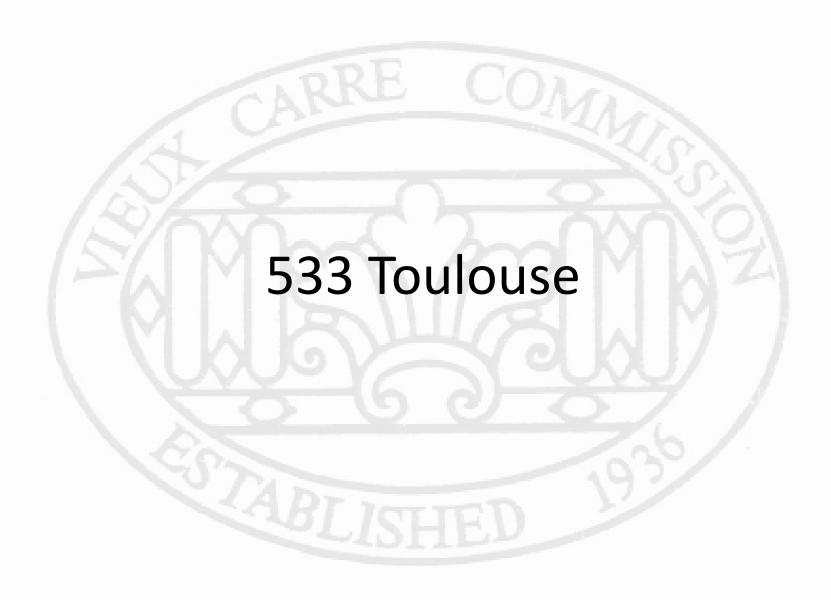


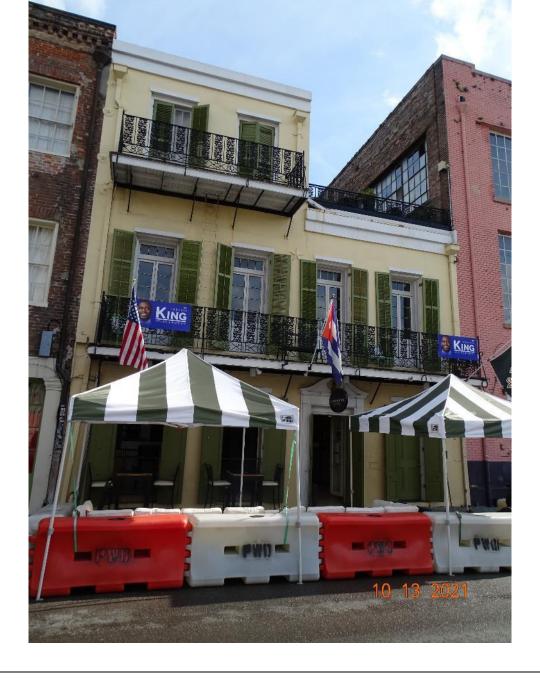




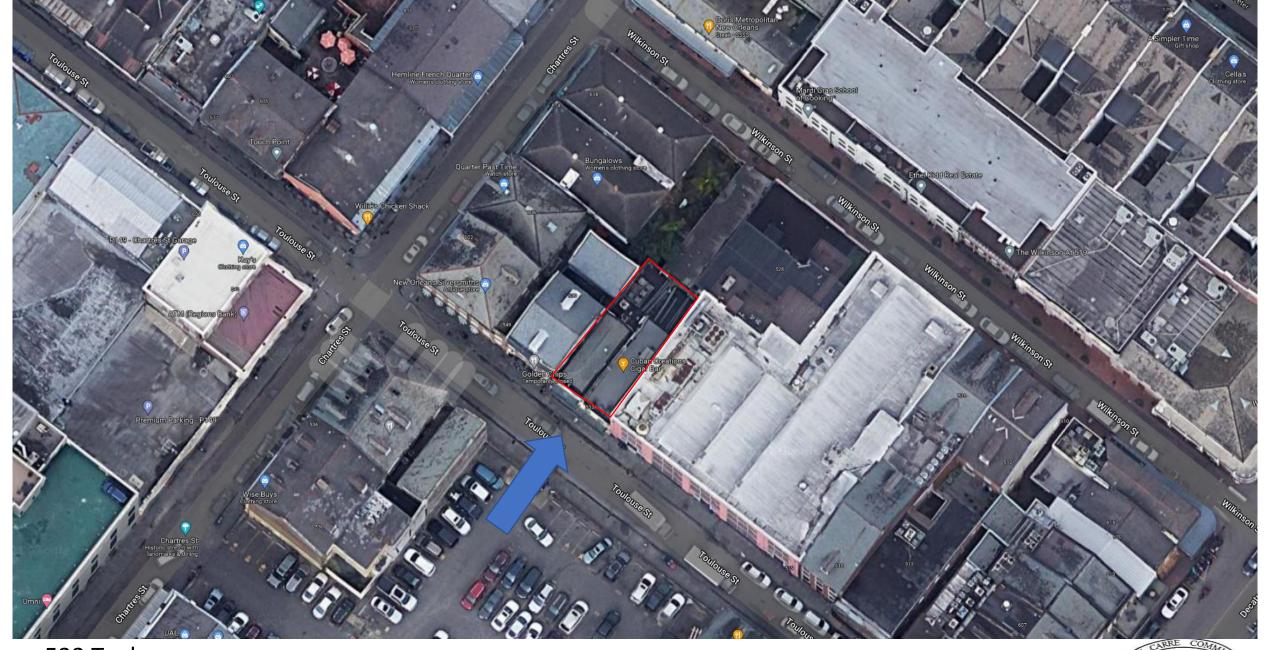

533 Toulouse

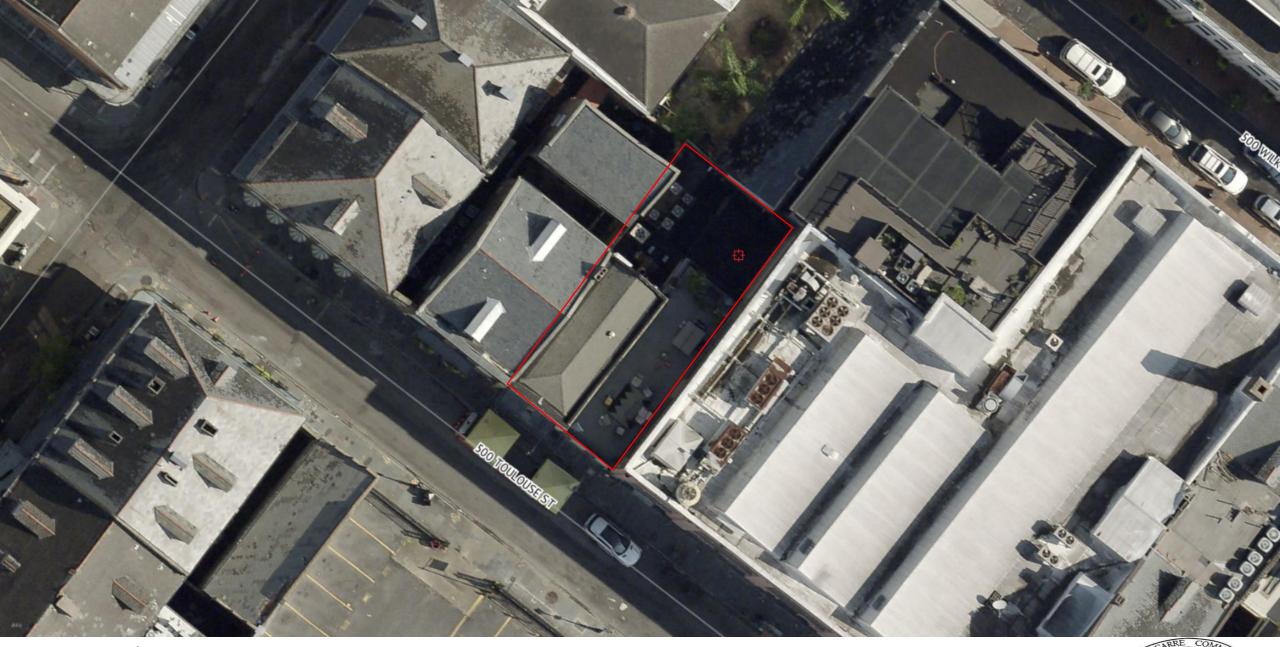

533 Toulouse

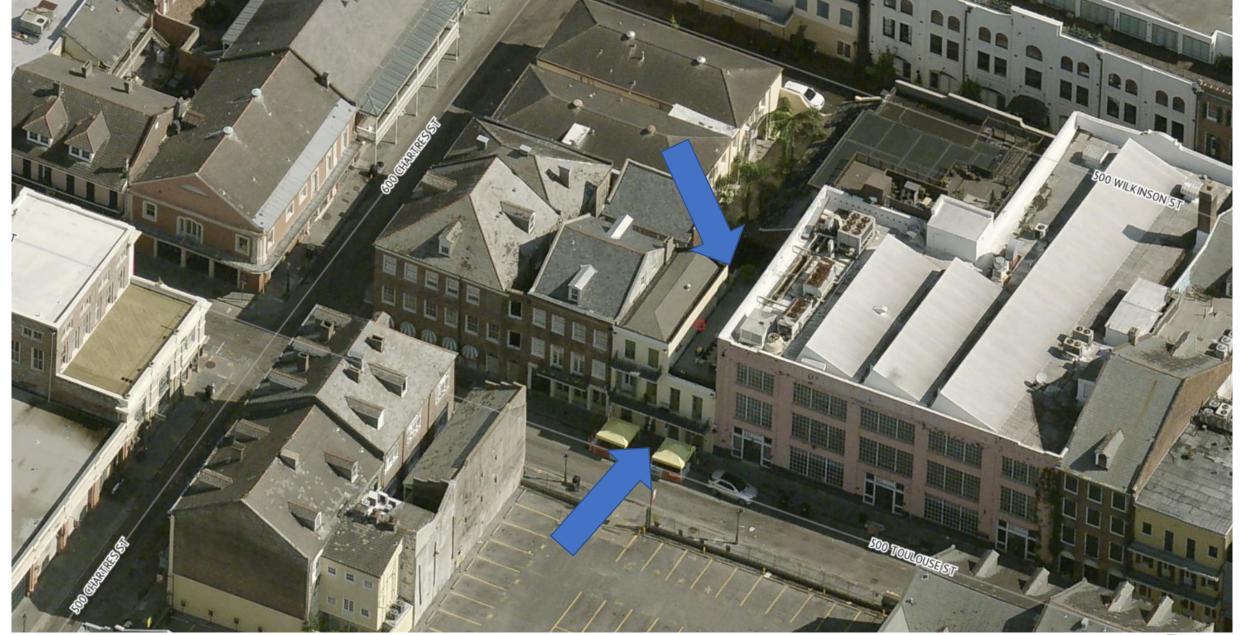


533 Toulouse





533 Toulouse – 2013 prior to deck installation



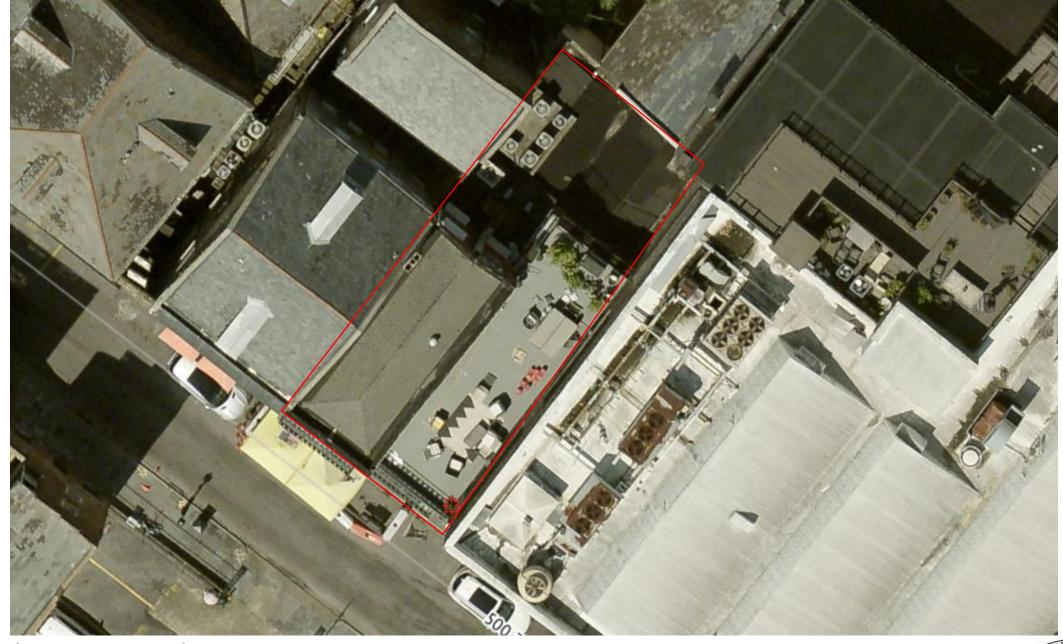


533 Toulouse – September 2021

VCC Architectural Committee






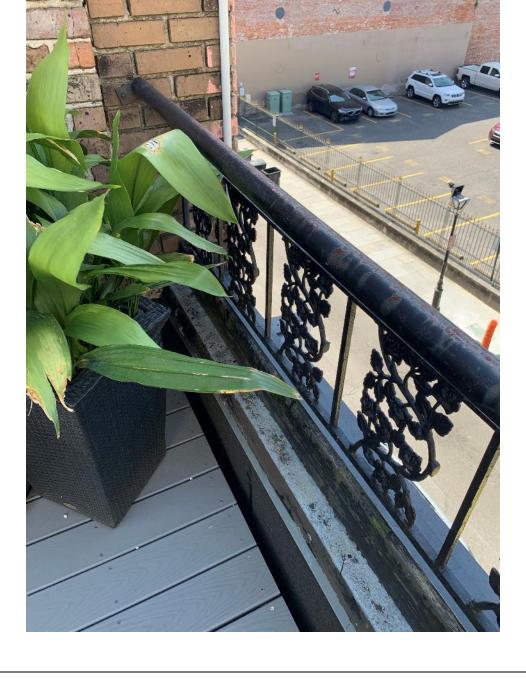






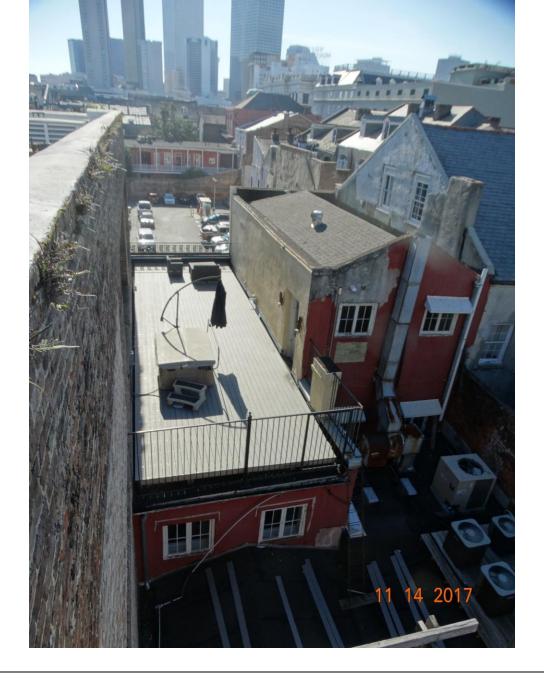





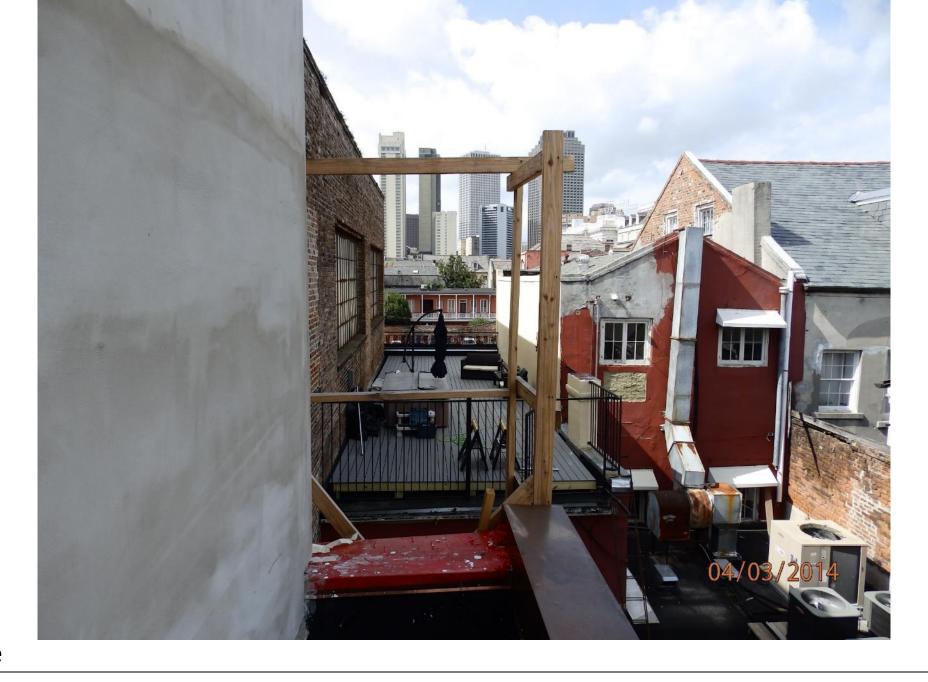













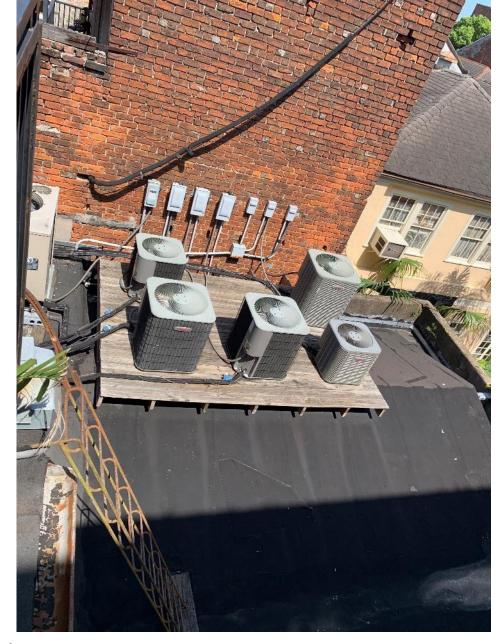



533 Toulouse




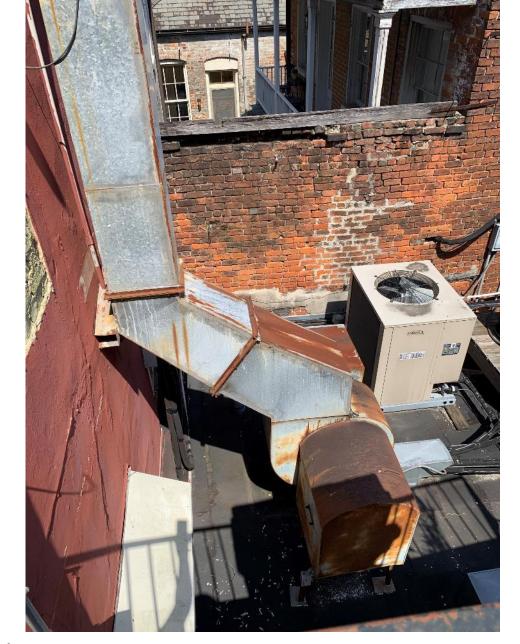



533 Toulouse



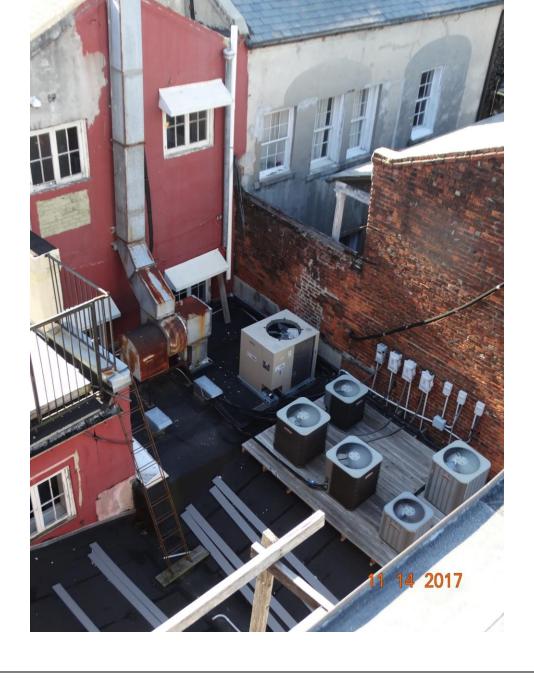





<b>Working Without Approval</b>	Description of Violation	Method of Abatement
-New Construction	Roof deck constructed without approval	Retain deck per architectural drawing remove hot tub.
Roof	Impermissible roof material installed/constructed without benefit of VCC review or approval, or in deviation from permit.	Replace roll down roofing on hip roof rear section with galvanized standing seam metal roof. Replace asphalt roof on three story section of building with Inspire slate in Mist Grey 803 per attached spec sheet.
Railings	Impermissible removal/alteration/installation/construction of the balcony/gallery without benefit of VCC review or approval, or in deviation from permit.	Remove unpermitted railing extension on parapet of 2 story section, per architectural drawing.
Security Cameras	Security camera(s) installed without benefit of VCC review or approval. Permit approval with the VCC is required before installing security cameras.	Retain security cameras on balcony facia of front façade. Remove dome security camera on arm and replace with cylindrical style camera to match cameras installed on front façade. Relocate camera on outside of balcony facia to underside of balcony.
Lighting	Impermissible light fixtures installed.	Remove all impermissible neon and string lights.
HVAC/Mechanical/Vents	HVAC/mechanical equipment/vents/racks installed without benefit of VCC review or approval or in deviation from permit.	Per City records AC condenser units, and hood vent were permitted in 2012.  Application to retain mechanical systems in place. Paint venting yellow to match building color. See architectural drawings.
Metal Cap Parapet Flashing	Impermissible alteration/installation/construction of flashing without benefit of VCC review or approval, or in deviation from permit.	Remove cap flashing from parapet wall. Inspect mortar cap and repair if needed per VCC guidelines on parapet mortar caps.

<b>Demolition by Neglect</b>	Description of Violation	Method of Abatement
Stucco	Stucco damage/deterioration/deformation present on the building(s)/property.	Repair cracked stucco on 3-story section rear, Wilkinson facing wall, using VVC stucco mix paint to match front façade yellow.
Windows	Window/window trim missing or damage/deterioration/deformation present on the building	Clean, repair and paint wood window to match existing on front and rear façade.
Trim	Trim/wooden trim damage/deterioration/deformation present on the building(s)/property.	Clean, repair and paint wood trim to match existing on front and rear façade.
Shutters	Damaged, deteriorated shutters	Repair shutters and louvers on front facade to match existing and paint to match.
Balconies	Balcony damage, deterioration present	Inspect balcony for damaged/rotten wood elements, replaced wood tung and groove decking as needed, replace facia and trim as needed, to match is material


## 533 Toulouse



		profile and shape, paint to match existing.
Paint		Paint rear wall of 3-story section yellow to match front façade. Remove vegetation.
	building(s)/property.	Paint all other walls, trim, windows, and shutters as needed to match existing.
Sign	Business sign installed without approval	Sign permit application to be made separately by tenant.





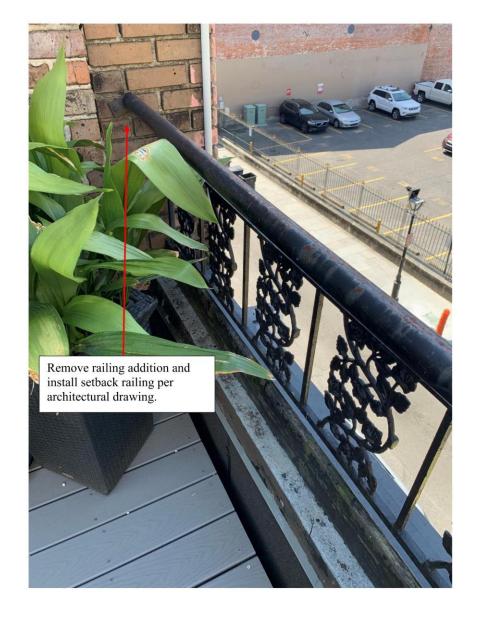























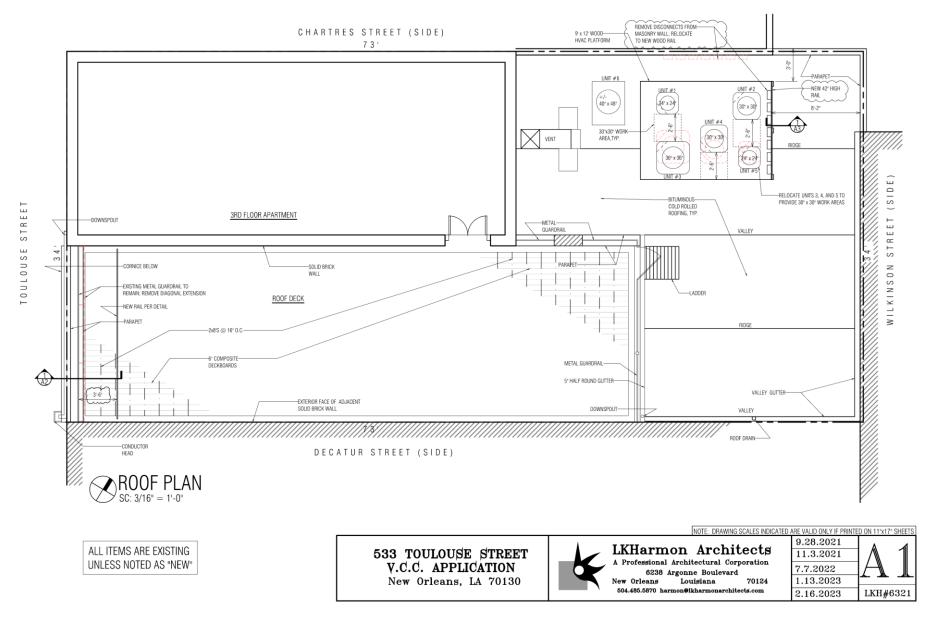






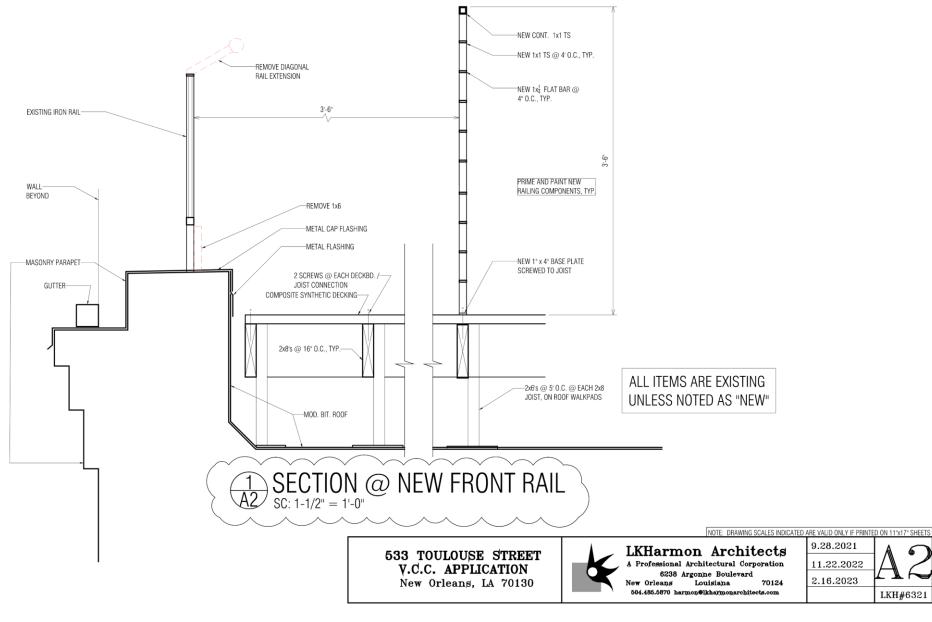

533 Toulouse



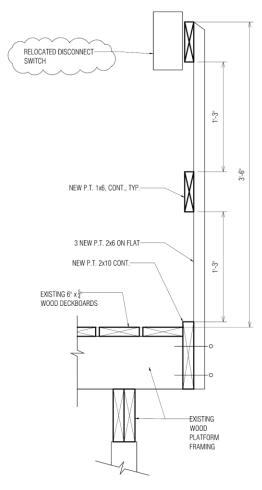

SECTION NEW HVAC PLATFORM RAIL

SC: 1-1/2" = 1'-0"

V.C.C. APPLICATION
New Orleans, LA 70130



NOTE: DRAWING SCALES INDICATED ARE VALID ONLY IF PRINTED ON 11\*x17\* SHEETS

Architects


1.7.7.2022


1.13.2023

LKH#6321

533 Toulouse



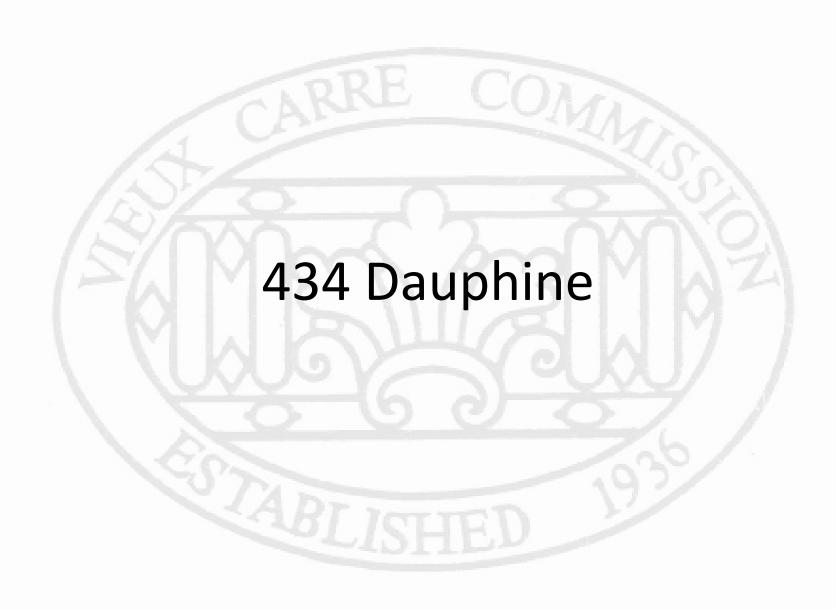

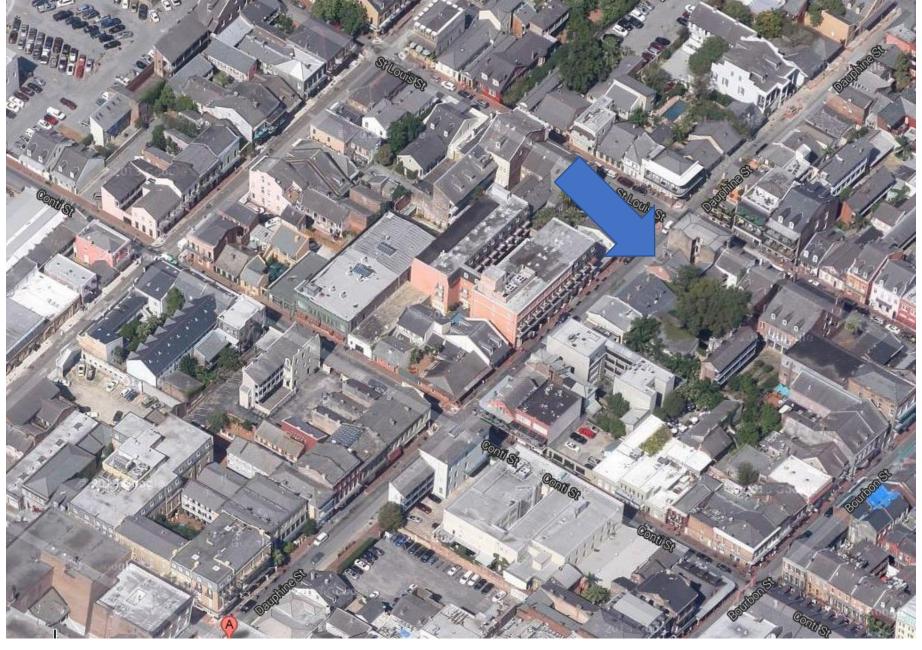




















VCC Architectural Committee March 14, 2023





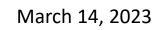






March 14, 2023






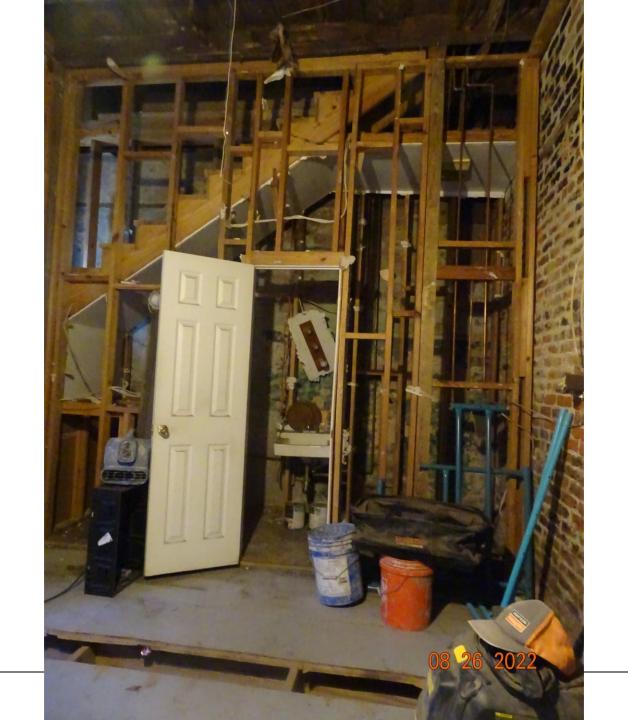






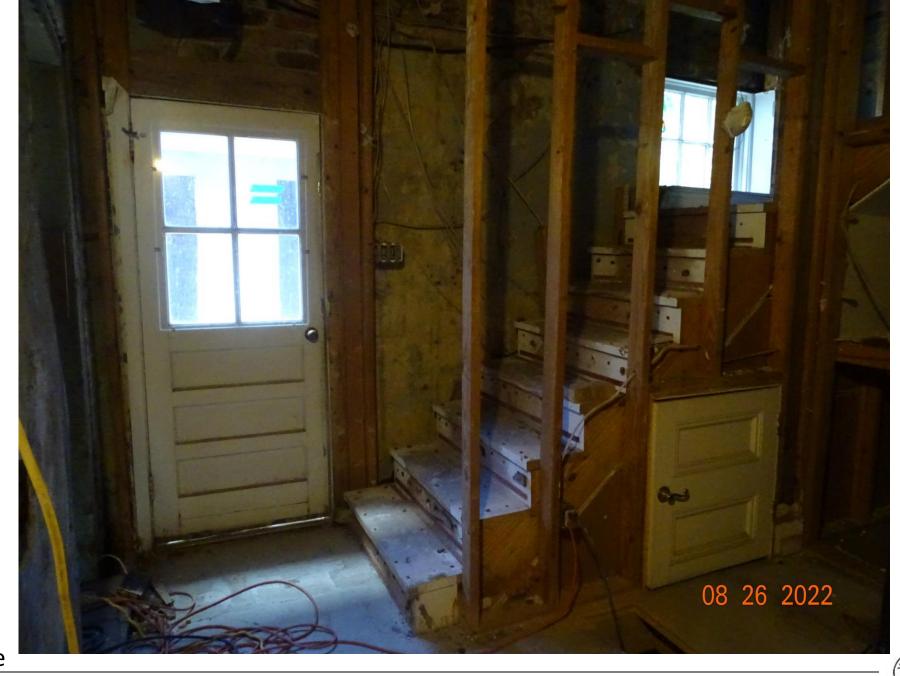







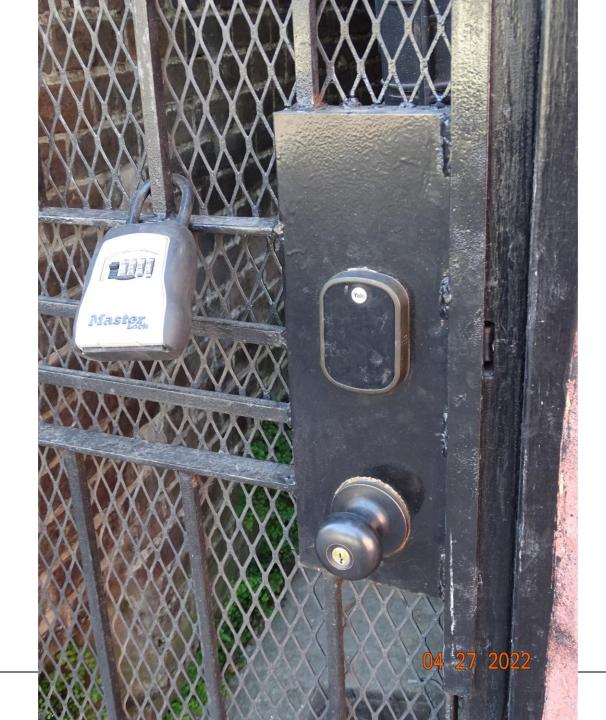





## Assure Lock®

Collection Specifications









Upgrade with a Yale Smart Module















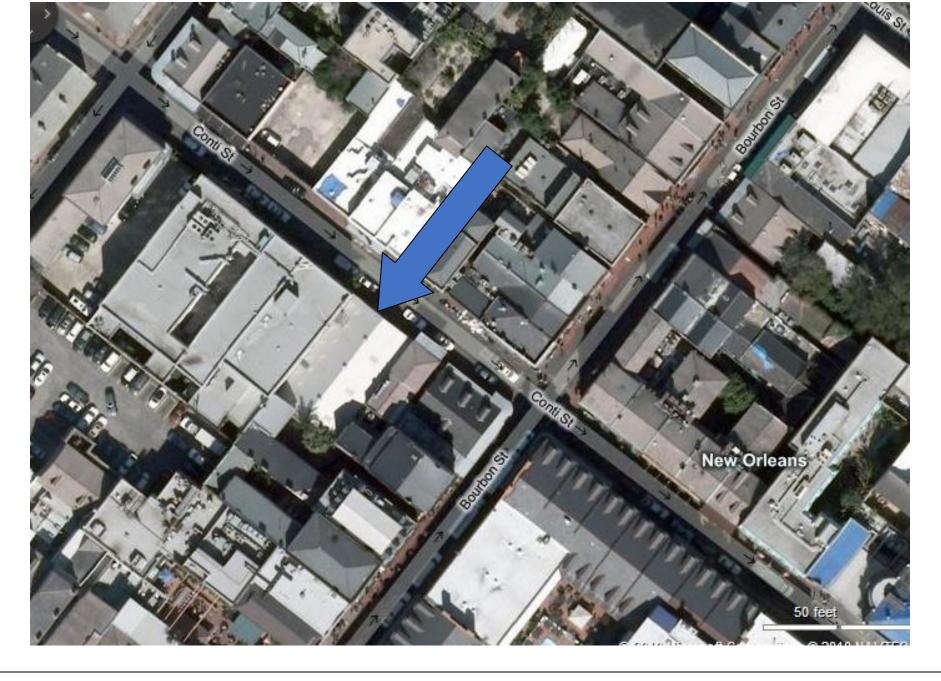



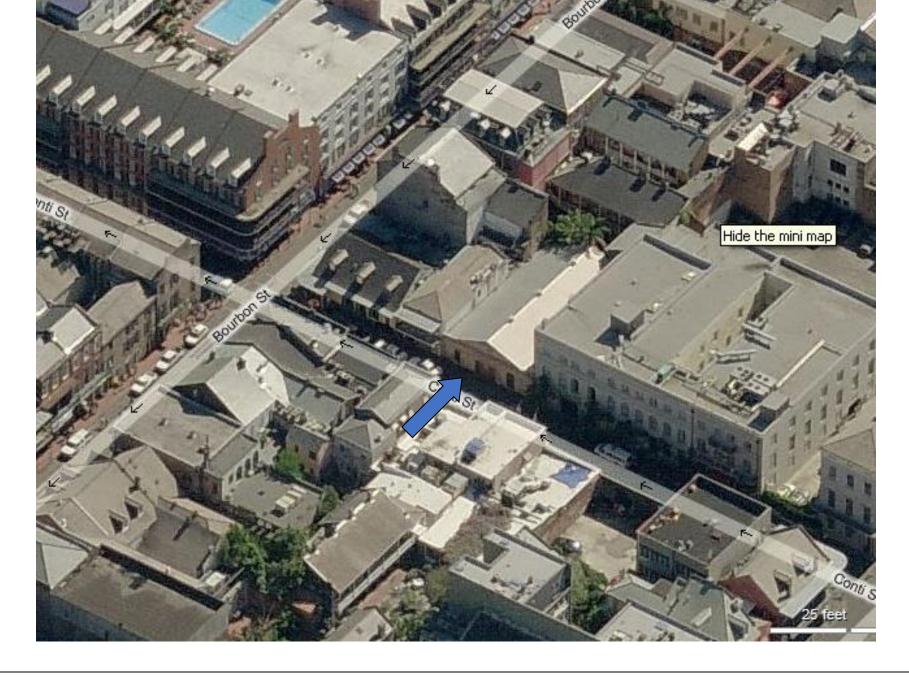












# The Garage

### 810 Conti St, New Orleans

DESIGN & FABRICATION BY QUARTTRO GRAPHICS INSTALLATION BY ANDERSEN DESIGN & BUILD

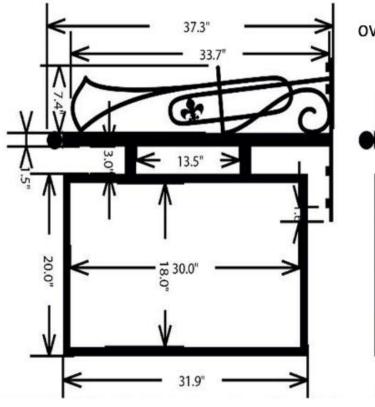

OVERALL DIMENSIONS: 31.9" H x 37.3" W




SIGN TO BE INSTALLED ON THE FACADE OF BUILDING LOCATED AT 810 CONTI ST. USING APPROPRIATE ANCHORS FOR WALL CONSTRUCTION. STEEL FRAMEWORK WITH



2 FACES PROJECTING FROM WALL 37.3" AND MOUNTED OVER 7' WIDE SIDEWALK. EXTERNAL LIGHTING ONLY, AS SHOWN IN DETAIL ABOVE USING EXISTING ELECTRICAL CONNECTION. SPOTLIGHTS ILLUMINATING BOTH PLEXIGLASS SIGN FACES. BOTTOM OF SIGN IS 9' ABOVE SIDEWALK.



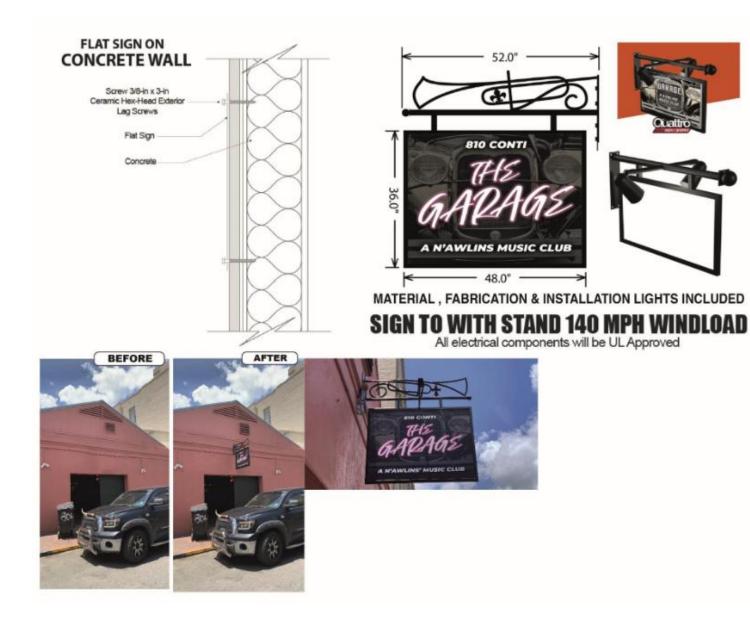


Qualific Valenci, bibroator A. Drawn By:: 1/ Sign Material , Solvication & Patellation lights included (36°H X 46°W) TOP AREA 52°W Customer's Approval: Date: 68183931 Location: 816 Cardi Sillion Oricens, LA 78112

All right reserved III Qualtro Graphics LLC 2020





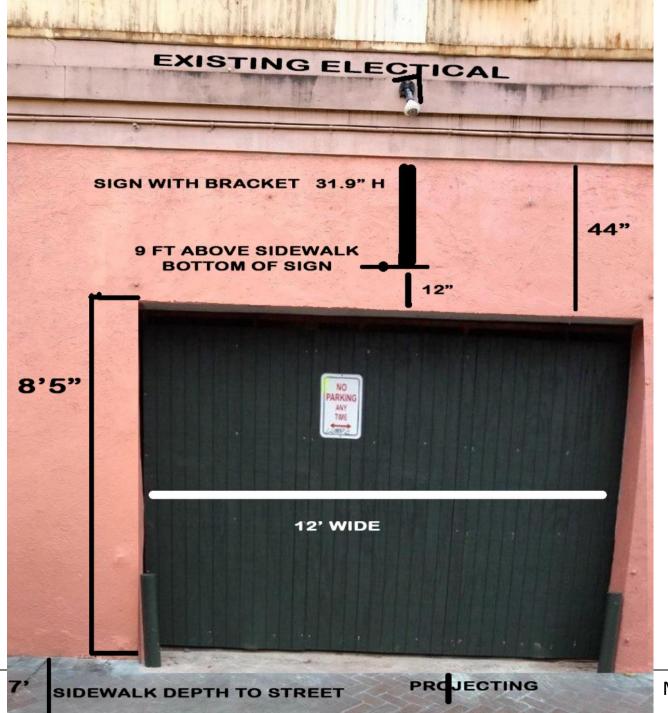








VCC Architect



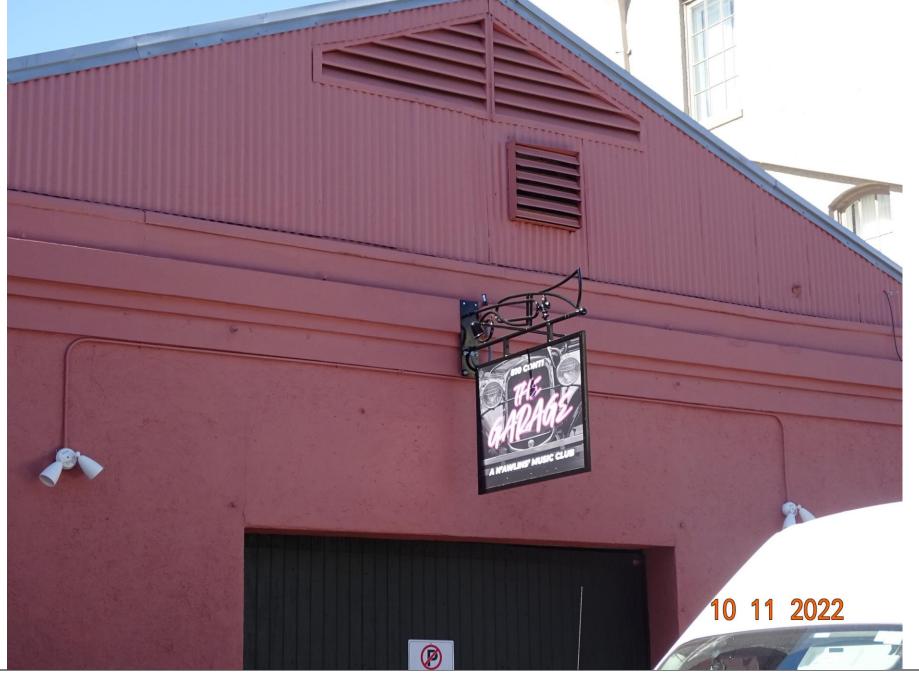


810 Conti






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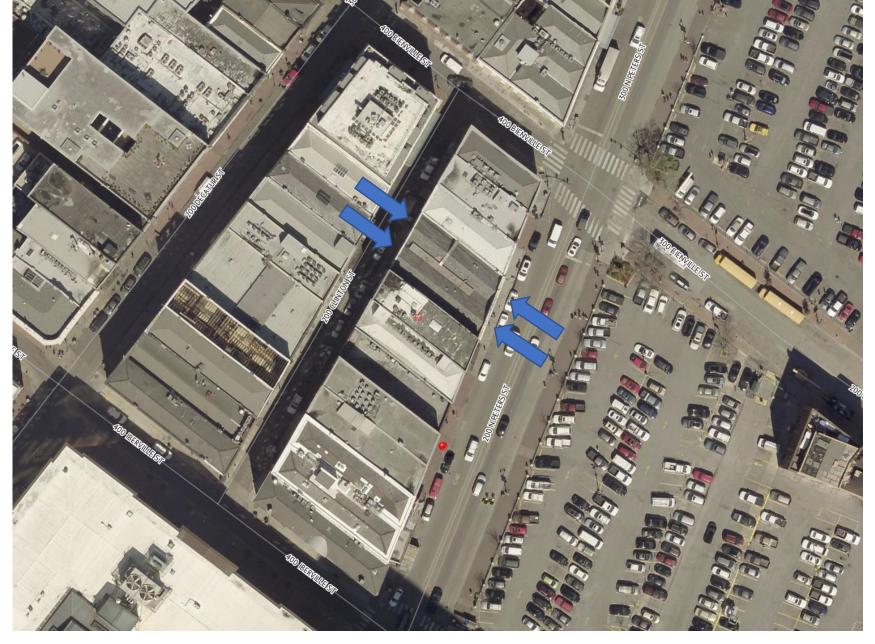


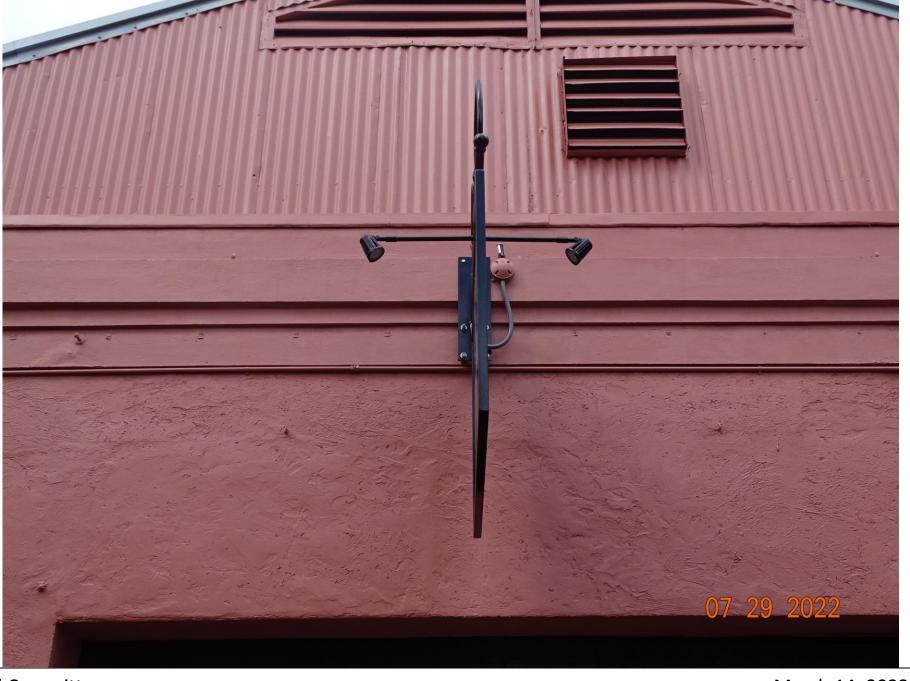

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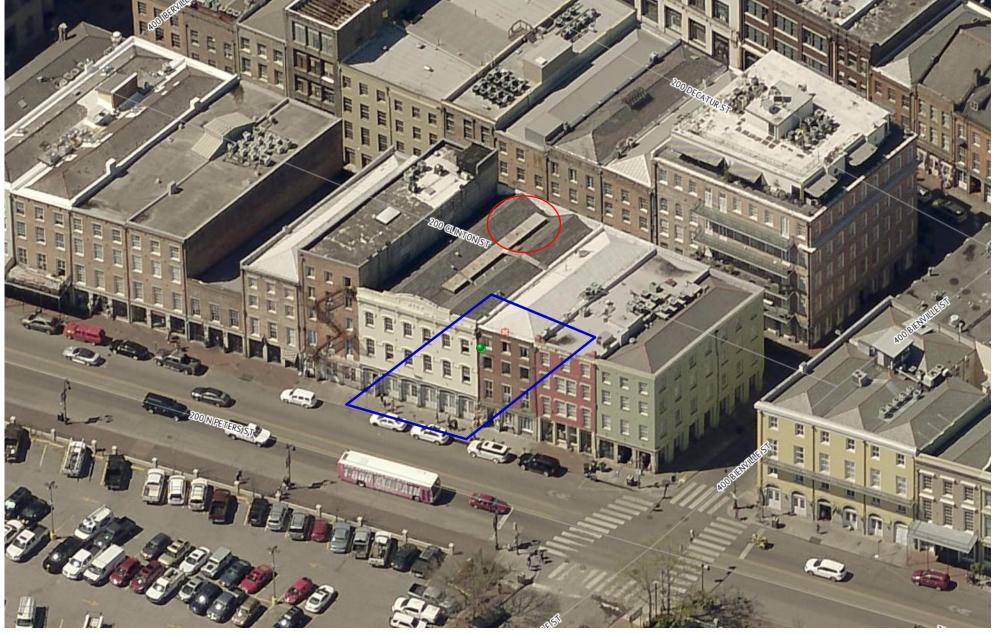




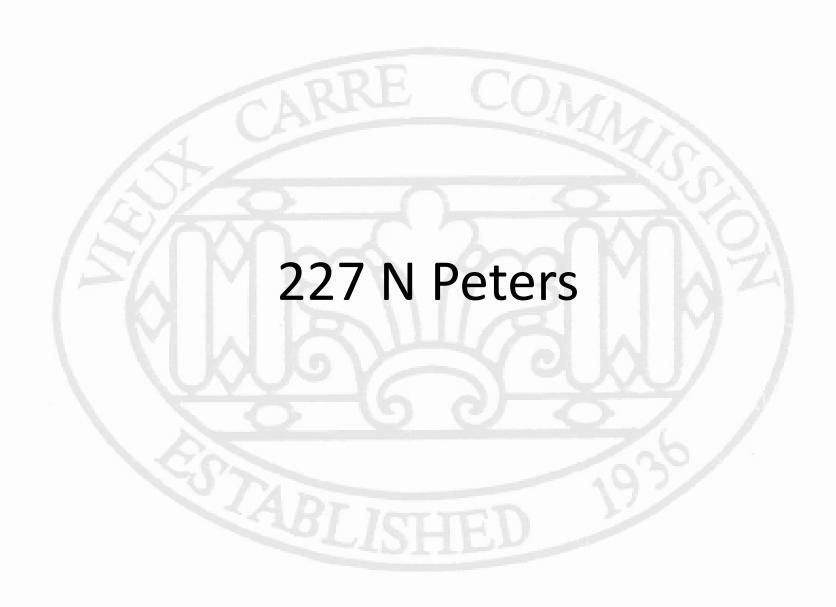

233 N Peters











233 N Peters





233 N Peters – prior to 1895





233 N Peters – 1962





233 N Peters





233 N Peters





233 N Peters – Clinton elevation















227-33 N Peters





227-33 N Peters

Mold Sampling and TestingCertified Stucco Inspections

Thermal Imaging

Engineering Services

· Construction Management

. Home and Commercial Building Inspections

#### **Engineering and Inspections**

622 City Park Avenue New Orleans, LA 70119 (504) 486-8500 (504) 486-8777 Fax www.gurtlerbros.com inspections@gurtlerbros.com

October 5, 2022

22-1459.02

Hancock Whitney Corp. c/o Ms. Lourdes Burke Via email to Lourdes.burke@hancockwhitney.com

Copy to Mr. Steve Rapier

Via email to Steve.rapier@hancockwhitney.com

Subject: 227-233 North Peters Street New Orleans, Louisiana

Dear Ms. Burke:

We had conducted a visual structural inspection of the subject property on August 2, 2022, to address concerns expressed by the Vieux Carré Commission with respect to the condition of the exterior walls at this property. We rendered our report 22-1459.02 dated August 15, 2022, in connection with that inspection.

In our report we documented conditions we noted during that inspection. Based on our observations, we indicated that no remedial structural repairs were deemed to be necessary. We had noted cracking at the stucco on the front wall and at various areas on the interior of the building that we indicated are not structurally detrimental and can be repaired cosmetically as desired.

Subsequent to that inspection, Mr. Anthony Whitfield of the VCC expressed concern about a bowing column and deteriorated masonry and provided with two photographs of the area in question. We revisited the site on September 8, 2022, and inspected the area of concern raised by Mr. Whitfield and offer the following further observations.



This is a view of the area of concern, which is at the left front corner of the subject property.



This is a limited view inside the wall cavity showing separation between the stucco cladding and the masonry wall.





This limited view of the interior of the wall cavity provides another view of the separation between the stucco and the underlying masonry wall.

Based on our reinspection, the bowing at the exterior stucco cladding at this corner of the building does not appear to reflect bowing of the underlying masonry but rather separations between the stucco and masonry due to moisture intrusion between the cladding. To reduce further separations at this stucco cladding, we recommend that the stucco be removed and replaced and that the underlying joints in the masonry wall be repointed. The vertical joint between the stucco and the adjacent wood trim also should be caulked and sealed as required to reduce the potential for further moisture intrusion.

FRIEDRICH W. GURTLER
REG. No. 25374
REGISTERED
PROFESSIONAL ENGINEER
IN

Yours very truly,

GURTLER BROS. CONSULTANTS, INC.

Friedrich W. L. Gurtler, P. E.

Vice-President

Louisiana Professional Engineer License #25374

Hancock Whitney Attn: Lourdes Burke PO Box 61964 New Orleans, LA 70161

Re: 227 - 233 N. Peters St. - Repairs to Left and Right Side of Two Door Openings

- I. SCOPE: These specifications pertain to the closure on the open joints on the left-side and right-side of (2) two door openings on the front elevation. *Please see pictures attached in email which show defined scope area.* 
  - Masonry surfaces will be cleaned with Prosoco 2010 All Purpose Neutral Cleaner in conjunction with high-volume low-pressure hot water regulated to (800 psi).
  - Vegetation growth will be removed from area prior to repair. Area where root ball was removed will be treated with an herbicide prior to repair.
  - Loose masonry on left-side and right-side of door opening will be removed. Vertical joint on
    left-side will be opened up slightly to provide a more uniform joint profile to perform
    repairs on. Vertical joint on both sides will be tuckpointed then filled to create an expansion
    joint that can be caulked. Prepared joints will be brushed clean and dampened.
    Tuckpointing procedure and composition of mortar conforms to the methods outlined by
    the VCC for maintenance of historical structures. Tuckpointing mortar color will be matched
    as close as possible to original but may vary slightly given age of existing joint and colored
    mortar availability.
  - Once mortar has cured closed cell foam backer rod will be utilized to ensure proper joint depth. Prepared joint will be caulked with MasterSeal NP-1, a non-sag urethane sealant and tooled to a smooth uniform consistency.

### II. ACCESS TO SITE, PROVISION REQUIRED, GENERAL NOTES:

The project will be worked during normal work hours Monday-Friday 8:00-4:00. Crew size
will vary depending on work requirements. Materials and tools will be delivered daily or as
needed by VolkerWP. Trash and work debris will be bagged and hauled as needed by
VolkerWP. We will need access to 120volt electric and water near work area.











813-15 Toulouse

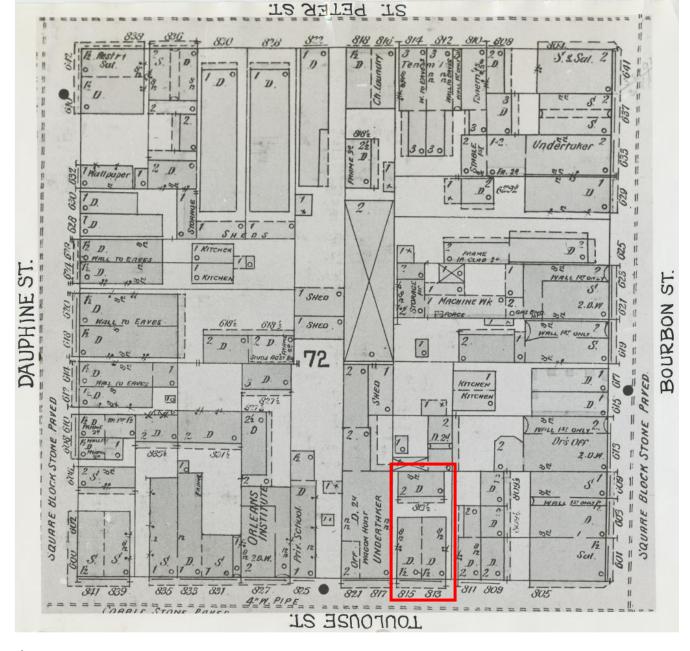








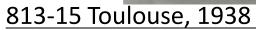





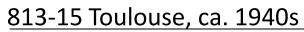











813-15 Toulouse
















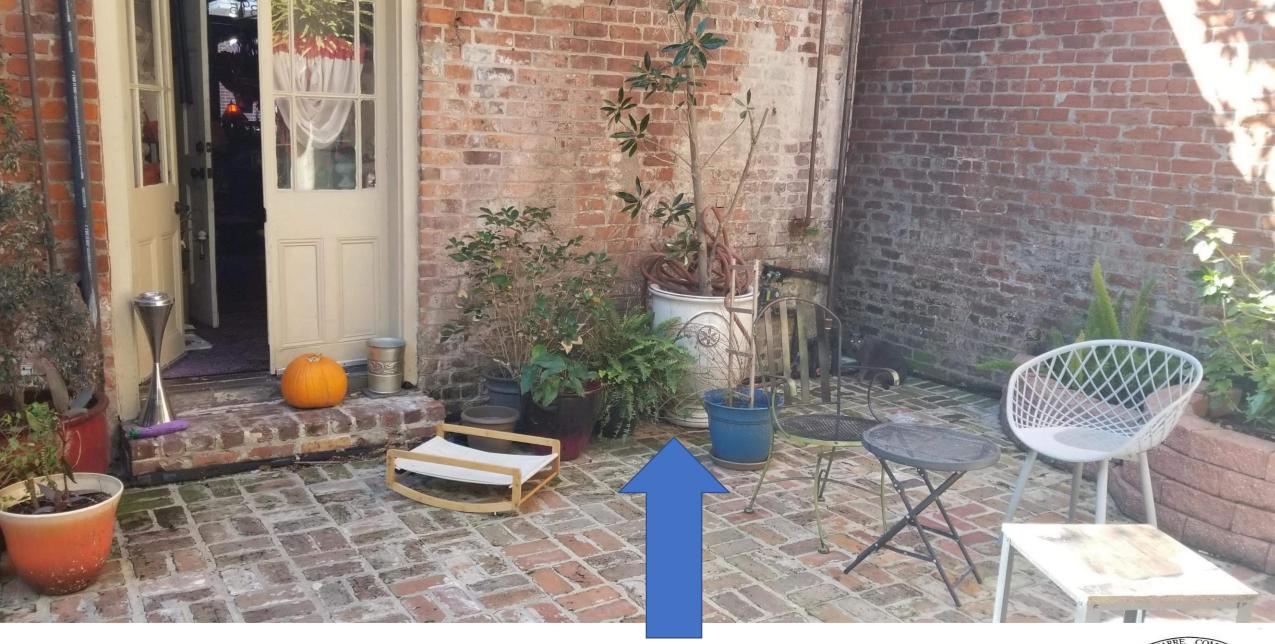

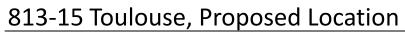






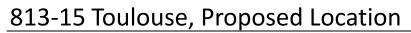



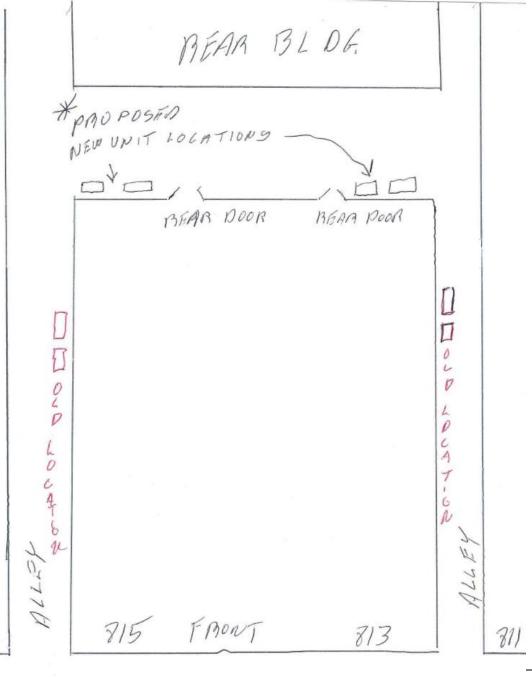

813-15 Toulouse


VCC Architectural Committee

TOULOUSE ST.

March 14, 2023





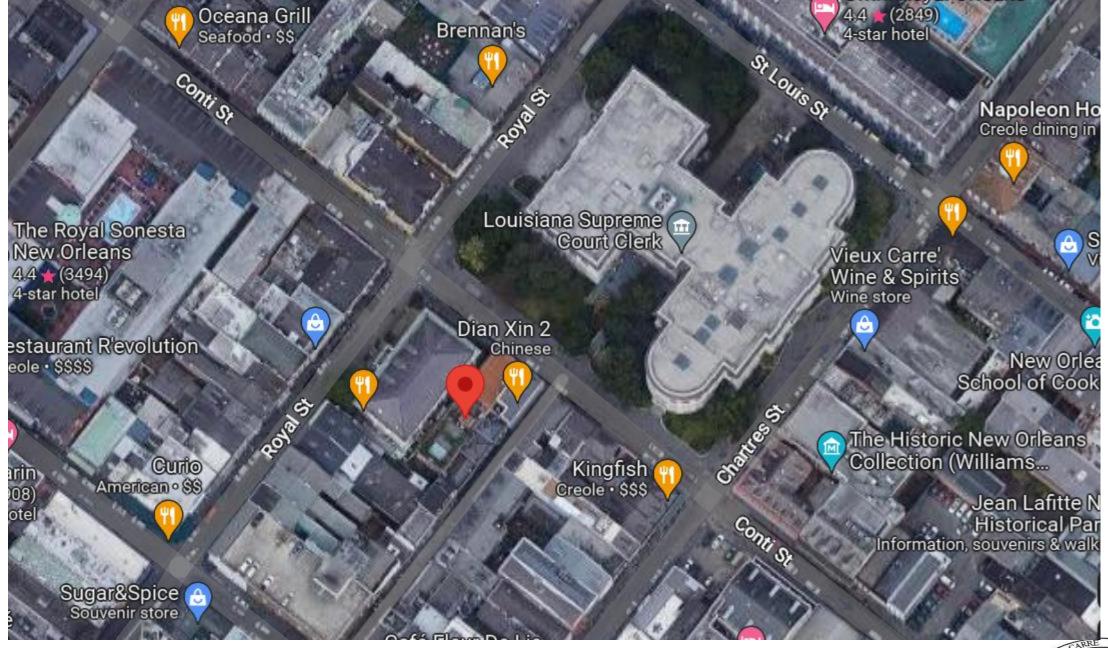

VCC Architectural Committee March 14, 2023

