Vieux Carré Commission Architecture Committee Meeting

Tuesday, September 9, 2025








528 Wilkinson




VCC Architectural Committee

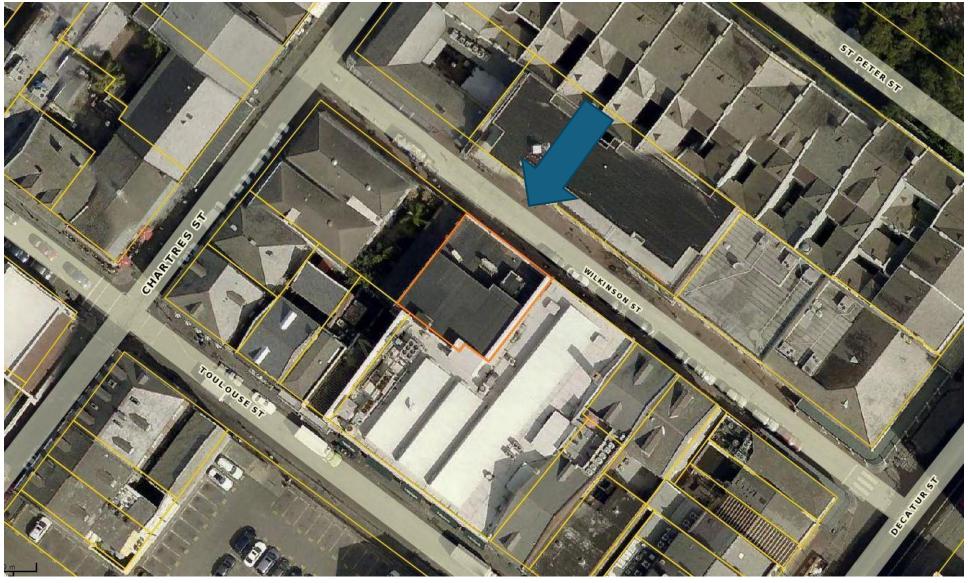

528 Wilkinson



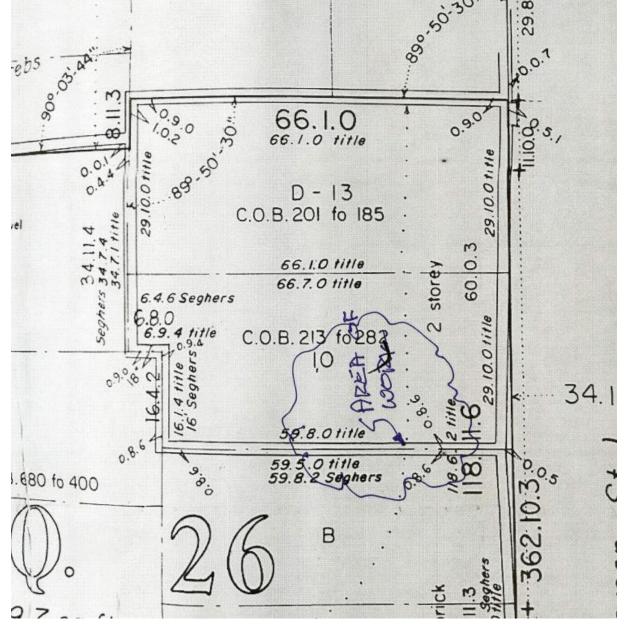

528 Wilkinson





528 Wilkinson, 1964





528 Wilkinson, c. 1987-88





528 Wilkinson





528 Wilkinson





528 Wilkinson





528 Wilkinson






528 Wilkinson




528 Wilkinson



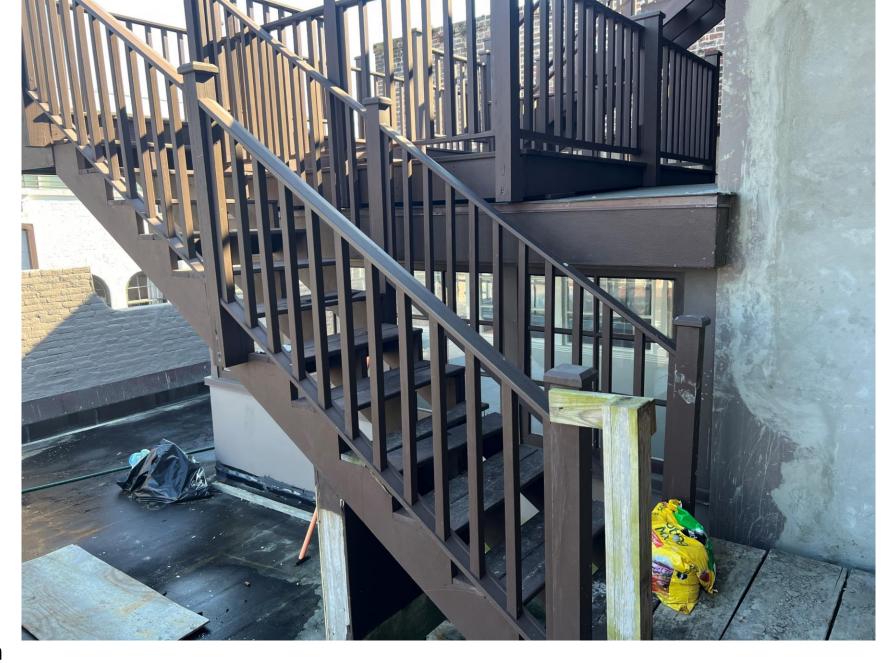




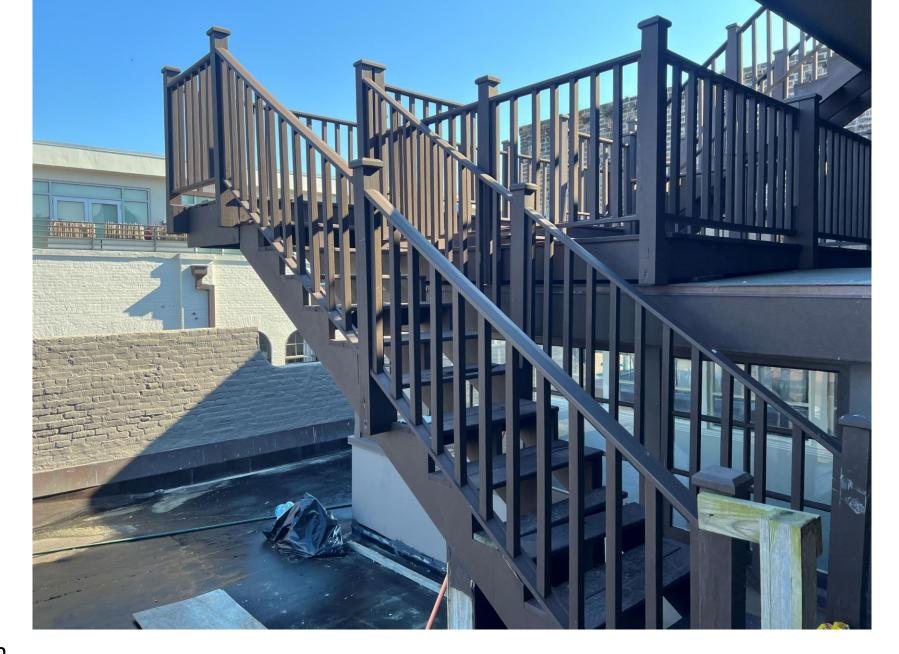







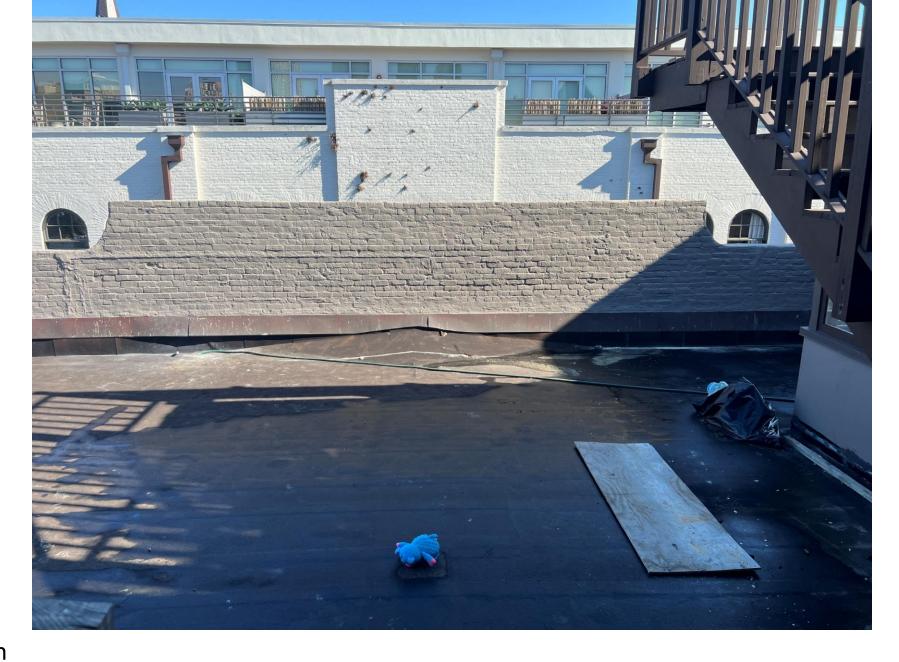





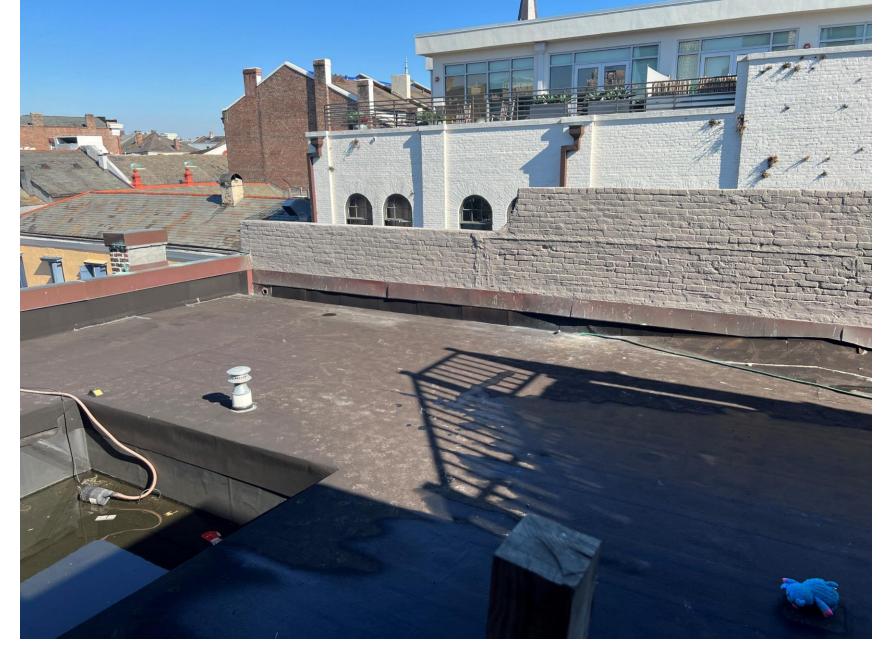

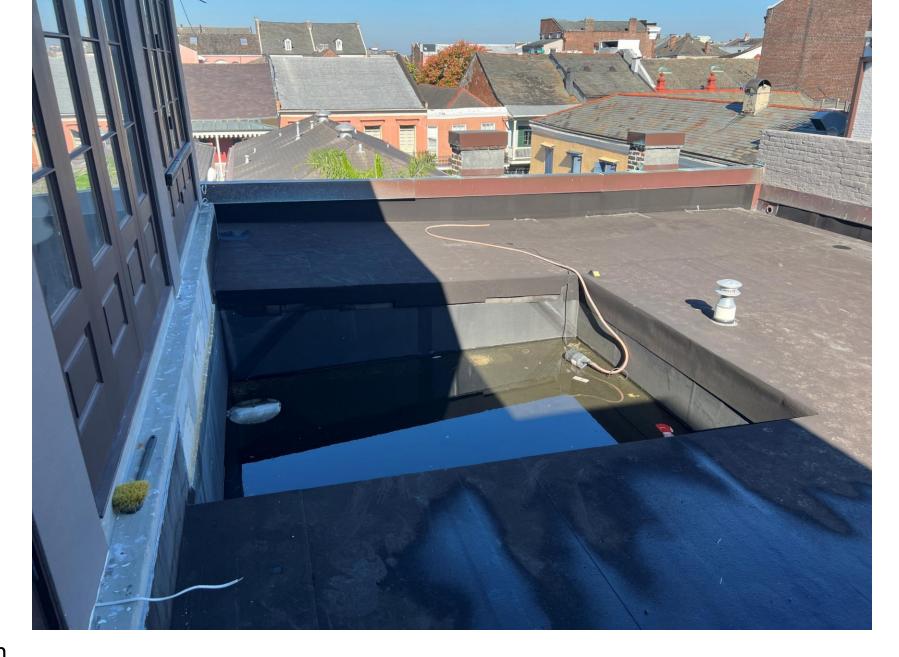
















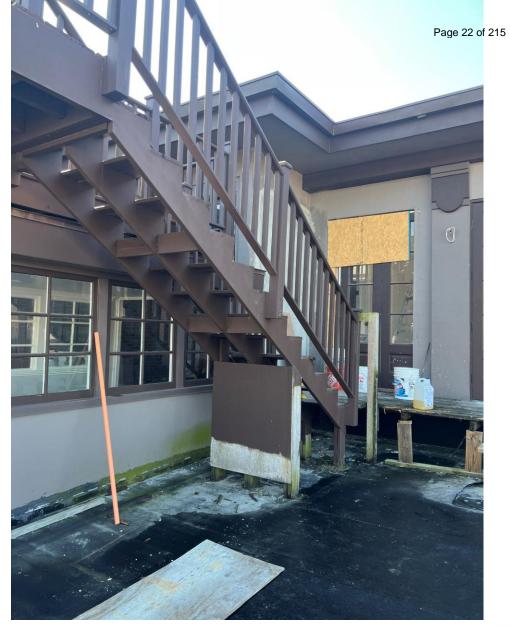

528 Wilkinson












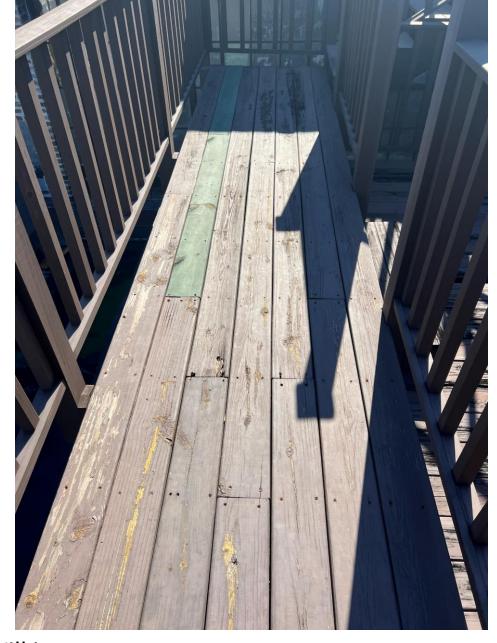





September 9, 2025

528 Wilkinson



VCC Architectural Committee

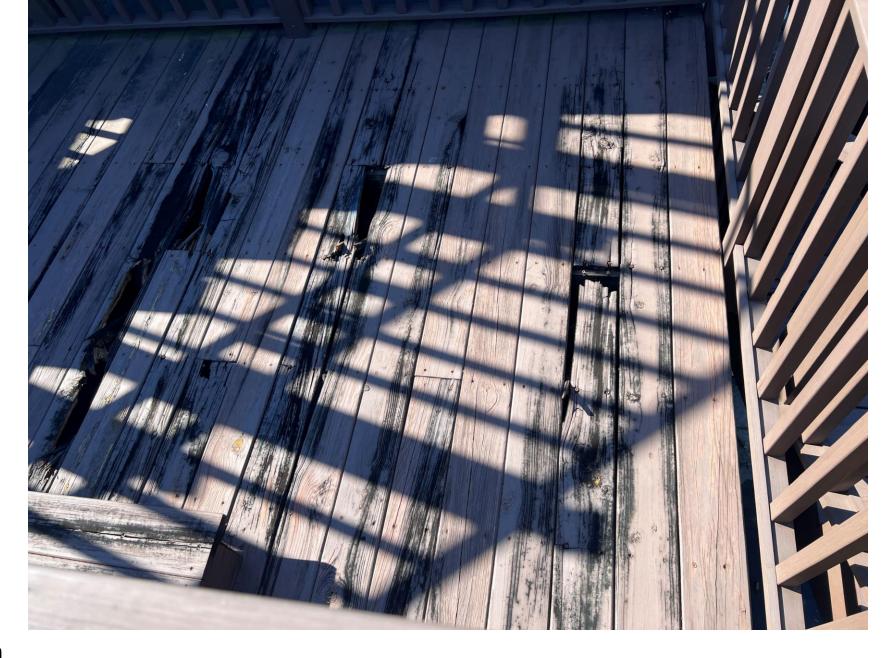

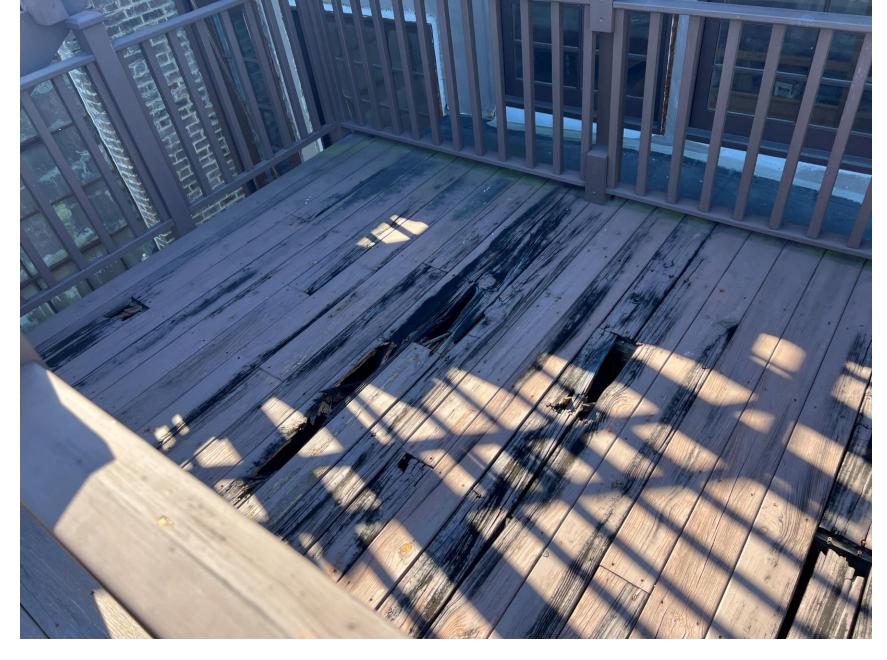







528 Wilkinson



























Page 36 of 215

ZACH SMITH CONSULTING & DESIGN

Description Date
ADDENDUM #1 11.4/22
REVISION 1-VCC REVIEW 11/30/22
REVISION 2- 5TAIR 41/3/20/3
REVISION 2- 11/4/11/20/2
REVISION 3- 5TAIR DTS 59/20/23
REVISION 4- LIGHTING 6/15/20/3

TITLE PAGE
CAUSEY
RESIDENCE
Project Number
6.15.2023

A1.0

CAUSEY RESIDENCE

ROOF AND DECK REPAIRS AND IMPROVEMENTS

528 WILKINSON STREET NEW ORLEANS, LOUISIANA





SHEET LIST					
SHEET NUMBER	SHEET NAME	Current Revision	Sheet Issue Date		
A1.0	TITLE PAGE		6.15.2023		
A-1	ROOF PLAN-DEMO		6.15.2023		
A-2	ROOF PLAN - NEW	1	6.15.2023		
A-3	ELEVATIONS	1	6.15.2023		
A-4	DETAILS	1	6.15.2023		
A-5	DETAILS	1	6.15.2023		
A-6	MASONRY REPAIR	1	6.15.2023		

CONTACT INFO. PROJECT INFO. Carl and Toni Causey 528 Wilkinson St. New Orleans, LA 70130 504.814.0214 toni@triccivilconstruction.com

DESCRIPTION

Exterior stair and roof renovation of 3 story single family home.

ZONING DISTRICT vcc CONSTRUCTION TYPE

OCCUPANCY TYPE
IRC: RESIDENTIAL, SINGLE FAMILY

NUMBER OF STORIES

BUILDING HEIGHT 42'-4 1/2"

STRUCTURAL ENGINEER

CONTRACTOR

Zach Smith Constultin & Design 530 N. Norman C Francis Pkwy New Orleans, LA 70119 504.383.3748

ARCHITECT

SHEET NAME	Current Revision	Sheet Issue Date
E PAGE		6.15.2023
F PLAN-DEMO		6.15.2023
F PLAN - NEW	1	6.15.2023
ATIONS	1	6.15.2023
AILS	1	6.15.2023
AILS	1	6.15.2023
ONRY REPAIR	1	6.15.2023

=	
07/13/2023 ebvogt	•A
1200	•A su
	•A
APPROVED	NIC
SEE NOTES	E


All wiring shall be placed in conduits
All conduits shall be placed along the inside corners of building
surfaces as much as possible, such as along gallery/balcony purlins at
the deck line, and painted to match the adjacent surfaces. All fixtures shall use lamps with the following criteria: 3000K color emperature, 80+ color rendering index, and 600-800 lumens per bulb

NOTE: SPIRAL STAIR MUST BE PAINTED AND MAY NOT REMAIN EXPOSED ALUMINUM








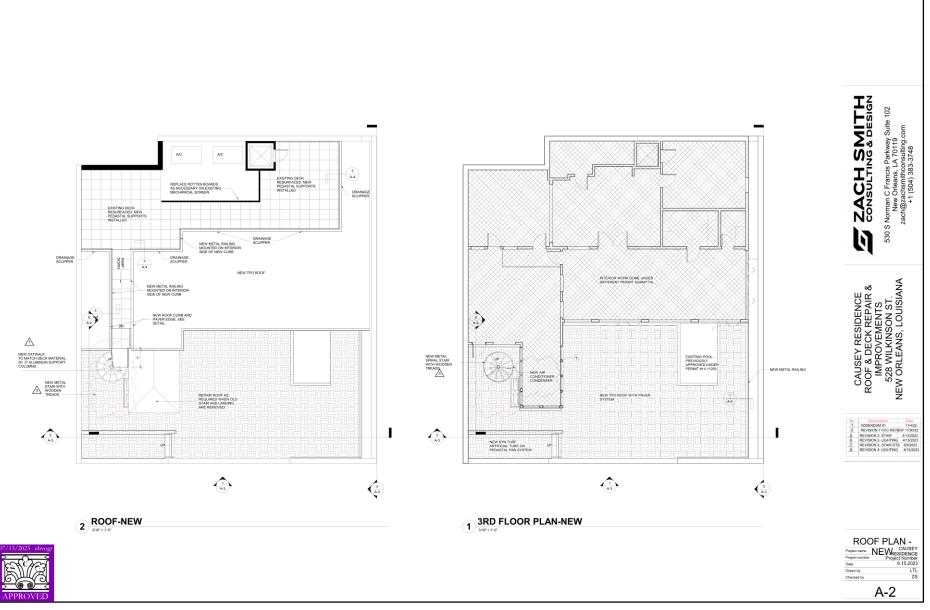






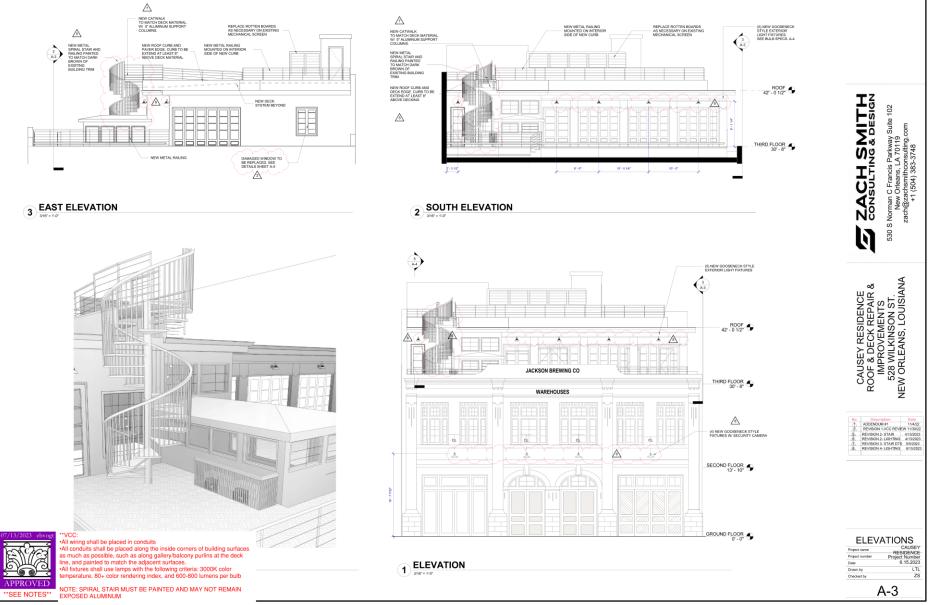




Page 40 of 215

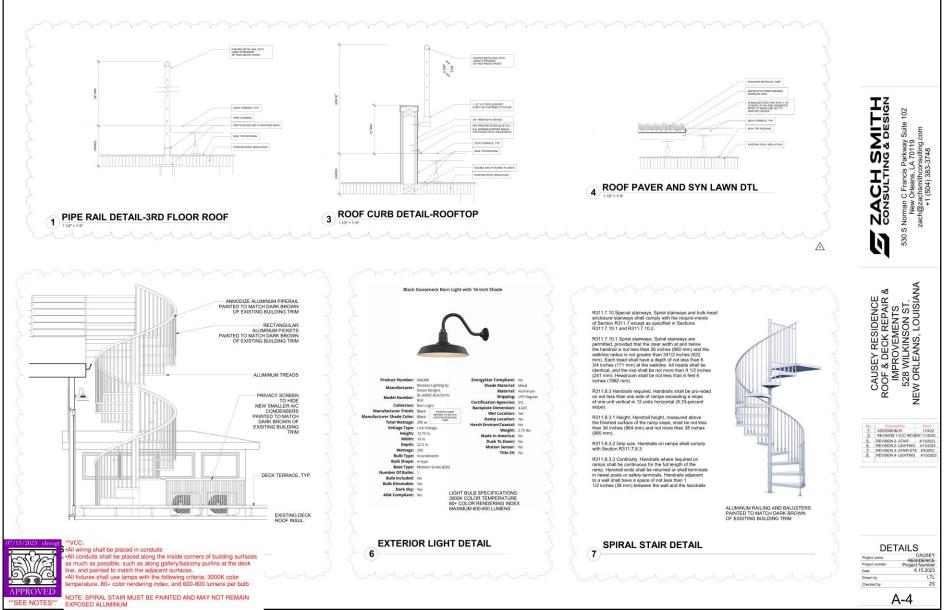




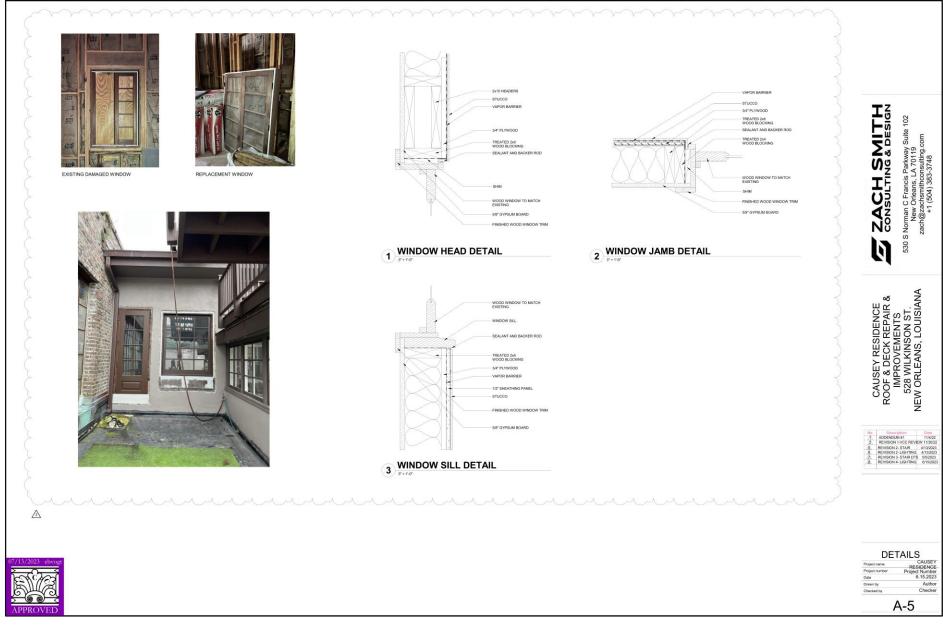






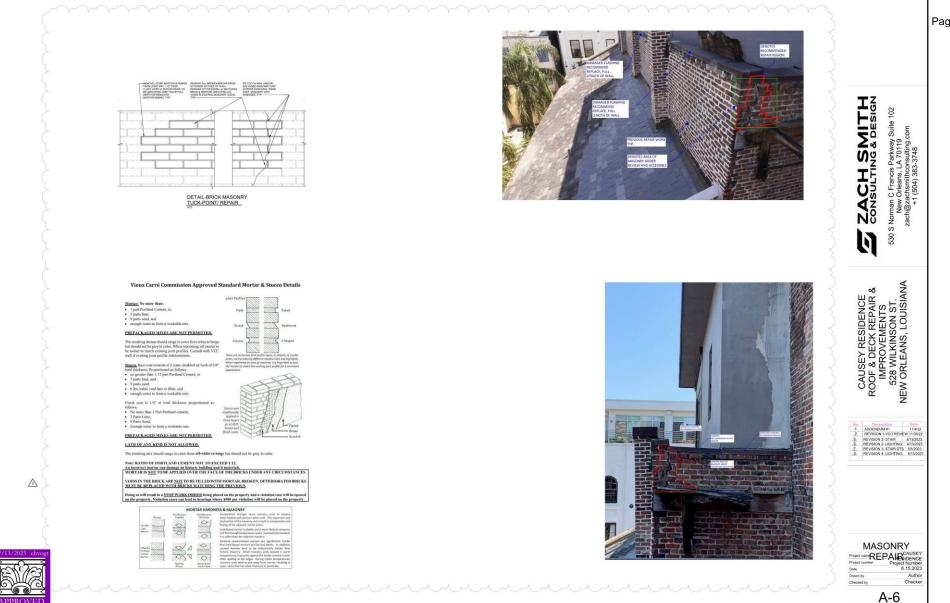







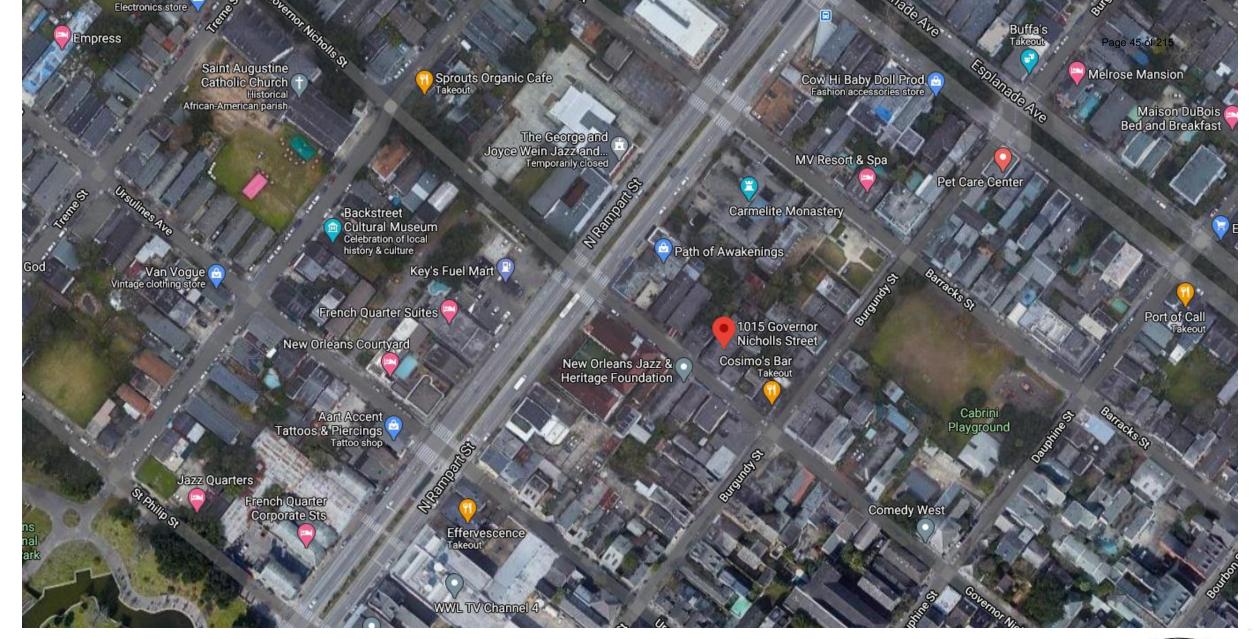

1015 Governor Nicholls





1015 Governor Nicholls



















SILVA Construction

AGREEMENT

State License #555610 4439 S. Rocheblave St New Orleans, LA 70125 silvaconstruction@cox.net

05/30/2025

Prepared For:

Reilly Bruce, Roberts Robin Ann, Ernest Fuhrmann, Dean E II Altenhofen, Jermaie J Gauthreaux

1015 Governor Nicholls St


New Orleans

JOB DESCRIPTION

Repair and Waterproof interior block porch supports, - Remove all block excess grout, Epoxy seal Wall, Cap, lift the porch and repair the interior support walls by repointing the brick pulling them in and straightening them. shouldn't have to touch the exterior cladding.

1015 Governor Nicholls



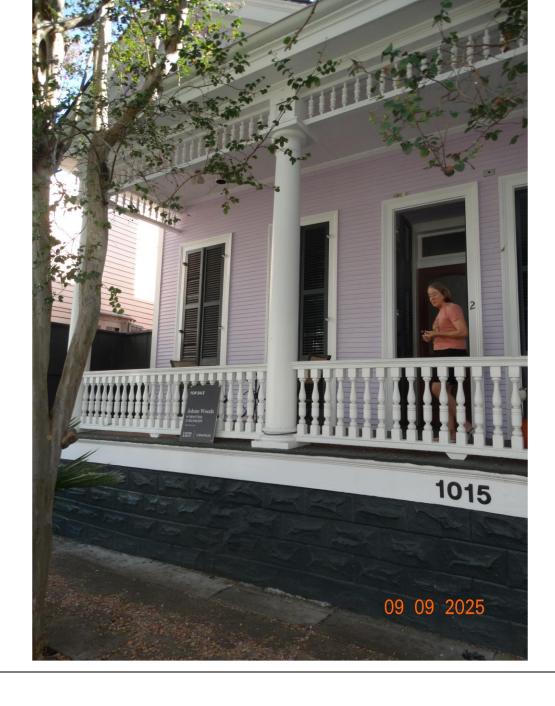









1015 Governor Nicholls














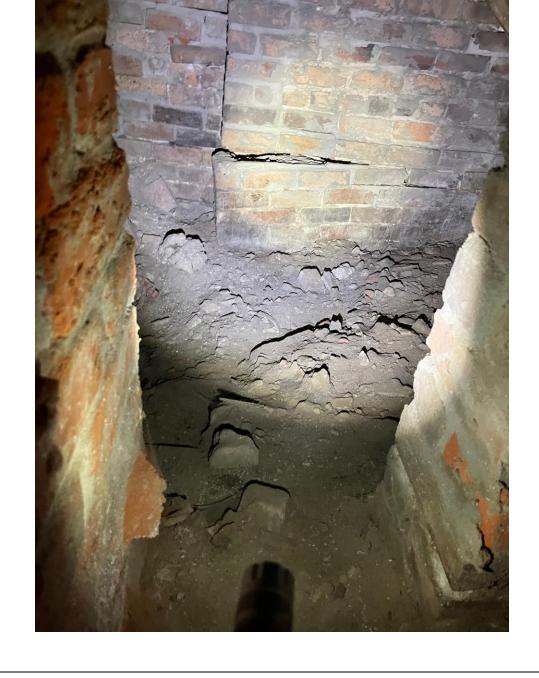





1015 Governor Nicholls





1015 Governor Nicholls



1015 Governor Nicholls



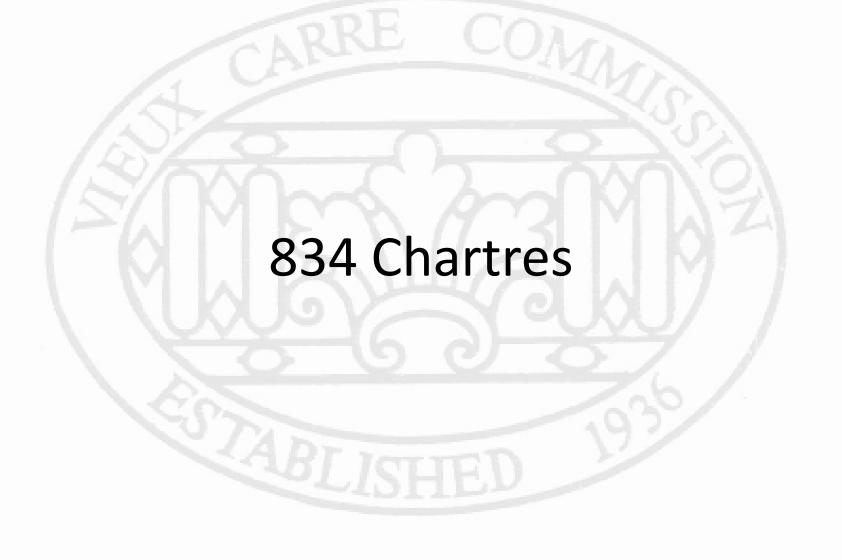

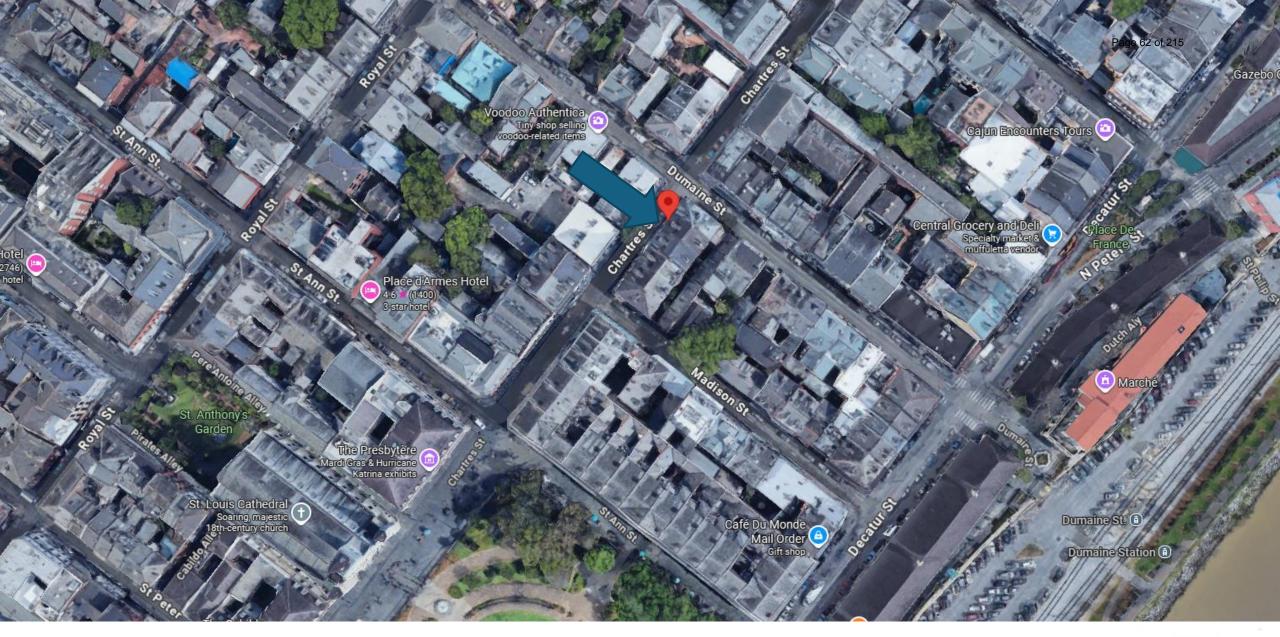

834 Chartres












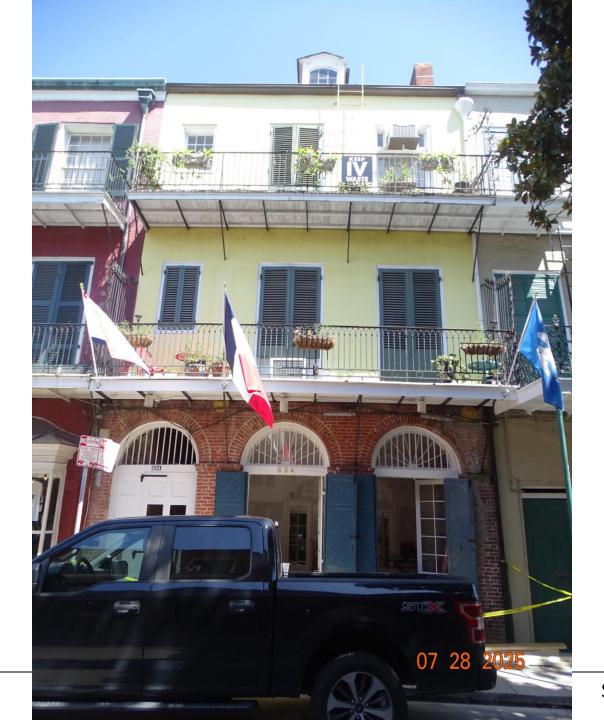







834 Chartres





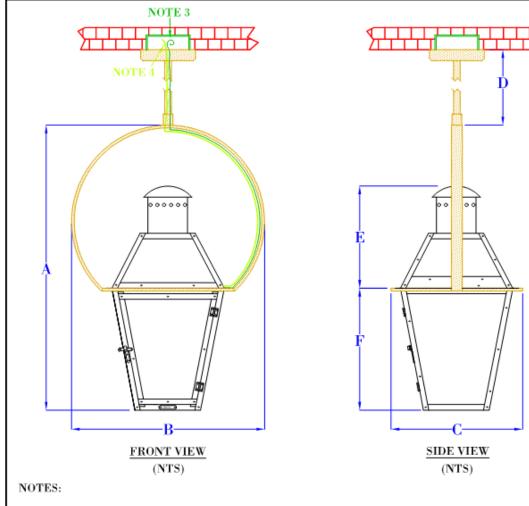

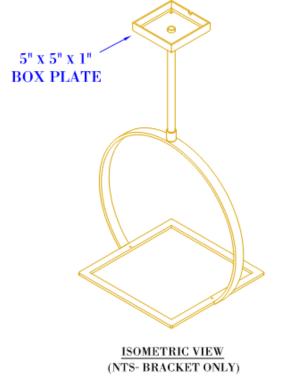

SIZE: 14" 18" 21" 24" 36" A: В: C: D: VARIES VARIES VARIES VARIES VARIES VARIES $6\frac{1}{4}$ " E:

F:

- 1. MOUNTING HARDWARE SUPPLIED BY OTHERS
- 2. FIXTURES ARE HANDCRAFTED. DIMENSIONS MAY VARY PLUS OR MINUS $\frac{1}{4}$ "
- 3. ELECTRIC LIGHTS SUPPLIED WITH 18/2 WIRE WITH GROUND
- 4. GAS LIGHTS SUPPLIED WITH $\frac{3}{16}$ COPPER GAS LINE AND $\frac{3}{16}$ x $\frac{1}{4}$ GAS LINE ADAPTOR

	LIGHT:	FRENCH Q
4 Chartres	BRACKET:	YOK

834

BEVOLO GAS & ELECTRIC LIGHTS			DRW BY:	JJG
LIGHT:	FRENCH QUARTER	DATE:	APP. BY:	JJG
BRACKET:	YOKE	3-11-25	REVISION:	13

EDITED TO A LIKENESS WITHOUT THE WRITTEN CONSENT OF BEVOLO GAS AND ELECTRIC LIGHT



834 Chartres

September 9, 2025



834 Chartres – Existing Lights at 828 Chartres






834 Chartres – Existing Lights at 828 Chartres





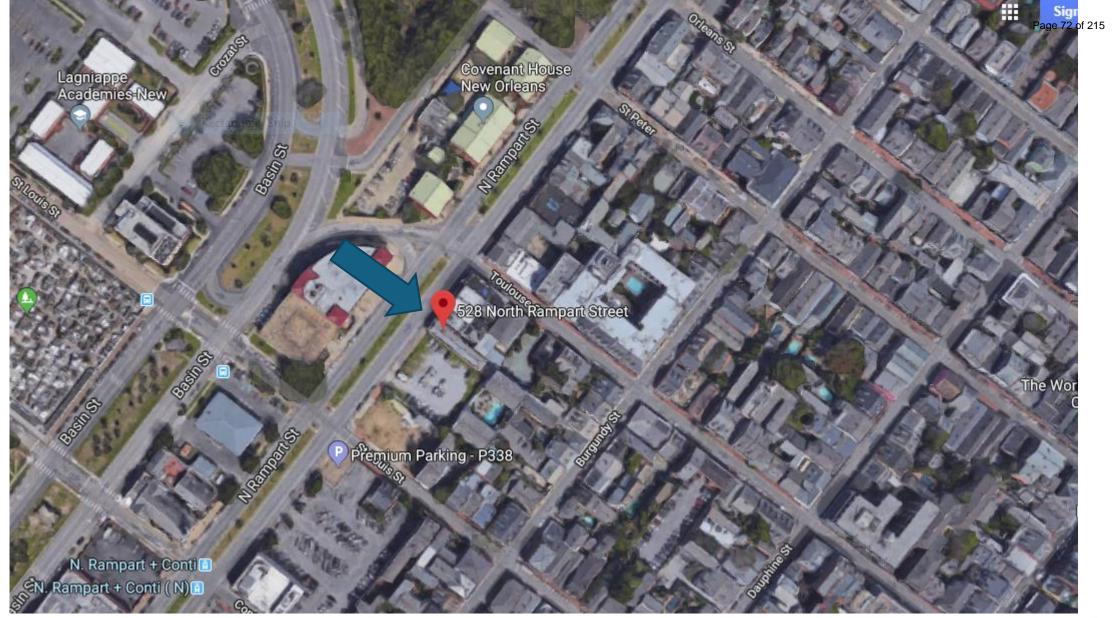














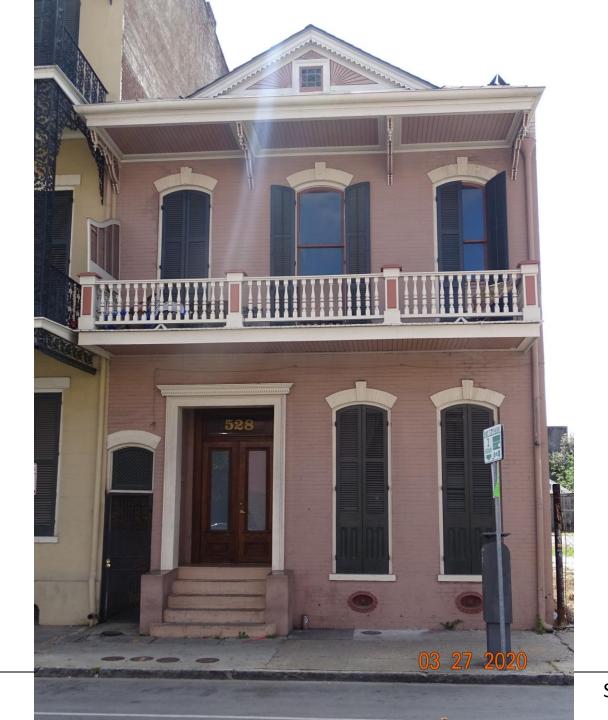





September 9, 2025







Example gate to model for new gate.





The security gate is sized to fit the opening and aligns with frames and muntins with a simple barrier grille and no decoration. The decorative fanlight transom remains visible.






528 N Rampart – Sitting Deterrent Example







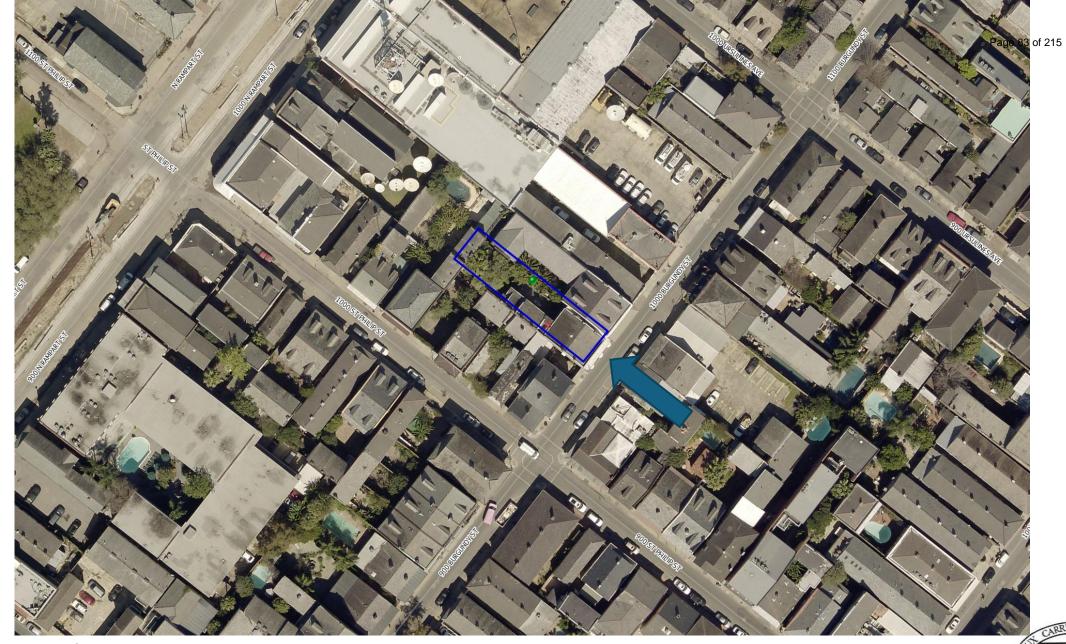













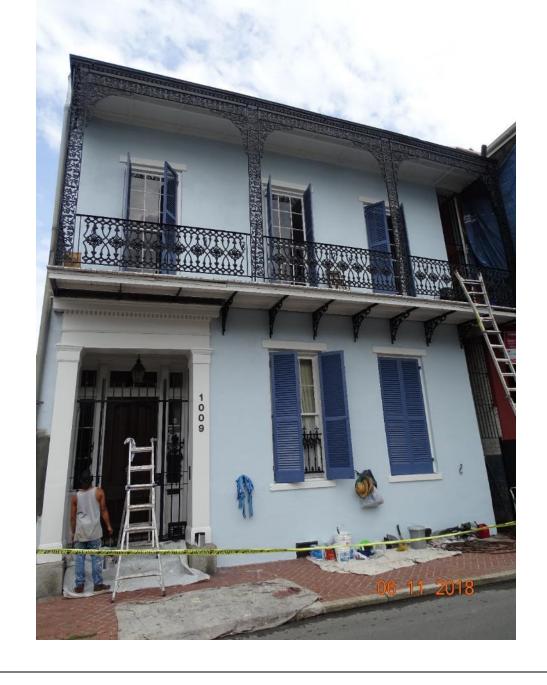




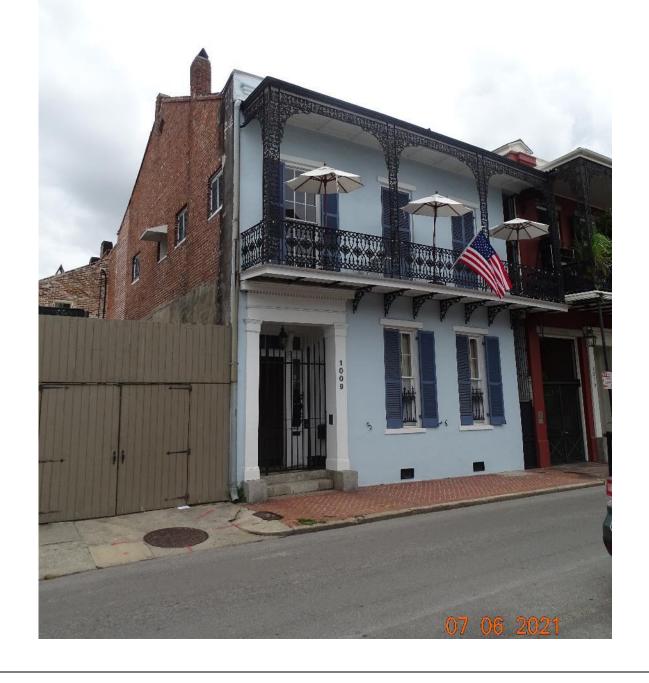







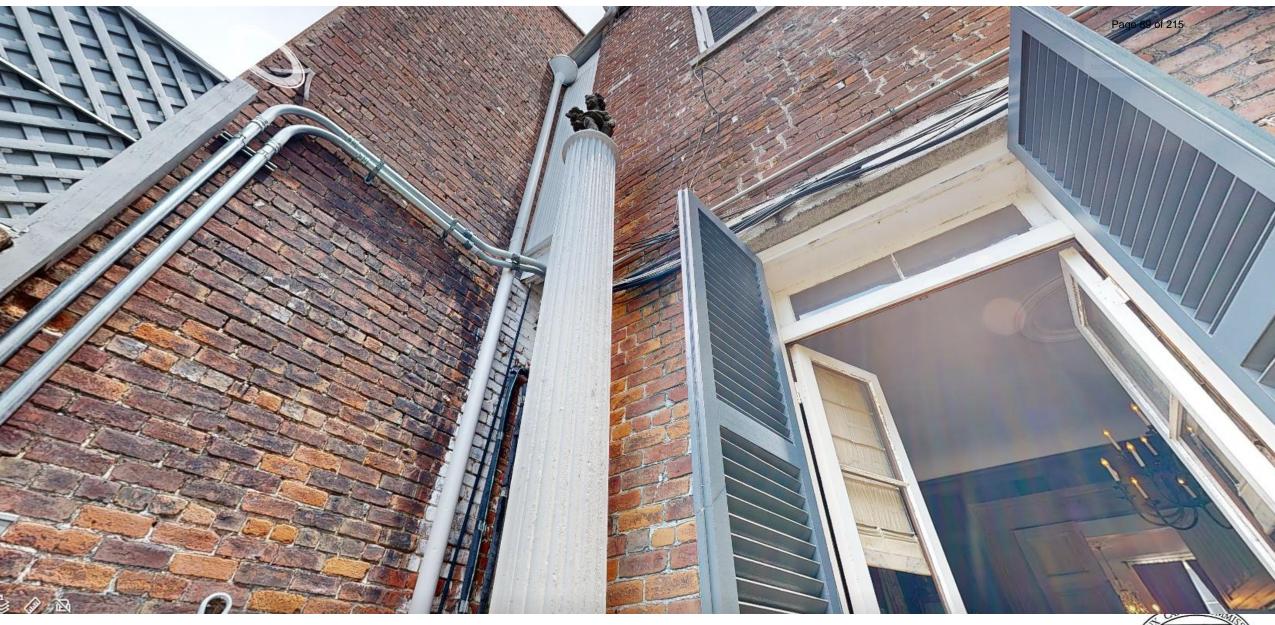

1009 Burgundy





1009 Burgundy




































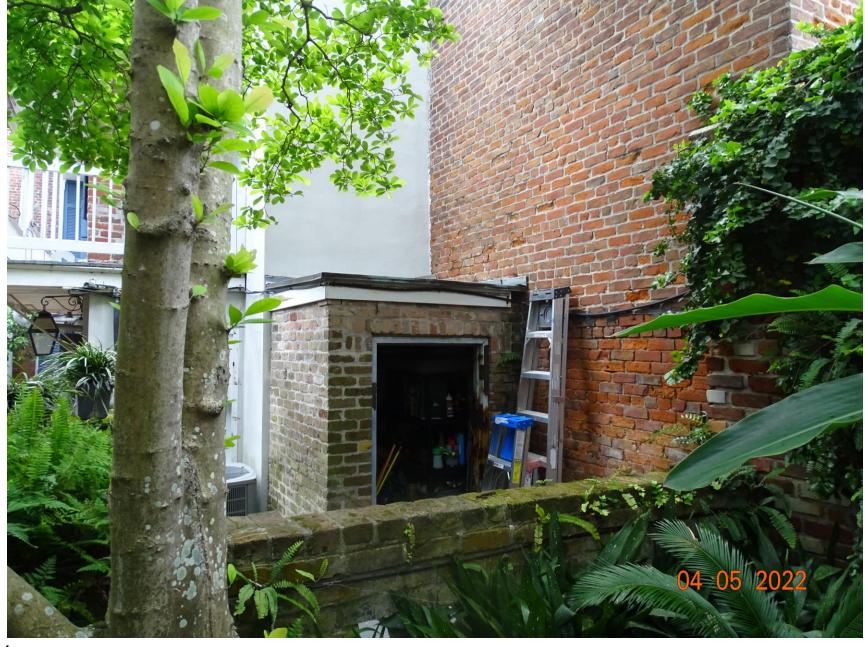











EXTERIOR REPAIRS

FOR

THE RESIDENCE OF:

JEFFERY & CELIA COLLINS

ΑT

1009 BURGUNDY STREET

NEW ORLEANS, LA. 70116




ARCHITECT

806 BELLEVILLE STREET PH: 504/603-6881 A LIMITED LIABILITY COMPANY
NEW ORLEANS, LA 70114
EM: MICHAEL@CLASSICALROOTS.COM

WALTER F. ZEHNER, III, P.E.

STRUCTURAL ENGINEER 4702 TOULOUSE ST. PH: 504/488-1442 A PROFESSIONAL STRUCTURAL ENGINEER NEW ORLEANS, LA 70119

EM: WALTERZEHNER@MSN.COM

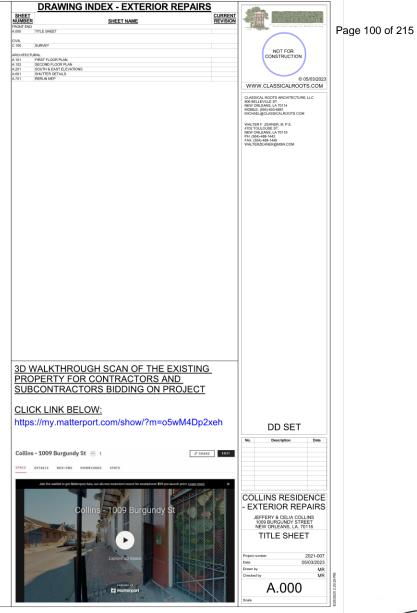



CLASSICAL ROOTS
ARCHITECTURE LLC AND THEIR
CONSULTANTS SHALL NOT BE
RESPONSIBLE FOR
INFORMATION PRESENTED ON
THIS PAGE. THE CONTRACTOR
AND HIS SUBCONTRACTOR
SHALL OBTAIN ORIGINAL
COPIES OF THE INFORMATION
FROM EACH ENTITY. SQUARE NO. 105 SECOND DISTRICT NEW ORLEANS, LA N. RAMPART ST. SIDE BURGUNDY May 7,1992
Survey certified correct. Made at the Request of Barbara B, Martin, Phelps Dunbar & Lawyers Title 108
Insurance Carp.

MORROW MORROW DD SET

Page 101 of 215

	Description	Date
	LLINS RESID (TERIOR RE	
- =/	CIERIOR RE	FAIR
	IEFFERY & CELIA CC 1009 BURGUNDY ST NEW ORLEANS, LA.	REET
	SURVEY	′
Project	number	2021-00
Project r	number	2021-00












Page 104 of 215

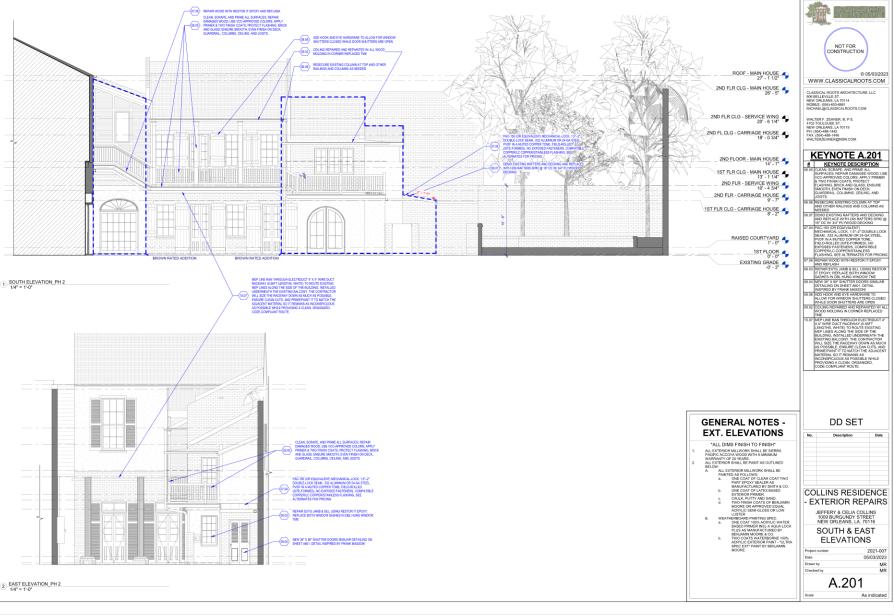












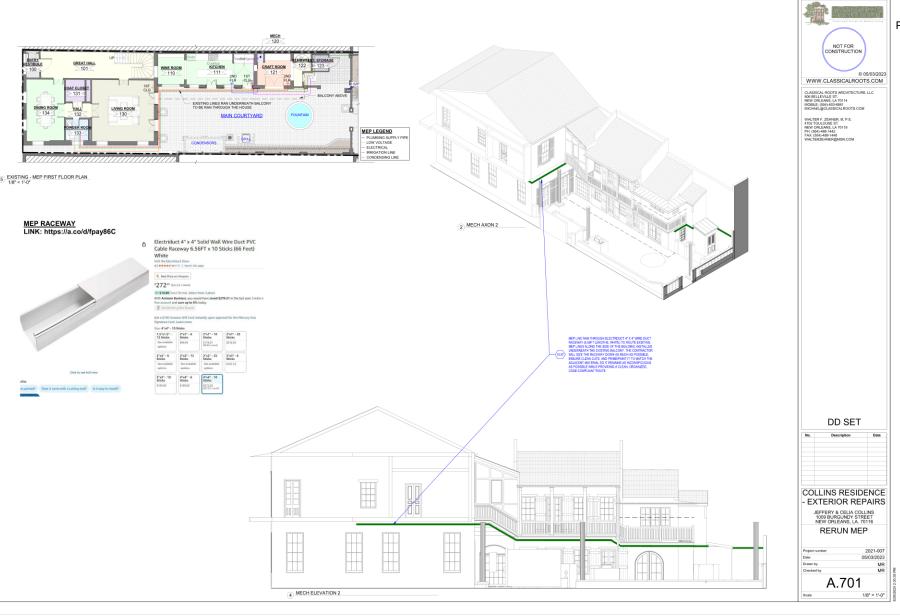


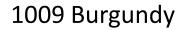



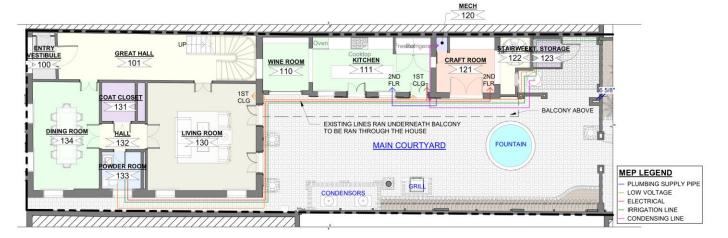

5 EXISTING - MEP FIRST FLOOR PLAN
1/8" = 1'-0"

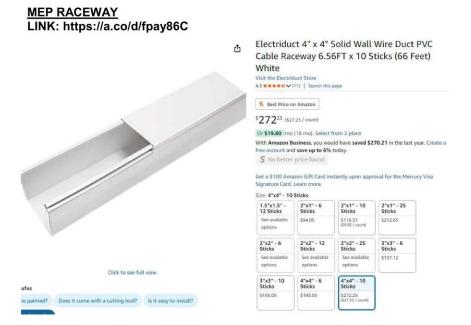











1009 Burgundy





PRODUCT DATA SHEET

Sikagard® SN-40

SILANE BASED REACTIVE WATER REPELLENT PENETRATING SEALER

PRODUCT DESCRIPTION

Sikagard® SN-40 is a highly penetrating, water-repelling silane sealer. Using proven technology, the material has been formulated to provide an integral barrier against the ingress of moisture and water-borne salts into concrete and masonry.

USES

- Building facades and civil engineering structures.
- Suitable for use on exposed horizontal and vertical surfaces including bridges and parking decks, barriers, abutment walls and marine structures.
- Prevention of deterioration arising out of soluble salts and freeze/thaw damage in reinforced concrete and porous block or brickwork.
- To help prolonging the design or service life of buildings and civil engineering structures.

CHARACTERISTICS / ADVANTAGES

- Good penetration
- · Solvent based emulsion, good for low temperatures
- Economic and easy to use
- Reduces capillary water absorption, protection against driving rain and splashing on vertical areas
- Reduction of absorption of aggressive or deleterious agents dissolved in water (i.e. chlorides)
- No change in water vapor permeability increases the resistance of concrete to freeze and thaw cycles and de-icing salts
- Resistant to sea water
- Ready to use

PRODUCT INFORMATION

Chemical Base	100% reactive alkylalkoxy silane in mineral spirits		
Packaging	55 gallon drum		
Shelf Life	2 years in original, unopened container		
Storage Conditions	Store between 0 and 85 $^{\circ} F$ (-18 and 30 $^{\circ} C$). Condition material between 50 and 85 $^{\circ} F$ (10 and 30 $^{\circ} C$) prior to use.		
Density	6.9 lbs/gal.		
Flash Point	102°F		
Active Content	40%		
Viscosity	<20 cps		

Product Data Sheet

Sikagard® SN-40 March 2020, Version 01.02 020303010010000019

1/4

1009 Burgundy

TECHNICAL INFORMATION

Resistance to Alkalinity	85.3%	150 ft²/gal		(Alberta BT002)	
	84.2%	225 ft²/gal			
Permeability to Water Vapor	90.2%	150 ft²/gal		(Alberta BT001)	
,	84.3%	225 ft²/gal		,	
-	()	363			
Rapid Chloride Permeability	82%	1 day		(NCHRP 244 Series II)	
	87%	5 days			
	90%	21 days			
	98%			(NCHRP 244 Series IV)	
	53.5%	0.625-0	0.5" depth	(AASHTO T-259/260)	
Coverage	The recommended coverage rate for most concrete substrates is 150 ft²/gal. Very porous surfaces may require 2 coats.				
	Substrate	Coverage		-1	
	Bridge Decks/Ramps 150-250 ft²/ga				
				150-300 ft²/gal	
	Smooth Concrete 150-225 ft²/g				
	Exposed Aggregate 100-200 ft²/g				
	Concrete Block 50-100 ft²/gal				
	Brick/Stone		60-200 ft ² /gal		
	Coverage rates are provided as a guideline only. Many factors including surface texture, porosity and weather conditions will determine actual coverage rates.				
Substrate Temperature	Recommended substrate temperatures are between 40-90°F Material may be applied as low as 20°F, providing the substrate is ice- free/frost-free, though lower penetration might be expected.				
Waiting / Recoat Times	Sikagard* SN-40 loses its solvent very rapidly after application. However, the reaction of the residual silane monomer with the substrate will take at least 24 hours at a temperature of 77 °F (25 °C). Drying is considerably longer at colder temperatures. Do not apply if rain is expected within 4-6 hrs of application.				

SURFACE PREPARATION

All surfaces must be clean, sound, frost free and dry (maximum depth of penetration is achieved when substrates are dry, with no damp patches). Any existing coatings, surfaces treatments, accumulated pollutants, dust, dirt, oil and efflorescence must be removed. A substrate clogged with dirt or oil will not permit proper sealer penetration. Uncoated surfaces must be free from curing compound residues and any material or contaminants detrimental to penetration. Best results are achieved when Sikagard® SN-40 is applied onto 28 days old or older concrete, however, due to its high alkali resistance, it is possible to apply it earlier. All substrates requiring preparation, such as contaminated surfaces or horizontal concrete slabs, must be properly cleaned before the sealer is applied. This is best achieved using grinding, light sand-blasting, shotblasting or high pressure water blasting. Allow adequate

Product Data Sheet Sikagard® SN-40 March 2020, Version 01.02 0203030100100000019

time for surfaces to dry (for best penetration) before proceeding with application. A test patch should always be performed to determine proper results and coverage rates prior to application.

The material is ready for use and requires no mixing. Do

APPLICATION

Vertical Surfaces: Apply Sikagard® SN-40 using a brush, roller or industrial spray equipment, working from top to bottom by maintaining a 12 in (30 cm) parallel curtain (run down). When applying the material on a vertical surface, avoid accumulation and run-off of the material. In the event of material accumulation or run-off lines being formed, redistribute the material on the surface or



BUILDING TRUST



Page 110 of 215

2/4

remove by sponging. In most cases, the flood coat should be applied in two (2) passes. Apply a light spray to break the surface tension of the wall and follow immediately with a flood coat, "wet on wet", with the second pass at right angles to the first. Fully saturate all mortar joints.

Horizontal Surfaces: Apply Sikagard* SN-40 using a roller or low-pressure spray, ensuring that product penetrates the substrate and does not "pond" or "puddle" on the surface. If ponding occurs, make sure to redistribute or remove the excess material on the surface before material starts to dry and form a film that will prevent penetration of excess material. Where working on a horizontal surface the flood coat should be applied in two (2) passes, "wet on wet" with the second pass at right angles to the first. Complete and correct coverage of surfaces is crucial to the success of such sealers. Fully saturate all mortar joints.

LIMITATIONS

- Sikagard® SN-40 is best applied onto 28 day old concrete or older, however, due to its high alkali resistance, it is possible to apply it earlier, though lower penetration might be expected.
- Can be applied at temperatures down to 20°F, providing the surface is ice-free/frost-free, though lower penetration might be expected.
- Not recommended for exterior applications if rain is expected within 4-6 hours.
- Not intended for waterproofing under hydrostatic pressure, in permanent contact with water or for below ground waterproofing.
- Not intended to seal visible cracks from moisture ingress.
- Building materials not to be treated (e.g. window frames and glazing) must be protected from contact. In case of splashes, clean immediately using clean water and a squeegee.
- Some coatings and bituminous materials may be damaged by the Sikagard® SN-40; care is required during application or protection against contact may be necessary.
- Use Sikagard® SN-40 with adequate ventilation.
- Surfaces treated with Sikagard® SN-40 cannot be overcoated with either cement or lime-wash based paints.

 Sikagard* SN-40 is clear and typically "invisible" to the eye once cured and dried, however if there are strict aesthetic requirements (for example on natural stone) it is recommended to undertake preliminary trials as slight darkening of some surfaces may occur.

 Do not let dry excess material, darkening, change of color and appearance of substrate may occur

BASIS OF PRODUCT DATA

Results may differ based upon statistical variations depending upon mixing methods and equipment, temperature, application methods, test methods, actual site conditions and curing conditions.

OTHER RESTRICTIONS

See Legal Disclaimer.

ENVIRONMENTAL, HEALTH AND SAFETY

For further information and advice regarding transportation, handling, storage and disposal of chemical products, user should refer to the actual Safety Data Sheets containing physical, environmental, toxicological and other safety related data. User must read the current actual Safety Data Sheets before using any products. In case of an emergency, call CHEMTREC at 1-800-424-9300, International 703-527-3887.

LEGAL DISCLAIMER

- KEEP CONTAINER TIGHTLY CLOSED
- KEEP OUT OF REACH OF CHILDREN
- NOT FOR INTERNAL CONSUMPTION
- FOR INDUSTRIAL USE ONLY
- FOR PROFESSIONAL USE ONLY

Prior to each use of any product of Sika Corporation, its subsidiaries or affiliates ("SIKA"), the user must always read and follow the warnings and instructions on the product's most current product label, Product Data Sheet and Safety Data Sheet which are available at usa.sika.com or by calling SIKA's Technical Service Department at 1-800-933-7452. Nothing contained in any SIKA literature or materials relieves the user of the obligation to read and follow the warnings and instructions for each SIKA product as set forth in the current product label, Product Data Sheet and Safety Data Sheet prior to use of the SIKA product.

SIKA warrants this product for one year from date of installation to be free from manufacturing defects and to meet the technical properties on the current Product Data Sheet if used as directed within the product's shelf life. User determines suitability of product for intended use and assumes all risks. User's and/or buyer's sole remedy shall be limited to the purchase price or replacement of this product exclusive of any labor costs. NO OTHER WARRANTIES EXPRESS OR IMPLIED SHALL

Product Data Sheet Sikagard® SN-40 March 2020, Version 01.02 020303010010000019


3/4

Jika

BUILDING TRUST

1009 Burgundy



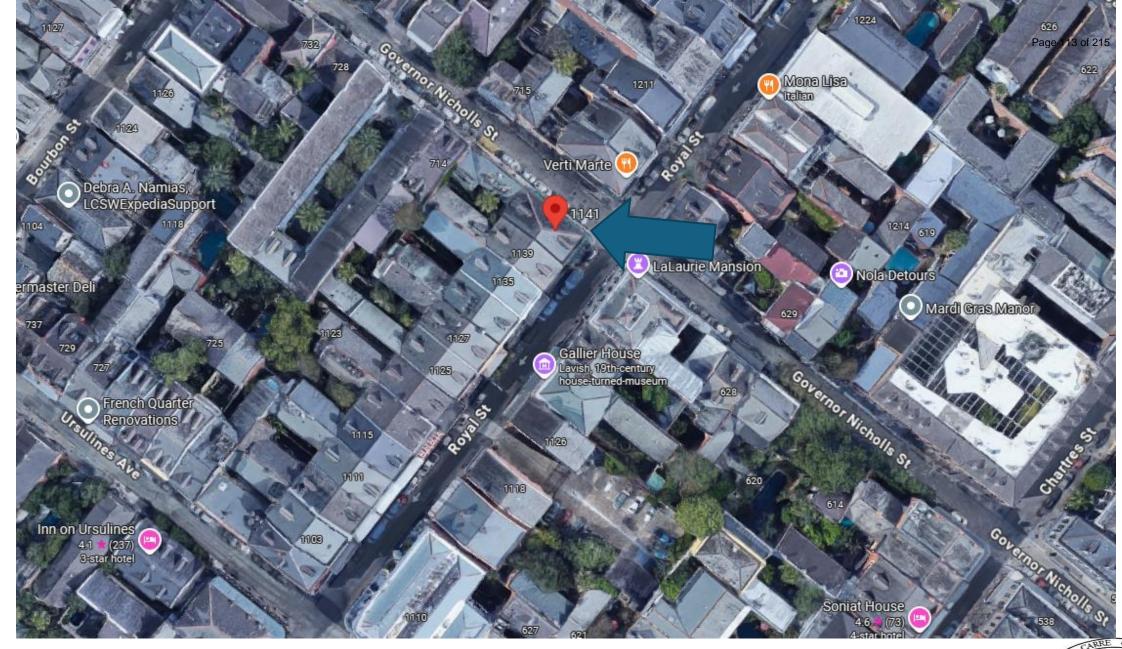





September 9, 2025



















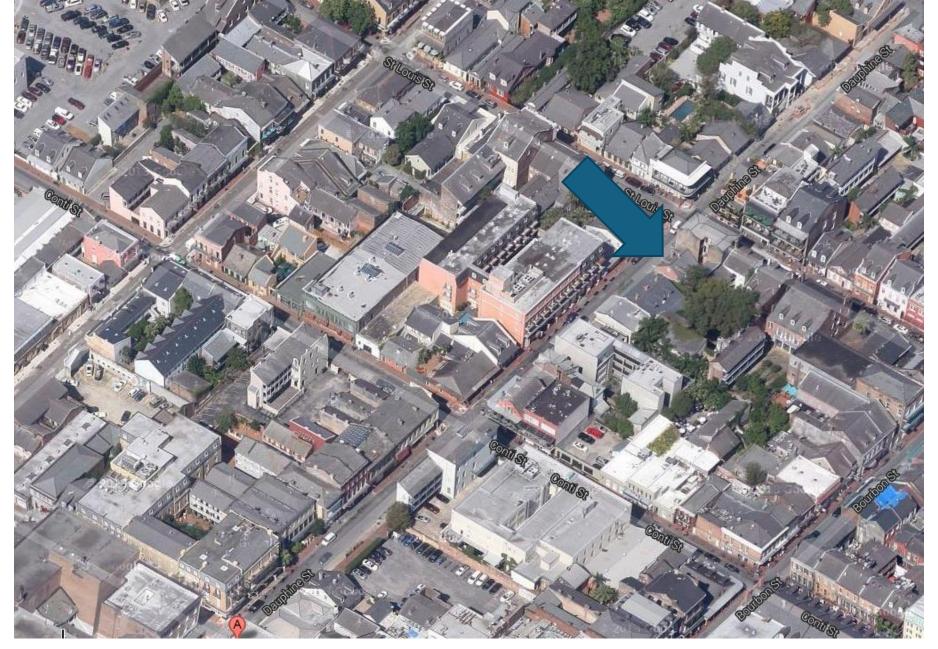






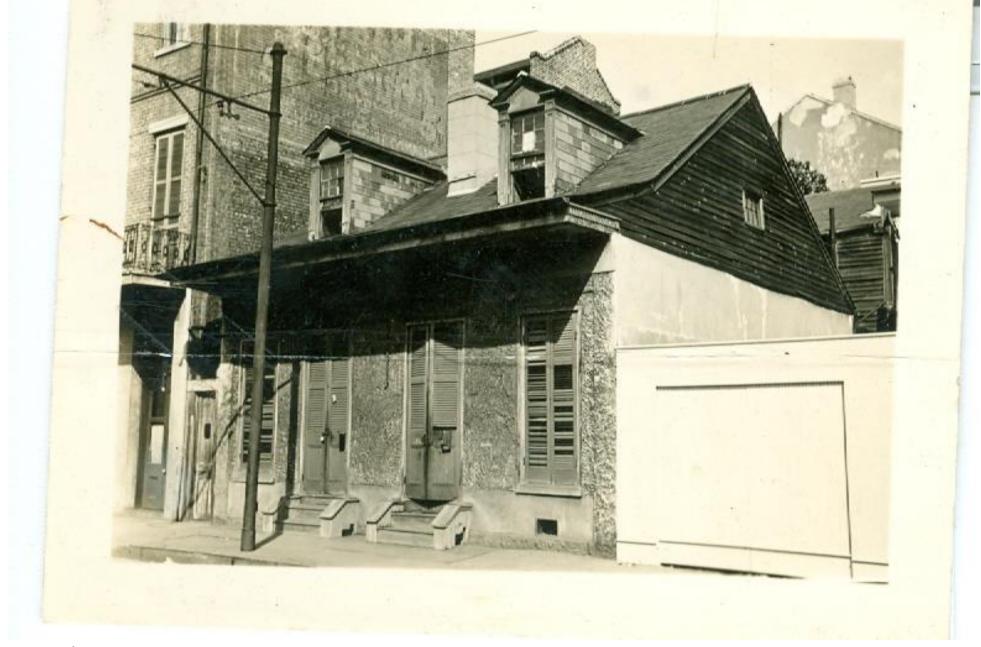





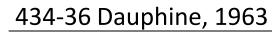












September 9, 2025






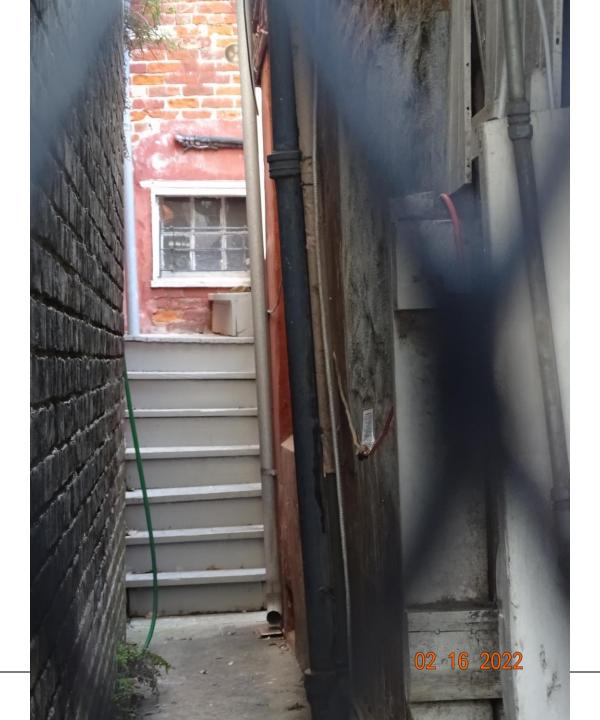






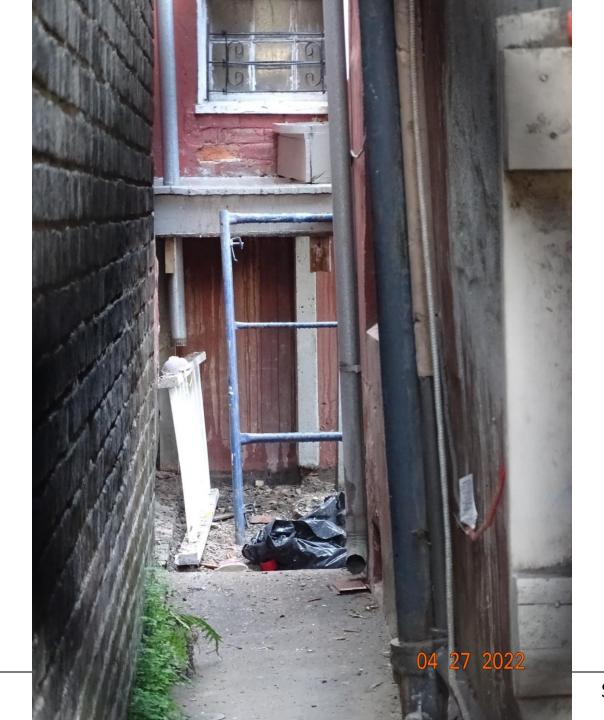







September 9, 2025

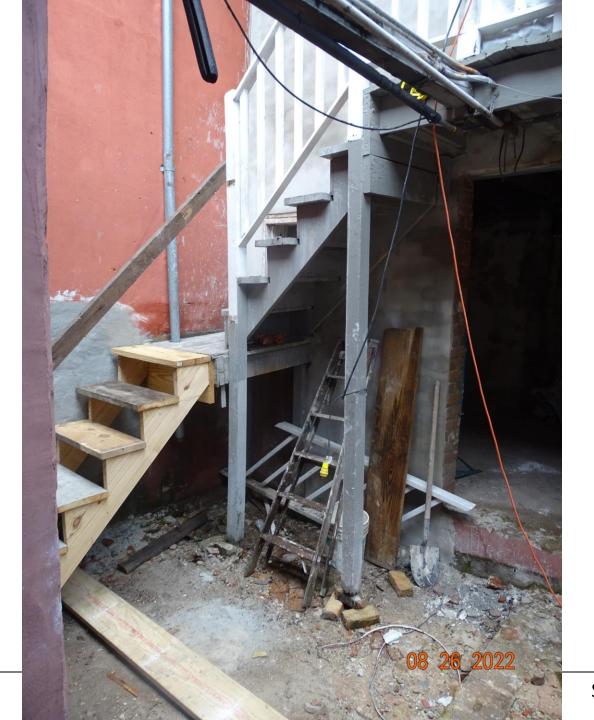



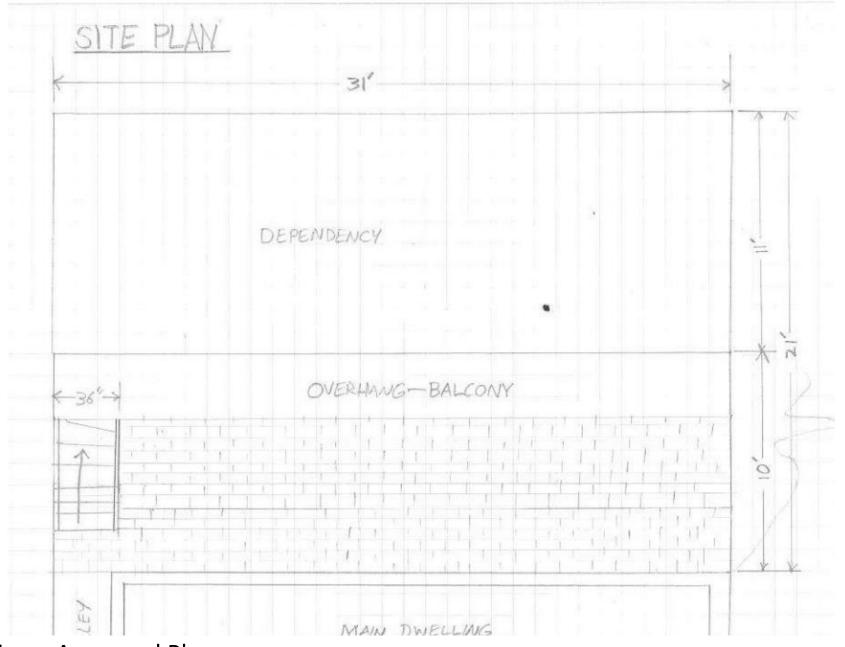

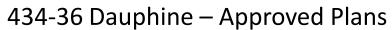














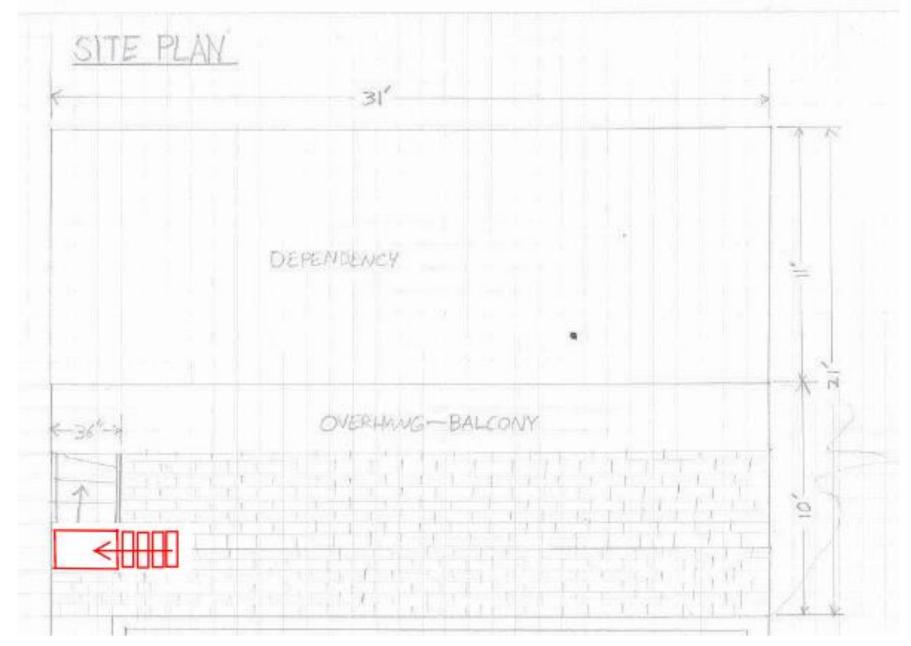

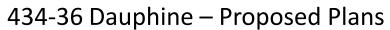






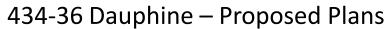




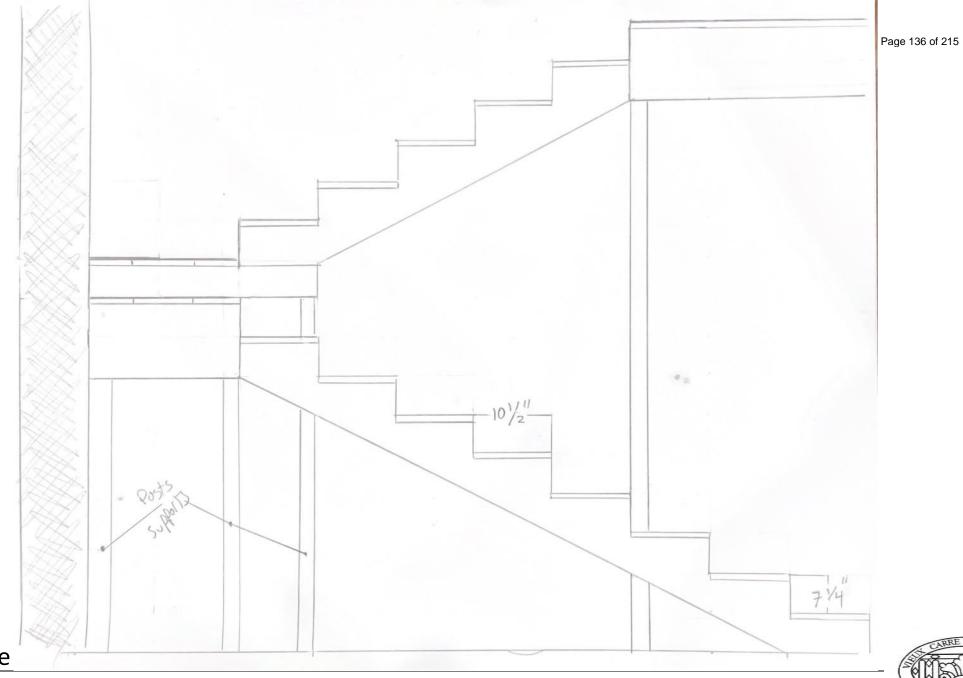







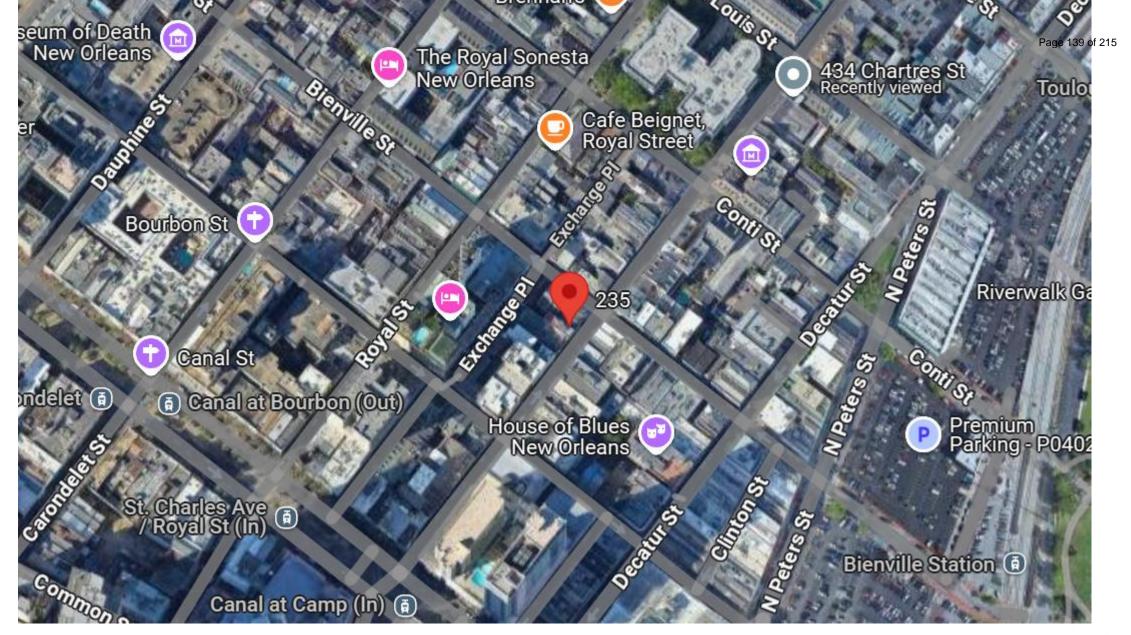







235 Chartres














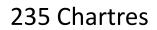




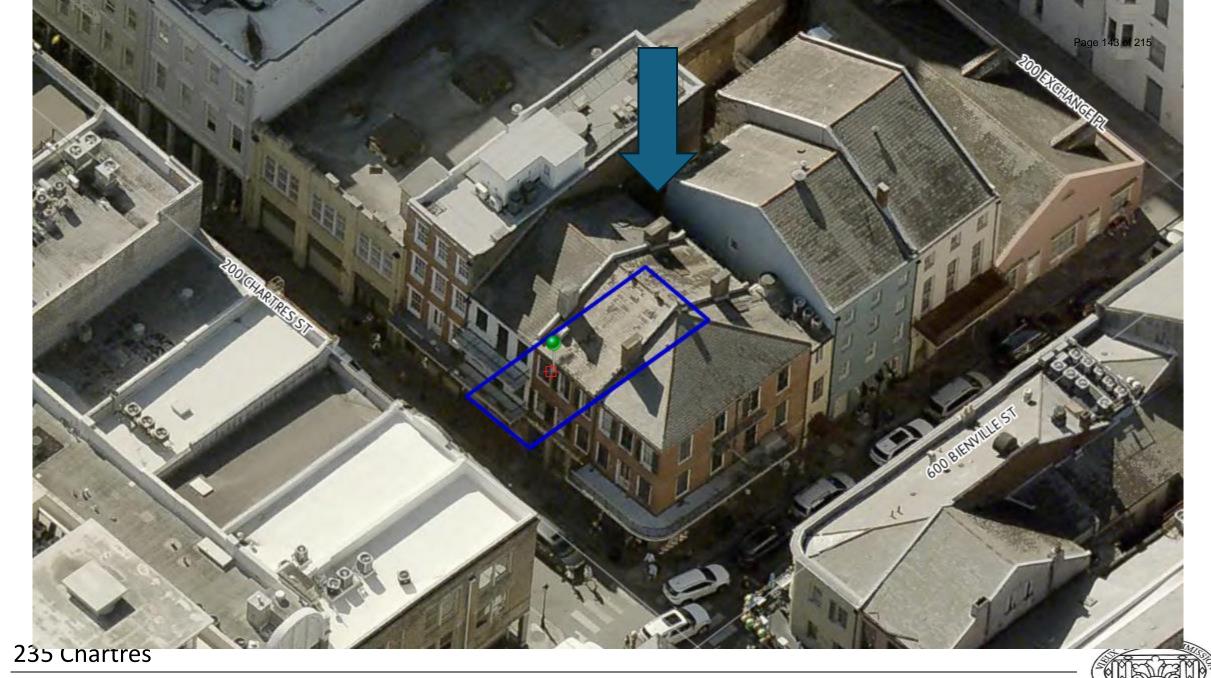


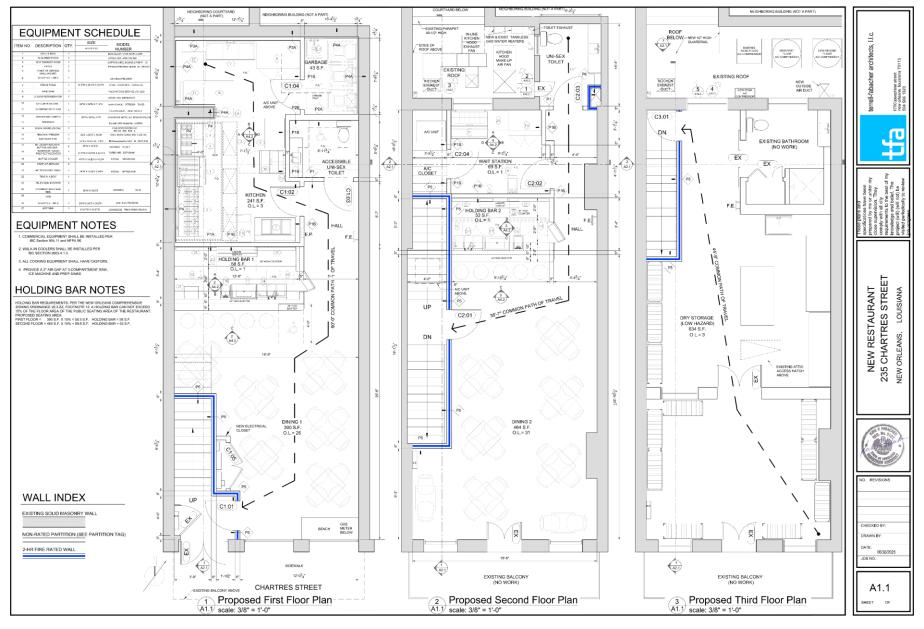



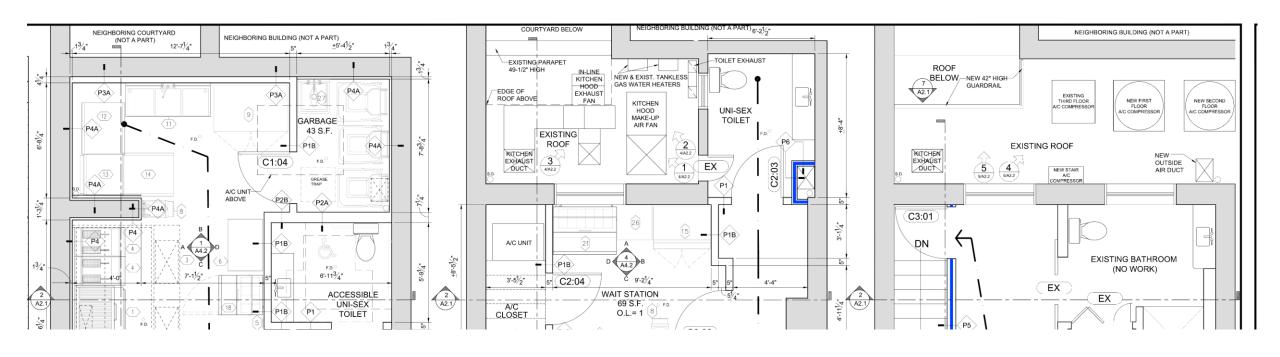




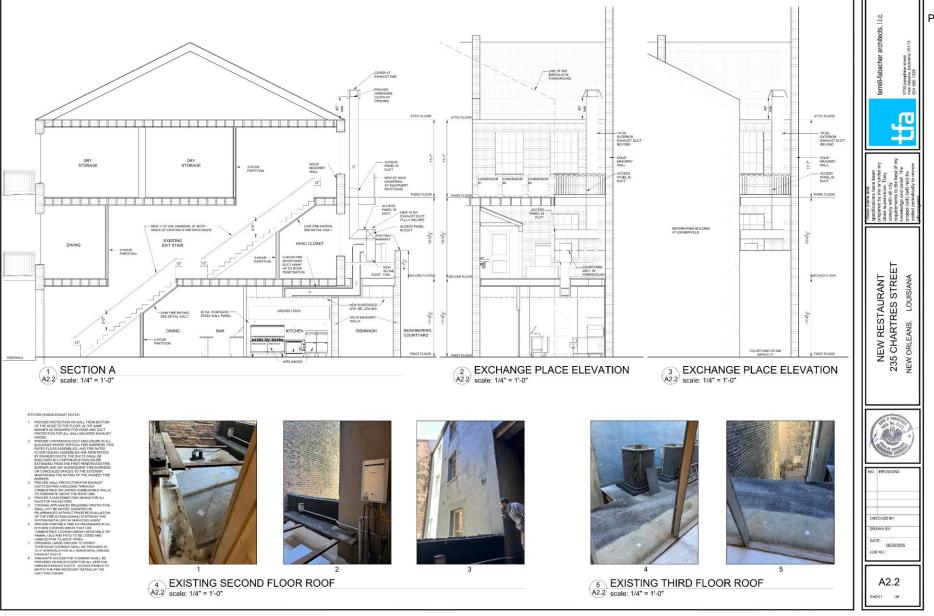


235 Chartres



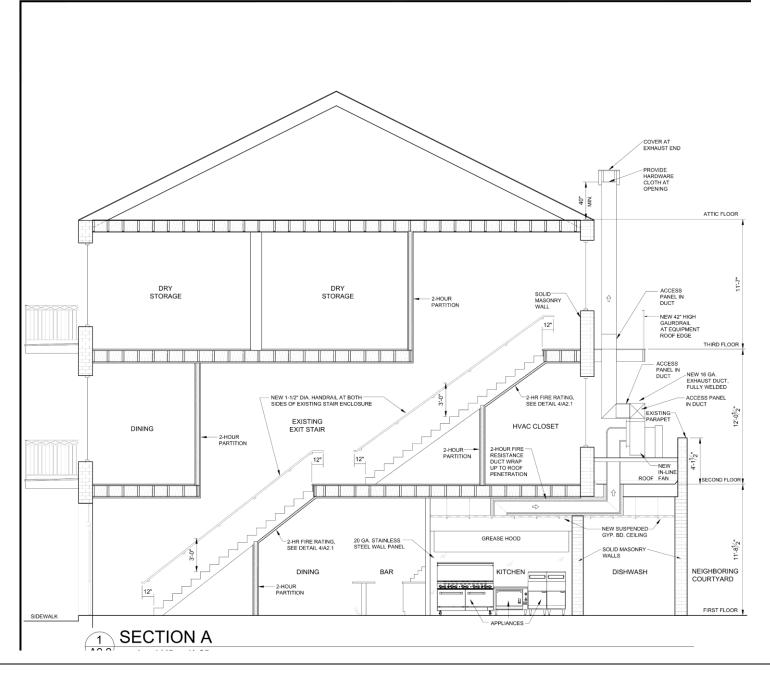



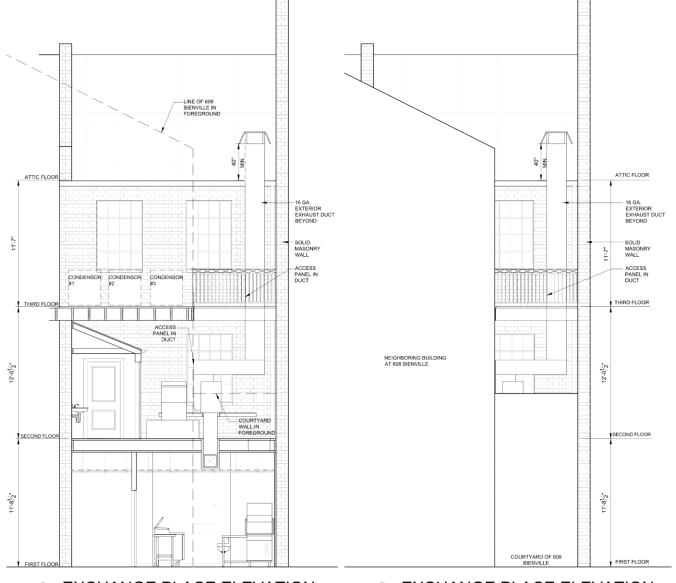


2 EXCHANGE PLACE ELEVATION scale: 1/4" = 1'-0"

3 EXCHANGE PLACE ELEVATION 82.2 scale: 1/4" = 1'-0"





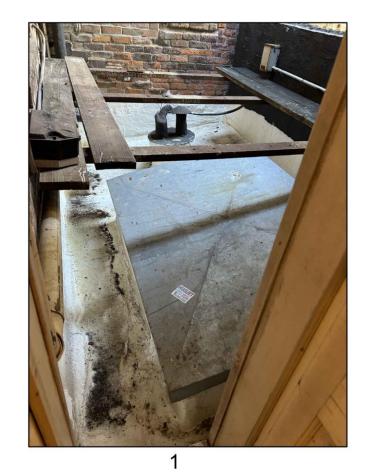





3



EXISTING SECOND FLOOR ROOF

A2.2 scale: 1/4" = 1'-0"

235 Chartres







5




²/ scale: 1/4" = 1'-0"







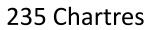




















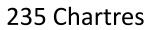


















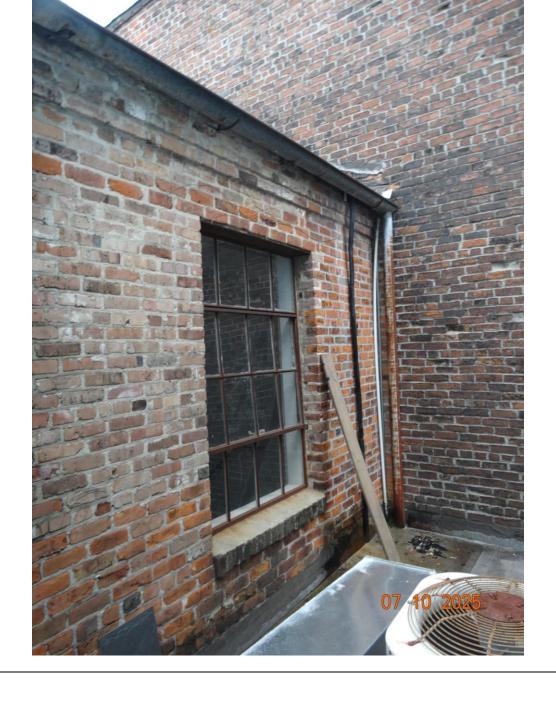



























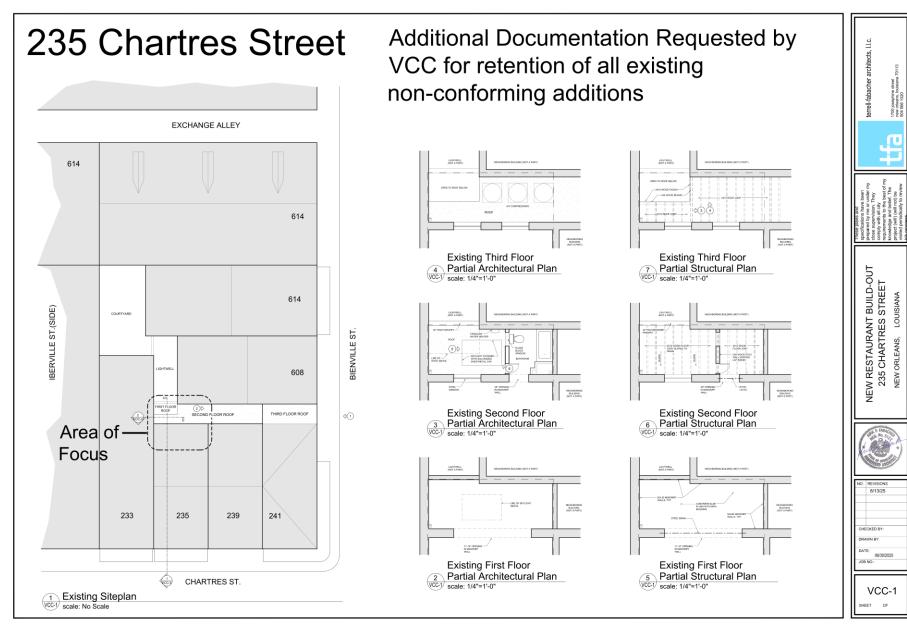







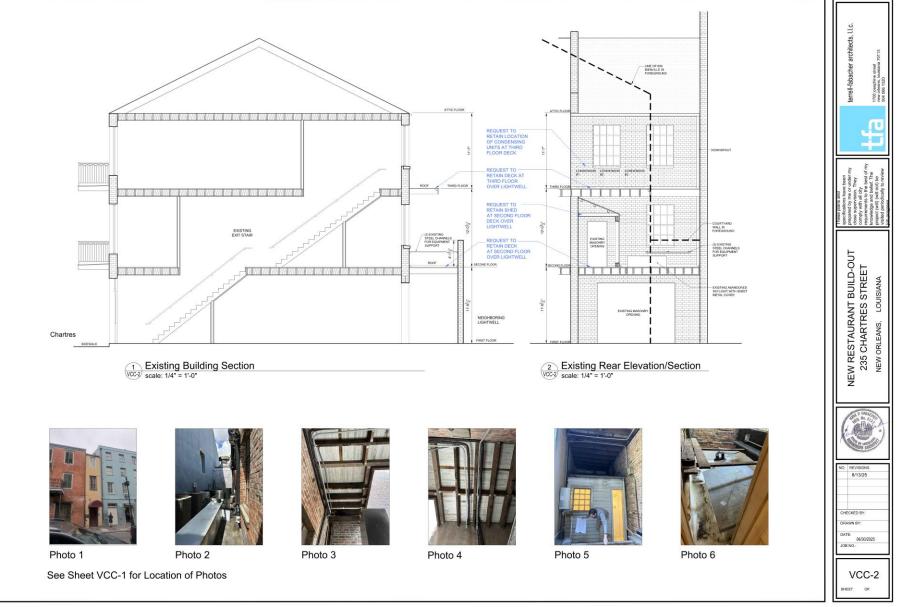



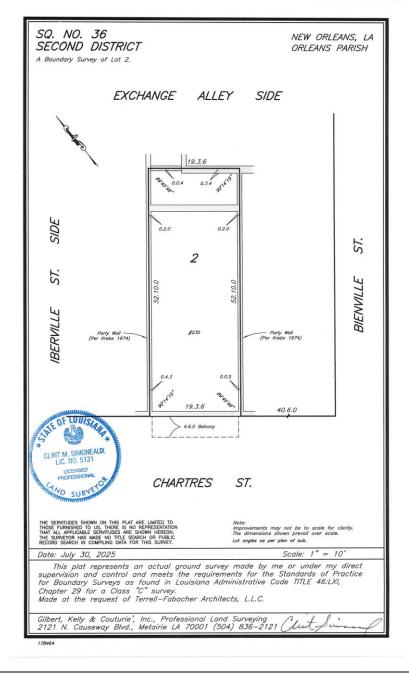


235 Chartres

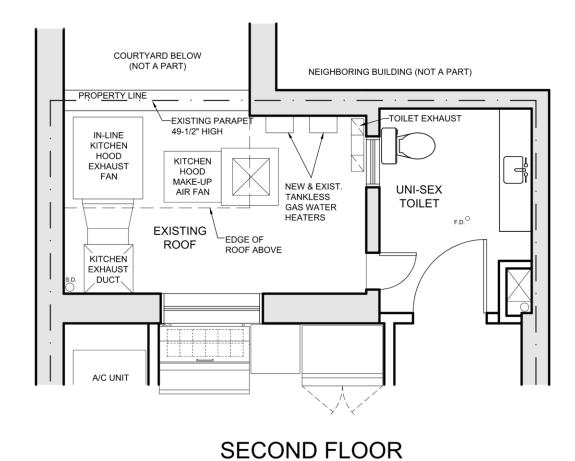

NEIGHBORING BUILDING (NOT A PART) PROPERTY LINE ROOF **BELOW** -NEW 42" HIGH-**GUARDRAIL** THIRD FLOOR A/C COMPRESSOR HP-1 HP-2 **EXISTING ROOF** NEW OUTSIDE KITCHEN EXHAUST AIR DUCT HP-3


THIRD FLOOR

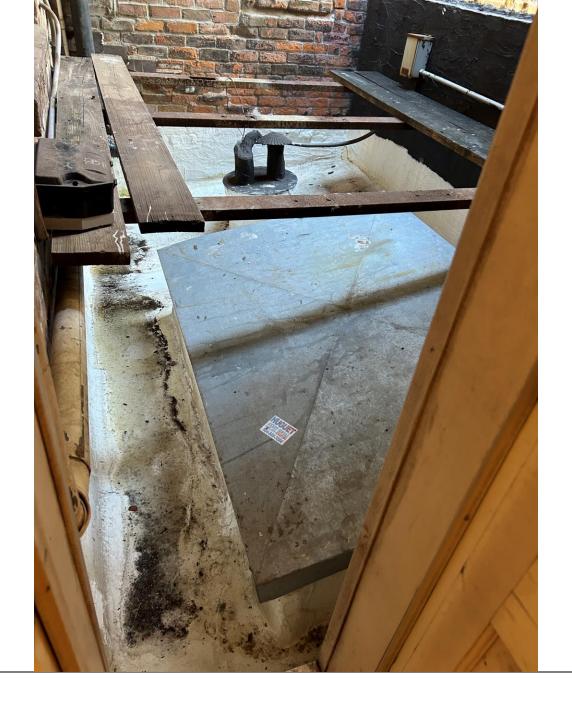








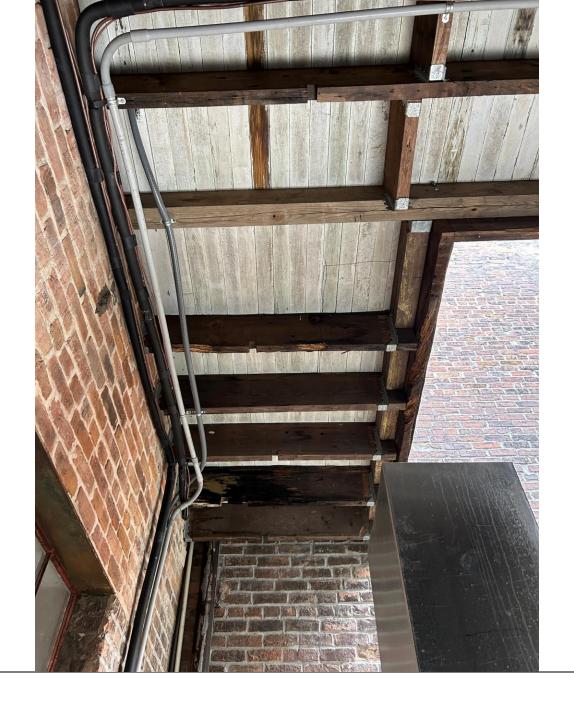






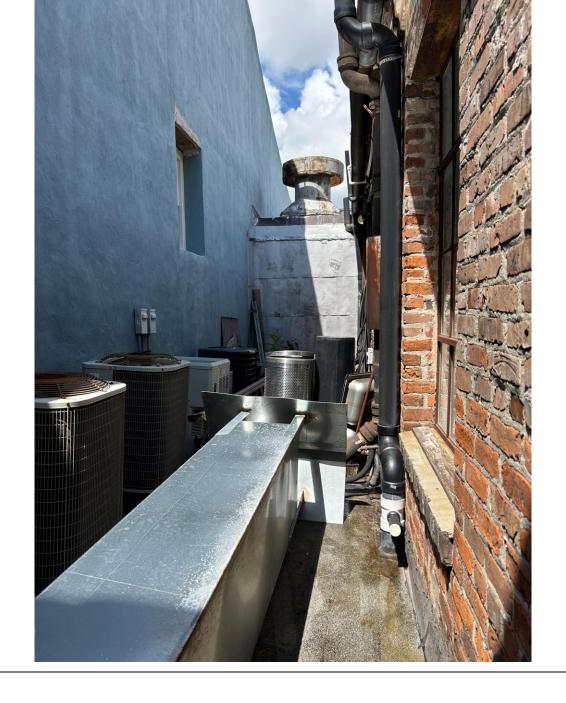




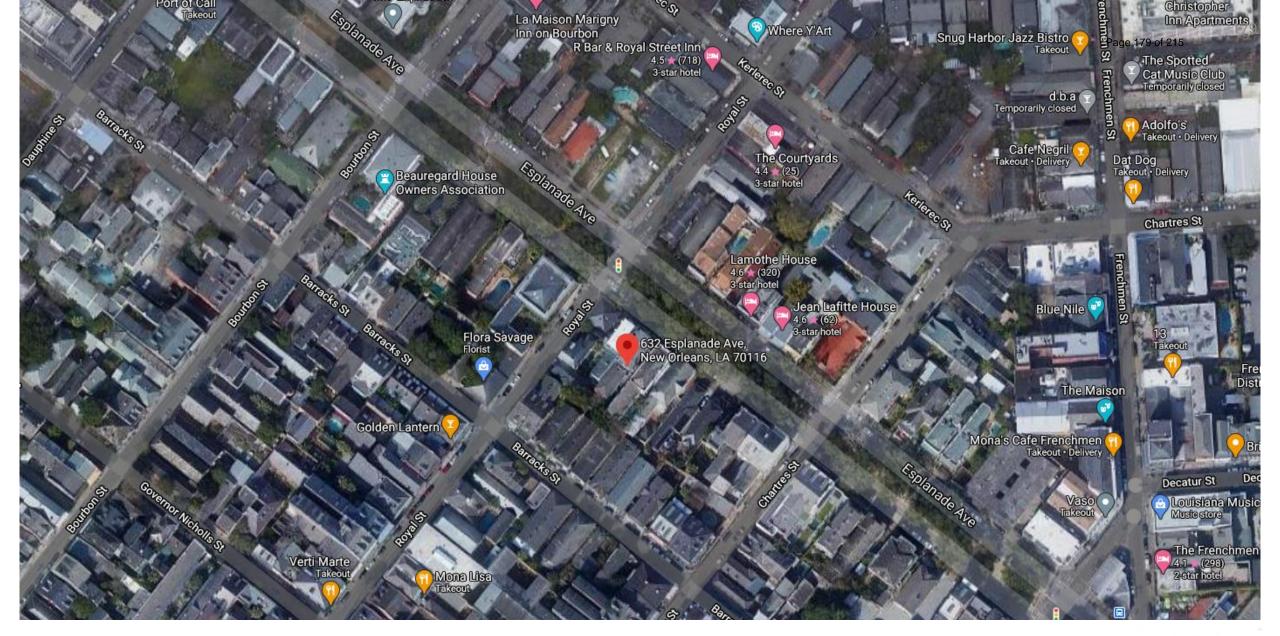





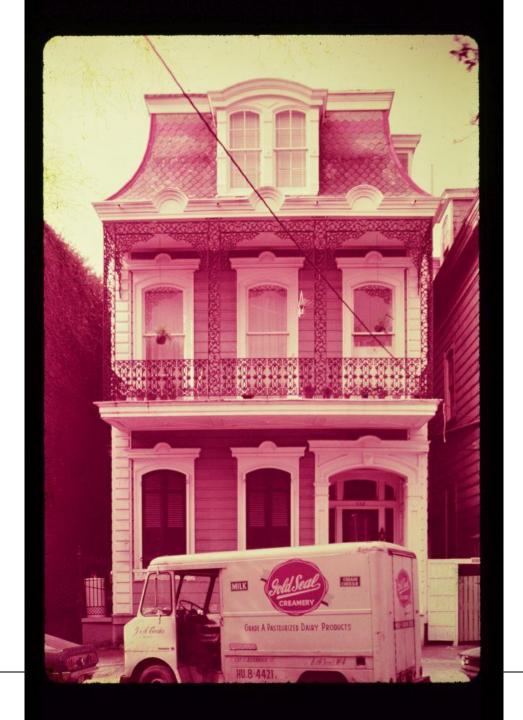


























VCC Architectural Committee

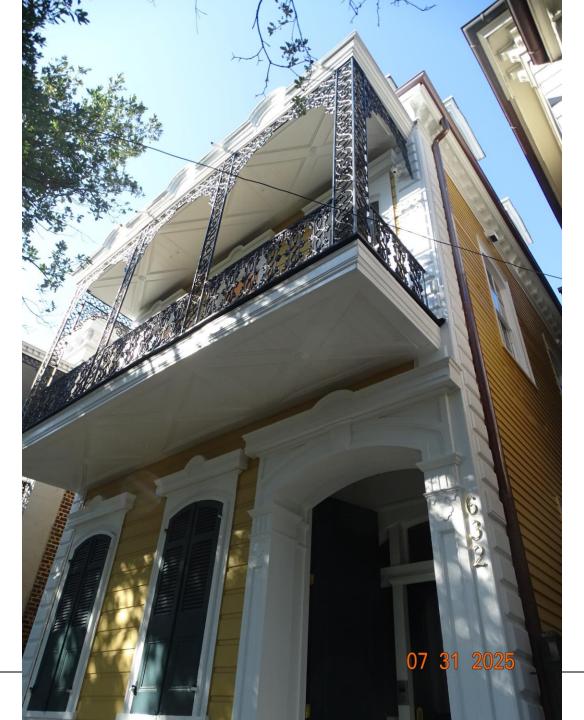




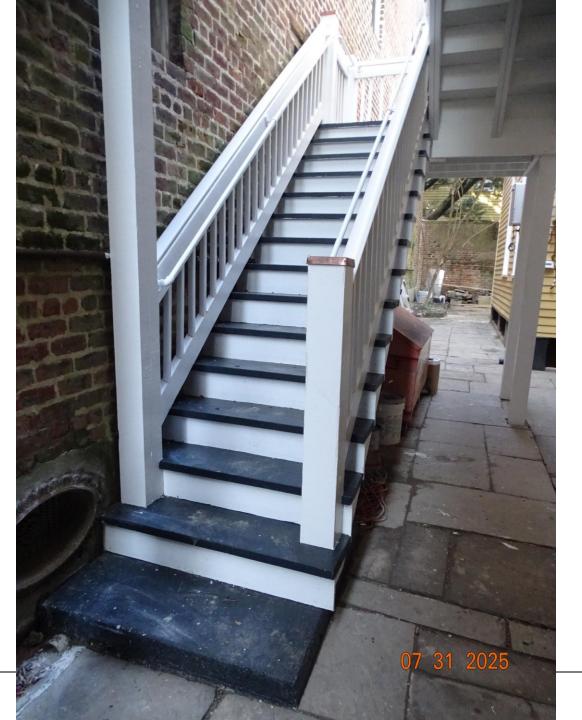




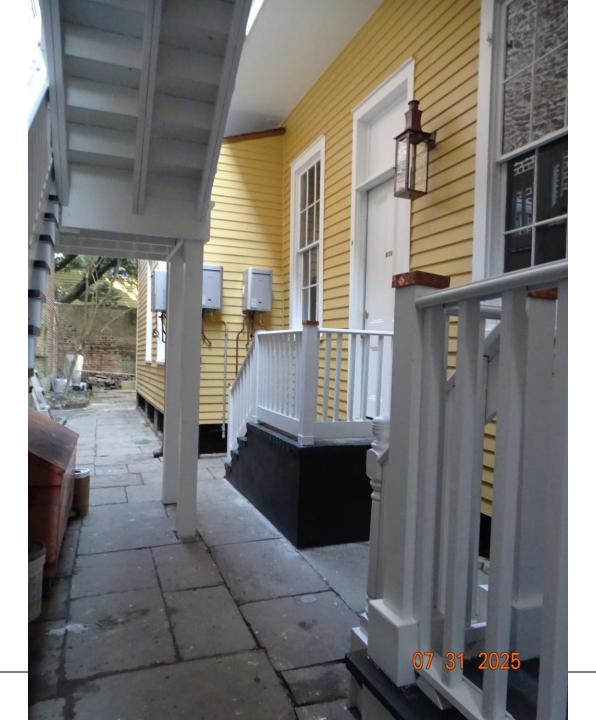




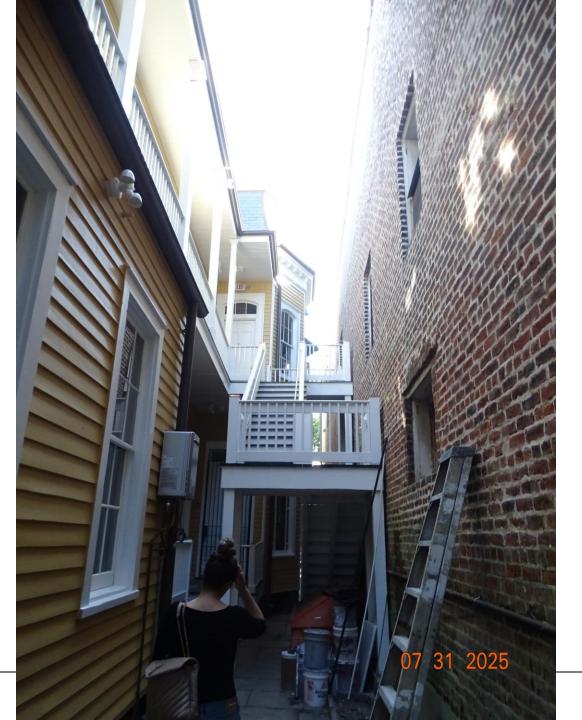



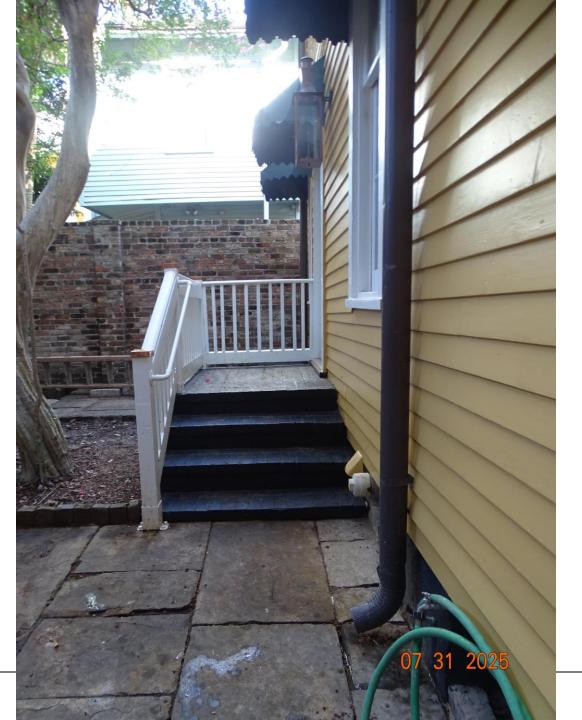




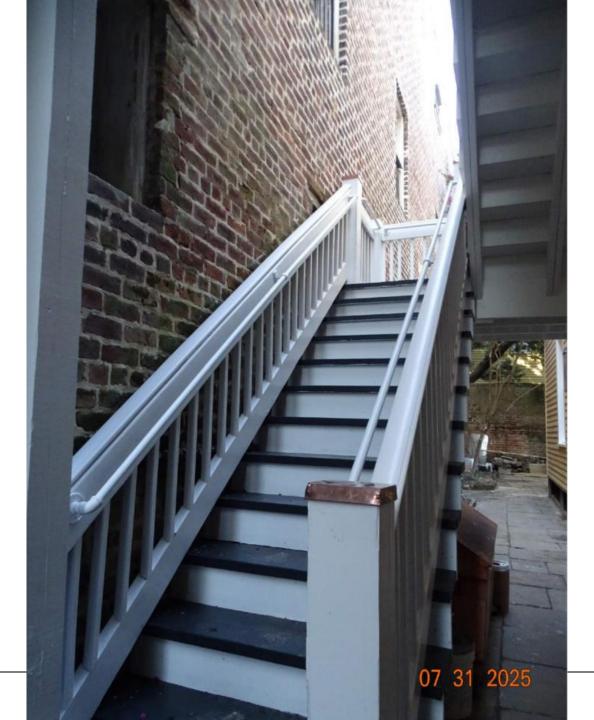





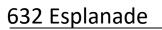


VCC Architectural Committee







6 in. x 6 in. Verona Copper High Point Pyramid Post Cap

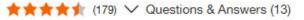














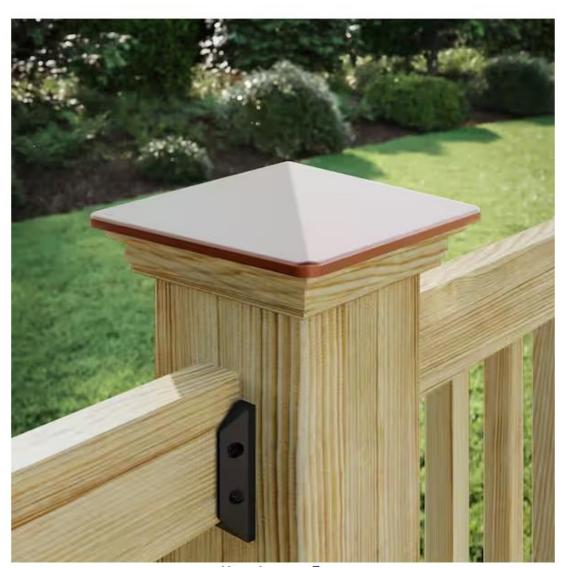




Highlights

- Features pressure-treated pine base
- Capped with elegant copper-plated plastic to provide long lasting finish
- Virtually maintenance free with no painting or staining needed
- Post cap fits a nominal 4 in. x 4 in. wood post (inside dimensions 3-5/8 in. x 3-5/8 in.)
- Add a finishing touch to the overall appearance of your outdoor space
- Use exterior grade construction adhesive to adhere the cap to post





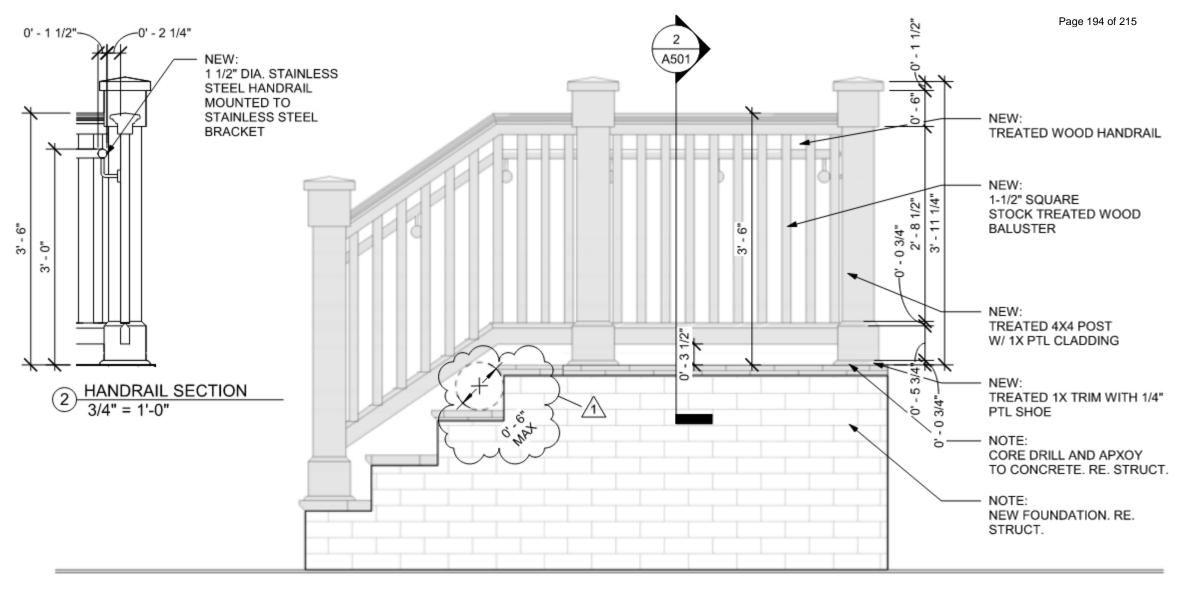

1) PROPOSED CONSTRUCTION OF EXTERIOR STAIRS


632 Esplanade – From Approved Plans








Page 196 of 215

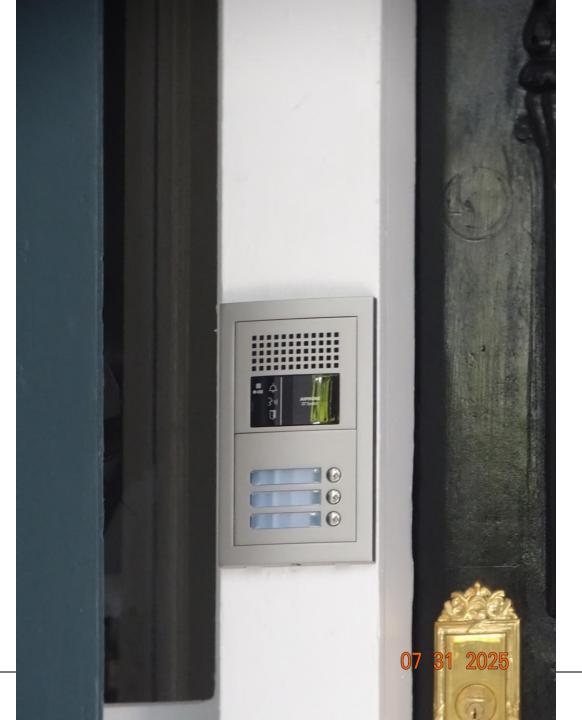



VCC Architectural Committee



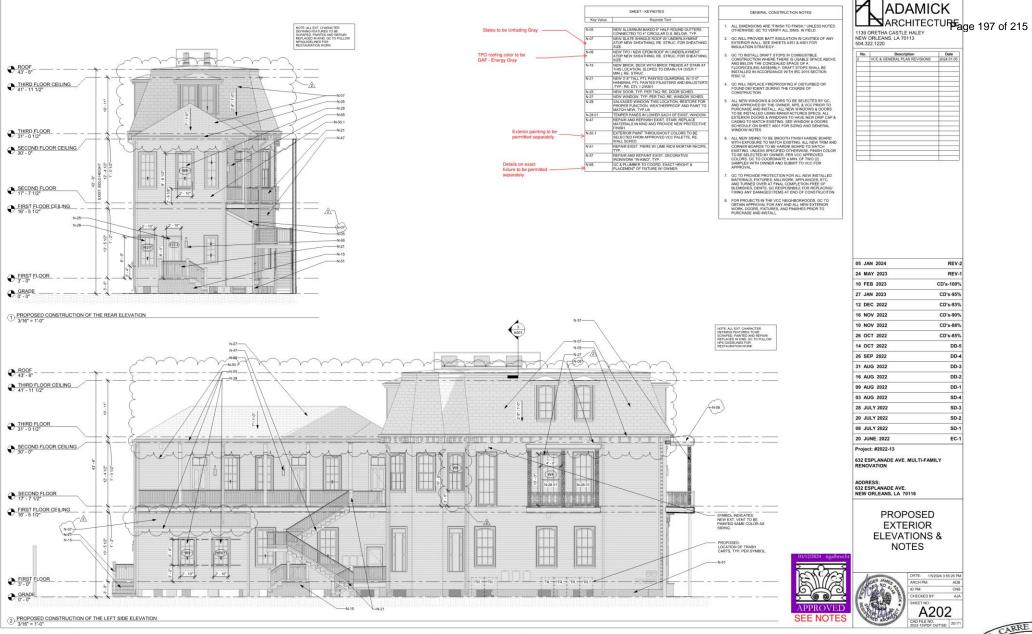


632 Esplanade – Lighting – Previously Approved Plans

VCC Architectural Committee

September 9, 2025



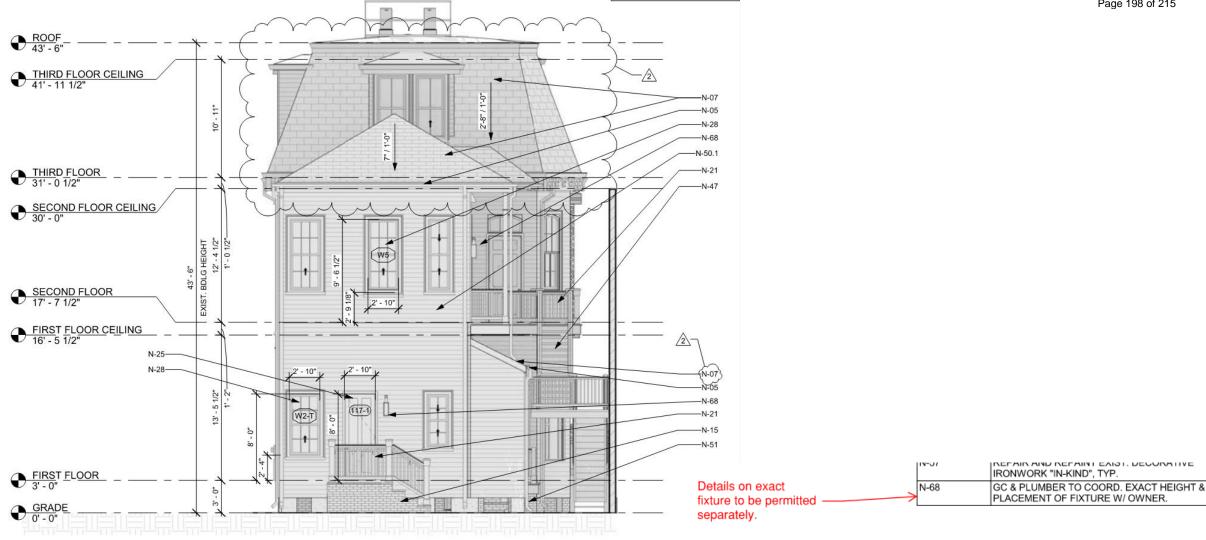


 $\underbrace{ \text{ 1} \text{ PROPOSED CONSTRUCTION OF THE REAR ELEVATION} }_{\text{3/16"} = \text{ 1'-0"}}$

632 Esplanade – Lighting – Previously Approved Plans






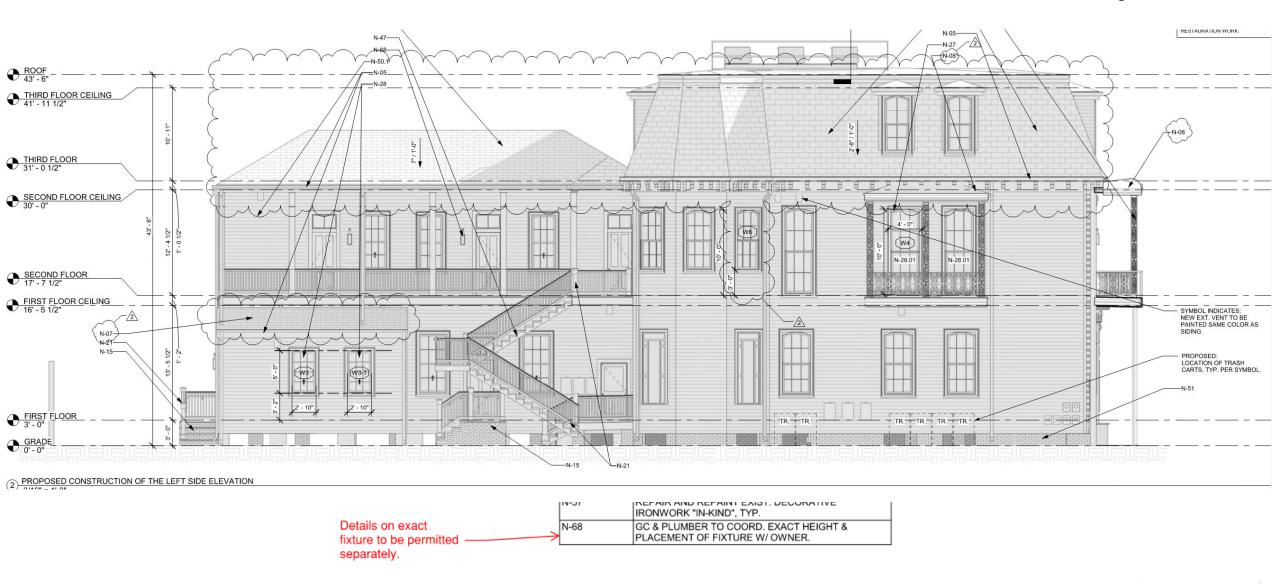


632 Esplanade – Lighting – Previously Approved Plans



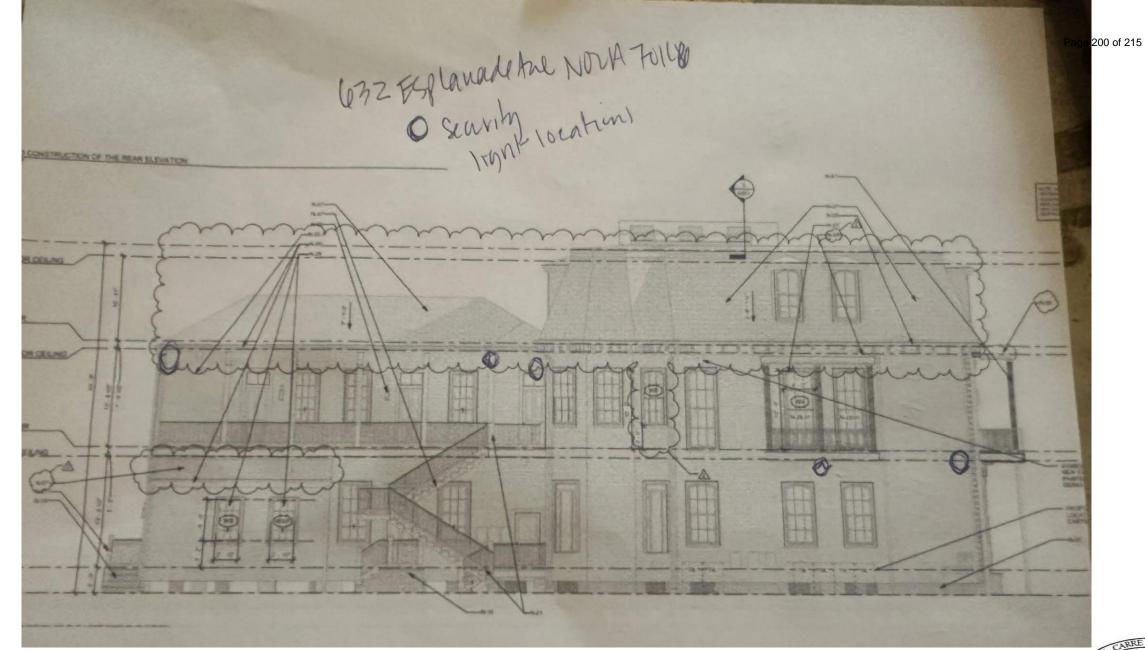

632 Esplanade

Page 201 of 215

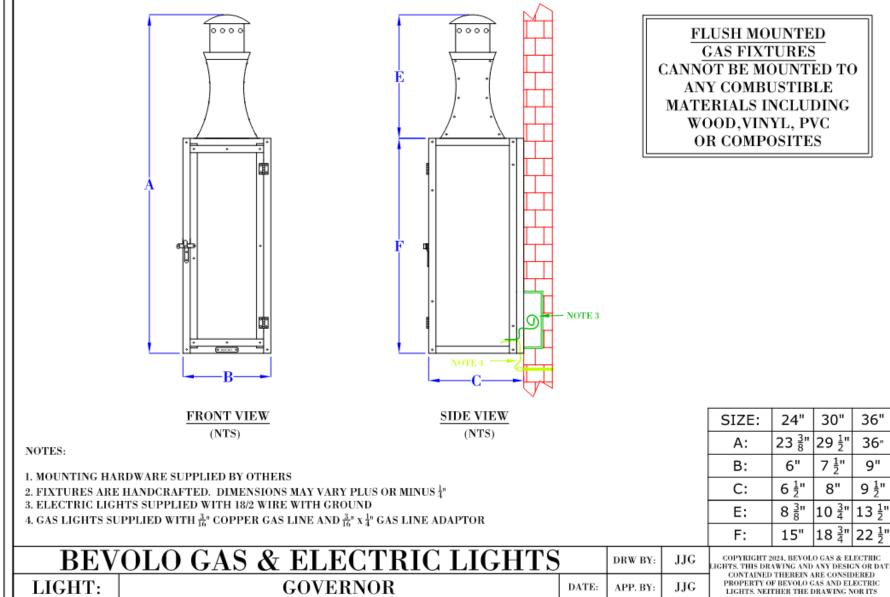

FLUSH MOUNT

632 Esplanade




BRACKET:

5-17-24 REVISION:






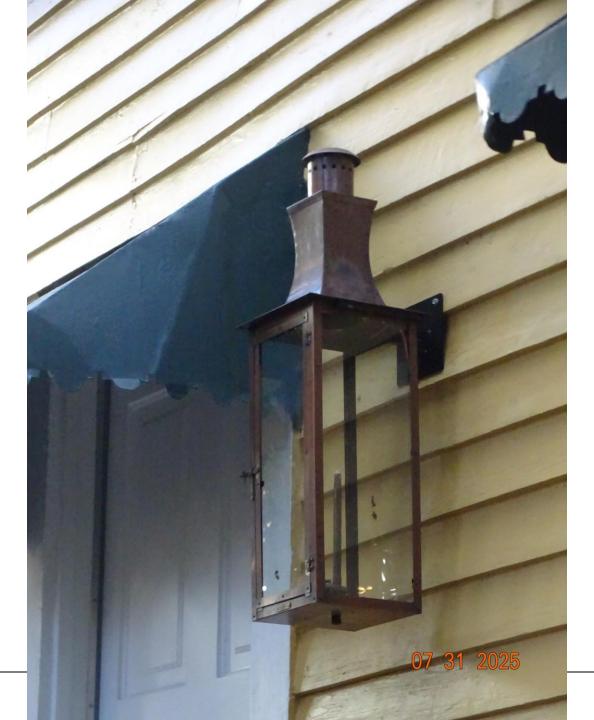




Page 204 of 215

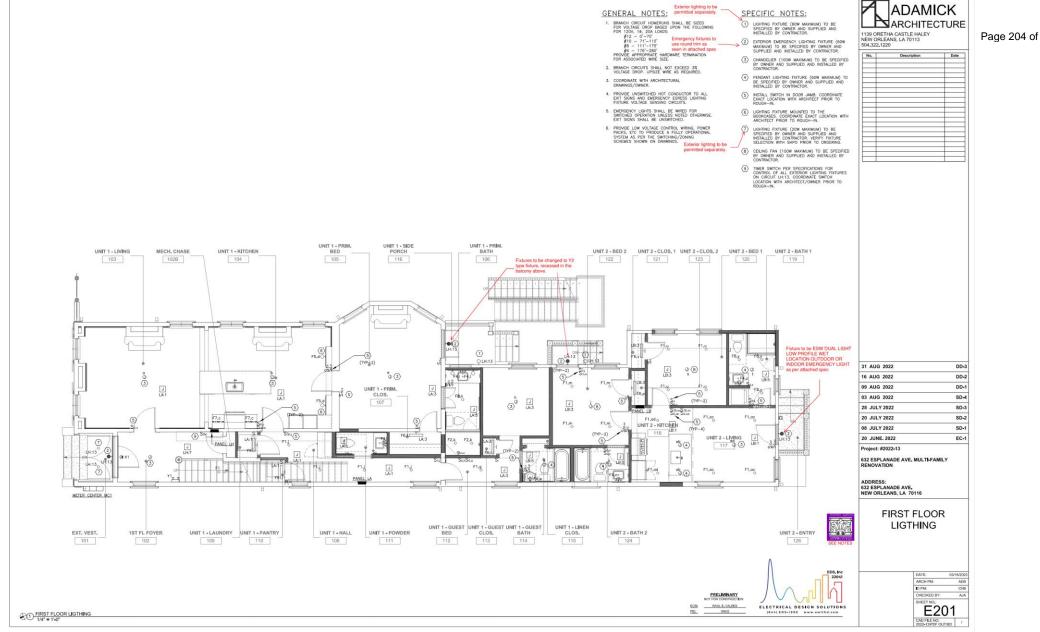

632 Esplanade – Lighting – Previously Approved Plans



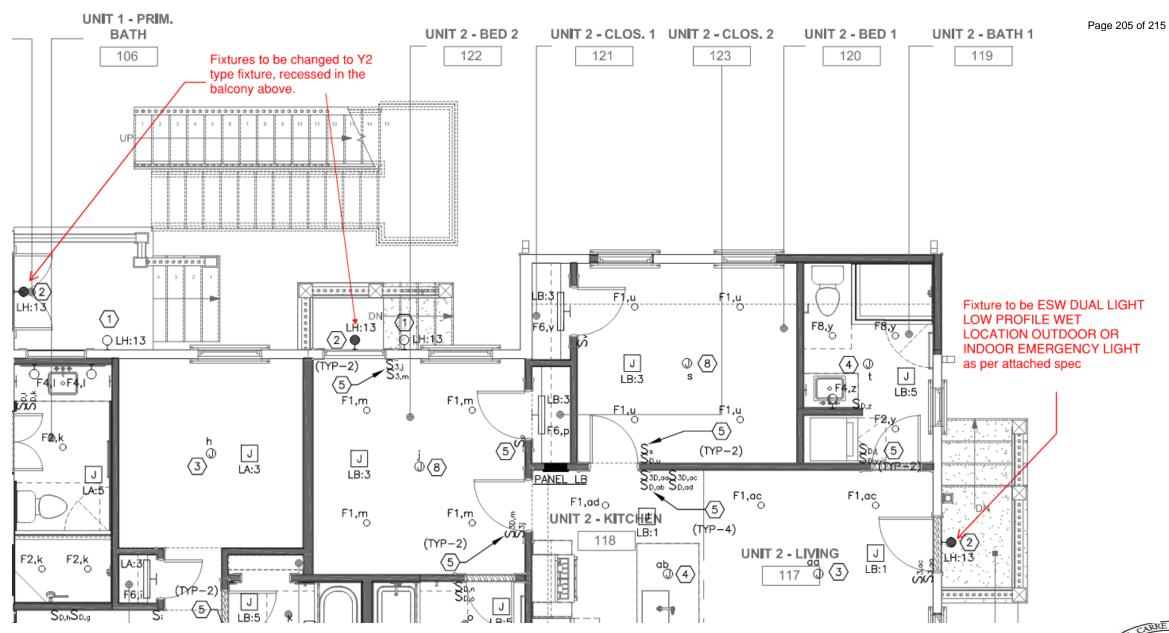

632 Esplanade – Lighting – Previously Approved Plans

September 9, 2025

Page 206 of 215

Exterior lighting to be permitted separately.

NS SHALL BE SIZED D UPON THE FOLLOWING S:

Emergency fixtures to use round trim as seen in attached spec

RDWARE TERMINATION ZE.

NOT EXCEED 3% /IRE AS REQUIRED.

ECTURAL

F CONDUCTOR TO ALL ICY EGRESS LIGHTING GIRCUITS.

. BE WIRED FOR .ESS NOTED OTHERWISE. SWITCHED.

ONTROL WIRING, POWER A FULLY OPERATIONAL ICHING/ZONING WINGS.

Exterior lighting to be permitted separately.

SPECIFIC NOTES:

- LIGHTING FIXTURE (60W MAXIMUM) TO BE SPECIFIED BY OWNER AND SUPPLIED AND INSTALLED BY CONTRACTOR.
- 2 EXTERIOR EMERGENCY LIGHTING FIXTURE (60W MAXIMUM) TO BE SPECIFIED BY OWNER AND SUPPLIED AND INSTALLED BY CONTRACTOR.
- 3 CHANDELIER (100W MAXIMUM) TO BE SPECIFIED BY OWNER AND SUPPLIED AND INSTALLED BY CONTRACTOR.
- PENDANT LIGHTING FIXTURE (60W MAXIMUM) TO BE SPECIFIED BY OWNER AND SUPPLIED AND INSTALLED BY CONTRACTOR.
- 5 INSTALL SWITCH IN DOOR JAMB. COORDINATE EXACT LOCATION WITH ARCHITECT PRIOR TO ROUGH-IN.
- 6 LIGHTING FIXTURE MOUNTED TO THE BOOKCASES. COORDINATE EXACT LOCATION WITH ARCHITECT PRIOR TO ROUGH-IN.
- LIGHTING FIXTURE (20W MAXIMUM) TO BE SPECIFIED BY OWNER AND SUPPLIED AND INSTALLED BY CONTRACTOR. VERIFY FIXTURE SELECTION WITH SHPO PRIOR TO ORDERING.
- CEILING FAN (100W MAXIMUM) TO BE SPECIFIED BY OWNER AND SUPPLIED AND INSTALLED BY CONTRACTOR.
- TIMER SWITCH PER SPECIFICATIONS FOR CONTROL OF ALL EXTERIOR LIGHTING FIXTURES ON CIRCUIT LH:13. COORDINATE SWITCH LOCATION WITH ARCHITECT/OWNER PRIOR TO ROUGH-IN.

<u>632 Esplanade – Lighting – Previously Approved Plans</u> VCC Architectural Committee



Page 207 of 215

EV4R Series

Recessed Ceiling Mount LED Emergency Light

FEATURES

Application

The EV4R Series is a ceiling mounted, recessed emergency light with superior emergency lighting coverage. The EV4R provides 90 minutes of emergency illumination when primary power is lost. The EV4R Series has a flame-rated, UV stable thermoplastic housing and choice of round or square trim-plate in white or black finish. The 4 LEDs are housed within an aluminum heat-sink and adjustable optic assembly. Each LED is driven at 1 watt each. Includes micro-controlled pulse charger and nickel metal hydride (NiMH) battery. The EV accepts 120/277VAC input at 50 or 60 Hz. Unit can be applied at 220-240VAC input without self-diagnostic option. The EV4R is approved for use in the City of Chicago with the addition of a KIT-EV4R-CP which includes a gasket, foil tape and special installation instructions.

Construction

The EV4R housing and trim-plate is made of flame-rated, UV stable thermoplastic with a lightly textured white or black finish. Each LED is housed in an aluminum heat-sink. Adjustable optic assembly is made of ABS thermoplastic. LED lens are made of acrylic. Includes a steel back-box and caddy-bar assembly.

Installation

The EV4R includes a round or square trim-plate with a rough-in template for back-box installation. Includes a caddy bar assembly for mounting within a T-Grid ceiling. Conduit entry through knock-outs in the back-box. Pre-stripped AC input leads provided. Unit designed for ceiling mount only.

The EV Series provides bright and uniform illumination and increased





Round or Rectangle Trim-Plates

Compliances

Listed to UL924 Standard, NFPA 101 and NFPA 70 Damp Location Listed IC Rated CEC T20 Compliant









632 Esplanade – Lighting – Previously Approved Plans

spacing by using 4 high power LEDs which are mounted in an Warranty adjustable optic assembly in 2 pairs. Adjustability is based on mounting LED Lifetime Warranty height for optimal light pattern. LED's are driven at 1 watt each for 88 EV4R Full 3 Year Warranty lumens per LED. EV4R with Spectron® Full 5 Year Warranty Photometrics are available for download at www.dual-lite.com. **ACCESSORIES** KIT-EV4R -CP Kit for Chicago Plenum Rating (see Note 4) **ORDERING GUIDE** Capacity Recessed Self-Diagnostics finish per architect 1. Each model includes round or square trim-plate 2. Each model is damp listed 3. Not for 220-240VAC input 4. KIT-EV4R-CP adds gasket and foil tape to meet City of Chicago Plenum Rating



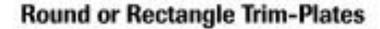



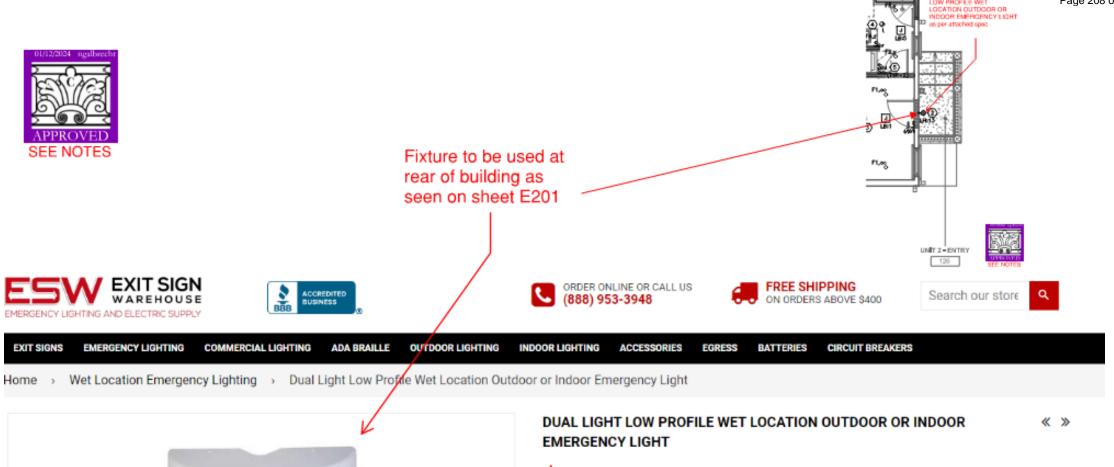

\$229.00

AVAILABILITY : In Stock

PRODUCT TYPE: Wet Location Emergency Lighting

VENDOR: Wet Location Emergency Lighting


SKU: ESW-EML-PG

632 Esplanade – Lighting – Previously Approved Plans


VCC Architectural Committee

September 9, 2025




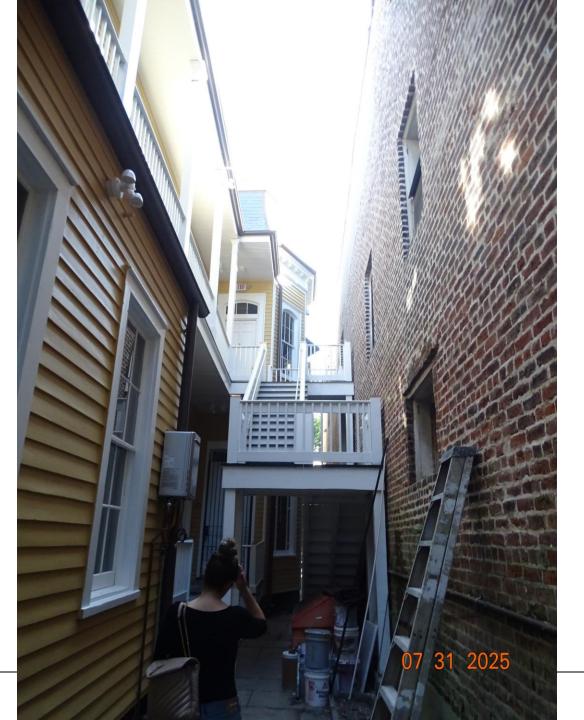



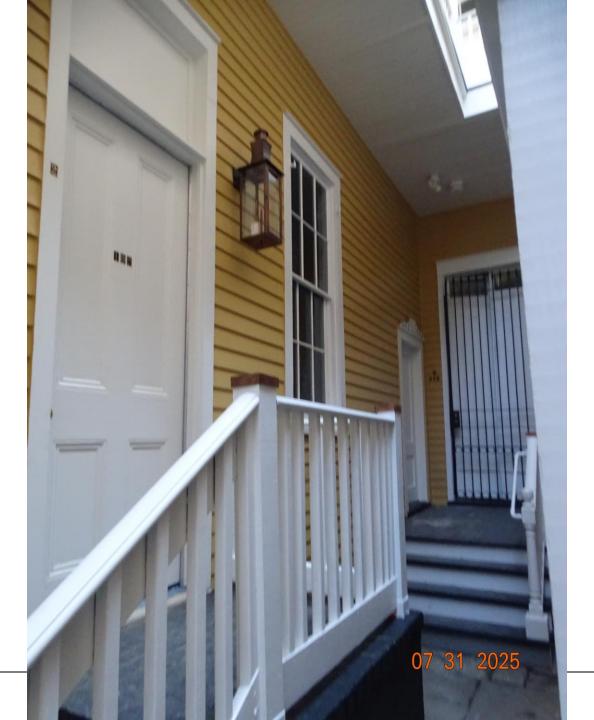



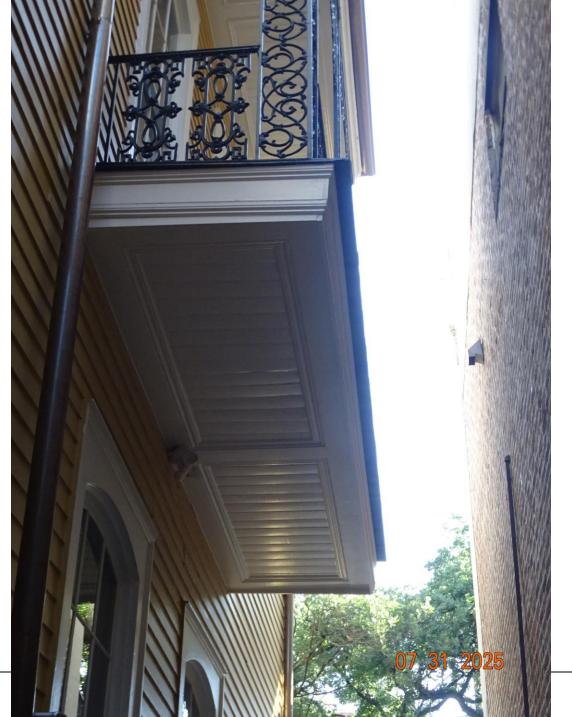

632 Esplanade









USE AND CARE GUIDE

MOTION SECURITY LIGHT

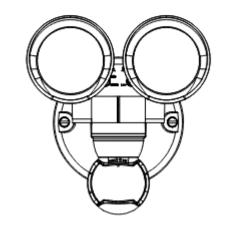

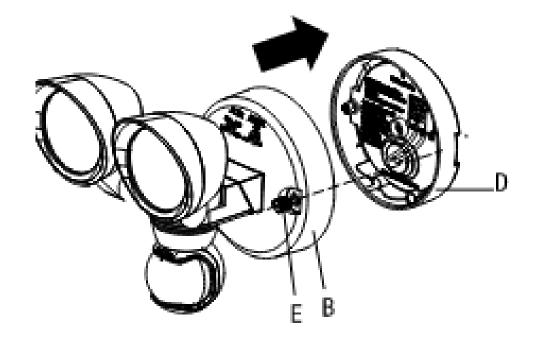







632 Esplanade – Masonry Wall VCC Architectural Committee



